
PAVING NOTES:

- 1. CONCRETE FOR ALL STREETS SHALL BE IN ACCORDANCE WITH NCTCOG CLASS "A" CONCRETE (4,000 P.S.I. COMPRESSIVE STRENGTH @ 28 DAYS).
- 2. REINFORCING STEEL SHALL BE DEFORMED BARS NO. 3, 18 INCHES ON CENTER, OR BARS NO. 4, 24 INCHES ON CENTER. REINFORCING SHALL BE IN BOTH DIRECTIONS ON CENTER. REINFORCING STEEL SHALL BE IN ACCORDANCE WITH ASTM 615, 616 AND 617.
- 3. ALL REINFORCING STEEL SHALL BE TIED (100%). STEEL SHALL BE SET ON PLASTIC CHAIRS BAR LAPS ARE TO BE MINIMUM 30 DIAMETER.
- 4. EXPANSION JOINTS SHALL BE SPACED EVERY 200 FEET AND AT ALL INTERSECTIONS.
- 5. SAWED TRANSVERSE DUMMY JOINTS SHALL BE SPACED EVERY 20 FEET ON PAVING 8 INCHES OR THICKER AND EVERY 15 FEET FOR PAVING THICKNESS LESS THAN 8 INCHES. SAWING SHALL OCCUR WITHIN 5 TO 12 HOURS AFTER THE POUR INCLUDING SEALING (SILICON SEALANT). OTHERWISE THE SECTION SHALL BE REMOVED AND LONGITUDINAL BUTT JOINT CONSTRUCTED.
- 6. LIME TRIMMINGS ARE NOT ACCEPTABLE TO ANY USE.
- 7. ALL FILL SHALL BE COMPACTED BY MECHANICAL METHODS. MAXIMUM LOOSE LIFT FOR COMPACTION SHALL BE 8 INCHES. ALL LIFTS SHALL BE TESTED FOR DENSITY BY AN INDEPENDENT LABORATORY APPROVED BY THE CITY. DENSITY REQUIREMENT SHALL BE AS SHOWN ON THE PLANS FOR THE TYPE OF MATERIAL CALLED FOR IN THE PLANS.
- 8. ALL DISTURBED AREAS OF ROADWAY WORK SHALL RESTORE GRASS AT COMPLETION OF PROJECT. GRASS SHALL MEET THE REQUIREMENT OF ITEM 3.8, 3.9, 3.10 & 3.11 OF NCTCOG.
- 9. ALL AREA TO BE EXCAVATED OR FILLED SHALL HAVE EROSION CONTROL PLACED PRIOR TO COMMENCING EARTHWORK. EROSION CONTROL DEVICES SHALL BE MAINTAINED THROUGHOUT THE PROJECT IN ACCORDANCE WITH NCTCOG ITEM 3.12.
- 10. SIDEWALK SHALL BE DOWELED INTO PAVEMENT WHERE IT ABUTS DRIVEWAY, AND EXPANSION JOINT MATERIAL SHALL BE USED AT THESE LOCATIONS.
- 11. NO VEHICLES SHALL BE PERMITTED ON CONCRETE PAVEMENT WITHOUT APPROVAL FROM THE CITY. THE CITY WILL MAKE DETERMINATION BASED ON CONCRETE BREAK REPORT.

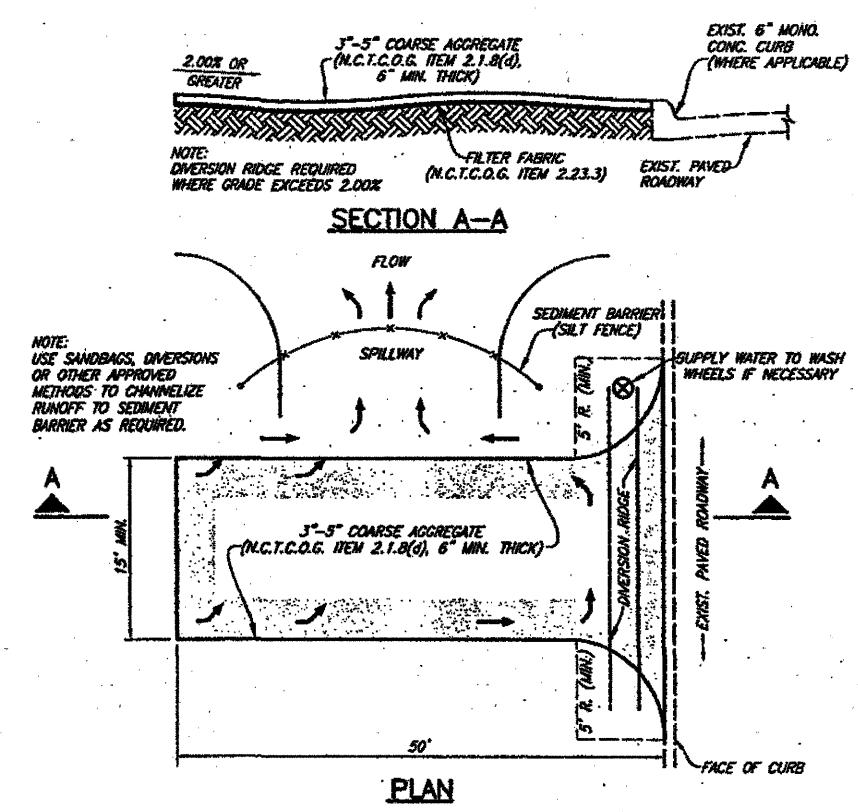

CONSTRUCTION ENTRANCE ROAD
FOR EROSION CONTROL
NO SCALE

24" NO. 8 SMOOTH DOWEL

16" DOWEL COATING

2" MIN.


TOP 1/4" NO JOINT
SEALING COMPOUND

JI" MIN.

DOWEL SLEEVE (CLOSED END) TO FIT DIGMEL AND BE SECURED. TO BE MISTALLED 12" CTR. TO CTR.

TRANSVERSE EXPANSION JOINT NOTES:

- . Dowels and reinforcing bars shall be supported by an approved device.
- 2. TRANSVERSE EXPANSION JOINTS SHALL BE SPACED AT 400 FT. MAXIMUM AND AT ALL INTERSECTIONS.
- TRANSVERSE EXPANSION JOINT

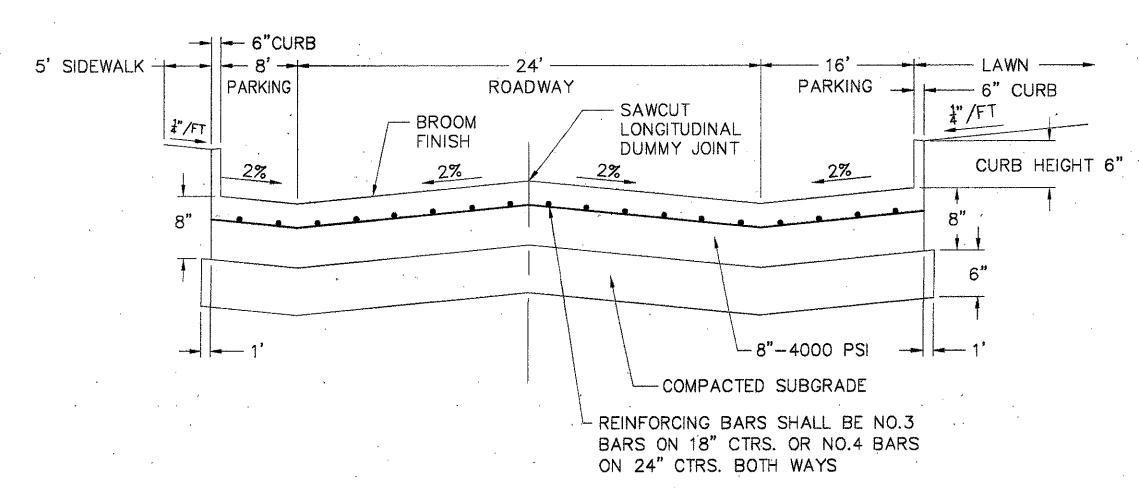


STANDARD SPECIFICATIONS:

A. REINFORCED CONCRETE PAVEMENTS


- ALL CURBS SHALL BE PLACED INTEGRAL WITH PAVEMENT.
 CURBS SHALL MEET THE SAME COMPRESSIVE STRENGTH AS SPECIFIED FOR THE CONCRETE PAVEMENT.
 BAR CHAIRS OR AN APPROVED SUPPORTING DEVICE SHALL BE FURNISHED
- B. CROSS SLOPE SHALL BE # PER FOOT UNLESS APPROVED BY ENGINEER

TYPICAL CROSS SECTION OF FESTIVAL WAY (A-A)

SCALE: NTS

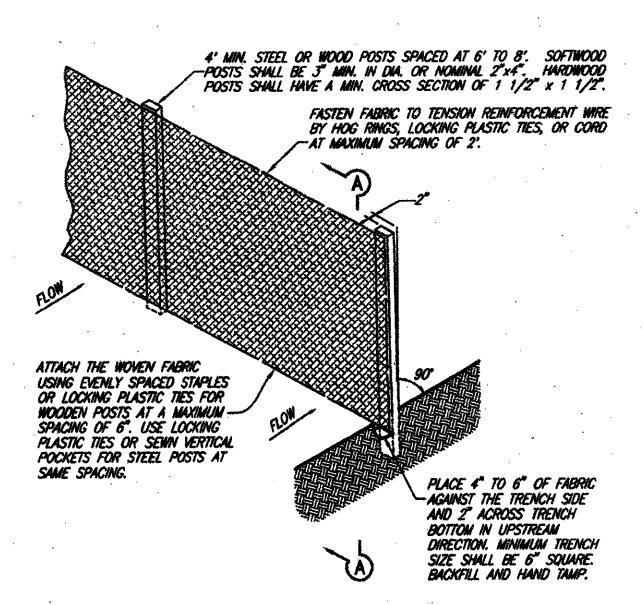


5 SILT FENCE ALTERNATE
NO SCALE

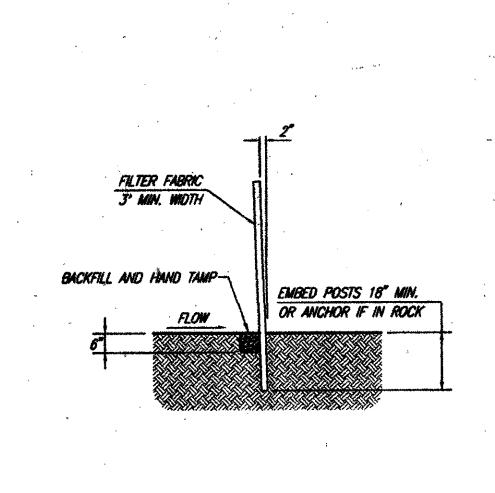

SECTION A-A

EROSION CONTROL ALTERNATES



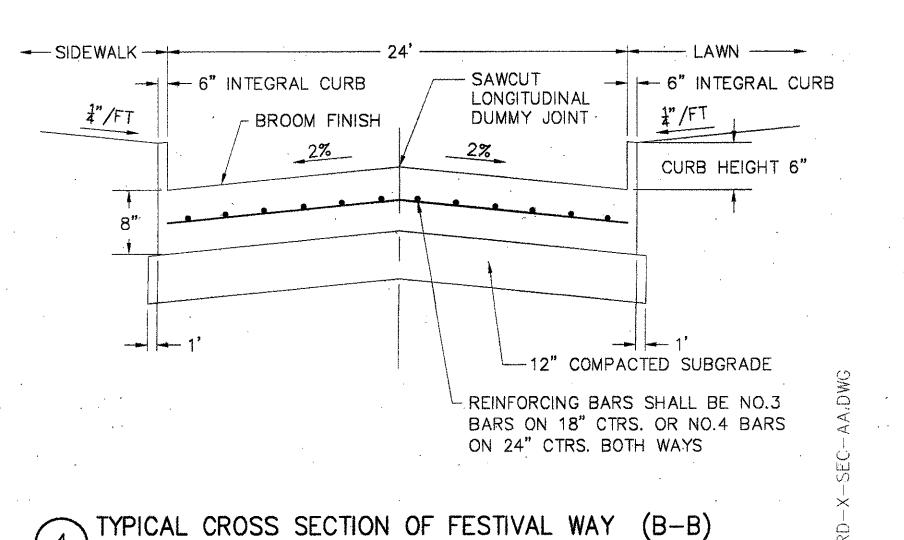

2 ROADWAY PAVEMENT UNDERCUT HEADER SECTION SCALE: NTS

CONCRETE -PAVEMENT

- #3 BARS @

COMPACTED SUBGRADE

PAVEMENT BARS TO BE BENT

AND PAVEMENT TO BE MONOLITHIC.

DOWN INTO HEADER. HEADER


EXPANSION ---

EXISTING ---

PAVEMENT

HEADER

JOINT SEALANT

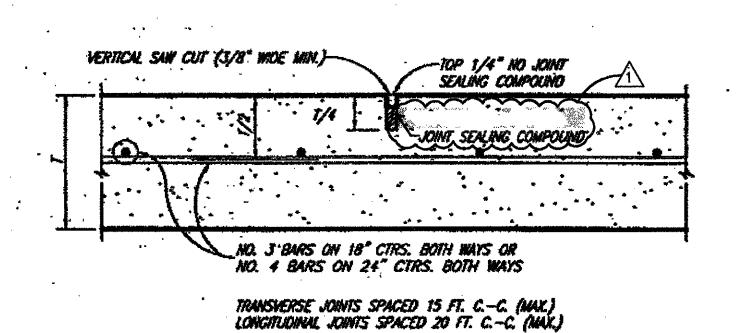

SAWED DUMMY JOINT


ADDENDUM #2

ISSUED FOR CONSTRUCTION

No. Description

Date

DWG ISSUE & REVISION HISTORY

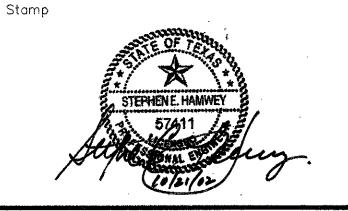

Project Title:

ADDISON ARTS & EVENTS DISTRICT ADDISON, TEXAS

Drawing Titi

SITE DETAILS ROADWAY PAVING

Project No. 14516.00 Scale: AS NOTED

Drawn By: SJM

Checked By: TC

Approved By: SFH

Date: September 30, 2002

C8-3