
Addison Circle Rond Point · Addison, Texas

Bid No. 98-10 100% CONSTRUCTION DOCUMENTS • 12 AUGUST 1998

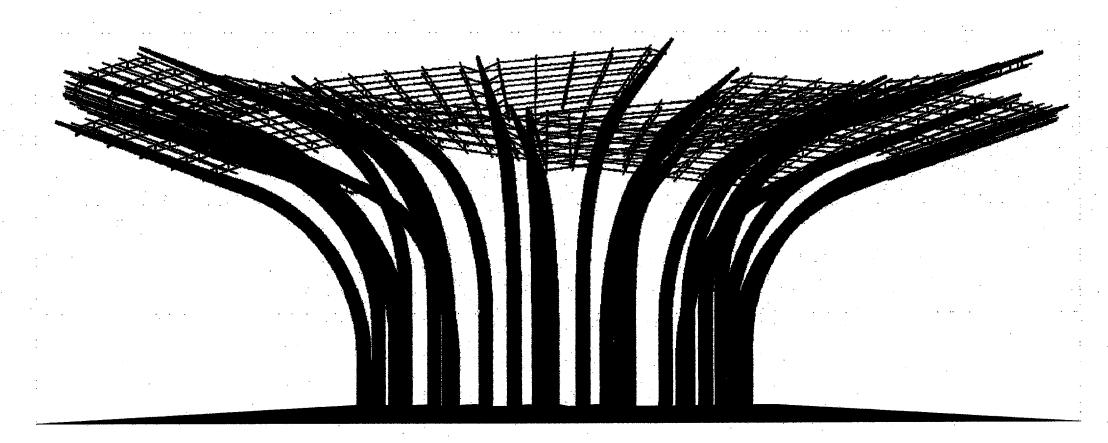

Client/Owner Town of Addison 5300 Belt Line Road Addison, Texas 75001-0144 Telephone (972) 450 7000 Facsimile (972) 450 7043

Landscape Architect/ Prime Consultant Michael Van Valkenburgh Associates, Inc. 231 Concord Avenue Cambridge, Massachusetts 02138 Telephone (617) 864 2076 Facsimile (617) 492 3128

Artist Mel Chin P.O. Box 566 Burnsville, North Carolina 28714 Telephone (704) 682 7199 Facsimile (704) 678 9059

Electrical Engineer
R.G. Vanderweil Engineers, Inc. 274 Summer Street Boston, Massachusetts 02210-1112 Telephone (617) 423 7423 Facsimile (617) 423 7401

Architectural Consultan Thompson and Rose Architec Cambridge, Massachusetts 02139 Telephone (617) 876 9966 Facsimile (617) 876 9922

Irrigation Consultant
Terry J. Little, Irrigation Consultant
16835 Addison Road, Suite 103 Dallas, Texas 75248 Telephone (972) 380 4566 Facsimile (972) 380 4566

Metal Fabricator Advisor Metalmorphosis Metal Fabricator Advisor
Metalmorphosis
3101 S. La Cienega Boulevard
Los Angeles, California 90016
Telephone (310) 287 0593
Facsimile (310) 287 0596

Geotechnical Engineer
HBC Engineering, Inc.
4747 Irving Boulevard, Suite 206 Dallas, Texas 75247 Telephone (214) 630 1010 Facsimile (214) 630 7070

30 West 22nd Street New York, New York 10010 Telephone (212) 741 3280 Facsimile (212) 741 3112

Wind Laboratory
The Boundary Layer Wind Tunnel Laboratory
The University of Western Ontario London, Ontario, Canada N6A 5B9

Electrical Engineering Drawings

El.01 Electrical Site Lighting Plan

E2.01 Electrical Legend, Details, Schedules, and

General Notes

List of Drawings



Landscape Drawings
L0.01 General Notes and Legends L1.01 Existing Conditions and Site Preparation Plans L1.02 Layout, Materials, Grading, and Planting Plans

Structural Drawings
S1.01 Metal Sculpture Foundation Plan Details and Notes
S1.02 Metal Sculpture Pole Layout and Details
S2.01 Metal Sculpture Truss Details

A1.01 Artwork Layer - Petals A,B, and C A1.02 Artwork Layer - Petals D and E A2.01 Petal A Images A1 through A4
A2.02 Petal B Images B1 through B4
A2.03 Petal C Images C1 through C2
A2.04 Petal C Images C3 through C4
A2.05 Petal D Images D1 through D4
A2.06 Petal E Images E1 through E4

Irrigation Drawings
II.01 Irrigation Plan, Notes, and Details

Legend of Symbols for Landscape Architectural Drawings

TTTTTTTTTProposed Wall Plus or minus dimension Detail Reference: Detail Number L1.01 Plan, Section, or Elevation Detail Reference Indicates Direction of View Ø Align Elements Elevation Marker 83 T'10" Angle in Degrees, minutes, seconds Limit of Work (715.0)**Existing Spot Elevation** 715.0 Proposed Spot Elevation --730--**Existing Contour** ____730____ Proposed Contour 1% → Percentage and Direction of Down Slope 3:1 Slope Ratio, Horizontal Distance: Vertical Rise Center Line Angle MH() **Existing Manhole** عـه: 🔗 **Existing Traffic Sign to Remain**

Legend of Symbols for Landscape Architectural Drawings

W/O

	•		•
TW	Top of Wall Elevation	PVC	Existing Polyvinyl Chloride Pipe
вw	Bottom of Wall Elevation	UGE	Existing Underground Electric Conduit
CIP	Cast in Place	RCP	Existing Reinforced Concrete Pipe
COMP	Compacted	ww	Existing Waste Water Line
CONC	Concrete	\mathbf{w}	Existing Water Line
DWG	Drawing	ENG	Engineer
EA	Each '	МН	Existing Manhole
Cl	Control Joint	LA	Landscape Architect
EJ ·	Expansion Joint	PH	Fire Hydrant
EL	Elevation	ELEC	Electric
EQ	Equal		
Exist	Existing		
HP	High Point		
LP	Low Point		
LOW	Limit of Work		
MAX	Maximum	•	·
MIN	Minimum		
NTS	Not to Scale	,	
oc	On Center	•	,
R	Radius		
REBAR -	Reinforcing Bar	•	
TC	Top of Curb Elevation		
BC	Bottom of Curb		
TYP	Typical		
VIF	Verify in Field, report findings to Landscape Architect	•	
W/	With	:-	
			•

GENERAL NOTES

- 1. The existing conditions were compiled from base plans of the site prepared by Huitt-Zollars, Inc., 3131 McKinney Avenue, Suite 600, Dallas, Texas 75204, (214) 871-3311, and dated January 1996. Although every effort has been made to accurately locate all conditions, actual conditions may vary from those shown. The Contractor shall make a full review of all existing conditions of the site and shall report discrepancies to the Landscape Architect before starting work. The Contractor shall assume responsibility for actual conditions as they exist on site.
- 2. The Contractor shall familiarize himself with all utilities above grade, at grade, and underground, including utility pipes and structures. The Contractor shall verify with the Town of Addison and Utility Companies the locations of all utilities prior to the start of construction. The Contractor shall take sole responsibility for the cost incurred due to damage and replacement of all utilities on the site. The Contractor shall contact all utility companies (including but not limited to Lone Star Gas, MCI, Texas Union Electric, Southwestern Bell, Addison Access) and the Town of Addison Department of Public Works to field locate all utilities before starting work.
- 3. The contract limit line represents the limit of work. The contract limit line shall be at the limit necessary for improvements and plantings as shown on the Drawings. The Contractor shall not do any work beyond the limit of work line as defined on the Drawings and authorized by the respective authority. The Contractor shall take sole responsibility for the cost incurred due to replacement for work done beyond the contract limit line and replacement for work done without the permission of the Owner.
- 4. The Contractor shall be responsible for all coordination to complete the work shown on the Drawings
- 5. All notes shall be applicable to all Drawings.

SITE PREPARATION NOTES

- 1. Prior to any construction or site preparation, the Contractor shall be responsible for obtaining the services of a Texas-licensed surveyor to stake the limits of demolition and the limits of proposed improvements to facilitate demolition work. The Construction Manager and the Owner shall review the site and approve the extent of clearing before any clearing is started. The Contractor shall take sole responsibility for all costs incurred due to damage and any required replacement of the site elements.
- 2. All existing utilities not indicated to be removed shall remain and be protected.
- 3: The Contractor shall verify all items to be removed with the Construction Manager and Owner prior to disposal. The Contractor shall protect all materials designated to remain and shall be solely responsible for replacement of any materials so designated that are damaged during construction. The extent of replacement and/or repair to damaged items or work shall be determined by the Landscape Architect and the Construction Manager and replaced/repaired to the Owner's satisfaction.
- 4. The Contractor shall clear and remove all organic matter, debris and rubbish from the job site not designated for salvage or relocation. The removal of such items shall be done in a manner so as not to damage items to remain. The Contractor shall dispose of said materials in a legal manner consistent with all applicable regulations and governing authorities.
- 5. No paint shall be applied to site elements designated to remain. The Contractor shall review the method of marking site elements to remain with the Landscape Architect prior to beginning construction.
- $\textbf{6.} \ \textbf{For tree protection of existing trees see Site Preparation Specifications}.$
- 7. The Contractor shall coordinate and perform all work in the Contract Documents with the work performed under other contracts of construction on the site.
- 8. Existing materials designated for salvage by the Construction Manager, Owner, Landscape Architect, or Contractor, shall be stockpiled or stored in locations as approved by the Construction Manager and Owner.
- 9. The Contractor shall be responsible for visiting the site to determine the extent of demolition, preparation, and removals necessary (whether shown on the Drawings or not) to construct the proposed site improvements. The Contractor shall report, in writing, any discrepancies between the existing and proposed work to the Landscape Architect and the Owner prior to proceeding with construction. Failure to inspect, notice, or report these discrepancies prior to construction shall not relieve the Contractor from his responsibility to perform the necessary operation for the successful completion of the proposed improvements without any change in the contract amount.
- 10. The existing catch basins and associated vaults and pipes shall be protected from damage at all times. The Contractor shall surround the existing catch basins with strawbales and siltation fences as required by authorities having jurisdiction over the catch basins. The Contractor shall maintain protective devices and delineation stakes for the duration of work operations. Contractor shall not drive equipment over existing catch basins.

For materials for protection of existing catch basins see Site Preparation Specifications.

- 11. All topsoil within work areas shall be stripped before the start of construction. Contractor shall review limits of topsoil stripping with the Landscape Architect prior to starting work, and topsoil shall be stockpiled at an approved location off site.
- 12. All existing utilities (whether shown on the Drawings or not) shall remain and be protected.
- 13. Limits of the work area shall be identified and staked prior to the start of

LAYOUT AND MATERIALS NOTES

- 1. Use dimensional information given. Do not scale Drawings.
- All lines and dimensions are parallel or perpendicular to the lines from which they are measured unless otherwise shown.
- 3. All dimensions shown are taken to the face or centerline of elements unless otherwise indicated.
- 4. The Contractor shall verify dimensions shown on the Drawings and notify the Landscape Architect of any discrepancies prior to the start of construction. The Contractor shall review and obtain the approval of the final layout with the Landscape Architect prior to starting construction.
- 5. The Contractor shall layout and determine the elevations of all site elements for approval by the Landscape Architect prior to the start of construction. The Contractor shall report any conflicts between utility structures and proposed improvements to the Landscape Architect.
- 6. The Contractor shall refer any questions on materials, finishes, and/or products to the Landscape Architect, prior to ordering materials or starting work.
- 7. The layout for the sculpture is shown on Sheet L1.02. All other plans shall be in reference to the layout on this sheet.

GRADING NOTES

- 1. The proposed grading is based upon information taken from plans prepared by Huitt-Zollars, Inc. The Contractor shall field verify grades and notify the Landscape Architect of any discrepancies for resolution prior to starting construction operations. The Contractor shall not proceed under uncertainty and shall assume full responsibility and all costs for revisions due to failure to give such notification.
- 2. The Contractor shall layout and determine the elevations of all site elements and foundations for approval by the Landscape Architect and Engineers prior to the start of construction. The Contractor shall report any conflicts between surface utility structures and proposed improvements to the Landscape Architect.
- 3. The Contractor shall be responsible for positive surface drainage in all areas. All newly graded ground surfaces shall be finished to uniform grades and sloped in such a manner as to drain properly and be free of depressions which cause areas of standing water. The Contractor shall report any conflicts with this requirement to the Landscape Architect for resolution prior to final grading operations.
- 4. All grading shall be completed in a way to maintain positive drainage away from or around all foundations. The Contractor shall report any conflicts with this requirement to the Landscape Architect for resolution prior to final grading operations.
- 5. Where proposed grades meet existing grades, blend grades to provide a smooth transition between the new work and the existing work. Ponding at joints will not be accepted.
- **6.** The Contractor shall adjust all utility elements or covers to be flush with the final finish grade whether shown on the Drawings or not.

SEEDING AND FINE GRADING NOTES

 Limit of seeding shall be as shown on the Drawings. All areas on the plan are to be loamed and seeded only after approval of the rough grading or as directed by the Landscape Architect.

For seeding refer to Seeding Specifications.

- 2. Fine Grading: Set sufficient grade stakes for checking the finished grades. Stakes must be set at the bottom and top of slopes. Grades shall be established which are accurate to 1/10th of a foot either way. Connect contours and spot elevations with an even slope. All grading will insure drainage away from structures
- 3. Fine grade lawn areas to smooth, free draining, even surfaces with fine texture. Roll, rake, and drag lawn areas to flatten ridges and fill depressions. Control moisture content to maintain optimum conditions, but do not create a muddy condition.

ADDISON CIRCLE ROND POINT

Addison, Texas

Bid No. 98-10

Client:
Town of Addison
P.O. Box 144
5300 Belt Line Road
Addison, Texas 75001-0144
Tel: 972.450.7000
Fax: 972.450.7043

Landscape Architect: Michael Van Valkenburgh Associates, Inc. 231 Concord Avenue

231 Concord Avenue
Cambridge, Massachusetts 02138
Tel: 617.864.2076
Fax: 617.492.3128

Architect / Design Consultant: Thompson and Rose Architects 1430 Massachusetts Ave. Cambridge, MA 02138 Tel: 617.876.9966

Structural Engineer: LeMessurier Consultants 675 Massachusetts Avenue Cambridge, MA 02138 Tel: 617.868.1200 Fax: 617.661.7520

Lighting Designer:
Cline Bettridge Bernstein Lighting Design
30 West 22nd Street
New York, NY 10010
Tel: 212.741.3280
Fax: 212.741.3112

Metal Fabricator Cost Consultant Metalmorphosis 3101 S. La Cienega Boulevard Los Angeles, CA 90016 Tel: 310.287.0593 Fax: 310.287.0596

Geotechnical Engineer: HBC Engineering, Inc. 4747 Irving Boulevard, Suite 206 Dallas, TX 75247 Tel: 214.630.1010 Fax: 214.630,7070

Electric Engineer: R.G. Vanderweil Engineers, Inc. 266 Summer St. Boston; MA 02210-1112 Tel: 617.423.7423 Fax: 617.423.7401

Irrigation Consultant:
Terry J. Little, Irrigation Consultant
16835 Addison Road
Suite 103
Dallas, TX 75248
Tel: 972.380.4566
Fax: 972.380.4566

100% Construction Documents

MICHAEL VAN VALKENBURGH ASSOCIATES, INC.




231 CDNCORD AVENUE, CAMBRIDGE, HA 02138 USA TEL (617) 864-2076 FAX (617) 492-3128

DRAVING YITLE

LANDSCAPE GENERAL NOTES AND LEGEND

JUB HAMBER 9630 DAYE 12 August 1998

DRAVIN BY JC, SRC LO.01

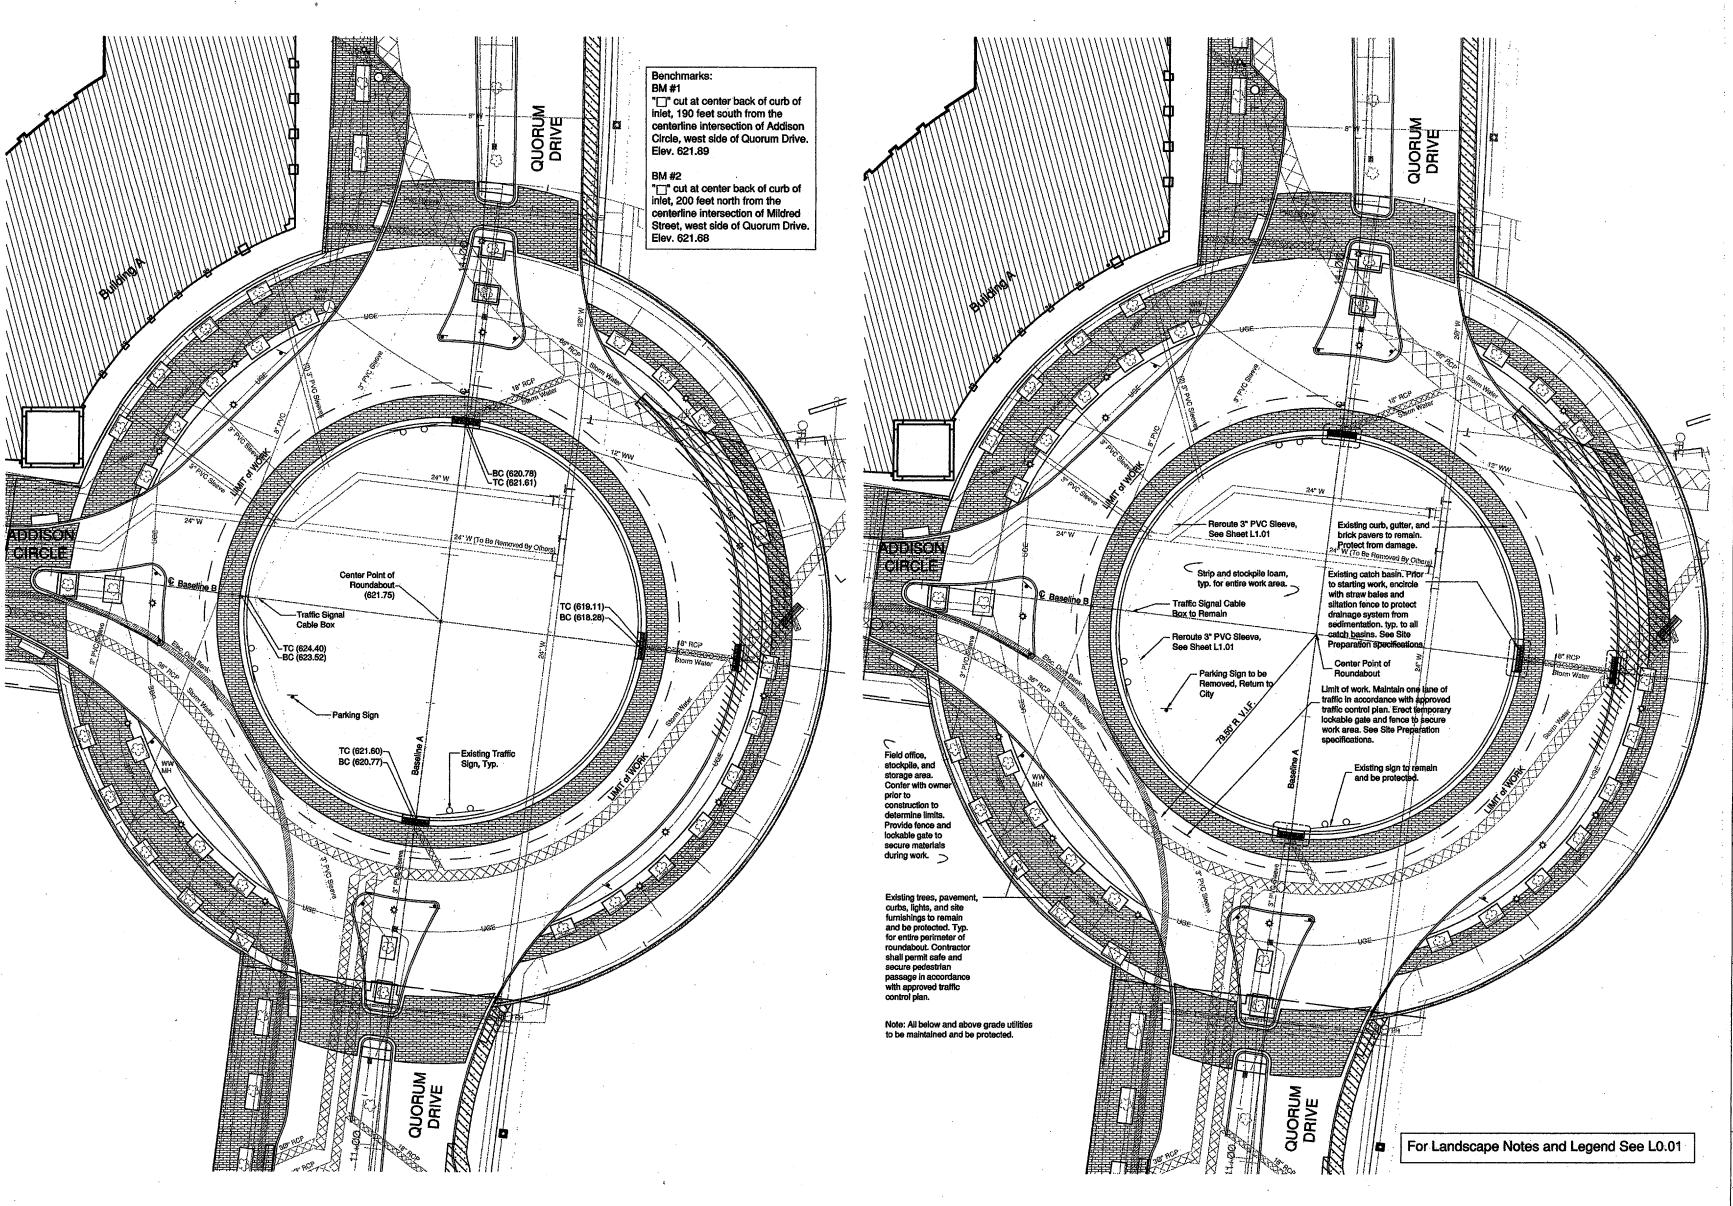

Addison, Texas

Bid No. 98-10

Client: Town of Addison P.O. Box 144 Addison, Texas 75001-0144 Tel: 972.450.7000 Fax: 972.450.7043

Landscape Architect: Michael Van Valkenburgh Associates, 231 Concord Avenue Cambridge, Massachusetts 02138 Tel: 617.864.2076

Artist:
Mel Chin
P.O. Box 566
Burnsville, North Carolina 28714
Tel: 704.682.7199 Fax: 212.388.9330

Architect / Design Consultant: Thompson and Rose Architects 1430 Massachusetts Ave. Cambridge, MA 02138 Tel: 617.876.9966 Fax: 617.876.9922

Structural Engineer: LeMessurier Consultants 675 Massachusetts Avenue Cambridge, MA 02138 Tel: 617.868.1200

Lighting Designer: Cline Bettridge Bernstein Lighting Design 30 West 22nd Street New York, NY 10010 Tel: 212.741.3280 Fax: 212.741.3112

Metal Fabricator Cost Consultant Metalmorphosis
3101 S. La Cienega Boulevard
Los Angeles, CA 90016
Tel: 310.287.0593 Fax: 310.287.0596

HBC Engineering, Inc.
4747 İrving Boulevard, Suite 206
Dallas, TX 75247
Tel: 214.630.1010 Fax: 214.630.7070

Electric Engineer: R.G. Vanderweil Engineers, Inc. 266 Summer St. Boston, MA 02210-1112 Tel: 617.423.7423 Fax: 617.423.7401

Irrigation Consultant: Terry J. Little, Irrigation Consulta 16835 Addison Road Suite 103 Dallas, TX 75248 Tel: 972.380.4566 Fax: 972.380.4566


100% Construction **Documents**



TEL (617) 864-2076 FAX (617) 492-3128

North

Existing Conditions and Site Preparation Plans

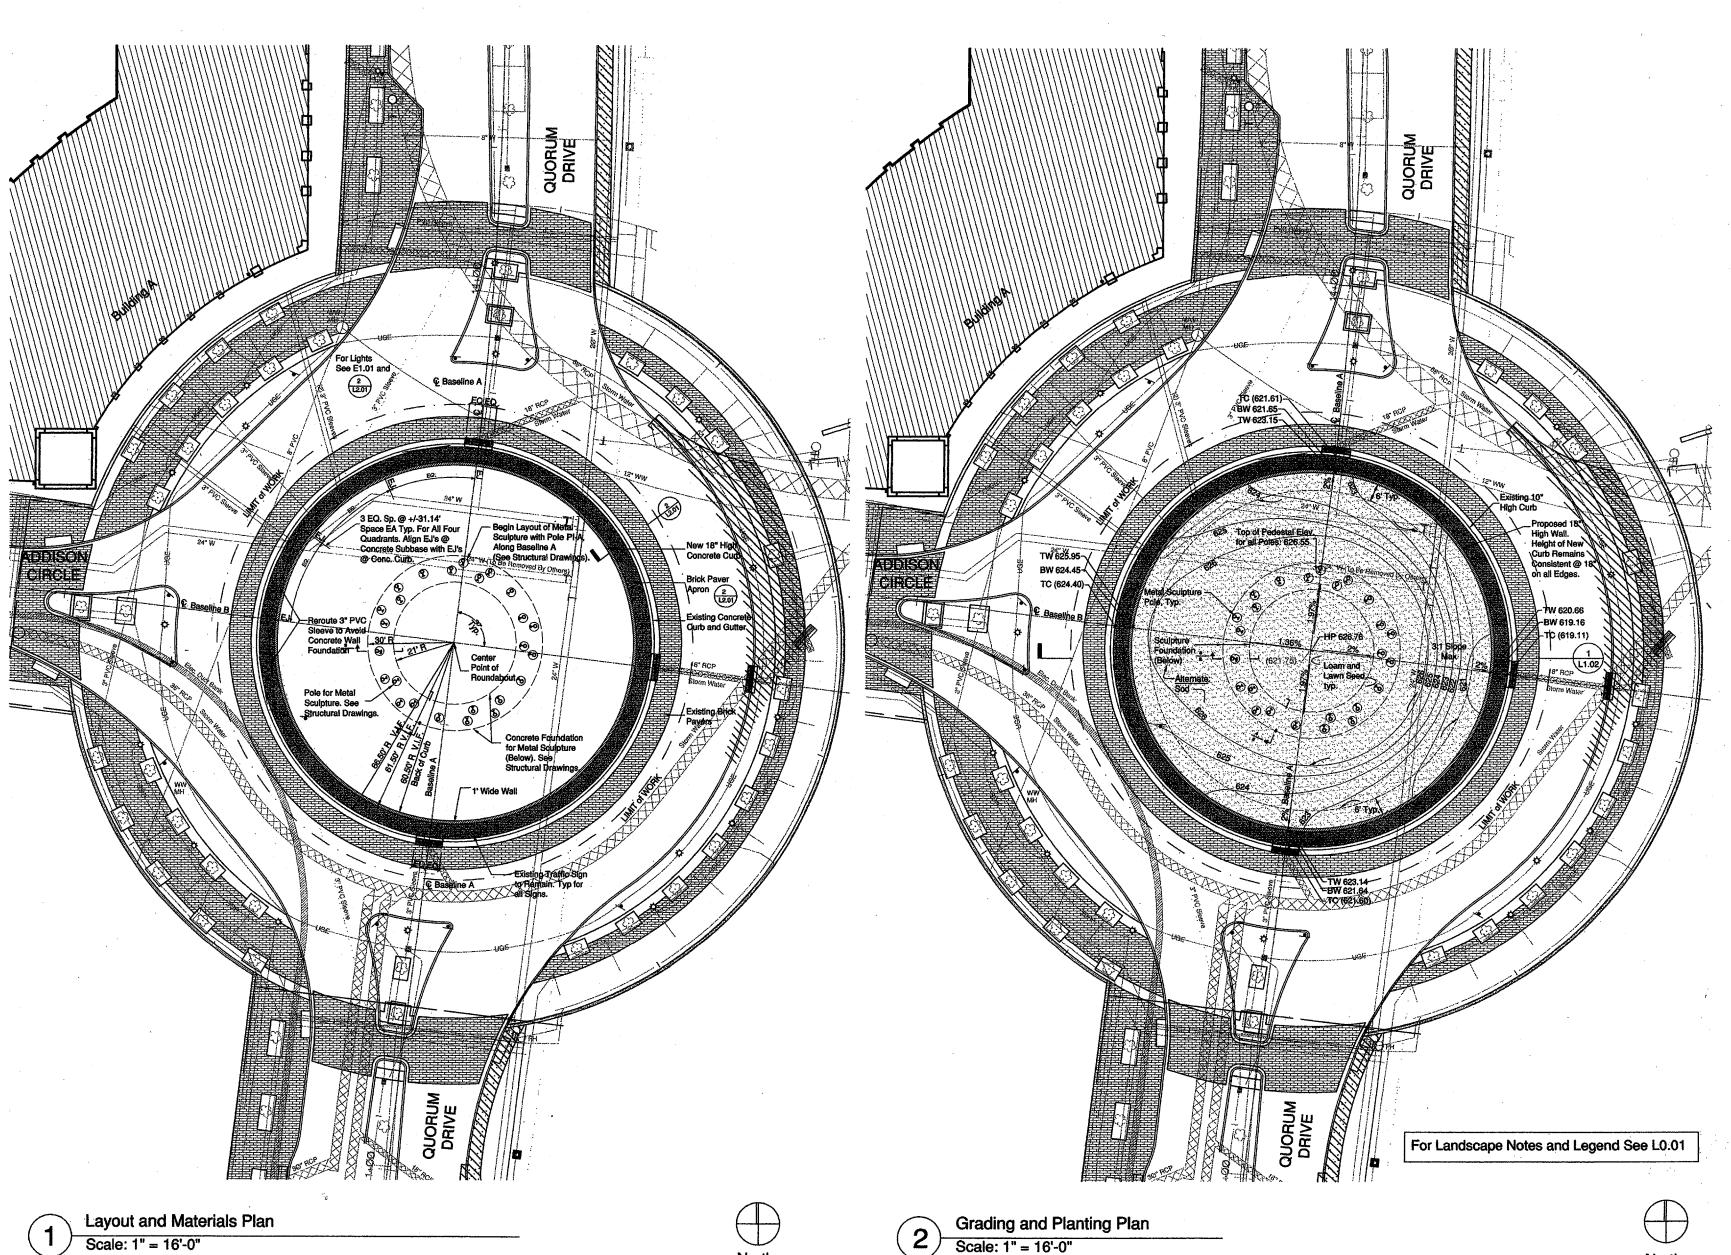

Addison, Texas

Bid No. 98-10

Client:
Town of Addison
P.O. Box 144
5300 Belt Line Road
Addison, Texas 75001-0144
Tel: 972.450.7000
Fax: 972.450,7043

Landscape Architect:
Michael Van Valkenburgh Associates, Inc
231 Concord Avenue
Cambridge, Massachusetts 02138
Tel: 617.864.2076

Fax: 617.492,3128

Architect / Design Consultant: Thompson and Rose Architects 1430 Massachusetts Ave. Cambridge, MA 02138 Tel: 617.876.9966 Fax: 617.876.9922

Structural Engineer: LeMessurier Consultants 675 Massachusetts Avenue Cambridge, MA 02138 Tel: 617.868.1200 Fax: 617.661.7520

Lighting Designer:
Cline Bettridge Bernstein Lighting Design
30 West 22nd Street
New York, NY 10010
Tel: 212.741.3280

Fax: 212.741.3112

Metal Fabricator Cost Consultant:
Metalmorphosis
3101 S. La Cienega Boulevard
Los Angeles, CA 90016
Tel: 310.287.0593
Fax: 310.287.0596

Geotechnical Engineer: HBC Engineering, Inc. 4747 Irving Boulevard, Suite 206 Dallas, TX 75247 Tel: 214.630,1010

Fax: 214.630.7070

Electric Engineer: R.G. Vanderweil Engineers, Inc. 266 Summer St. Boston, MA 02210-1112 Tel: 617.423.7423 Fax: 617.423.7401

Irrigation Consultant:
Terry J. Little, Irrigation Consultant
16835 Addison Road
Suite 103
Dallas, TX 75248
Tel: 972.380.4566
Fax: 972.380.4566

100% Construction Documents


HICHAEL VAN VALKENBURGH ASSOCIATES, INC.



31 CONCORD AVENUE, CAMBRIDGE, HA 02138, USA TEL (617) 864-2076 FAX (617) 492-3128


Layout, Materials, Grading, and Planting Plans

LOB HAMBER 9630 DRAVING MAMBER
DATE 12 August 1998
SCALE 1" = 16"-0"
DRAVIN BY PS
CHECKED BY L.S., MVV

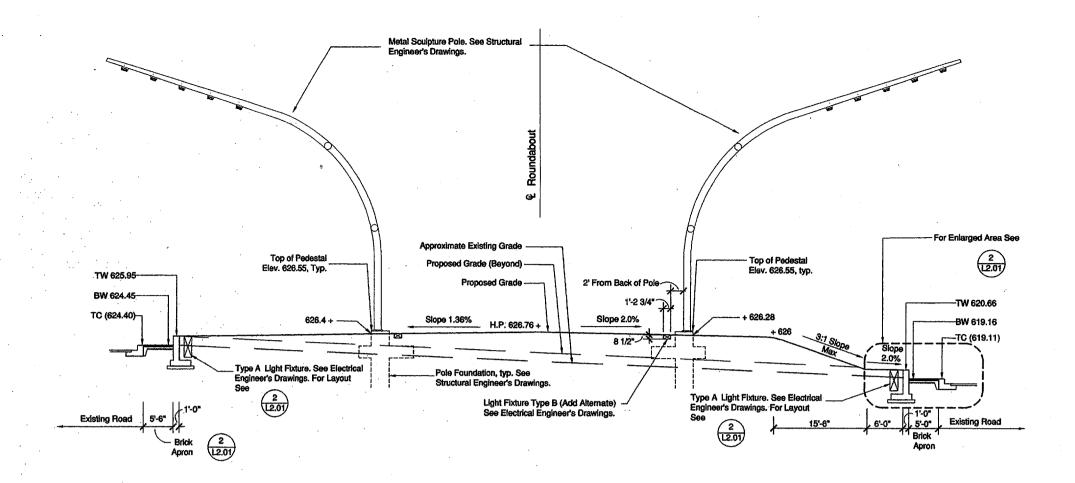

Roundabout Grading - Section

Scale: 1/8" = 1'-0"

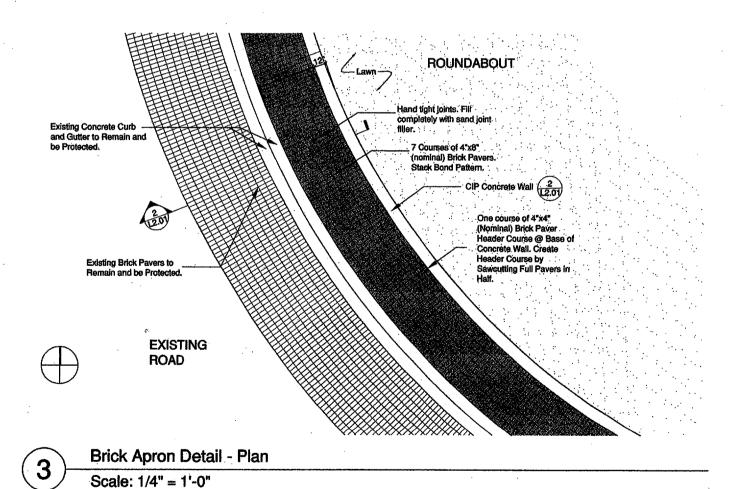

Note: For location of expansion joints see FI: 60'-6" Back of Wall R: 59'-0" Max. R: 55'-6" Min. New C.I.P. Concrete Wall Q.
Finish to Match Existing Road Curb. R: 54'-9" To Toe of Slope New Brick Apron 2% Slope 1/2" Expansion Joint. Extend EJ to Full Depth of Concrete Base. 4.4 1-1/4" Sand Setting Bed t" Compacted Sand Cushlon-Compacted Subgrade -4" Concrete Sub-base w/ 6 1-0 6 Outer Ring Lighting Fixture- Type A. See Electrical Engineer's Drawings. Set on 3/4" Gravel.

Brick Paver Apron - Section

Scale: 1/2" = 1'-0"

For Landscape Notes and Legend See L0.01

ADDISON CIRCLE **ROND POINT**

Addison, Texas

Bid No. 98-10

Client: Town of Addison P.O. Box 144 5300 Belt Line Road Addison, Texas 75001-0144 Tel: 972.450.7000 Fax: 972.450.7043

Landscape Architect:
Michael Van Valkenburgh Associates, Inc.
231 Concord Avenue
Cambridge, Massachusetts 02138
Tel: 617.864.2076

Fax: 617.492.3128

Artist: Mel Chin P.O. Box 566 Burnsville, North Carolina 28714 Tel: 704.682.7199 Fax: 212.388.9330

Architect / Design Consultant: Thompson and Rose Architects 1430 Massachusetts Ave. Cambridge, MA 02138 Tel: 617.876.9966 Fax: 617.876.9922

Structural Engineer: LeMessurier Consultants 675 Massachusetts Avenue Cambridge, MA 02138 Tel: 617.868.1200 Fax: 617.661.7520

Lighting Designer:
Cline Bettridge Bernstein Lighting Design
30 West 22nd Street
New York, NY 10010 Tel: 212.741.3280 Fax: 212.741.3112

Geotechnical Engineer: HBC Engineering, Inc. 4747 Irving Boulevard, Suite 206 Dallas, TX 75247 Tel: 214.630.1010

Fax: 214.630.7070

Electric Engineer: R.G. Vanderweil Engineers, Inc. 266 Summer St. Boston, MA 02210-1112 Tel: 617.423.7423

Irrigation Consultant:
Terry J. Little, Irrigation Consultant
16835 Addison Road
Suite 103
Dallas, TX 75248 Tel: 972.380.4566 Fax: 972.380.4566

100% Construction Documents

MICHAEL VAN VALKENBURGH ASSUCIATES, INC. LANDSCAPE ARCHITECTS



Site Details

5

ADDISON CIRCLE

ROND POINT

Addison, Texas

BID No. 98-10

Town of Addison P.O. Box 144

5300 Belt Line Road

Addison, Texas 75001-0144 Tel: 972.450.7000

Landscape Architect: Michael Van Valkenburgh Associates, Inc. 231 Concord Avenue Cambridge, Massachusetts 02138

Tel: 617.864.2076

Fax: 617.492.8128

Mel Chin

Fax: 212.388.9330

Architect/Design Consultant: Thompson and Bose Architects

Cambridge, MA 02138

Fax: 617.876.9922

Structural Engineer: LeMessurier Consultants 675 Massachusetts Avenu

Cambridge, MA 02139 Tel: 617.868.1200

Lighting Designer: Cline Bettridge Bernstein Lighting Design 30 West 22nd Street New York, NY 10010

Fax: 212,741,3112

Metalmorphosis

Si01 S. La Cienega Boulevard
Loe Angeles, CA 90016

Tel: 810.287.0598

Geotechnical Engine

HBC Engineering, Inc. 4747 Irving Boulevard, Suite 206 Dallas, TX 75247

Tel: 214.680.1010 Fax: 214.680.7070

Electric Engineer R.G. Vanderweil Engineers, Inc. 266 Summer St.

Tel: 617.429.7428

Irrigation Consultant: Terry J. Little, Irrigation Consultant 16835 Addison Road Suite 108

Dallas, TX 75248

100% CONSTRUCTION **DOCUMENTS**

MICHAEL VAN VALKENBURGI I ASSOCIATES, INC.

TEL (817) 884-2076 FAX (817) 492-3128

Metal Sculpture

Foundation Plan **Details and Notes**

S1.01

ю нами 96275 DAL 12 AUG 1998 SOAF AS NOTED

CROSSO UT DFS

Metal Fabricator Cost Consu

P.O. Box 566 wille, North Carolina 28714 Tel: 704.682.7199

FOR EL SEE DWG 2.01

SCALE: 34"-1"-0"

PETAL ORIGIN

SCALES 34"=P-O"

SCALE: 34"=1"-0"


SCALE: 34"=1"-0"


SCALE: 34"=1"-0"

໌9ີ


PIER REINF (TYP)

ADDISH CHOLE RIND POLNT SEZTS AT CHO LDFS? SINCLAIR F-416-1938 12358 , poutses

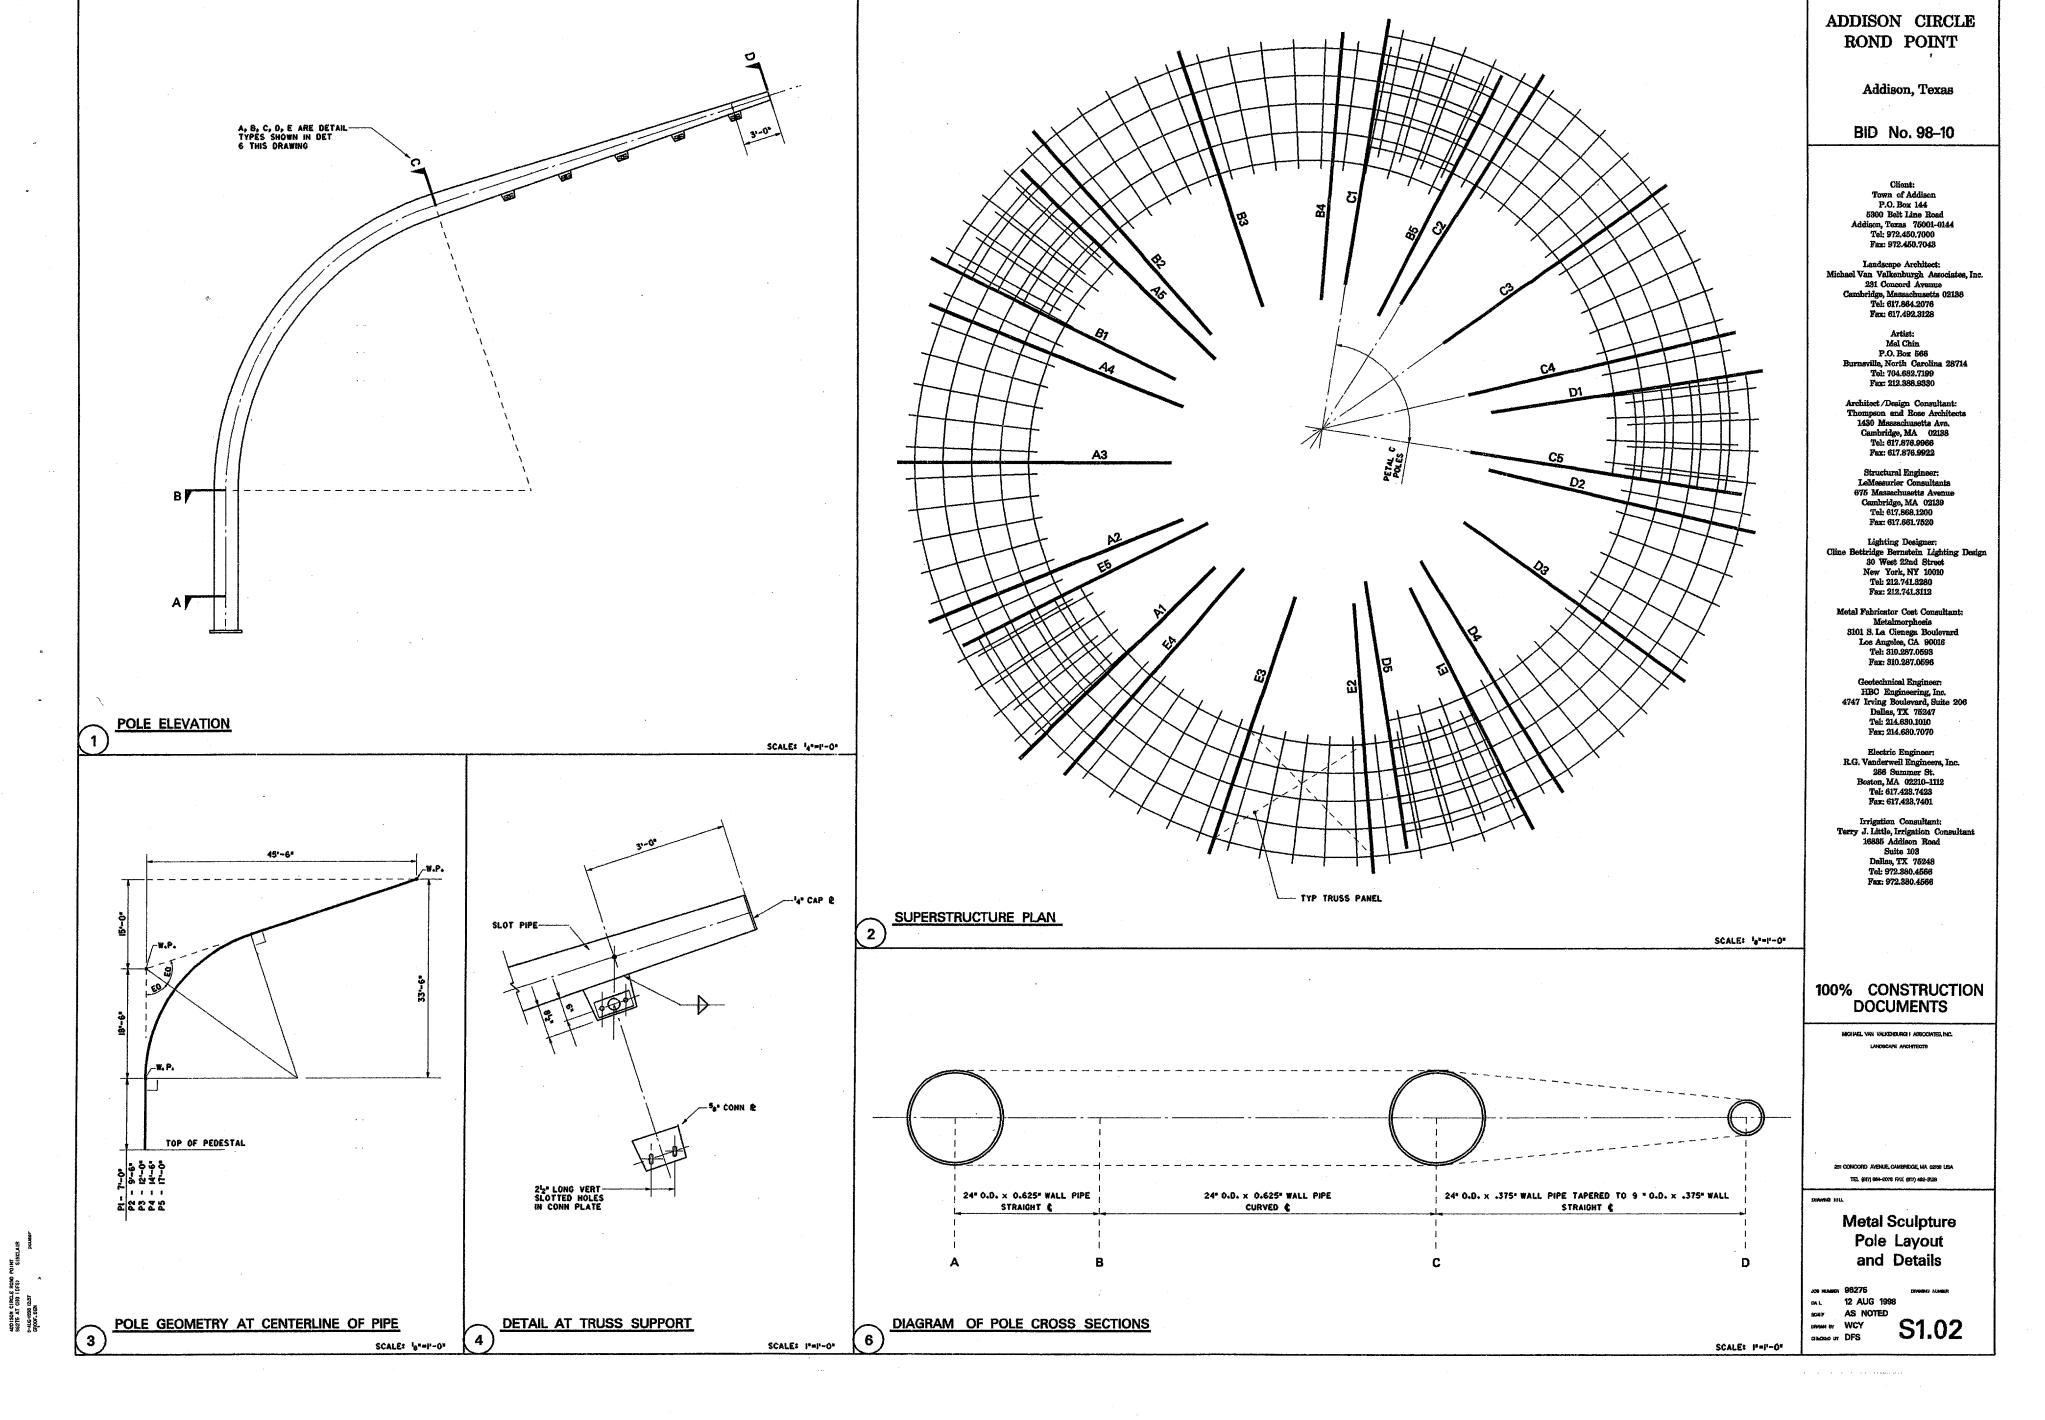

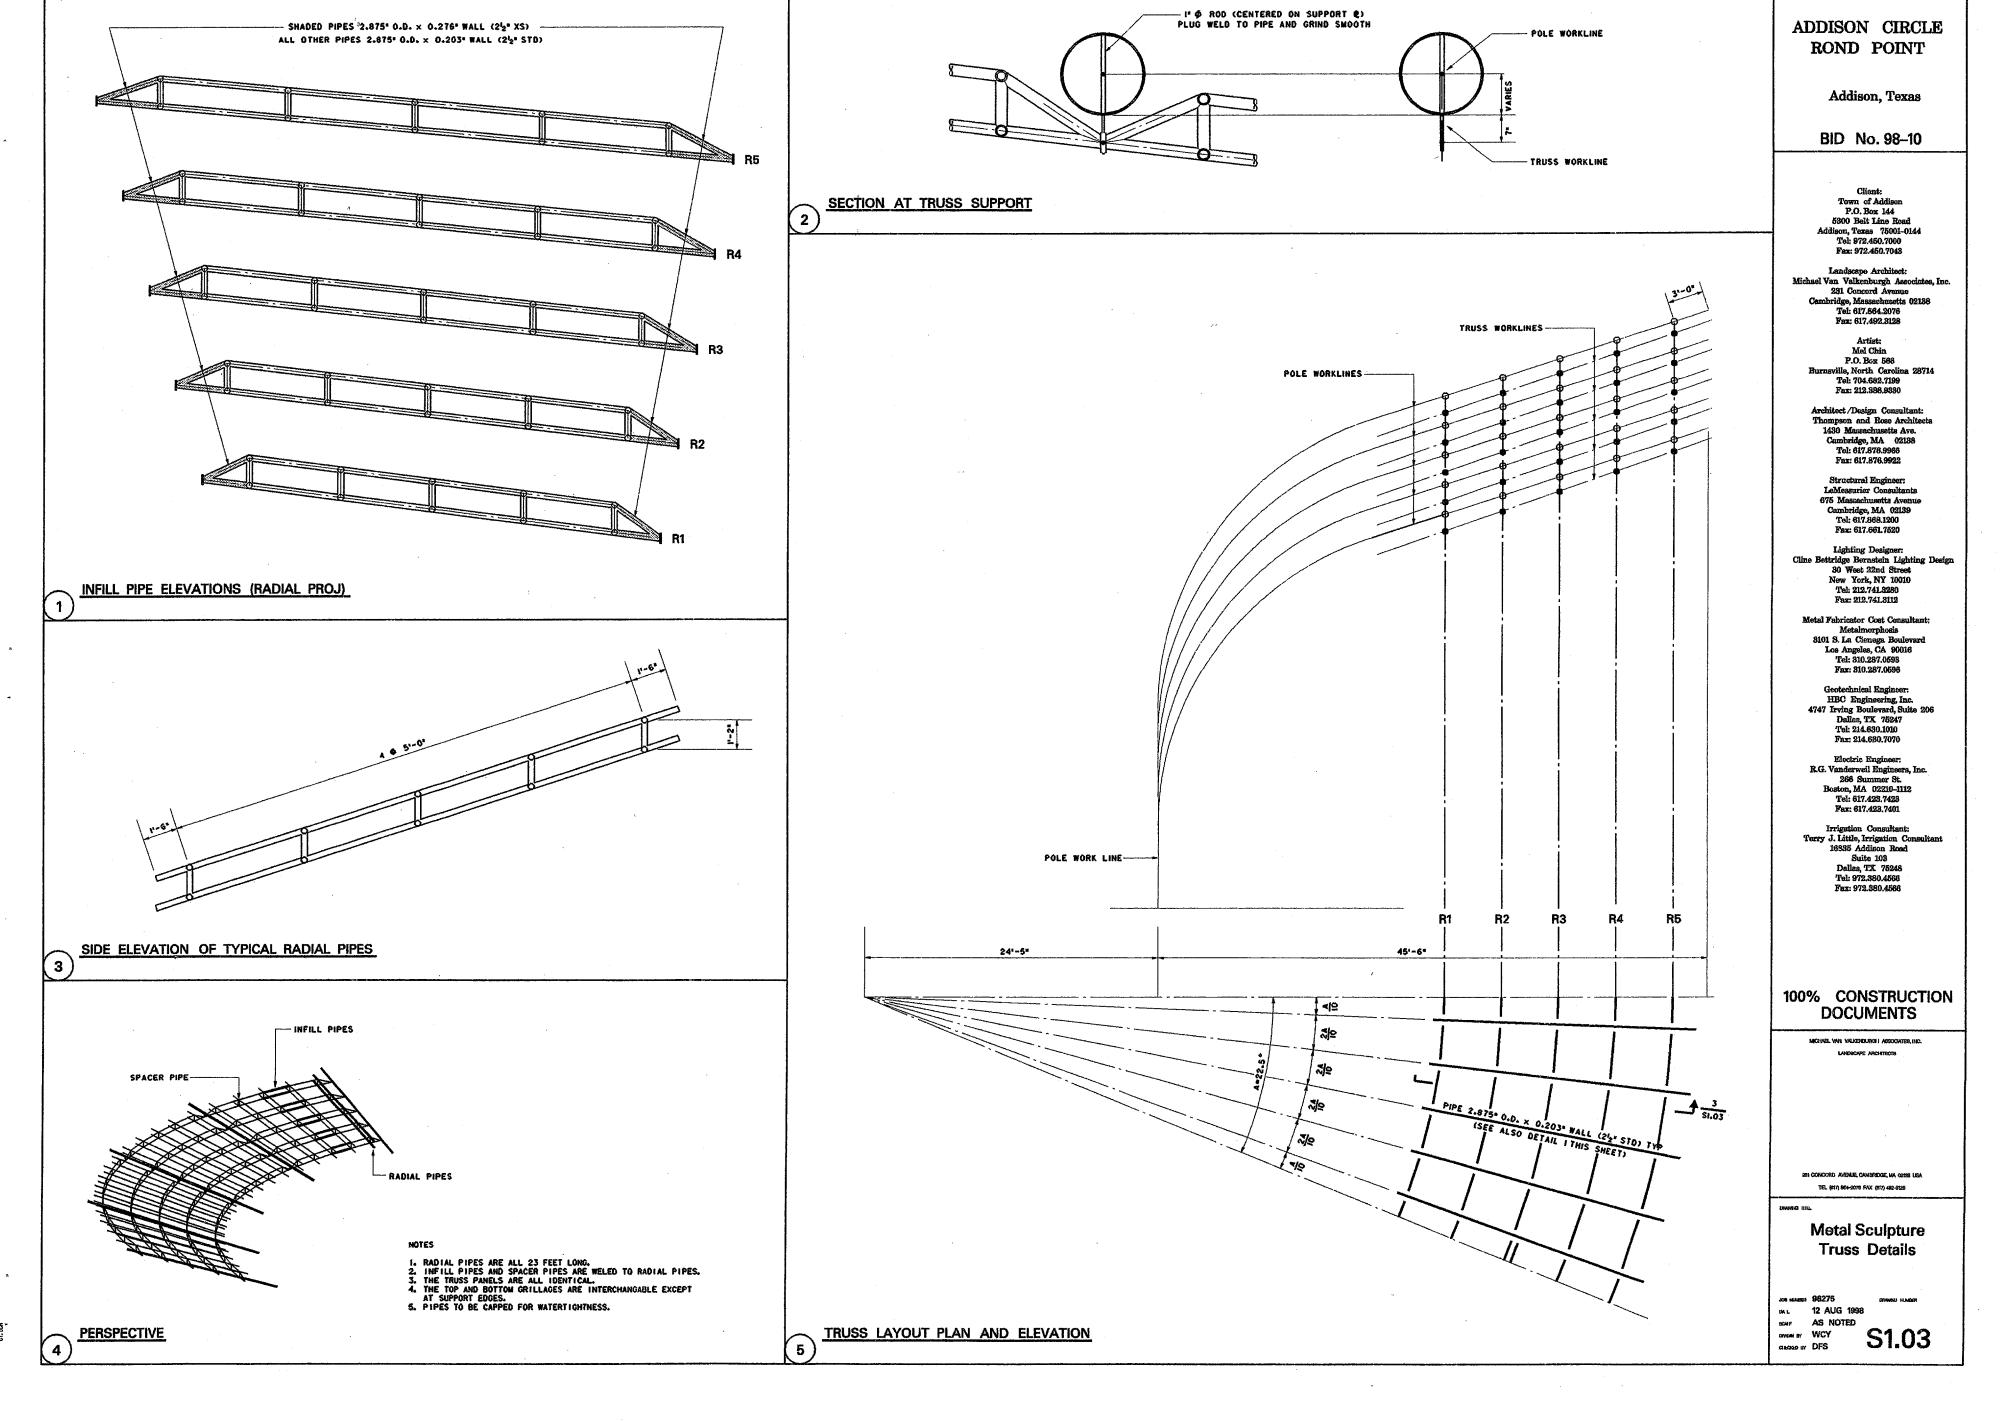

95215 AT CHO (DFS) SHIGLAIR F-MG-1998 12-37 pouser 01.00A b

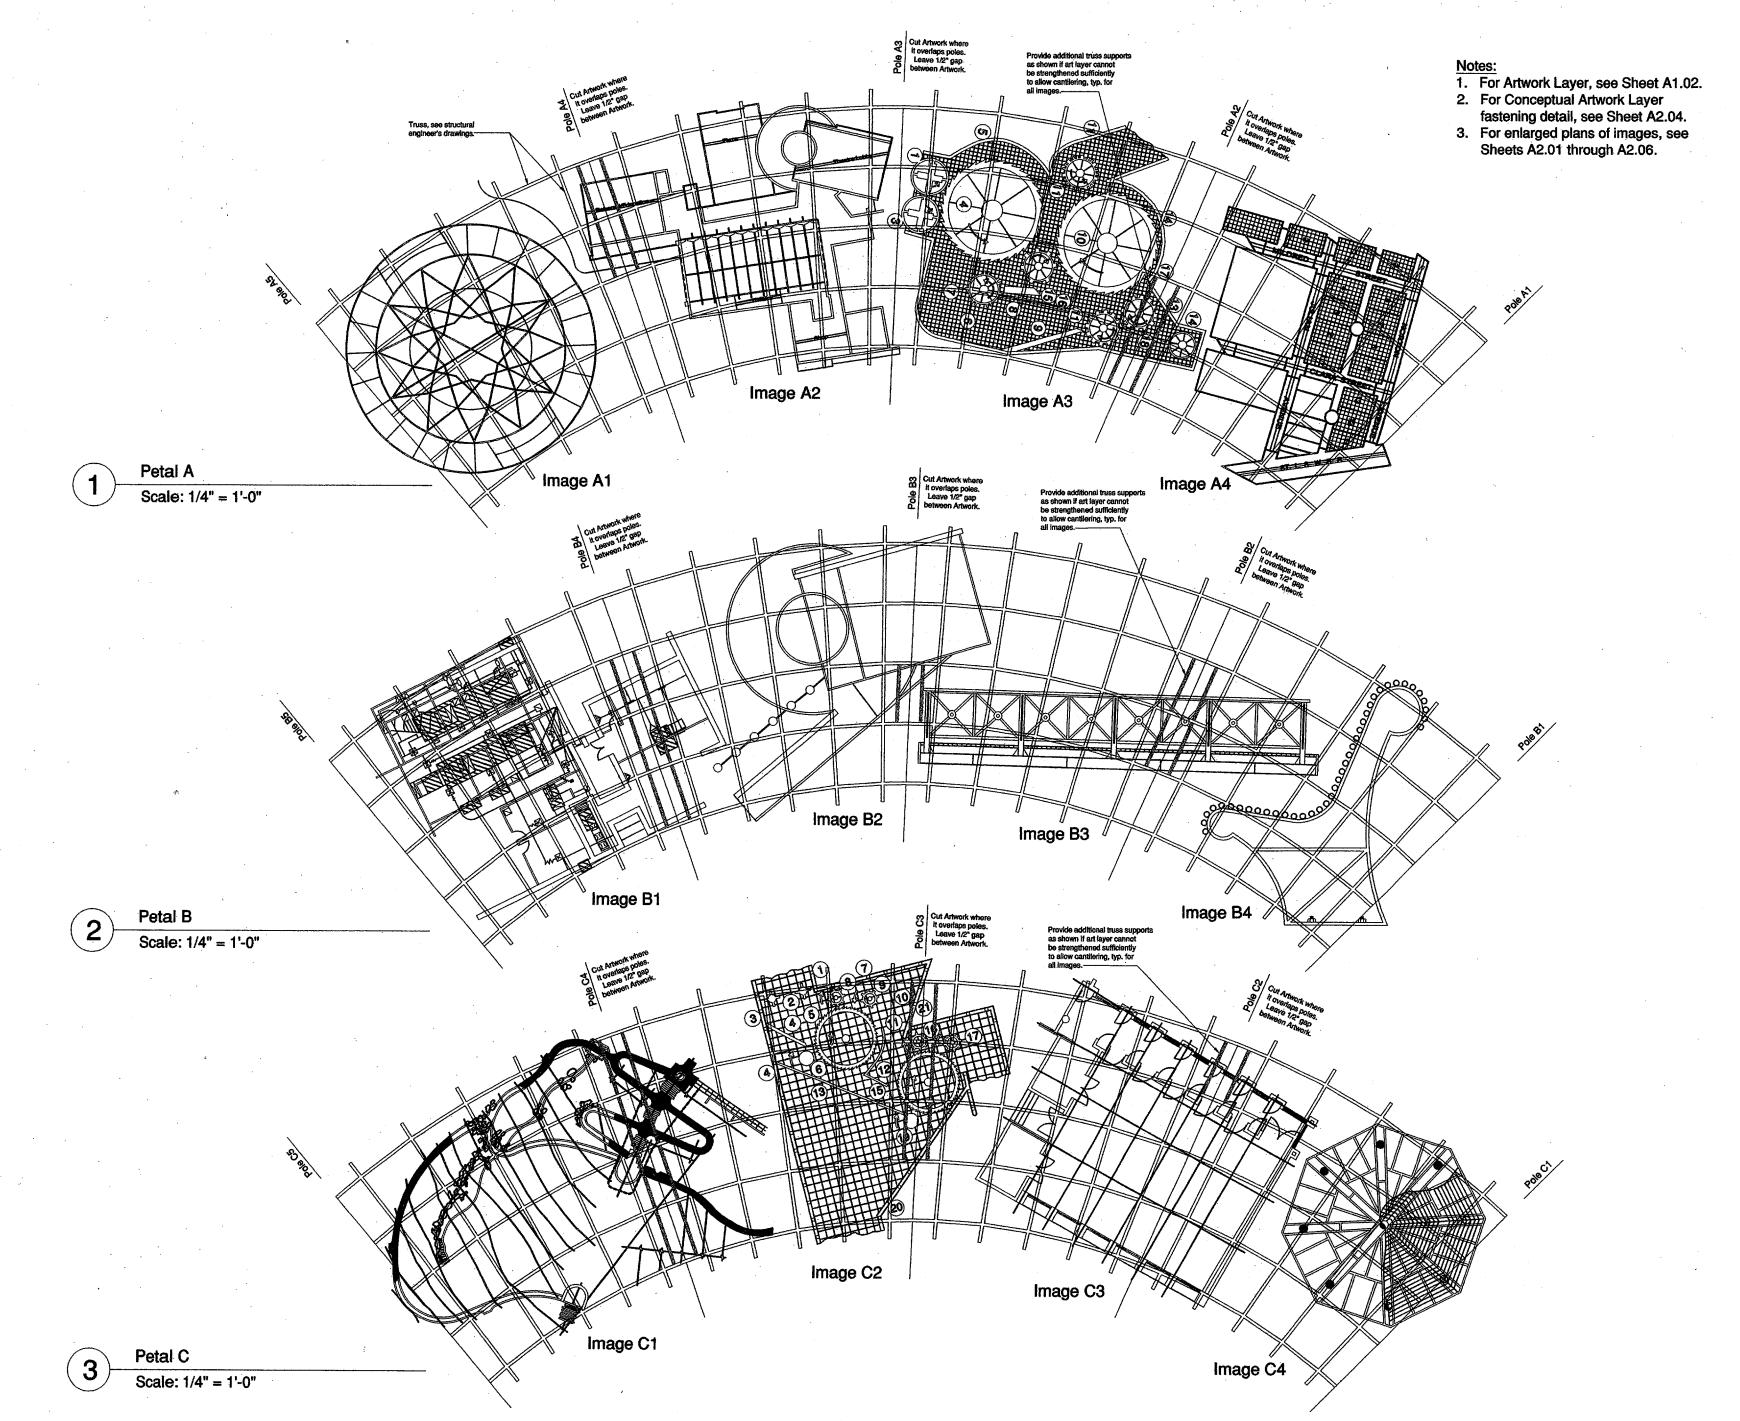

Addison, Texas

Bid No. 98-10

Client:
Town of Addison
P.O. Box 144
5300 Belt Line Road
Addison, Texas 75001-0144
Tel: 972.450.7000
Fax: 972.450.7043

Landscape Architect:
Michael Van Valkenburgh Associates, Inc
231 Concord Avenue
Cambridge, Massachusetts 02138
Tel: 617.864.2076

Artist:
Mel Chin
P.O. Box 566
Burnsville, North Carolina 28714
Tel: 704.682.7199
Fax: 212.388.9330

Fax: 617.492.3128

Architect / Design Consultant: Thompson and Rose Architects 1430 Massachusetts Ave. Cambridge, MA 02138 Tel: 617.876.9966 Fax: 617.876.9922

Structural Engineer: LeMessurier Consultants 675 Massachusetts Avenue Cambridge, MA 02138 Tel: 617.868.1200 Fax: 617.661.7520

Lighting Designer:
Cline Bettridge Bernstein Lighting Design
30 West 22ad Street
New York, NY 10010
Tel: 212.741.3280
Fax: 212.741.3112

Metal Fabricator Cost Consultant: Metalmorphosis
3101 S. La Cienega Boulevard
Los Angeles, CA 90016
Tel: 310.287.0593 Fax: 310.287.0596

HBC Engineering, Inc. 4747 Irving Boulevard, Suite 206 Dallas, TX 75247 Tel: 214.630.1010 Fax: 214.630:7070

Electric Engineer: R.G. Vanderweil Engineers, Inc. 266 Summer St. Boston, MA 02210-1112 Tel: 617.423.7423 Fax: 617.423.7401


Irrigation Consultant:
Terry J. Little, Irrigation Consultant
16835 Addison Road
Suite 103
Dallas, TX 75248
Tel: 972.380.4566
Fax: 972.380.4566

100% Construction **Documents**

TEL (617) 864-2076 FAX (617) 492-3128

Artwork Layer-Petals A, B and C

JOS MUNISER 9630 DATE 12 August 1998 SCALE 1/4" = 1'=0"DRAWN BY EP, MR, SRC A1.01
CHECKED BY LS, MVV

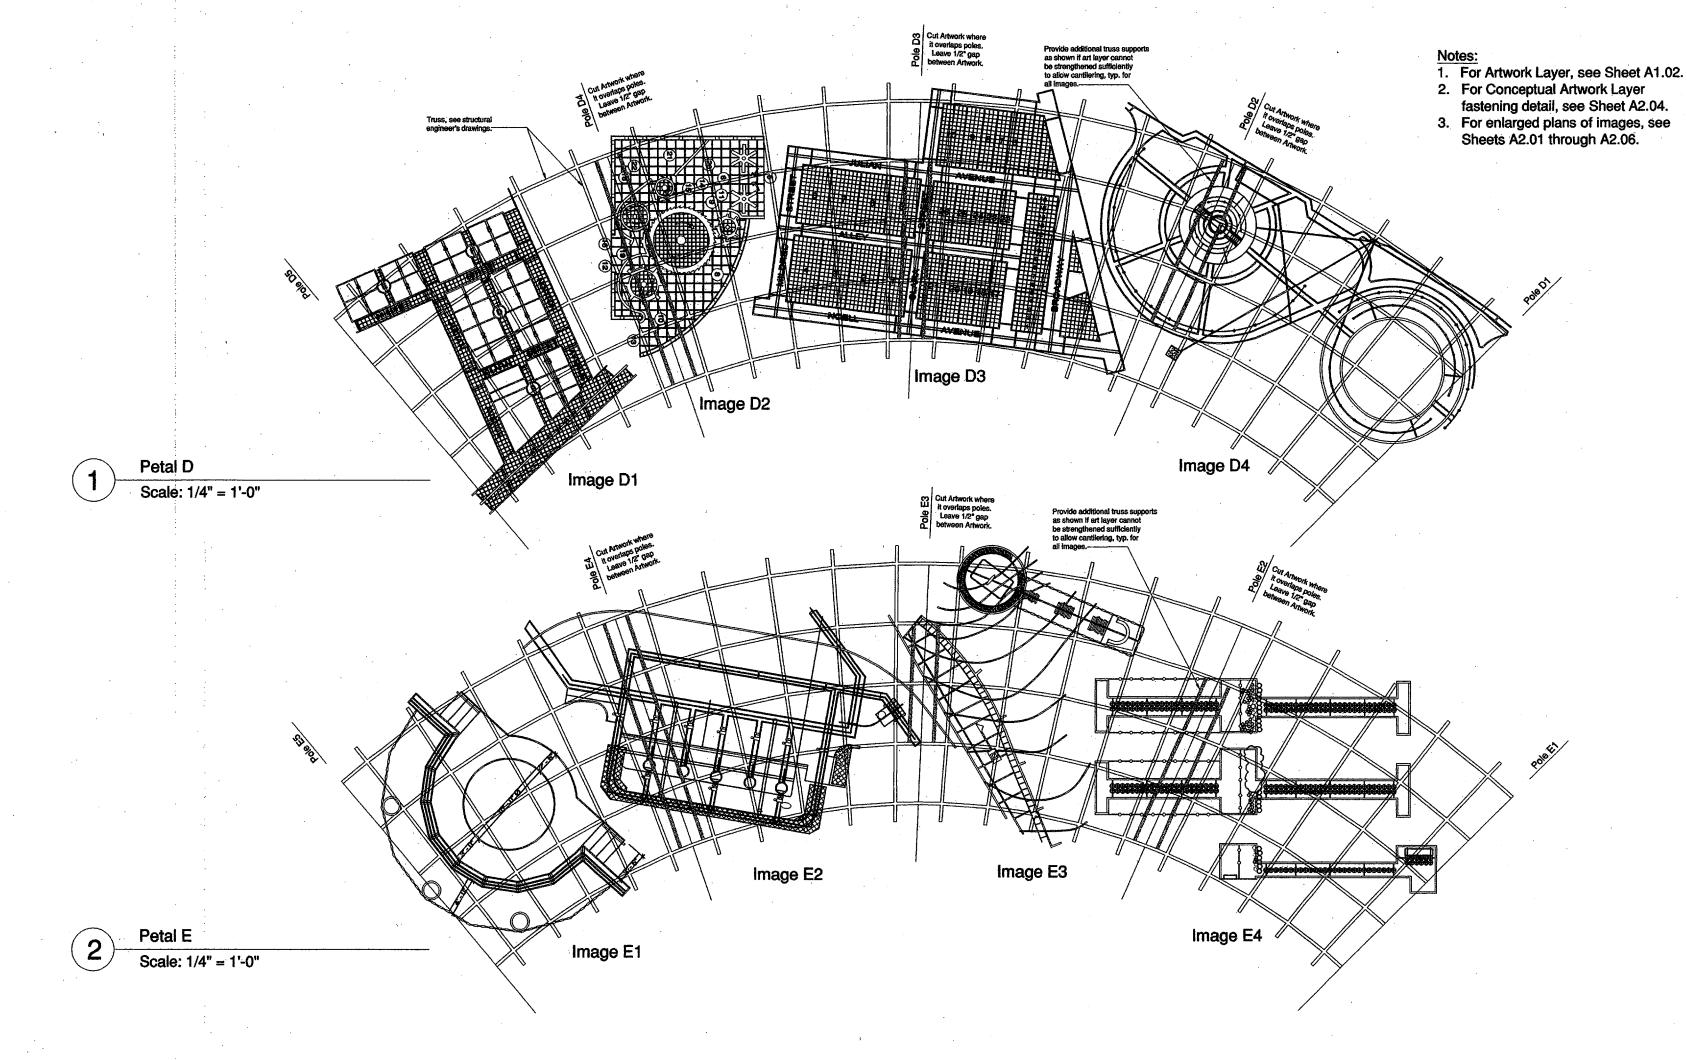

ARTWORK LAYER NOTES

- 1. The design and detailing of the artwork layers are schematic. The Drawings depict the general design intention and alignment of the artwork but they shall not be interpreted as being fully detailed. It is anticipated that the arrangement of the art images on the truss system may have to change in order to accommodate structural or attachment needs. The Contractor shall work with the Artist and the Landscape Architect to determine the final arrangement.
- 2. The artwork layer shall be attached to the truss system. A conceptual detail for attaching the artwork layer to the truss system is shown on the Drawings for the convenience of the Contractor but the Contractor shall decide for himself the final method of attachment that meets the standards set forth in the
- The Contractor shall submit Shop Drawings of the attachment system.
- The finishing of the attachment system shall match the finishing of the metal sculpture including cleaning, priming, and finish coats.
- The Contractor shall determine for himself the quantity of attachments necessary to attach the artwork layer to the truss system and poles.

- 3. The maximum depth of the artwork layer shall be three inches. The Contractor shall verify that this depth is not exceeded and he shall report any epancies to the Artist and Landscape Architect. Contractor shall resolve all conflicts to the satisfaction of the Artist and Landscape Architect prior to
- 4. The Contractor shall fully coordinate the fabrication of the artwork layer as to ensure that the pieces fit together. Coordination shall occur prior to, during, and after fabrication.
- 5. Drawings of the artwork layer "petals" and "images" are available to the Contractor in electronic format (the drawings were created in AutoCAD, Release 14). This information is offered for the convenience of the Contractor and it does not represent a warranty of the accuracy or usefulness of these Drawings.
- 6. The structural requirements of the trusses and poles necessitate that the artwork layer be cut where it straddles poles P2, P3, and P4. The artwork layer shall not be attached to poles P2, P3, and P4. The artwork layer may be attached to poles P1 and P5. Refer to Structural Drawings and Petal Plan Drawings for additional information.

- 7. Petal Plans on Sheets A1.01 and A1.02 are shown as reflected ceiling plans.
- 8. When erected, the Petal Panels will overlap and thus the Petal Images will
- 9. All welds for the Art Panels shall be sealed welded. The Contractor may, at his/her option, elect to make the WWM grid components only of stainless steel
- 10. Flame cut pieces shall be cut and cleaned, and grind rough edges. Edges do not have to be ground and squared. Blow outs do not have to be filled and
- 11. The components which make up the Art Images are layered. For example, the 1" x 3/4" tube on Image A1 shall be stacked to form a 3" deep profile.

ADDISON CIRCLE ROND POINT

Addison, Texas

Bid No. 98-10

Client: Town of Addison P.O. Box 144 5300 Belt Line Road Addison, Texas 75001-0144 Tel: 972.450,7000 Fax: 972.450.7043

Landscape Architect:
Michael Van Valkenburgh Associates, Inc.
231 Concord Avenue
Cambridge, Massachusetts 02138
Tel: 617.864.2076

Fax: 617.492.3128

Artist: Mel Chin P.O. Box 566

Burnsville, North Carolina 28714

Tel: 704.682.7199

Fax: 212.388.9330

Architect / Design Consultant: Thompson and Rose Architects 1430 Massachusetts Ave. Cambridge, MA 02138 Tel: 617.876.9966 Fax: 617.876.9922

Structural Engineer: LeMessurier Consultants 675 Massachusetts Avenu Cambridge, MA 02138 Tel: 617.868.1200 Fax: 617.661.7520

Lighting Designer: Cline Bettridge Bernstein Lighting Design 30 West 22nd Street New York, NY 10010 Tel: 212.741.3280 Fax: 212.741.3112

Metal Fabricator Cost Consul Metalmorphosis
3101 S. La Cienega Boulevard
Los Angeles, CA 90016
Tel: 310.287.0593 Fax: 310.287.0596

Geotechnical Engineer: HBC Engineering, Inc. 4747 Irving Boulevard, Suite 206 Dallas, TX 75247 Tel: 214.630.1010 Fax: 214.630.7070

Electric Engineer: R.G. Vanderweil Engineers, Inc. 266 Summer St. Boston, MA 02210-1112 Tel: 617.423.7423

Irrigation Consultant: Terry J. Little, Irrigation Consults 16835 Addison Road Suite 103 Dallas, TX 75248 Tel: 972.380.4566

100% Construction Documents

MICHAEL VAN VALKENBURGH ASSOCIATES, INC.

231 CONCORD AVENUE, CAMPRIDGE, NA 02138 USA

TEL (617) 864-2076 FAX (617) 492-3128

Artwork Layer-Petals D and E

JUB NUMBER 9630 DATE 12 August 1998 SCALE 1/4" = 1'=0" DRAWN BY EP, MR, SRC A1.02

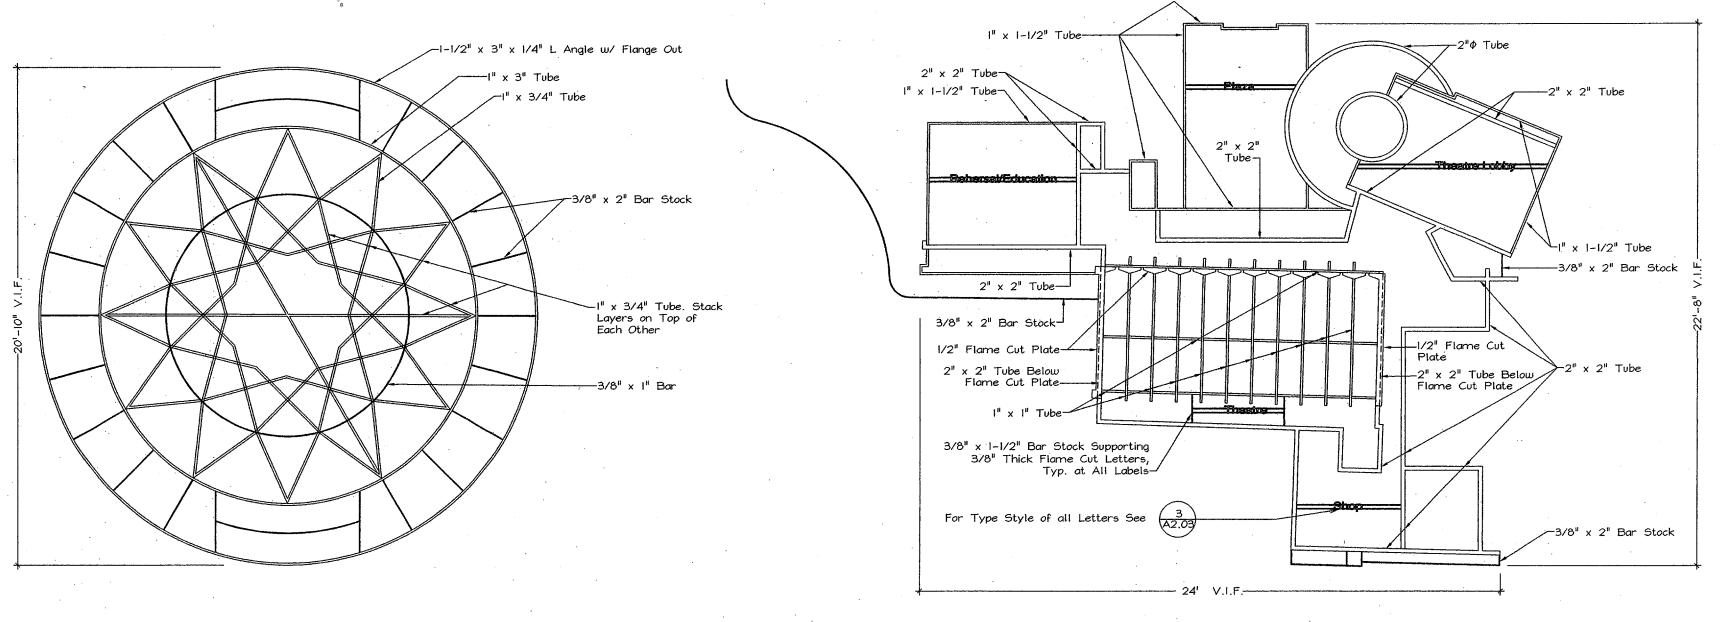


Image A1 Scale: 1/2" = 1'-0"


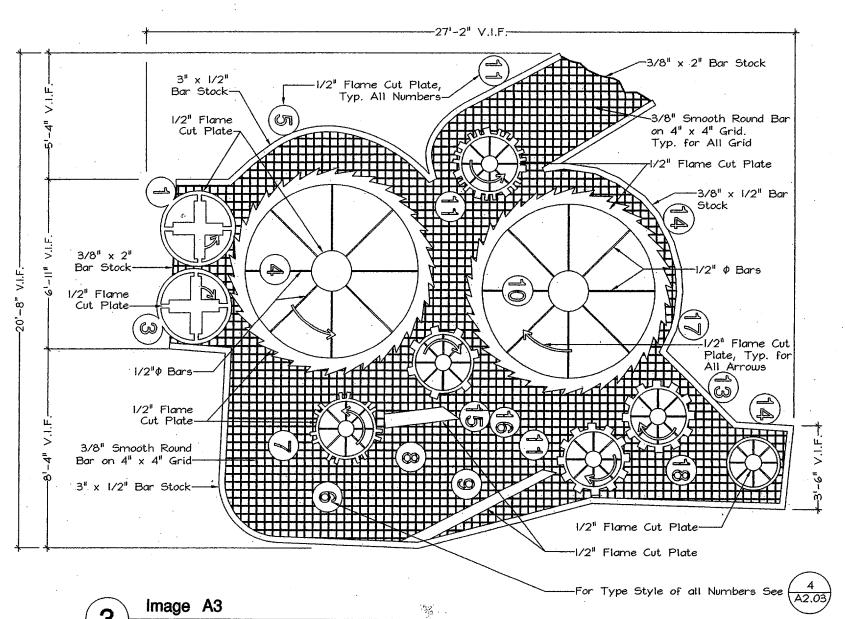


Image A2 Scale: 1/2" = 1'-0"

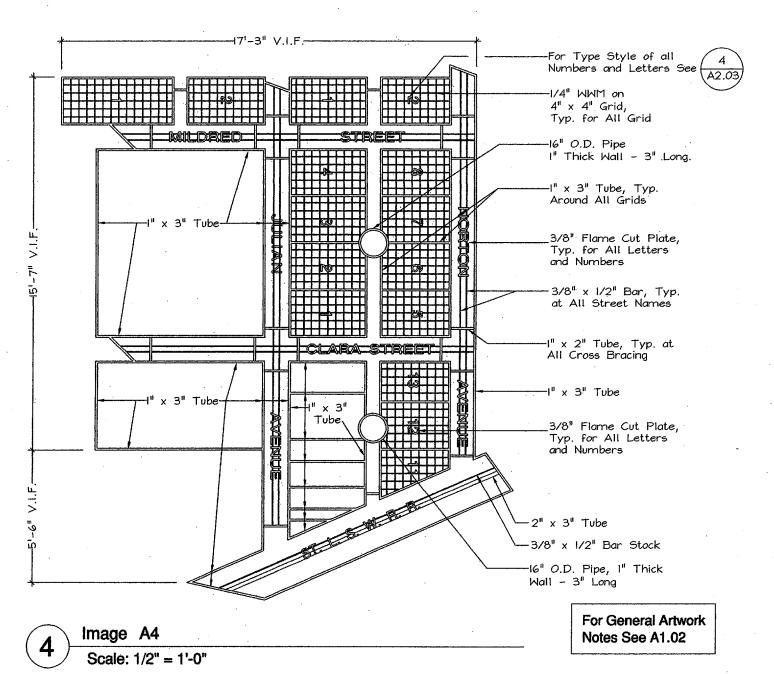

ADDISON CIRCLE **ROND POINT**

Addison, Texas

Bid No. 98-10

Client: Town of Addison P.O. Box 144 5300 Belt Line Road Tel: 972,450,7000 Fax: 972.450.7043

Landscape Architect:
Michael Van Valkenburgh Associates, Inc.
231 Concord Avenue Cambridge, Massachusetts 02138 Tel: 617.864.2076

Fax: 617.492.3128

Artist: Mel Chin P.O. Box 566
Burnsville, North Carolina 28714
Tel: 704.682.7199 Fax: 212.388.9330

Architect / Design Consultant Thompson and Rose Architects 1430 Massachusetts Ave. Cambridge, MA 02138 Tel: 617.876.9966

Fax: 617.876.9922 Structural Engineer: LeMessurier Consultants 675 Massachusetts Avenu Cambridge, MA 02138 Tel: 617.868.1200 Fax: 617.661.7520

Lighting Designer: Cline Bettridge Bernstein Lighting Design 30 West 22nd Street New York, NY 10010 Tel: 212.741.3280

Metal Fabricator Cost Consultant

Fax: 212.741.3112

Metalmorphosis
3101 S. La Cienega Boulevard
Los Angeles, CA 90016
Tel: 310,287,0593 Fax: 310.287.0596

Geotechnical Engineer HBC Engineering, Inc. 4747 Irving Boulevard, Suite 206 Dallas, TX 75247 Tel: 214,630,1010 Fax: 214.630.7070

Electric Engineer: R.G. Vanderweil Engineers, Inc. 266 Summer St. Boston, MA 02210-1112 Tel: 617.423.7423 Fax: 617.423.7401

Irrigation Consultant:
Terry J. Little, Irrigation Consultant
16835 Addison Road Suite 103 Dallas, TX 75248 Tel: 972.380.4566


100% Construction Documents

231 CONCORD AVENUE, CAMBRIDGE, MA 02138 USA TEL (617) 864-2076 FAX (617) 492-3128


Petal A Images A1 through A4

JUB MUMBER 9630 DATE 12 August 1998 SCALE 1/2" = 1'=0" DRAWN BY EP; MR, SRC A2.01


Scale: 1/2" = 1'-0"

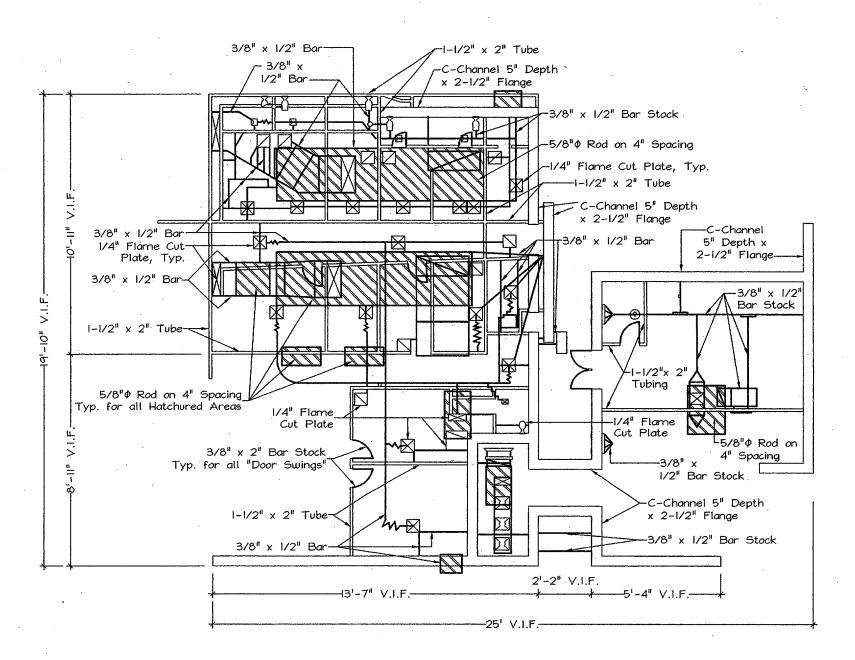


1 | Image B1 | Scale: 1/2" = 1'-0"

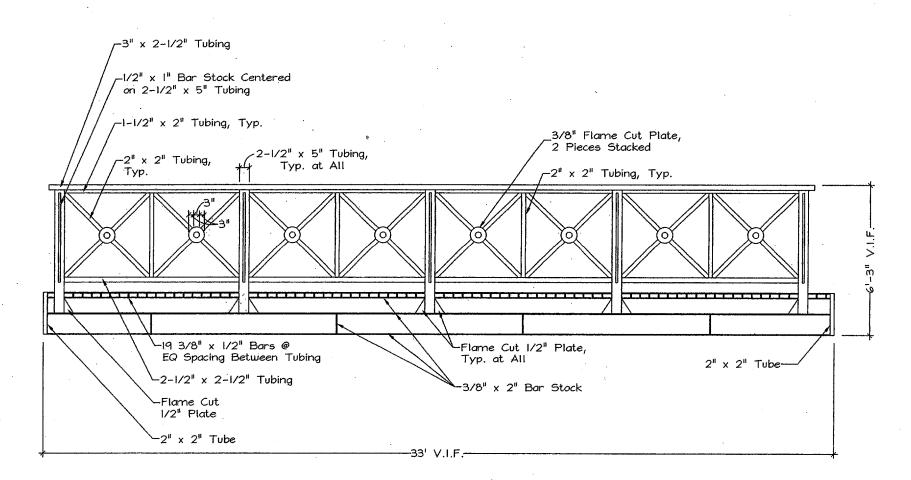

3 | Image B3 | Scale: 1/2" = 1'-0"

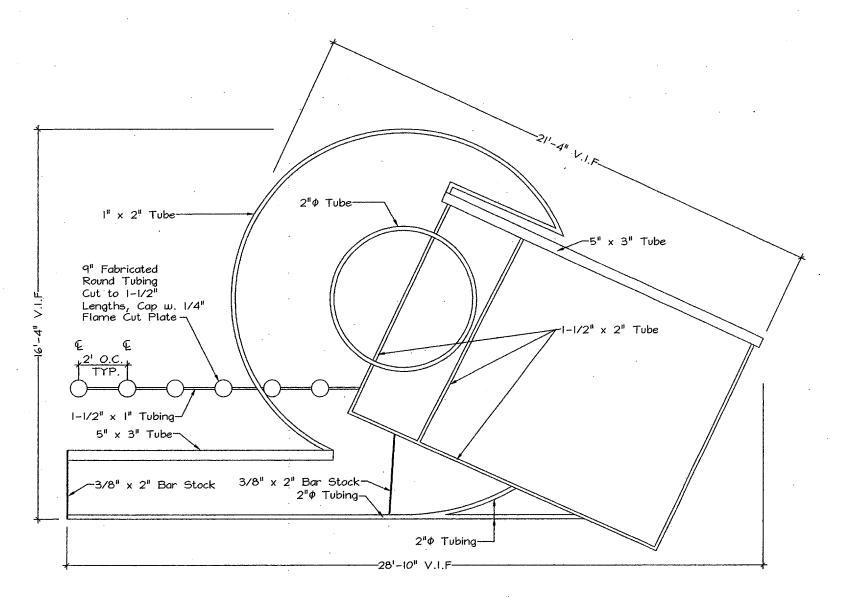

2 | Image B2 | Scale: 1/2" = 1'-0"

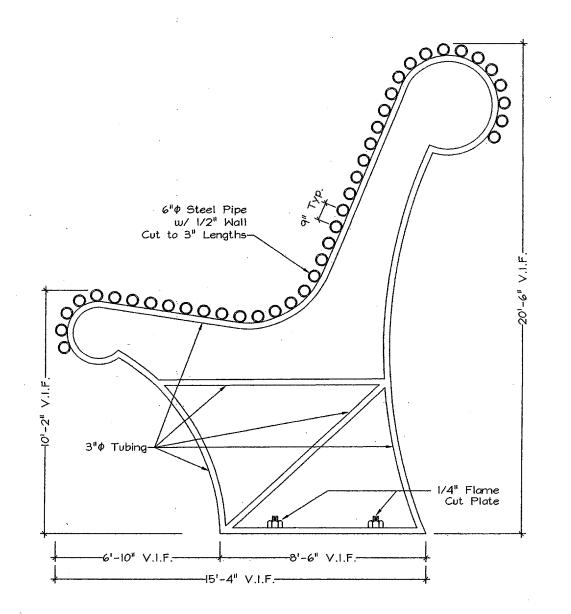

4 Image B4

Scale: 1/2" = 1'-0"

For General Artwork
Notes See A1.02

ADDISON CIRCLE ROND POINT

Addison, Texas

Bid No. 98-10

Client:
Town of Addison
P.O. Box 144
5300 Belt Line Road
Addison, Texas 75001-0144
Tel: 972.450.7000
Fax: 972.450.7043

Landscape Architect:
Michael Van Valkenburgh Associates, In
231 Concord Avenue
Cambridge, Massachusetts 02138
Tel: 617.864.2076
Fax: 617.492.3128

Artist:
Mel Chin
P.O. Box 566
Burnsville, North Carolina 28714
Tel: 704.682.7199
Fax: 212.388.9330

Architect / Design Consultant: Thompson and Rose Architects 1430 Massachusetts Ave. Cambridge, MA 02138 Tel: 617.876.9966

Structural Engineer: LeMessurier Consultants 675 Massachusetts Avenue Cambridge, MA 02138 Tel: 617.868.1200 Fax: 617.661.7520

Lighting Designer: Cline Bettridge Bernstein Lighting Design 30 West 22nd Street New York, NY 10010 Tel: 212.741.3280

Fax: 212.741.3112

Metal Fabricator Cost Consultan Metalmorphosis 3101 S. La Cienega Boulevard Los Angeles, CA 90016 Tel: 310.287.0593 Fax: 310.287.0596

Geotechnical Engineer: HBC Engineering, Inc. 4747 Irving Boulevard, Suite 206 Dallas, TX 75247 Tel: 214.630.1010 Fax: 214.630.7070

Electric Engineer: R.G. Vanderweil Engineers, Inc. 266 Summer St. Boston, MA 02210-1112 Tel: 617.423.7423 Fax: 617.423.7401

Irrigation Consultant:
Terry J. Little, Irrigation Consultant
16835 Addison Road
Suite 103
Dallas, TX 75248
Tel: 972.380.4566

100% Construction Documents

MICHAEL VAN VALKENBURGH ASSOCIATES, INC.

231 CONCORD AVENUE, CAMBRIDGE, MA 62138 USA
TEL (617) 864-2076 FAX (617) 492-3128

DRAWING TITLE


Petal B Images B1 through B4

DEP NUMBER 9630

DATE 12 August 1998

SCALE 1/2" = 1'=0"

DRAWN BY EP, MR, SRC
CHECKED BY LS, MVV

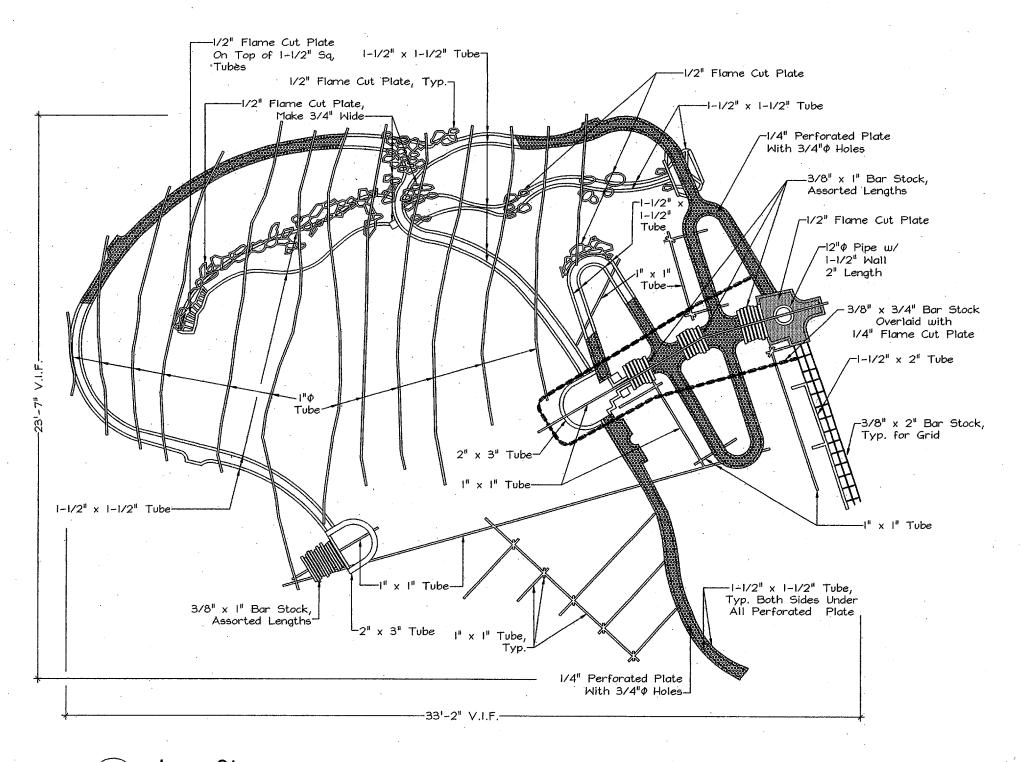

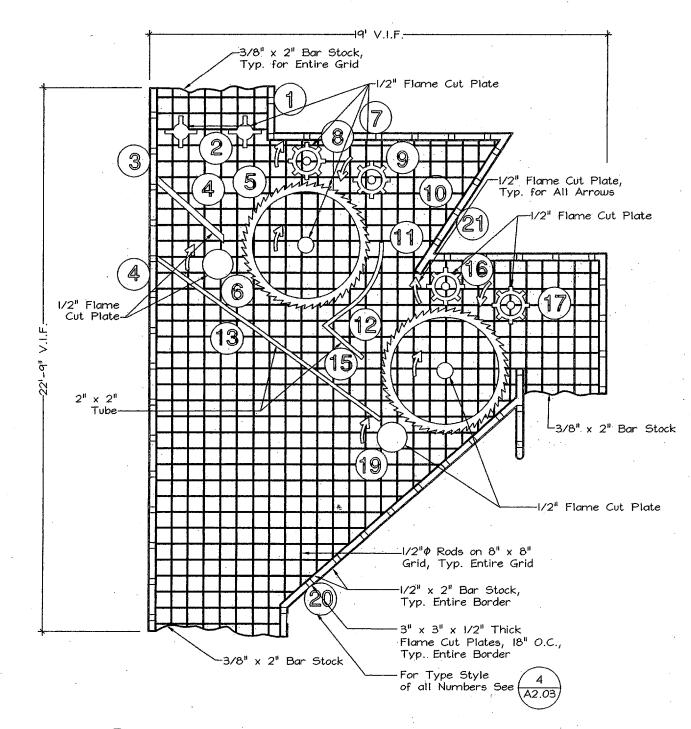


Image C1 Scale: 1/2" = 1'-0" Image C2 Scale: 1/2" = 1'-0"

Shop Theater Plaza Theater Lobby Rehearsal / Education 1 2 3 4 5 6 7 8 9 0

Letters / Numbers Type Style A Scale: NTS

12345 NORTON AVENUE 678910 JULIAN AVENUE 11 12 13 14 CLARA STREET 15 16 17 18 MILDRED STREET 19 20 21 22

Letters / Numbers Type Style B

Scale: NTS

ADDISON CIRCLE **ROND POINT**

Addison, Texas

Bid No. 98-10

Town of Addison P.O. Box 144 5300 Belt Line Road Addison, Texas 75001-0144 Tel: 972.450.7000 Fax: 972.450.7043

Landscape Architect: Michael Van Valkenburgh Associates, Inc 231 Concord Avenue

Cambridge, Massachusetts 02138 Tel: 617.864.2076 Fax: 617.492.3128

Artist: Mel Chin P.O. Box 566 Burnsville, North Carolina 28714 Tel: 704.682.7199

Fax: 212.388.9330 Architect / Design Consultant: Thompson and Rose Architects 1430 Massachusetts Ave. Cambridge, MA 02138 Tel: 617.876.9966

Structural Engineer: LeMessurier Consultants 675 Massachusetts Avenue Cambridge, MA 02138 Tel: 617.868.1200 Fax: 617.661.7520

Lighting Designer:
Cline Bettridge Bernstein Lighting Design
30 West 22nd Street
New York, NY 10010 Tel: 212.741.3280 Fax: 212.741.3112

Metal Fabricator Cost Consultant Metalmorphosis
3101 S. La Cienega Boulevard
Los Angeles, CA 90016
Tel: 310.287.0593

Geotechnical Engineer: HBC Engineering, Inc. 4747 Irving Boulevard, Suite 206 Dallas, TX 75247 Tel: 214.630.1010 Fax: 214.630.7070

Fax: 310.287.0596

Electric Engineer:
R.G. Vanderweil Engineers, Inc.
266 Summer St.
Boston, MA 02210-1112 Tel: 617.423.7423

Irrigation Consultant: Terry J. Little, Irrigation Consult 16835 Addison Road Suite 103 Dallas, TX 75248 Tel: 972.380.4566 Fax: 972.380.4566


100% Construction Documents

MICHAEL VAN VALKENBURGH ASSOCIATES, INC.


231 CONCORD AVENUE, CAMBRIDGE, MA 02138 USA TEL (617) 864-2076 FAX (617) 492-3128

Petal C Images C1 through C2

BATE 12 August 1998 SCALE 1/2" = 1'=0" DRAWN BY EP, MR, SRC A2.03

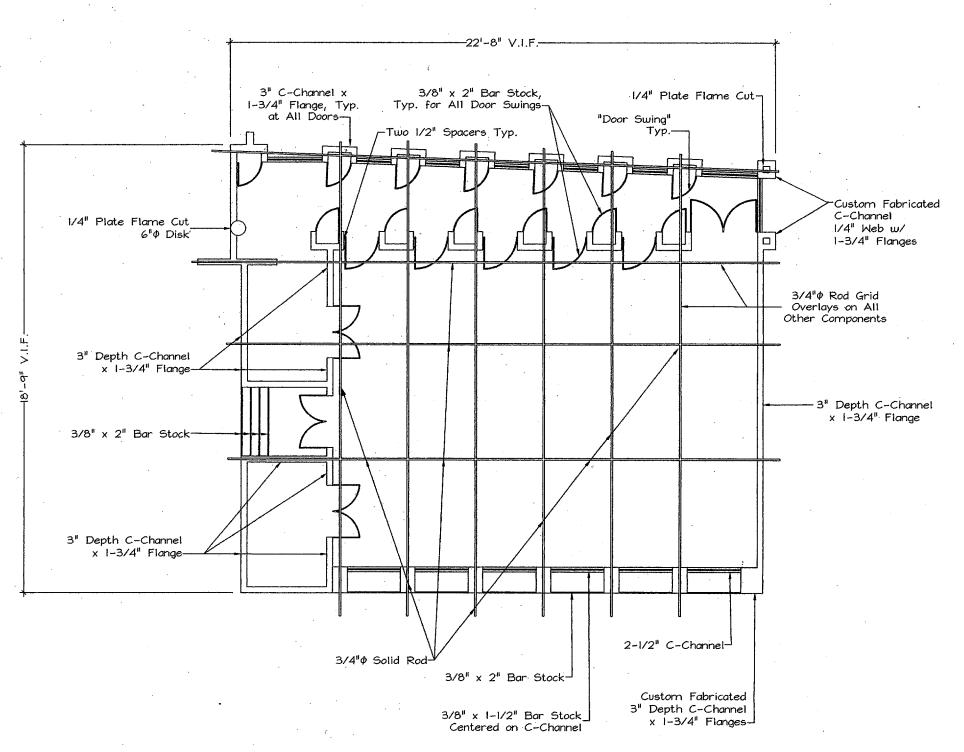


1 | Image C3 | Scale: 1/2" = 1'-0"

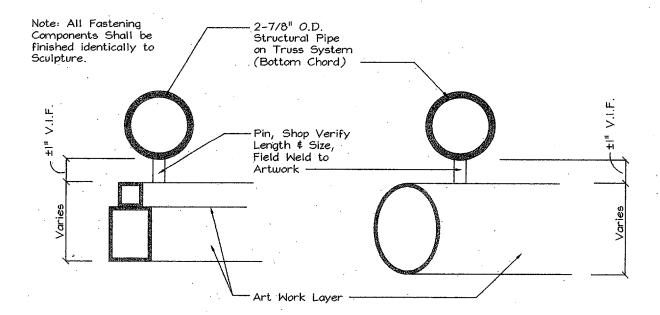

Conceptual Fastening Detail for Artwork Layer

Scale: 1/2" = 1"

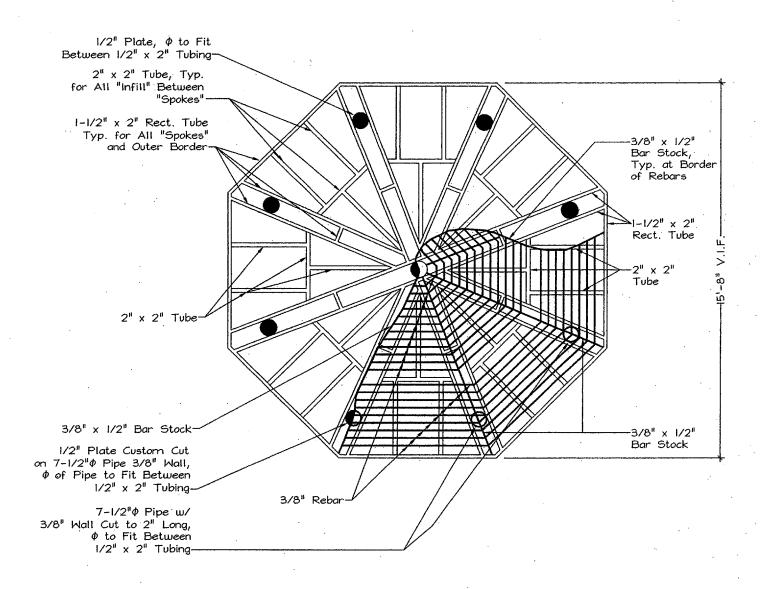

2 Image C4
Scale: 1/2" = 1'-0"

For General Artwork Notes See A1.02

ADDISON CIRCLE ROND POINT

Addison, Texas

Bid No. 98-10

Client:
Town of Addison
P.O. Box 144
5300 Belt Line Road
Addison, Texas 75001-0144
Tel: 972.450.7000
Fax: 972.450,7043

Landscape Architect:
Michael Van Valkenburgh Associates, Inc.
231 Concord Avenne
Cambridge, Massachusetts 02138
Tel: 617.864.2076
Fax: 617.492.3128

Architect / Design Consultant: Thompson and Rose Architects 1430 Massachusetts Ave. Cambridge, MA 02138 Tel: 617.876.9966 Fax: 617.876.9922

Structural Engineer: LeMessurier Consultants 675 Massachusetts Avenue Cambridge, MA 02138 Tel: 617.868.1200 Fax: 617.661.7520

Lighting Designer:
Cline Bettridge Bernstein Lighting Design
30 West 22nd Street
New York, NY 10010
Tel: 212.741.3280
Fax: 212.741.3112

Metal Fabricator Cost Consultant:
 Metalmorphosis
3101 S. La Cienega Boulevard
 Los Angeles, CA 90016
 Tel: 310.287.0593
 Fax: 310.287.0596

Geotechnical Engineer: HBC Engineering, Inc. 4747 Irving Boulevard, Suite 206 Dallas, TX 75247 Tel: 214.630.1010 Fax: 214.630.7070

Electric Engineer:
R.G. Vanderweil Engineers, Inc.
266 Summer St.
Boston, MA 02210-1112
Tel: 617.423.7423

Irrigation Consultant:
Terry J. Little, Irrigation Consultant
16835 Addison Road
Suite 103
Dallas, TX 75248
Tel: 972.380.4566

100% Construction Documents


ICHAEL VAN VALKENBURGH ASSOCIATI


231 CONCORD AVENUE, CAMBRIDGE, HA 02138 USA TEL (617) 864-2076 FAX (617) 492-3128

DRAVING TITLE


Petal C Images C3 through C4


JOB NUMBER 9630 BRAVUE NAMBER DATE 12 August 1998 SEALE $1/2^n = 1^n = 0^n$ BRAVIN BY EP, MR, SRC A2.04

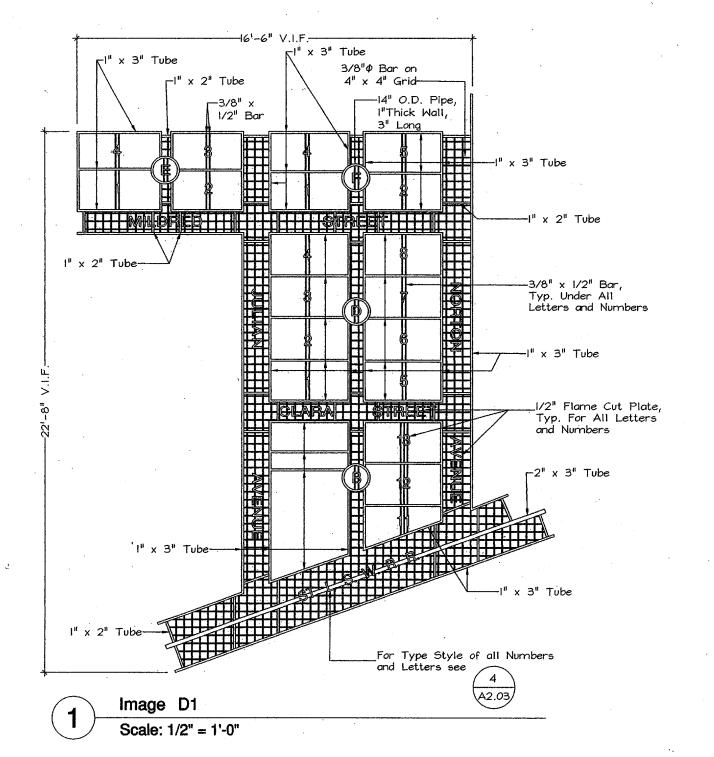

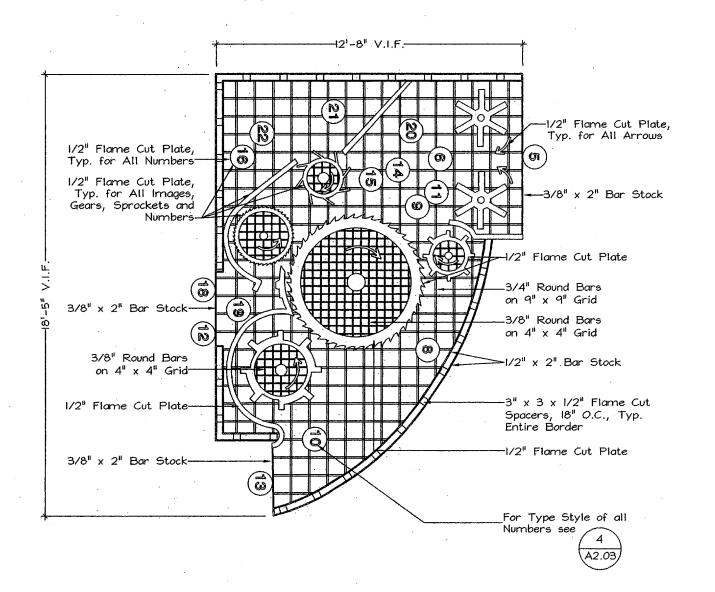

| Image D2 | | Scale: 1/2" = 1'-0"

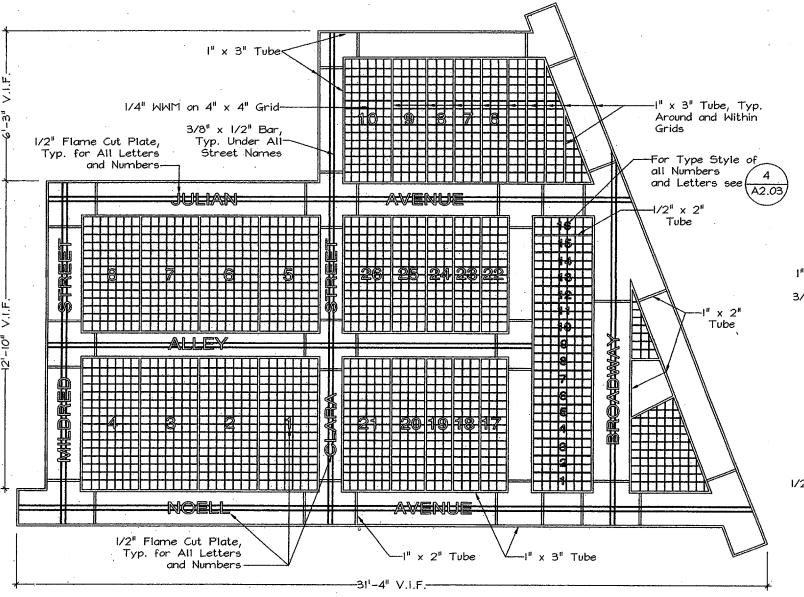

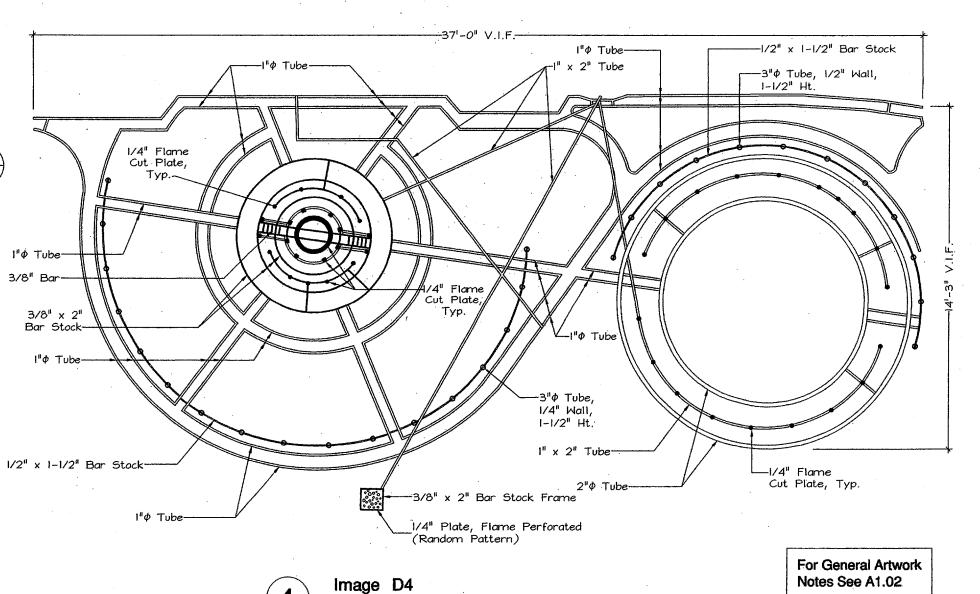

Scale: 1/2" = 1'-0"

ADDISON CIRCLE ROND POINT

Addison, Texas

Bid No. 98-10

Client:
Town of Addison
P.O. Box 144
5300 Belt Line Road
Addison, Texas 75001-0144
Tel: 972.450.7000
Fax: 972.450.7043

Landscape Architect:
Michael Van Valkenburgh Associates, Inc.
231 Concord Avenue
Cambridge, Massachusetts 02138
Tel: 617.864.2076
Fax: 617.492.3128

Architect / Design Consultant: Thompson and Rose Architects 1430 Massachusetts Ave, Cambridge, MA 02138 Tel: 617.876.9966

Structural Engineer: LeMessurier Consultants 675 Massachusetts Avenue Cambridge, MA 02138 Tel: 617.868.1200 Fax: 617.661.7520

Lighting Designer:
Cline Bettridge Bernstein Lighting Design
30 West 22nd Street
New York, NY 10010
Tel: 212.741.3280
Fax: 212.741.3112

Metal Fabricator Cost Consultant:
Metalmorphosis
3101 S. La Cienega Boulevard
Los Angeles, CA 90016
Tel: 310.287.0593
Fax: 310.287.0596

Geotechnical Engineer: HBC Engineering, Inc. 4747 Irving Boulevard, Suite 206 Dallas, TX 75247 Tel: 214.630.1010 Fax: 214.630.7070

Electric Engineer: R.G. Vanderweil Engineers, Inc. 266 Summer St. Boston, MA 02210-1112 Tel: 617.423.7423

Irrigation Consultant:
Terry J. Little, Irrigation Consultant
16835 Addison Road
Suite 103
Dallas, TX 75248
Tel: 972-380-4566

100% Construction Documents

MICHAEL VAN VALKENBURGH ASSOCIATES, INC.

231 CUNCORD AVENUE, CAMBRIDGE, MA 02138 USA TEL (617) 864-2076 FAX (617) 492-3128

DRAVING TITLE

Petal D Images D1 through D4

DE NAMBER 9630 DRAVING MANGER

DATE 12 AUGUST 1998


SCALE 1/2" = 1"=0"


DRAVN BY EP, MR, SRC
CHECKED BY LS, MVV

DRAVE A 2.05

3 Image D3

Scale: 1/2" = 1'-0"

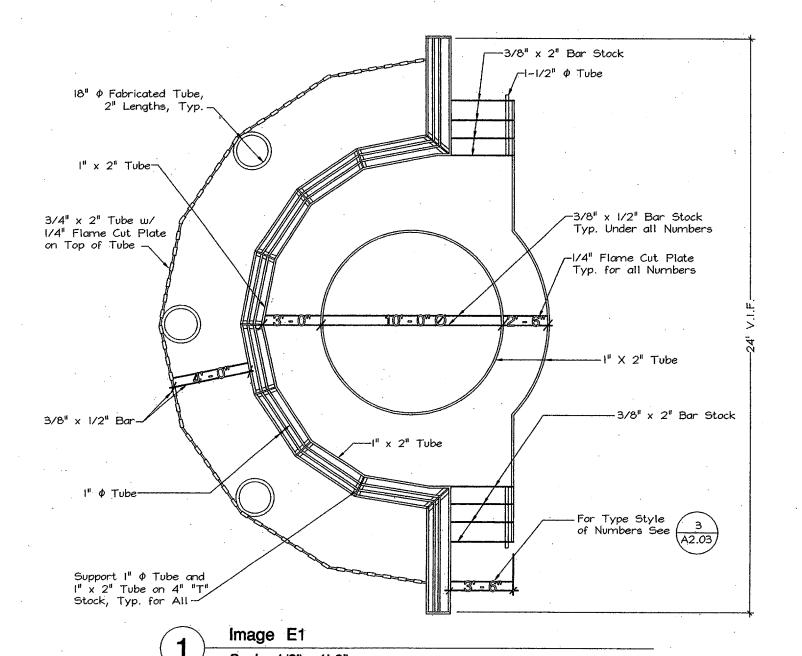

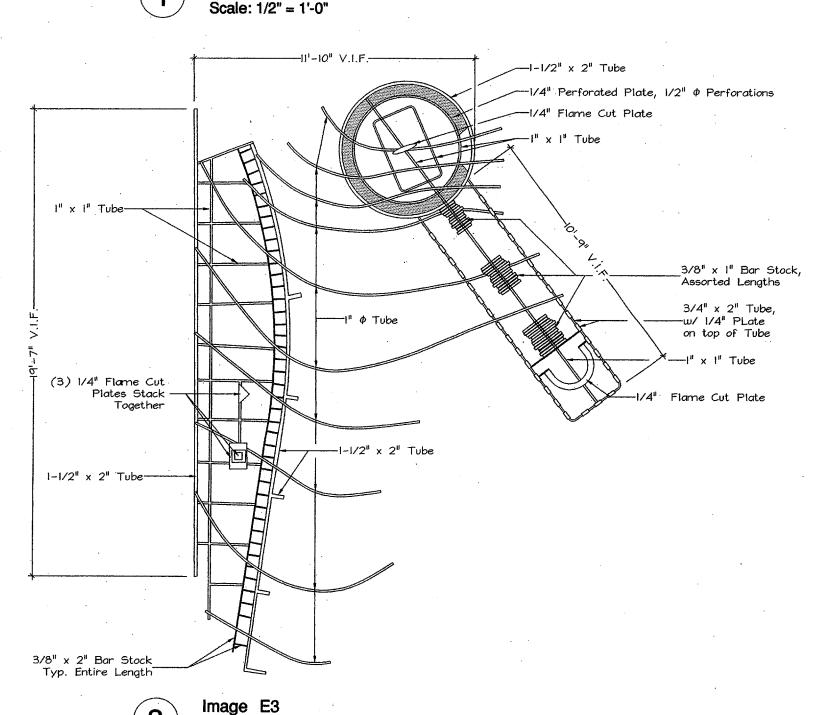

Scale: 1/2" = 1'-0"

-37'-I" V.I.F.--1-1/2" x 1-1/2" Tube -1/2" x 1-1/2" Tube w/ r1/2" Flame 1/4" Flame Cut Plate Cut Plate attached to Tube, typ. x 1-1/2" Tube Tube 3/8" x 1-1/2" Bar Stock 1/4" Flame CutPlate Irregular Pattern, Attach to Grid 1" x 1-1/2" 1/4" Flame Cut Plate, Typ. 3/8" x 1/2" Bar Stock-3/8" WWM --2-1/2" Depth C-Channel on 4" x 4" Grid typ. Entire Grid. -1/2" Flame Cut Plate **−3/8" x 1−1/2" Ba**r Stock 12" Φ Tube, Cut to 2" Length, Typ.-3/8" x 1-1/2" Bar Stock-1/2" Flame Cut Plate

| Image E2 | Scale: 1/2" = 1'-0"

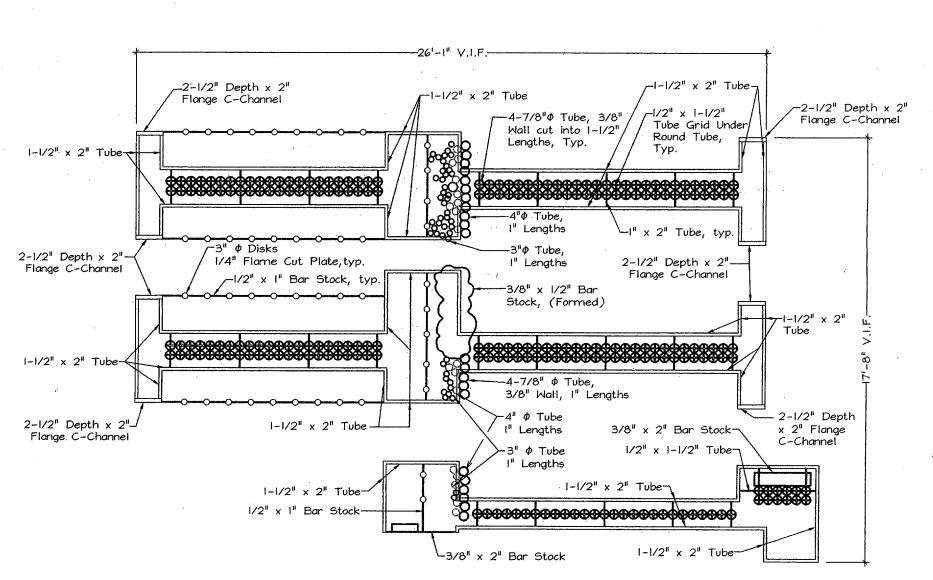


Image E4
Scale: 1/2" = 1'-0"

For General Artwork
Notes See A1.02

ADDISON CIRCLE ROND POINT

Addison, Texas

Bid No. 98-10

Client:
Town of Addison
P.O. Box 144
5300 Belt Line Road
Addison, Texas 75001-0144
Tel: 972.450.7000
Fax: 972.450.7003

Landscape Architect:
Michael Van Valkenburgh Associates, Inc.
231 Concord Avenue
Cambridge, Massachusetts 02138
Tel: 617.864.2076

Fax: 617.492.3128

Artist: Mel Chin P.O. Box 566 Burnsville, North Carolina 28714 Tel: 704.682.7199

Architect / Design Consultant: Thompson and Rose Architects 1430 Massachusetts Ave. Cambridge, MA 02138 Tel: 617.876.9966 Fax: 617.876.9922

Structural Engineer: LeMessurier Consultants 675 Massachusetts Avenue Cambridge, MA 02138 Tel: 617.868.1200 Fax: 617.661.7520

Lighting Designer:
Cline Bettridge Bernstein Lighting Design
30 West 22nd Street
New York, NY 10010
Tel: 212.741.3280

Fax: 212.741.3112

Metal Fabricator Cost Consultant Metalmorphosis 3101 S. La Cienega Boulevard Los Angeles, CA 90016 Tel: 310.287.0593

Geotechnical Engineer: HBC Engineering, Inc. 4747 Irving Boulevard, Suite 206 Dallas, TX 75247 Tel: 214.630.1010 Fax: 214.630.7070

Fax: 310.287.0596

Electric Engineer: R.G. Vanderweil Engineers, Inc. 266 Summer St. Boston, MA 02210-1112 Tel: 617.423.7423 Fax: 617.423.7401

Irrigation Consultant:
Terry J. Little, Irrigation Consultant
16835 Addison Road
Suite 103
Dallas, TX 75248
Tel: 972.380.4566

100% Construction Documents

MICHAEL VAN VALKENBURGH ASSOCIATES, INC.

231 CONCORD AVENUE, CAMBRIDGE, NA 02138 USA TEL (617) 964-2076 FAX (617) 492-3128

RAVING TITLE


Petal E Images E1 through E4

DIS NUMBER 9630

DATE 12 August 1998

SCALE 1/2" = 1'=0"

DRAVIN BY EP, MR, SRC
CHECKED BY, LS, MVV

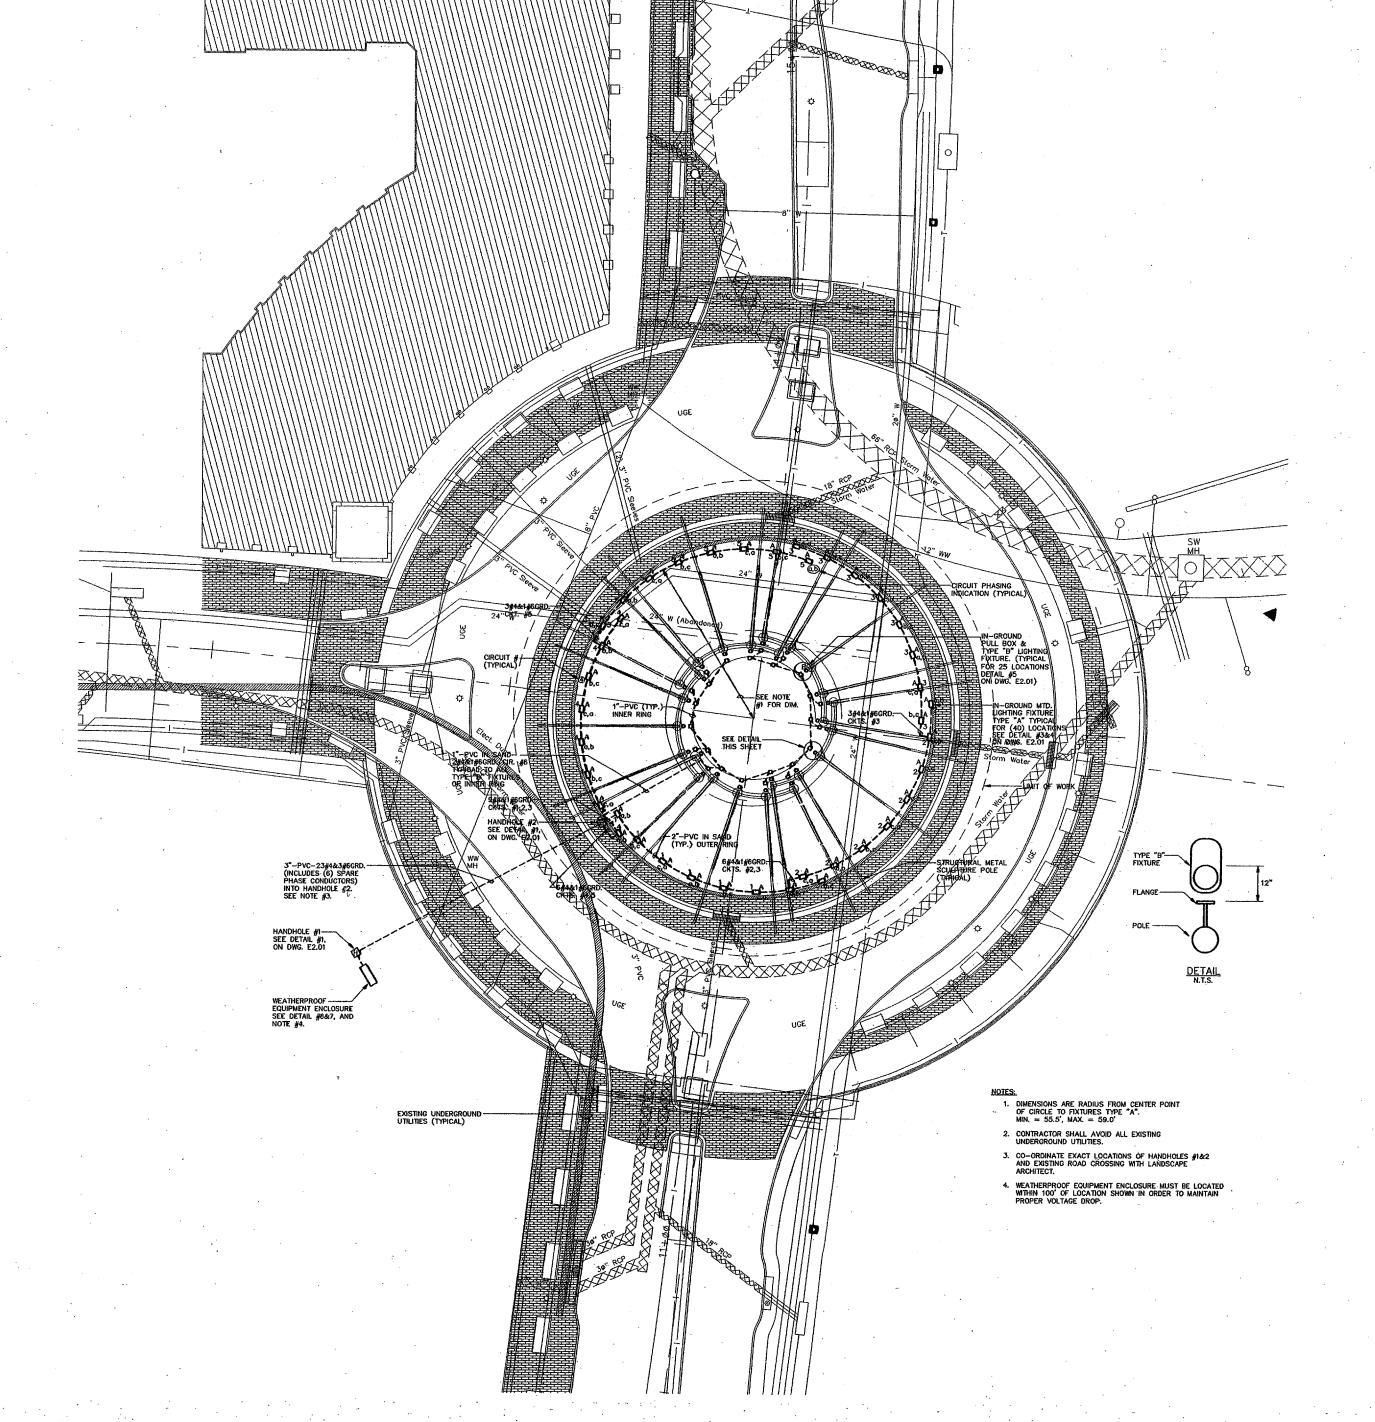



Addison, Texas

BID NO. 98-10

Client: Town of Addison P.O. Box 144 5300 Belt Line Road Addison, Texas 75001-0144 Tel: 972.450.7000 Fax: 972.450.7043

Landscape Architect: Michael Van Valkenburgh Associates, Inc. 231 Concord Avenue Cambridge, Massachusetts 02138 Tel: 617.864.2076

Fox: 617.492.3128

Artist: Mel Chin P.O. Box 566 Burnsville, North Carolina 28714 Tel: 704.682.7199 Fax: 212.388.9330

Architect / Design Consultant: Thompson and Rose Architects 1430 Massachusetts Ave. Cambridge, MA 02138 Tel: 617.876.9966 Fax: 617.876.9922

Structural Engineer: LeMessurier Consultants 675 Massachusetts Avenue Combridge, MA 02138 Tel: 617.868.1200 Fax: 617.661.7520

Lighting Designer:
Cline Bettridge Bernstein
Lighting Design
30 West 22nd Street
New York, NY 10010
Tel: 212.741.3280 Fox: 212.741.3112

Metal Fabricator Cost Consultant: Metalmorphosis 3101 S. La Cienega Boulevard Los Angeles, CA 90016 Tel: 310.287.0593 Fax: 310.287.0596

Geotechnical Engineer: HBC Engineering, Inc. 4747 Irving Boulevard, Suite 206 Dailas, TX 75247 Tel: 214.630.1010 Fax: 214.630.7070

Electric Engineer: R.G. Vanderweil Engineers, Inc. 266 Summer St. Boston, MA 02210-1112 Tel: 617.423.7423 Fax: 617.423.7401

Irrigation Consultant:
Terry J. Little,
Irrigation Consultant
16835 Addison Road
Suite 103
Dallas, TX 75248
Tel: 972.380.4566
Fax: 972.380.4566

100% CONSTRUCTION DOCUMENTS



TEL (807) 864-9170 FAX (807) 460-3129

DRAWING TITLE

ELECTRICAL SITE LIGHTING PLAN


JOB HUMBER 98158,000 DATE 12 August 48 SCALE 1"= 16"-0"


E-1.01 DRAWN BY PJM CHECKED BY J.K.


	GENERAL ABE		IATIONS
A	AMPERES	KVA	KILOVOLT AMPERES
ADA	AMERICANS WITH DISABILITIES ACT	KW	KILOWATTS
AFF	ABOVE FINISH FLOOR	LTG	LIGHTING
AFG	ABOVE FINISH GRADE	LFMC	LIQUIDTIGHT FLEXIBLE METAL
AHJ	AUTHORITY HAVING JURISDICTION		CONDUIT
AHU	AIR HANDLING UNIT	MC	METAL CLAD CABLE
AIC	AMPERE INTERRUPTING CAPACITY	MCB	MAIN CIRCUIT BREAKER
AL	ALUMINUM	MCC	MOTOR CONTROL CENTER
ANSI	AMERICAN NATIONAL STANDARDS	MCP-	MOTOR CIRCUIT PROTECTOR
	INSTITUTE	MISC	MISCELLANEOUS
ARCH	ARCHITECT	MLO	MAIN LUGS ONLY
ATS	AUTOMATIC TRANSFER SWITCH	NC	NORMALLY CLOSED
ATC	AUTOMATIC TEMPERTURE CONTROL	NEC	NATIONAL ELECTRIC CODE
AWG	AMERICAN WIRE GAUGE	NEMA	NATIONAL ELECTRICAL
BFG	BELOW FINISH GRADE		MANUFACTURES ASSOCIATION
BLDG	BUILDING	NFPA	NATIONAL FIRE PROTECTION ASSOCIATION
С	CONDUIT	NO	NORMALLY OPEN OR NUMBER
CAT	CATALOG	NTS	NOT TO SCALE
CB .	CIRCUIT BREAKER	P	POLE
CBM	CERTIFIED BALLASTS MANUFACTURERS	PB	PUSHBUTTON
CKT	CIRCUIT	PNL	PANEL
CL	CENTERLINE	POS	PROVIDED UNDER OTHER SECTIONS
CLF	CURRENT LIMITING FUSE	PVC	POLYVINYL CHLORIDE
COL	COLUMN	PWR	POWER
CPT	CONTROL POWER TRANSFORMER	QTY	QUANITY
CT	CVRRENT TRANSFORMER	REQ'D	REQUIRED
CU	COPPER	RMC	RIGID METAL CONDUIT
DWG	DRAWING	RMS	ROOT MEAN SQUARED
EC '	ELECTRICAL CONTRACTOR	RNMC	RIGID NON-METALLIC CONDUIT
EF	EXHAUST FAN	RTU	ROOF TOP UNIT
EM	EMERGENCY	SP	SPARE
EMT	ELECTRICAL METALLIC TUBING	SW	SWITCH
EPO	EMERGENCY POWER OFF	SYM	SYMMETRICAL
EWC F	ELECTRIC WATER COOLER FUSE	TEL	TELEPHONE
FA '	FIRE ALARM	TMCB	THERMAL MAGNETIC CIRCUIT
FLA			BREAKER
FMC	FULL LOAD AMPERES FLEXIBLE METAL CONDUIT	UG	UNDERGROUND OR UNDERGRADE
FT	FEET	UL	UNDERWRITERS LABORATORIES
GND.G	GROUND OR GROUNDING	V	VOLT
GRMC	GALVANIZED RIGID METALLIC CONDUIT	`VT	VOLTAGE TRANSFORMER
HOA	HAND, OFF, AUTOMATIC SWITCH	W	WRE
HUA	INSTITUTE OF ELECTRICAL AND	WH.	WATER HEATER
ICCE	ELECTRONIC ENGINEERS	WP	WEATHER PROOF
IMC	INTERMEDIATE METAL CONDUIT	XFMR	TRANSFORMER
INT	INTERLOCK	Δ	DELTA
KCMIL	THOUSAND CIRCULAR MILS	Υ	WYE
KUMIL	THOUGHT UNDULAR MILS	Ø	PHASE


LEGEND				LIGHTING FIXTURE SCHE					
3□ ^A _{0,b}	IN-GROUND MOUNTED LIGHTING FIXTURE . "A" DENOTES TYPE, "3" DENOTES CIRCUIT NUMBER, "a,b" DENOTES CIRCUIT PHASING FROM A 3 PHASE FEED.		FIXTURE TYPE	DESCRIPTION	MANUFACTURER AND CATALOG NUMBER				
J'B'	IN-GROUND MOUNTED LIGHTING PIXTURE. "B" DENOTES TYPE, FIXTURE SHOWN WITH I" LIQUIDITIE FLEX AND B"x8"x7"D FIBRE-REINFORSED JUNCTION BOX. ALL COSTS TO FURNISH AND INSTALL FOXURE TYPE "B" AND FLEX. WIRING SHALL BE PROVIDED UNDER "ADD ALTERNATE". COMPOSOLITE HAND-HOLE, SEE DETAIL \$1 ON THIS DRAWING. - P.V.C. CONDUIT AND WIRING RUN DIRECT BURIED, THROUGHOUT SITE, FOR LIGHTINE SYSTEM. SEE DRAWING E1.01 FOR SIZING AND LAYOUT. INSTALL CONDUIT AS DIRECTED BY PROJECT MANAGER IN FIELD.		Α	METAL HALIDE CANOPY UPLIGHT NOTE: BASE FIXTURE WITH INTEGRAL BALLAST MOUNTED	STERNER "INFRANOR" 565-MOD/WELL LIGHT-N-N-N- 48x79-1000H-208V-E				
H				ON CROSS BRACE WITHIN CUSTOM 16"M/28"Lx42"D GALVANIZED STEEL HOUSING WITH 1" DEEP x 1"o.c. GRATE ENCLOSURE, BEAM DISTRIBUTION TO MEET MANUFACTURER PHOTOMETRIC FILE #872559.les.					
			θ	METAL HALIDE PAR-30 DIRECT BURIAL COLUMN ACCENT LIGHT	GREENLEE LIGHTING INC. M-MDB-35-MH-208V- MOD/MHPAR-30L-BLK- TR-HL				
· · · · · · · · · · · · · · · · · · ·				NOTE: 1. MODIFIED FOR METAL HALIDE PAR 30 LONG NECK LAMP. 2. INCLUDE (ADD-ALTERNATE) TO PROVIDE AND INSTALL TYPE "9" FIXTURE ONLY, BOXES, CONDUIT					
		•		INSTALL TYPE "B" FIXTURE ONLY, BOXES, CONDUIT AND WRING SHALL BE PART OF BASE BID.	,				

	CONTACTO	R SCHI	EDULE			
UNIT NO.	FUNCTION	VOLTAGE	AMPERAGE	POLES	ENCLOSURE	REMARKS
1	CONTROL OF LIGHTING - PETAL "A"	208,3¢	40	3	OPEN	
2	CONTROL OF LIGHTING - PETAL "B"	208,3¢	40	3	OPEN	
3	CONTROL OF LIGHTING - PETAL "C"	208,3ø	40	3	OPEN	
4	CONTROL OF LIGHTING - PETAL "D"	208,3¢	40	3	OPEN -	
5	CONTROL OF LIGHTING - PETAL "E"	208,3ø	40	3	OPEN	
6	CONTROL OF LIGHTING - INNER CIRCLE	208,1¢	40	2	OPEN	
7	SPARE (PROVIDE LOOSE)	208,3¢	40	3	OPEN	
						•
·						
		1				

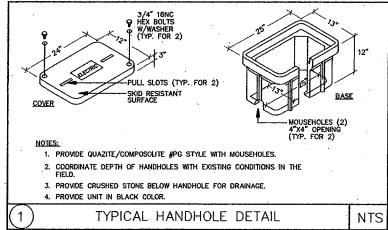

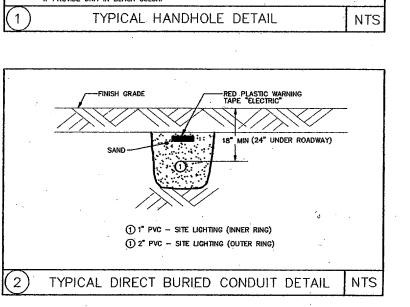

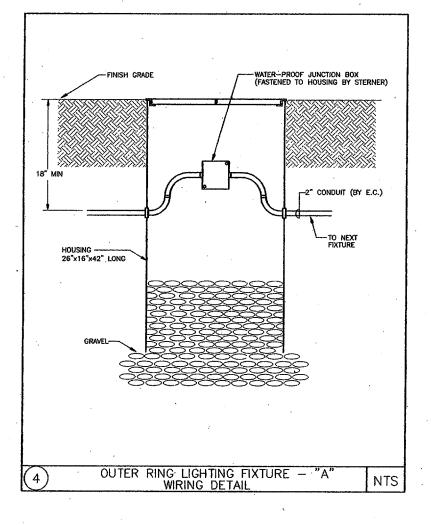


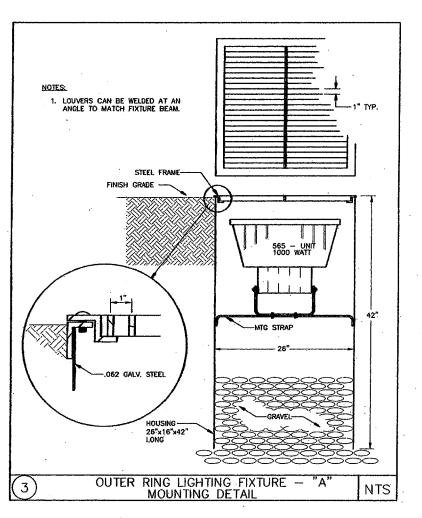



LAMPS


TYPE


208

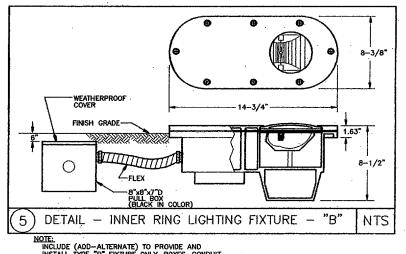

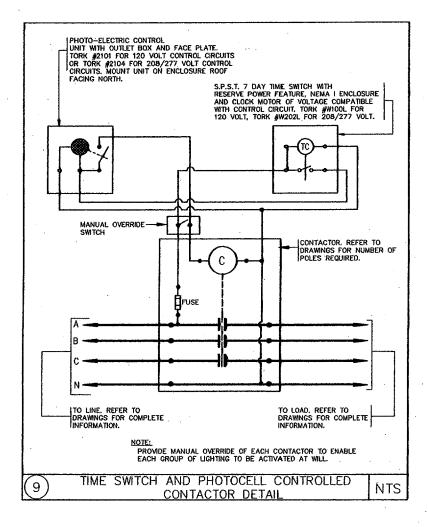

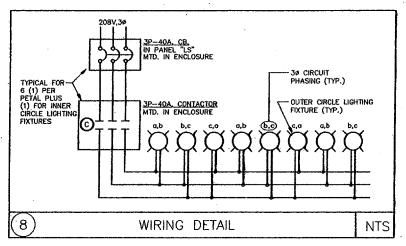

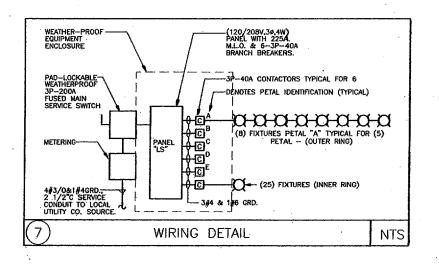

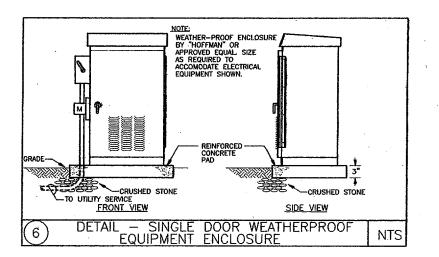

ADDISON CIRCLE **ROND POINT**

Addison, Texas

BID NO. 98-10

Town of Addison 5300 Belt Line Road Addison, Texas 75001-0144 Tel: 972.450.7000 Fax: 972,450,7043

Landscape Architect: Associates, Inc.

231 Concord Avenue Combridge, Massachusetts 02138 Tel: 617.864.2076 Fax: 617.492.3128

> Artist: Mel Chin P.O. Box 566 Burnsville, North Carolina 28714 Tel: 704,682,7199 Fax: 212.388.9330

Architect / Design Consultant: Thompson and Rose

Architects 1430 Massachusetts Ave. Combridge, MA 02138 Tel: 617.876.9966 Fax: 617.876.9922

Structural Engineer: LeMessurier Consultants 675 Massachusetts Avenue Cambridge, MA 02138 Tel: 617.868.1200

Lighting Designer: Cline Bettridge Bernstein Lighting Design 30 West 22nd Street

New York, NY 10010 Tel: 212.741.3280 Metal Fabricator Cost Consultant: 3101 S. La Cienega

Los Angeles, CA 90016 Tel: 310.287.0593 Fox: 310.287.0596 Geotechnical Engineer:

HBC Engineering, Inc. 4747 Irving Boulevard, Suite 206 Dallas, TX 75247 Tel: 214.630,1010 Fax: 214.630.7070

Electric Engineer: R.G. Vanderweil Engineers, Inc. 266 Summer St. Boston, MA 02210-1112 Tel: 617.423.7423 Fax: 617.423.7401

irrigation Consultant: Terry J. Little; Irrigation Consultant 16835 Addison Road Suite 103 Dallas, TX 75248 Tel: 972.380.4566

Fax: 972.380.4566

100% CONSTRUCTION DOCUMENTS



TEL (807) 884-2678 FAX (807) 492-3128


DRAWING TITLE

ELECTRICAL LEGEND, DETAILS, SCHEDULES, AND GENERAL NOTES

JOB NUMBER 98158.00 DATE 12 August 98 GCALE N.T.S.

DRAWN BY PJM

E-2.01 CHECKED BY J.K.

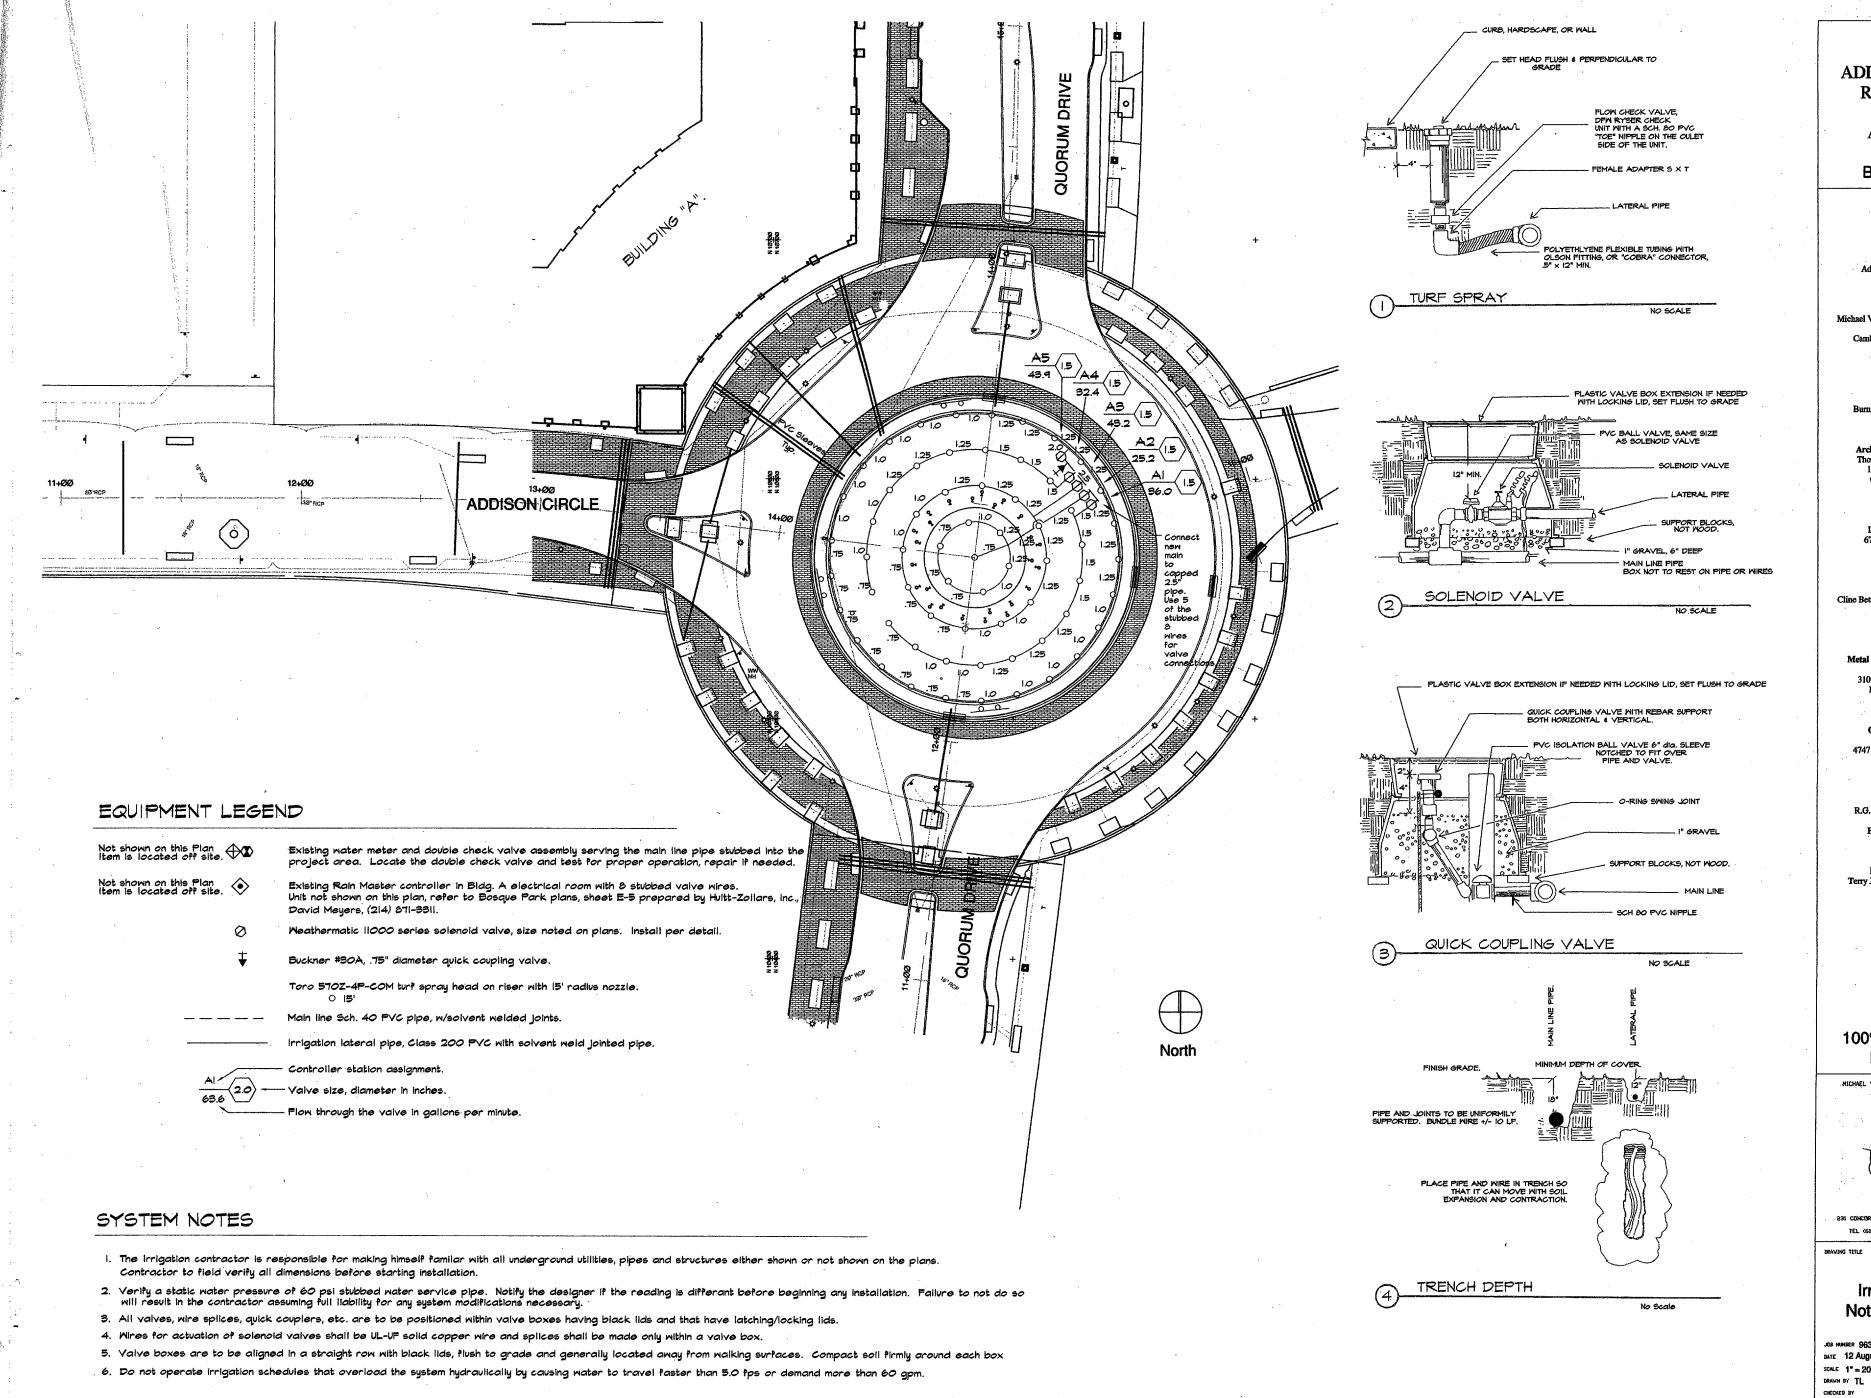

Addison, Texas

Bid No. 98-10

Client: Town of Addison P.O. Box 144 5300 Belt Line Road Addison, Texas 75001-0144 Tel: 972.450.7000 Fax: 972.450.7043

Landscape Architect: Michael Van Valkenburgh Associate 231 Concord Avenue

Cambridge, Massachusetts 02138 Tel: 617.864.2076 Fax: 617.492.3128

Artist: Mel Chin P.O. Box 566 Burnsville, North Carolina 287.14 Tel: 704,682,7199 Fax: 212.388.9330

Architect / Design Consultant: Thompson and Rose Architects 1430 Massachusetts Ave. Cambridge, MA 02138 Tel: 617.876.9966

Structural Engineer: LeMessurier Consultants 675 Massachusetts Avenue Cambridge, MA 02138 Tel: 617.868.1200 Fax: 617.661.7520

Lighting Designer: Cline Bettridge Bernstein Lighting Design 30 West 22nd Street New York, NY 10010 Tel: 212.741.3280

Fax: 212.741.3112

Metal Fabricator Cost Consultant

Metalmorphosis
3101 S. La Cienega Boulevard
Los Angeles, CA 90016
Tel: 310.287.0593 Fax: 310.287.0596

Geotechnical Engineer HBC Engineering, Inc. 4747 Irving Boulevard, Suite 206 Dallas, TX 75247

Tel: 214.630.1010

Electric Engineer: R.G. Vanderweil Engineers, Inc. 266 Summer St. Boston, MA 02210-1112

Tel: 617.423.7423 Fax: 617.423.7401

Irrigation Consultant: Terry J. Little, Irrigation Consultant 16835 Addison Road

Dallas, TX 75248 Tel: 972.380.4566 Fax: 972.380.4566

100% Construction Documents

MICHAEL VAN VALKENBURGH ASSOCIATES, INC.



235 CONCORD AVENUE, CAMBRIDGE, NA 02138 USA TEL (617) 864-2076 FAX (617) 492-3128

Irrigation Plan, Notes and Details

JOB HUMBER 9630 рате 12 August 1998 SCALE 1" = 20'-0"

11.01