
CONSTRUCTION PLANS FOR

MAINSTAY SUITES OF ADDISON ADDITION ADDISON, TEXAS

GENERAL NOTES

- A. Prior to final acceptance by the Town of Addison,
 - A Texas Registered Professional Engineer shall certify that the project was constructed in accordance with the plans and specifications approved by the Town of Addison.
 - 2. The owner shall provide 1 reproducible set of as—built (sealed and certified by a Texas Registered Engineer) and 2 blue line sets.
 - 3. A five foot sidewalk shall be installed along the public streets. See attached detail
 - 4. A one year 10% maintenance bond is required for the public infrastructure
 - 5. Contractor shall demonstrate that the water and sanitary sewer systems meet the proper pressure, bacteria, and mandrel tests. In addition, the owner shall provide a VHS format video tape of the sanitary sewer.
- B. Prior to starting construction, the contractor shall contact the utility companies to locate existing facilities. These include but may not be limited to the following:
 - Town of Addison
 Lone Star Gas
 - 3. Southwestern Bell
 - 4. Storer Cable5. Planned Cable Systems
 - . TU Electric
- C. Prior to beginning construction, the owner or his authorized representative shall convene a preconstruction conference among the Town of Addison, Consulting Engineers, Contractor(s), Utility companies and any other affected parties. Notify Bruce Ellis 450—2847 at least 48 hours prior to beginning of construction.
- D. Any existing pavement, curbs, and/or sidewalks damaged or removed will be repaired by the contractor at their expense.
- E. Lot pins shall be installed after construction and prior to final acceptance. Concrete monuments shall be placed as shown on the final plat and iron pins shall be placed at Block corners, curve points and angle points in public right—of—way. Concrete monuments shall be six (6) inches in diameter and twenty—four (24) inches long. An iron rod one—half inch in diameter embedded at least three (3) inches in the monument at the exact intersection point of the monument. The monument shall be set at such an elevation that after construction, the top of the monument will be not less than twelve (12) inches below the ground surface.
- F. The contractor shall stamp a 2-inch "S" and a 2-inch "W" in the curb at the location of the sewer service and water service lines, respectfully.
- G. At intersections that have valley drainage, the crown of the intersecting streets will culminate in a distance of 40 feet from the intersecting curb line unless otherwise noted.
- H. Temporary or permanent street barricades shall remain at all points of ingress and egress to prevent public use until such streets receive final acceptance.
- . Contractor shall obtain a right—of—way permit by the Town of Addison for working within the public right—of—way.
- J. During construction, the owner shall provide a qualified geotechnical lab to perform materials testing during the construction at the request of the Town of Addison.
- K. The contractor shall submit material sheets to the Town of Addison for approval prior to incorporating materials into the job.
- L. The utility contractor shall submit to the Town of Addison for approval a trench safety plan sealed by a Registered Professional Engineer for the installation of utilities greater than five (5) feet in depth.
- M. All existing and proposed improvements (valves, manholes, fire hydrants, water meters, etc.) shall be adjusted to finished grade by the contractor.

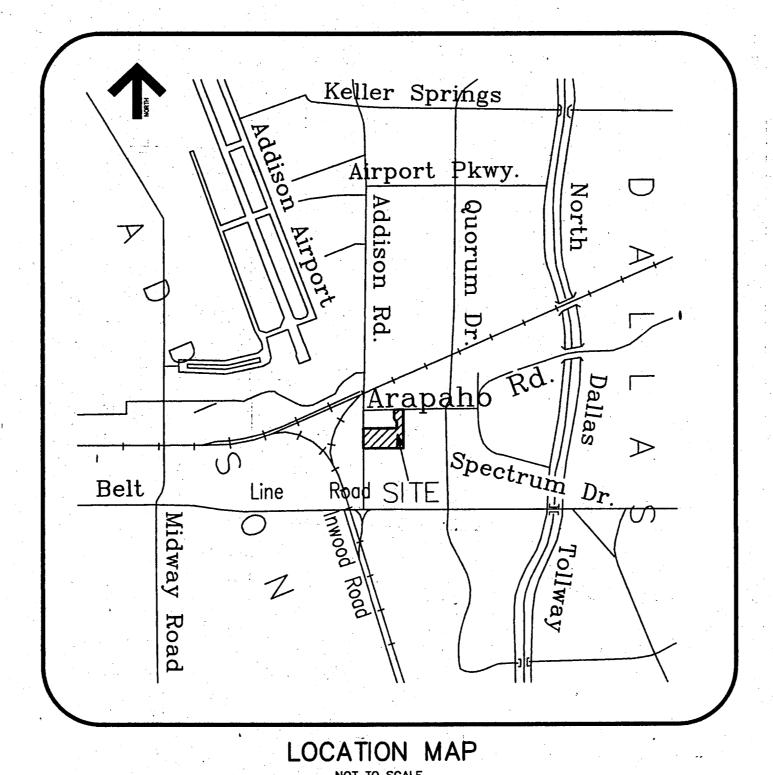

OWNER:

RAIL HOTELS CORPORATION 1839 FORT WORTH AVENUE DALLAS, TEXAS 75208 TELEPHONE: (214) 742-3037 CONTACT: ISHWARBHAI A. DESAI

SHEET LIST


SUBDIVISION PLAT

- C1 SITE DIMENSIONAL CONTROL PLAN
- C2 GRADING AND PAVING PLAN
- C3 EROSION CONTROL PLAN
- C4 PAVEMENT JOINT PATTERN PLAN
- C5 UTILITY SERVICES PLAN
- C6 PAVING AND EROSION CONTROL DETAILS

PREPARED BY:

JAMES DEWEY, JR., P.E.

JDJR ENGINEERS AND CONSULTANTS

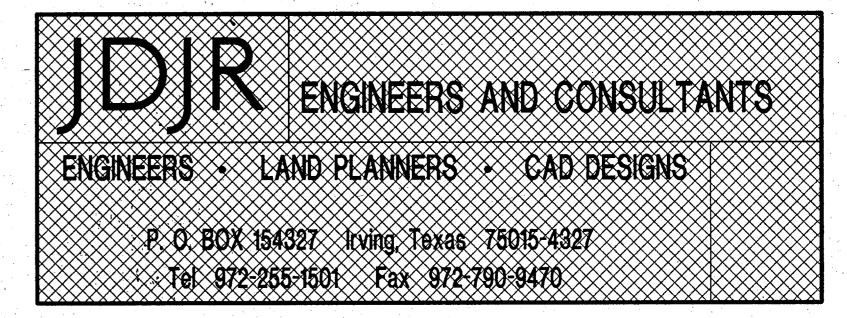


FINAL PLAT

MAINSTAY SUITES OF ADDISON ADDITION

AN ADDITION TO THE TOWN OF ADDISON, DALLAS COUNTY, TEXAS AND BEING A REPLAT OF A PORTION OF QUORUM CENTRE ADDITION

OWNER: RAIL HOTELS CORPORATION 1839 FORT WORTH AVENUE DALLAS, TEXAS 75208 TELEPHONE: (214) 742-3037 FAX: (214) 742-3037 CONTACT: ISHWARBHAI A. DESAI

SEPTEMBER 1998 SCALE: 1"=30'

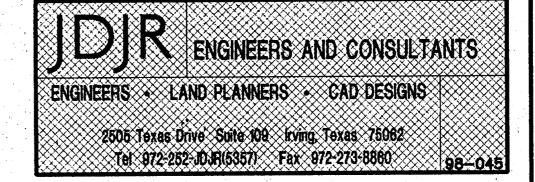

OWNER'S CERTIFICATE

COUNTY OF DALLAS)(CITY OF ADDISON)(

> WHEREAS WE, RAIL HOTELS CORPORATION, are the Owners of a 1.5812 acre tract of land situated in the G. W. Fisher Survey, Abstract No. 482, said tract also being a part of QUORUM CENTRE ADDITION, an addition to the Town of Addison according to the plat recorded in Volume 86067, Page 5718 of the Deed Records of Dallas County, Texas, and being more particularly described by metes and bounds as follows;

> COMMENCING at a point for corner at the most southerly corner of a corner clip at the intersection of the south right-of-way line of Arapaho Road (having a 60 foot wide right-of-way) with the east right-of-way line of Addison Road

THENCE South 00 degrees 17 minutes 00 seconds West along the said east right-of-way line of Addison Road for a distance of 301.50 feet to a chiseled 'X' in concrete found for corner, same point being the POINT OF BEGINNING;

THENCE South 89 degrees 43 minutes 00 seconds East departing the said east right-of-way line of Addison Road for a distance of 249.00 feet to a PK nail set for corner;

THENCE North 00 degrees 17 minutes 00 seconds East for a distance of 120.00 feet to a iron rod found for corner;

THENCE North 44 degrees 43 minutes 00 seconds West for a distance of 25.44 feet to a chiseled 'X' in concrete found

THENCE North 00 degrees 17 minutes 00 seconds East for a distance of 177.97 feet to a chiseled 'X' in concrète found for corner in the south right-of-way line of Arapaho Road;

THENCE South 89 degrees 35 minutes 00 seconds East along the said south right-of-way line of Arapaho Road for a distance of 52.49 feet to a 1/2" iron rod set for corner, the same point being the northwest corner of Lot 1, Block A of SUMMERFIELD/ARAPAHO/ADDISON ADDITION, an addition to the Town of Addison according to the plat recorded in Volume

95119 at Page 4232 of the Deed Records of Dallas County, Texas; THENCE South 00 degrees 17 minutes 00 seconds West along the west line of said Lot 1 for a distance of 490.98 feet to the southwest corner of said Lot 1 and continuing along the same line for a total distance of 508.49 feet to a 1/2" iron rod set for corner, the same point being the northeast corner of ADDISON ROAD QUORUM ADDITION, an addition to the Town of Addison according to the plat recorded in Volume 93041 at Page 2824 of the Deed Records of Dallas County,

THENCE North 89 degrees 43 minutes 00 seconds West along the north line of said ADDISON ROAD QUORUM ADDITION for a distance of 283,50 feet to a chiseled 'X' in concrete found for corner in the east right-of-way line of Addison Road;

THENCE North 00 degrees 17 minutes 00 seconds East along the said east right—of—way line of Addison Road for a distance of 192.65 feet to the POINT OF BEGINNING;

CONTAINING 1.5812 acres of land, more or less.

That RAIL HOTELS Corporation ("Owner") does hereby adopt this plat designating the hereinabove property as MAINSTAY SUITES OF ADDISON ADDITION, Texas, and, subject to the conditions, restrictions and reservations stated hereinafter, owner dedicates to the public use forever the streets and alleys shown thereon.

The easements shown on this plat are hereby reserved for the purposes as indicated, including, but not limited to, the installation of water, sanitary sewer, storm sewer, drainage, electric, telephone, gas and cable television. Owner shall have the right to use these easements, provided however, that it does not unreasonably interfere or impede with the provision of the services to others. Said utility easements are hereby being reserved by mutual use and accommodation of all public utilities using or desiring to use the same. An express easement of ingress and egress is hereby expressly granted on, over and across all such easements for the benefit of the provider of services for which easements are

Any drainage and floodway easement shown hereon is hereby dedicated to the public's use forever, but including the following covenants with regards to maintenance responsibilities. The existing channels or creeks traversing the drainage and floodway easement will remain as an open channel, unless required to be enclosed by ordinance, at all times and shall be maintained by the individual owners of the lot or lots that are traversed by or adjacent to the drainage and floodway easement. The City will not be responsible for the maintenance and operation of said creeks or creeks or for any damage or injury of private property or person that results from the flow of water along said creek, or for the control of erosion. No obstruction to the natural flow or the water run—off shall be permitted by construction of any type building, fence or any other structure within the drainage and floodway easement. Provided, however, it is understood that in the event it becomes necessary for the City to Channelize or consider erecting any type of drainage structure in order to improve the storm drainage, then in such event, the City shall have the right, but not the obligation, to enter upon the drainage and floodway easement at any point, or points, with all rights of ingress and egress to investigate, survey, erect, construct or maintain any drainage facility deemed necessary by the City for drainage purposes. Each property owner shall keep the natural drainage channels and creeks traversing the drainage and floodway easement adjacent to his property clean and free of debris, slit, growth, vegetation, weeds, rubbish, refuse, matter and any substances which would result in unsanitary conditions or obstruct the flow of water, and the City shall have the right of ingress and egress for the purpose of inspection and supervision and maintenance work by the property owner to alleviate any undesirable conditions which may occur. The natural drainage channels and creeks through the drainage and floodway easement, as in the case of all natural channels, are subject to storm water overflow and natural bank erosion to an extent that cannot be definitely defined. The City shall not be held liable for any damages or injuries of any nature resulting from the occurrence of these natural phenomena, nor resulting from the failure of any structure or structures, within the natural drainage channels and the owners hereby agree to indemnify and hold harmless the City from any such damages and injuries. Building areas outside the drainage and floodway easement line shall be filled to a minimum elevation as shown on the plat. The minimum floor of elevation of each lot shall be

The maintenance or paving of the utility and fire lane easements is the responsibility of the property owner. All public utilities shall at all times have the full right of ingress and egress to and from and upon the said utility easements for the purpose of constructing, reconstructing, inspecting, patrolling, maintaining, and adding to or removing all or parts o its respective system without the necessity at any time of procuring the permission of anyone. Any public utility shall have the right of ingress and egress to private property for the purpose of reading meters and maintenance and service required or ordinarily performed by that utility. Buildings, fences, trees, shrubs or other improvements or growth may be constructed, reconstructed, or placed upon, over of across the utility easements as shown; provided, however, that owner shall at its sole cost and expense be responsible, under any and all circumstances for the maintenance and repair of such improvements or growth, and any public utility shall have the right to remove and keep removed all or parts of any buildings, fences, trees, shrubs or other improvements or growth which in any way endanger or interfere with the construction, maintenance or efficiency of its respective system or service.

Water main and sanitary sewer easements shall also include additional area of working space for construction and maintenance of the systems. Additional easement area is also conveyed for installation and maintenance of manholes, člean outs, fire hydrants, water services and sewer services from the main curb or pavement line, and the descriptions of such additional easements herein granted shall be determined by their locations as installed.

This plat is approved subject to all platting ordinances, rules, regulations, and resolutions of the Town of Addison, Texas.

Rail Hotels Corporation

ISHWARBHAI A. DESAI, VICE-PRESIDENT

GIVEN UNDER MY HAND AND SEAL OF OFFICE

State of Texas)(BEFORE ME, the undersigned authority, a Notary Public in and for said State, on this date personally appeared ISHWARBHAI A. DESAI, VICE-PRESIDENT of RAIL HOTELS CORPORATION, known to me to be the person and officer whose name is subscribed to the foregoing instrument and acknowledged to that the same was the act of the said corporation, that he was duly authorized to perform the same by appropriate resolution of the Board of Directors of such Corporation and that he executed the same as the act of such Corporation for the purposes and consideration therein expressed, and

Notary Public in and for the State


THAT I, JAMES DEWEY, do hereby certify that I prepared this plat from an actual and accurate survey on the ground of property and that all block monuments and corners were placed under

REGISTERED PROFESSIONAL

BEFORE ME, the undersigned, a Notary Public in and for said State on this date personally appeared JAMES DEWEY, known to me personally to be the person whose name is for the foregoing instrument and acknowledged to me that he executed the same GIVEN UNDER MY HAND AND SEAL OF OFFICE this _____ day of _____ 1998.

JDJR FILE NO. 98045

Notary PUBLIC IN AND FOR THE STATE OF TEXAS My commission Expires: 12-06-98

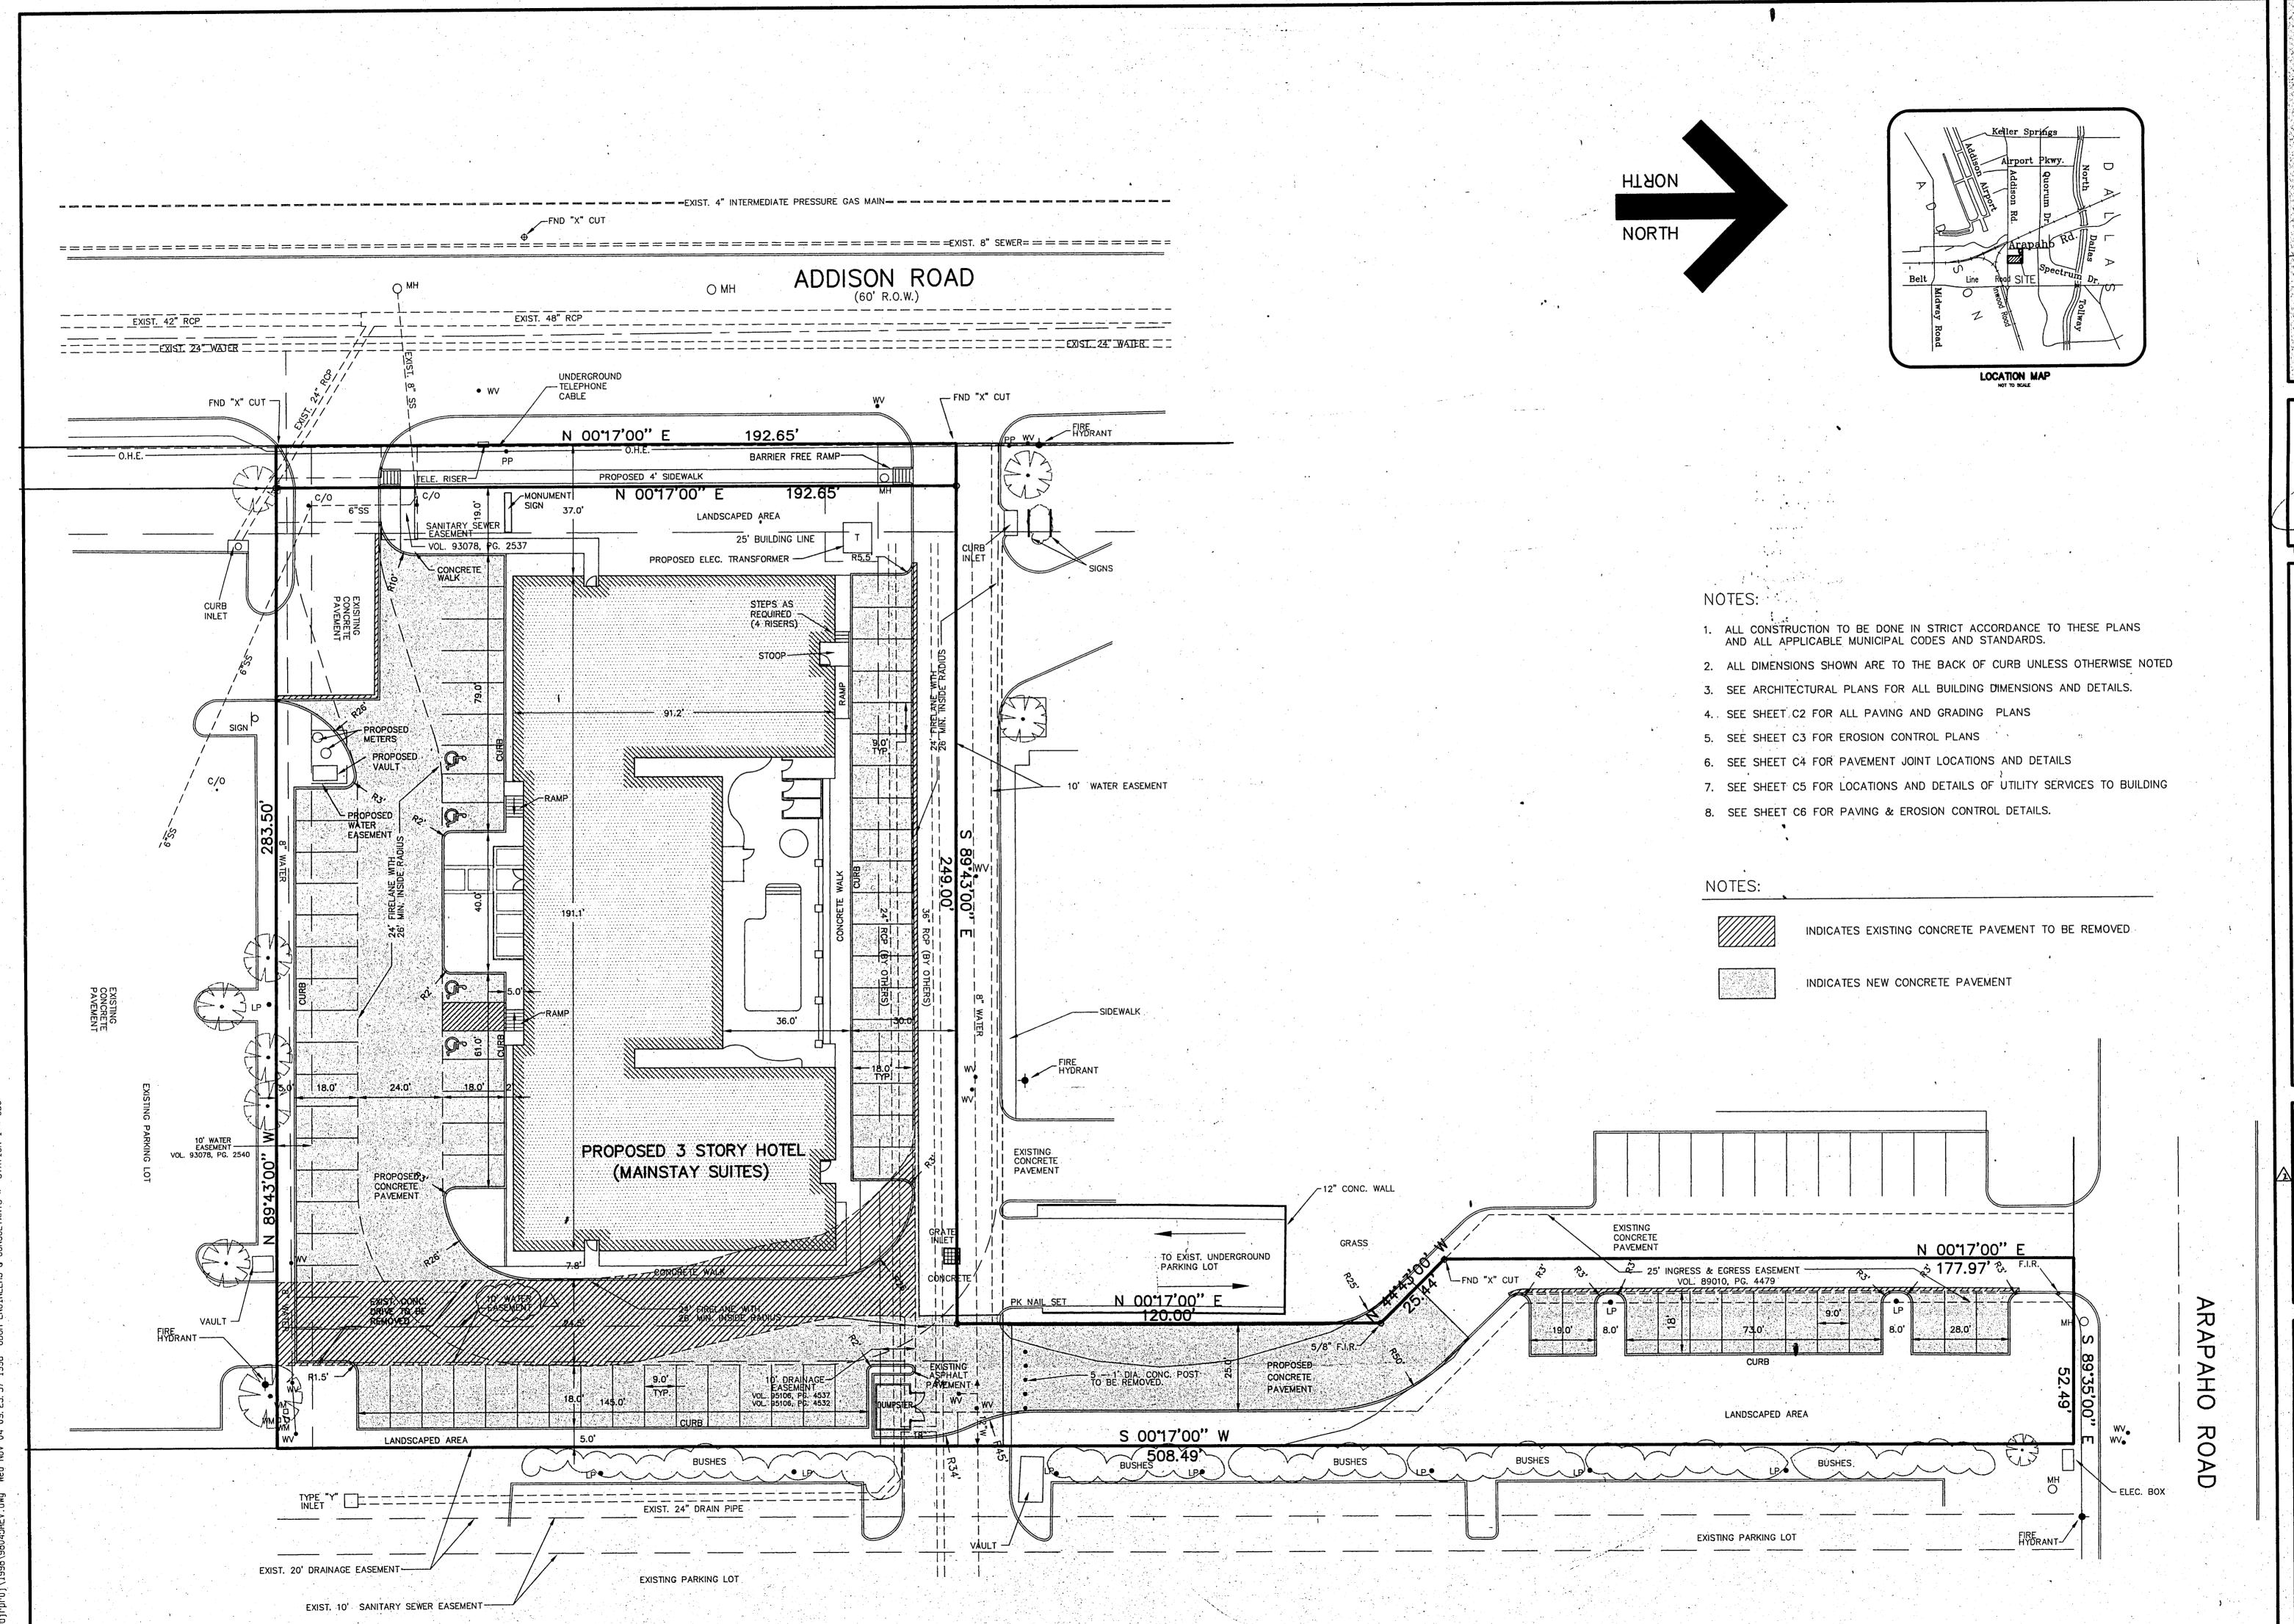

PROJECT:
MAINSTAN
BELTLINE
ADDISON, **REVISIONS:** 11/02/98 PUBLIC WORKS COMMENTS


ON

SUITE: ROAD TEXAS

SHEET TITLE SITE DIMENSIONAL CONTROL PLAN

DATE: 09/11/98 **SCALE:** 1" = 20'

DRAWN BY: J.N.M. CHECKED BY: JDJR SHEET NO.

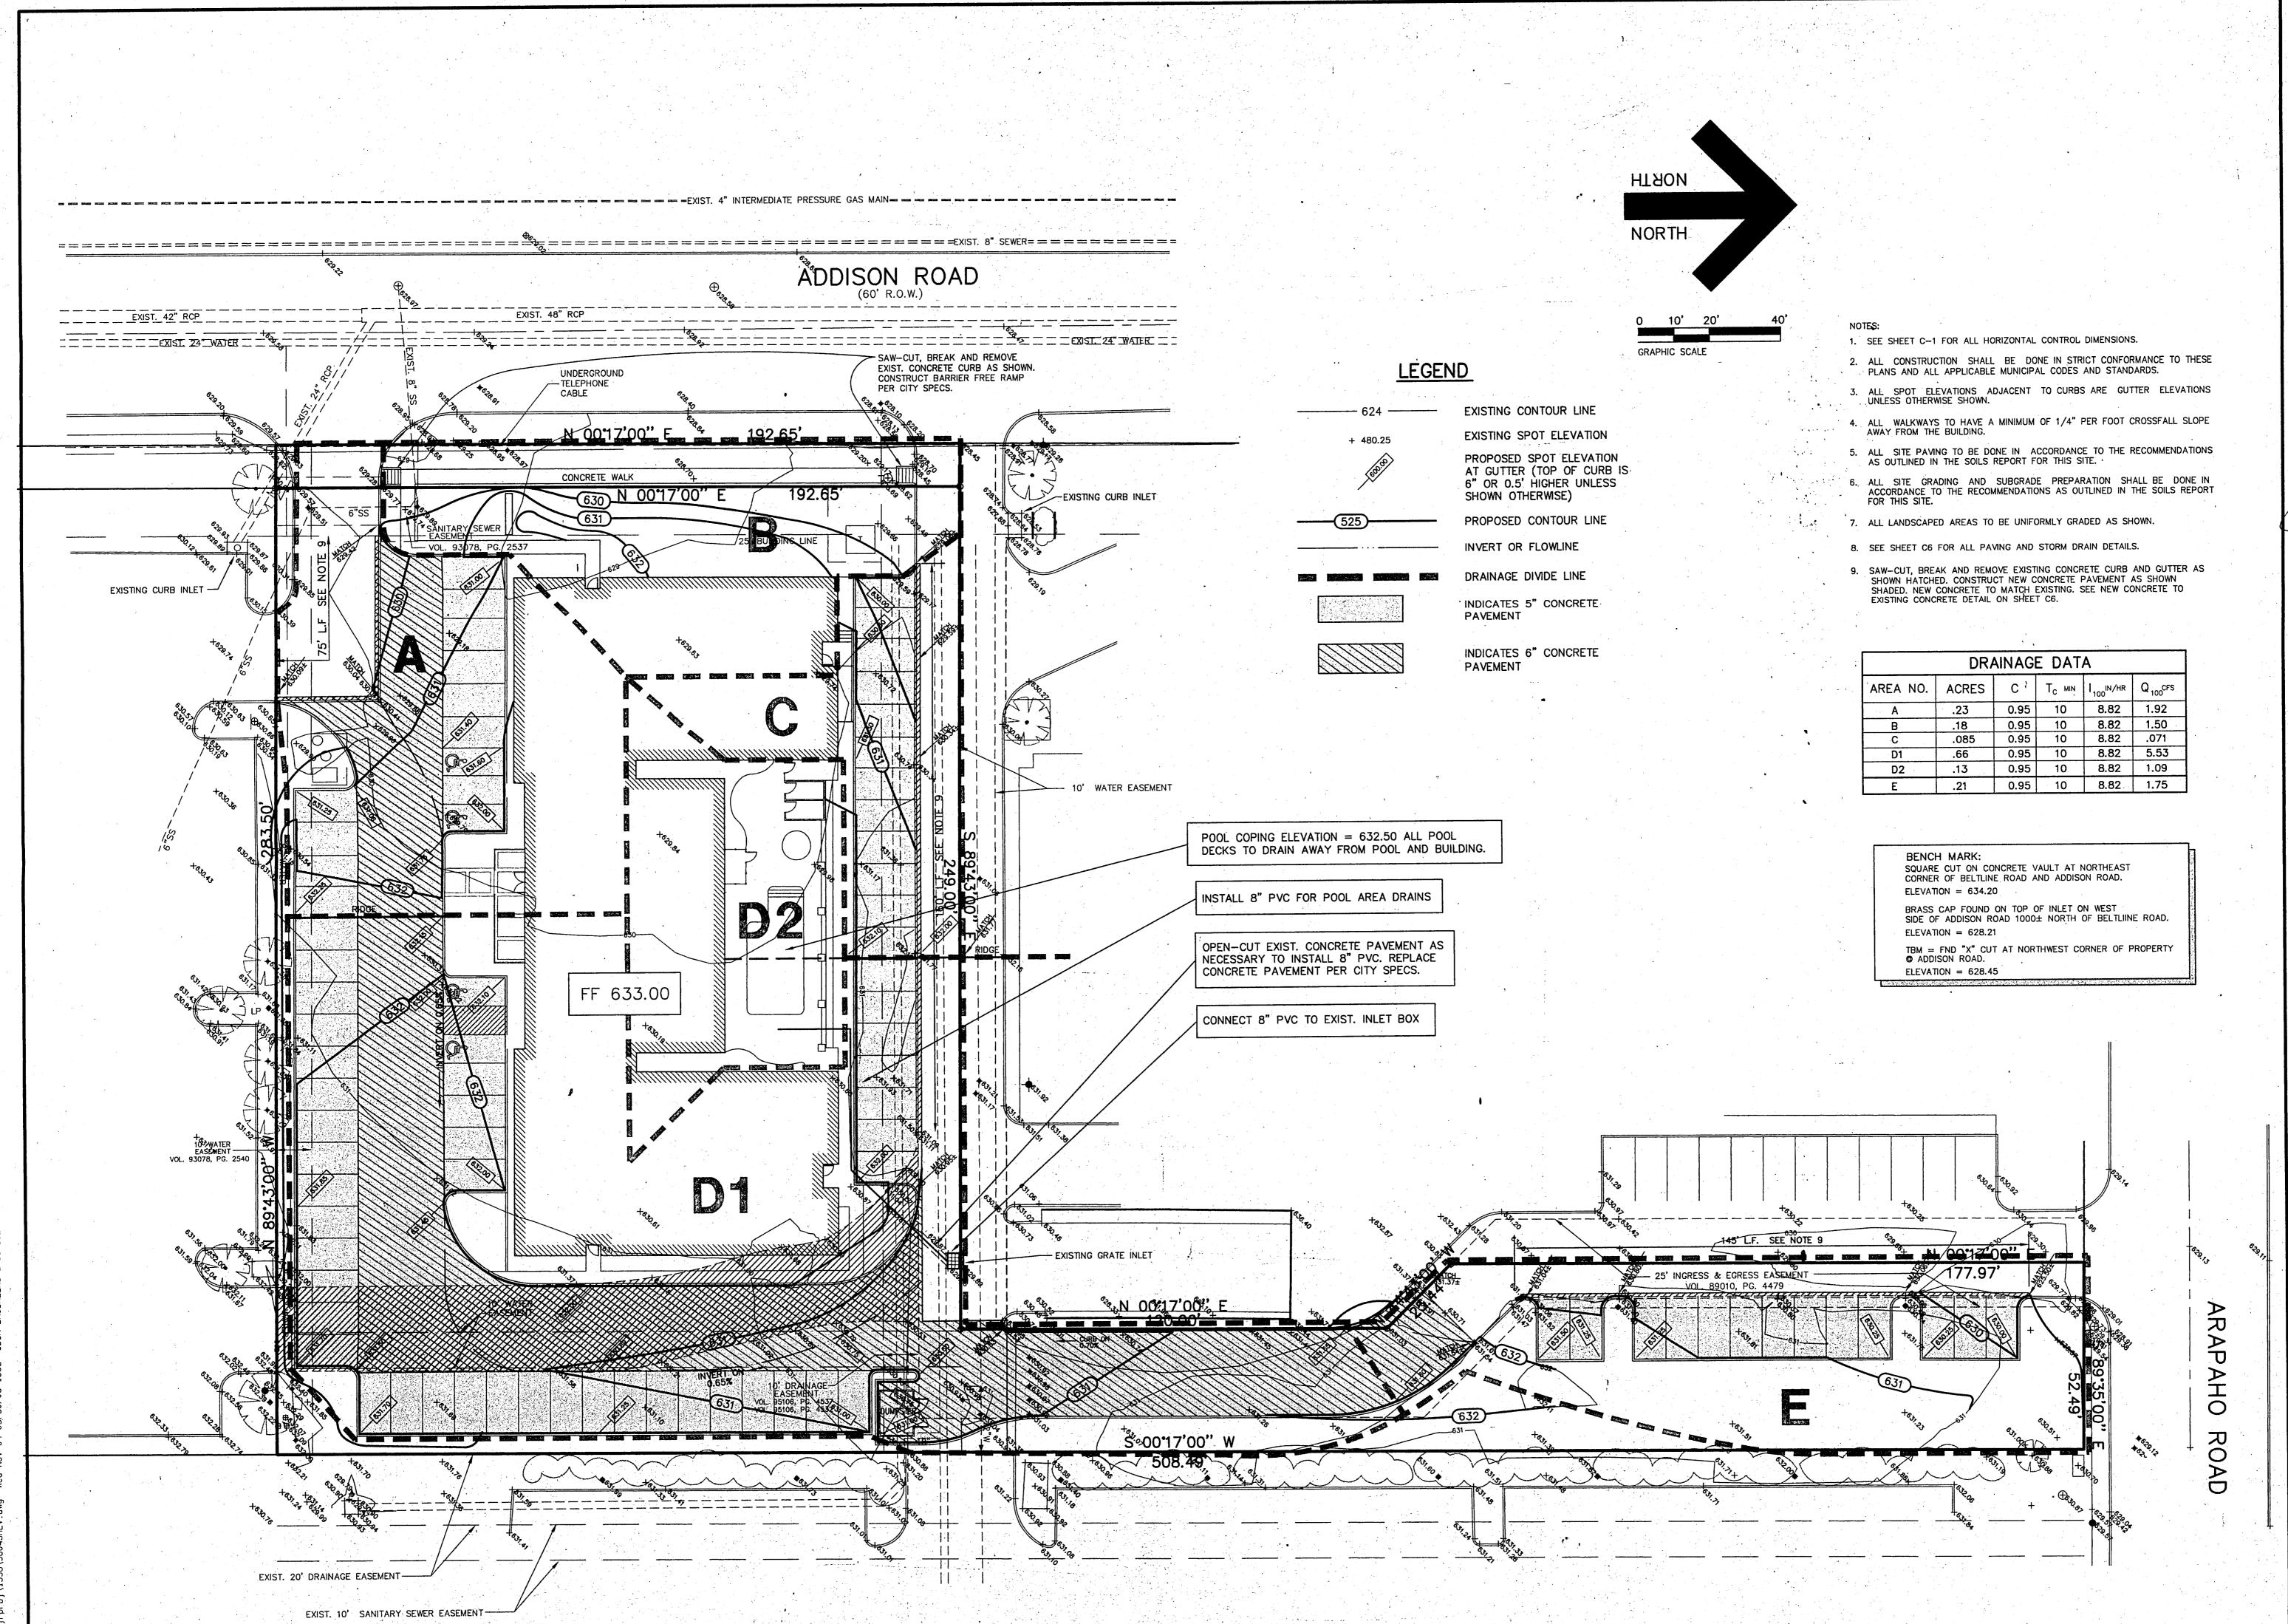

BELTLINE ADDISON,

R H

JAMES DEWEY, JR.

SHEET TITLE
GRADING
AND
PAVING
PLAN


DATE: 09/11/98

SCALE: 1" = 20'

DRAWN BY: J.N.M.
CHECKED BY: JDJR

SHEET NO.

C2 of 6

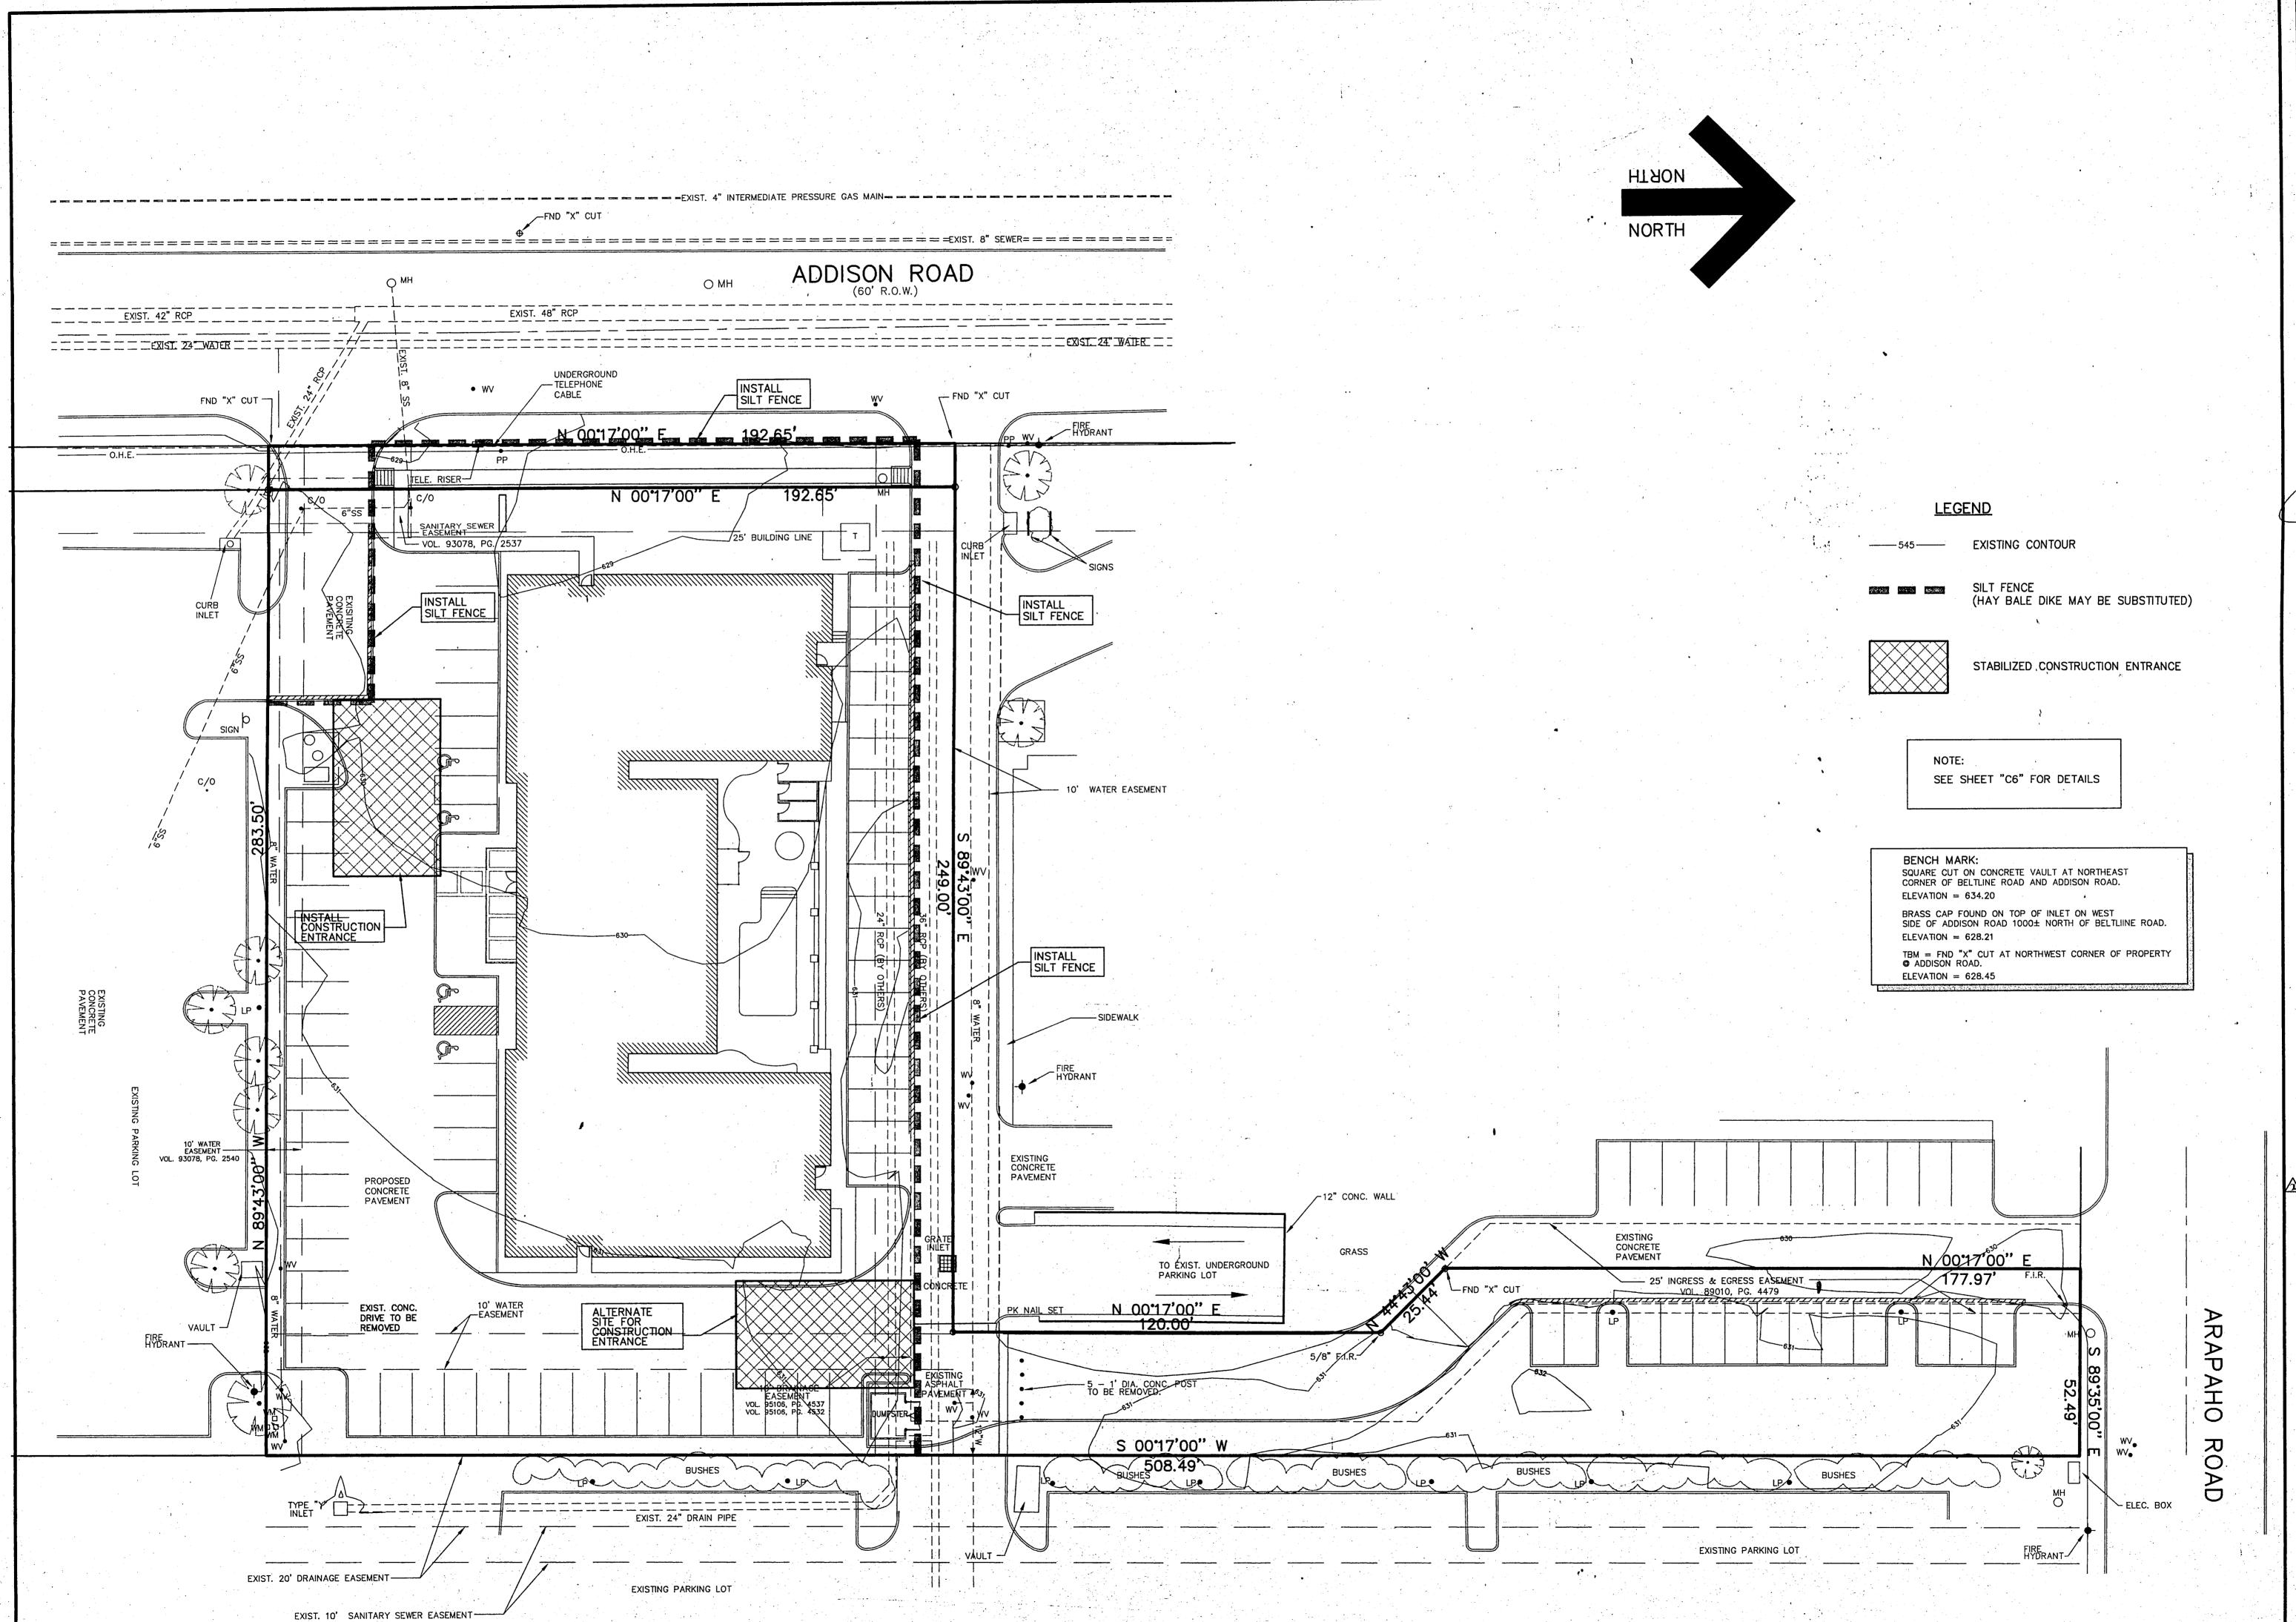

ENGINEERS & CONSULTANTS, IS . LAND PLANNERS . CAD DESIGNS

MAINSTAY SUITES OF ADDISON ADDI BELTLINE ROAD ADDISON, TEXAS

REVISIONS:

DATE REVISION

11/02/98 PUBLIC WORKS
COMMENTS

SHEET TITLE
EROSION
CONTROL
PLAN

DATE: 09/11/98


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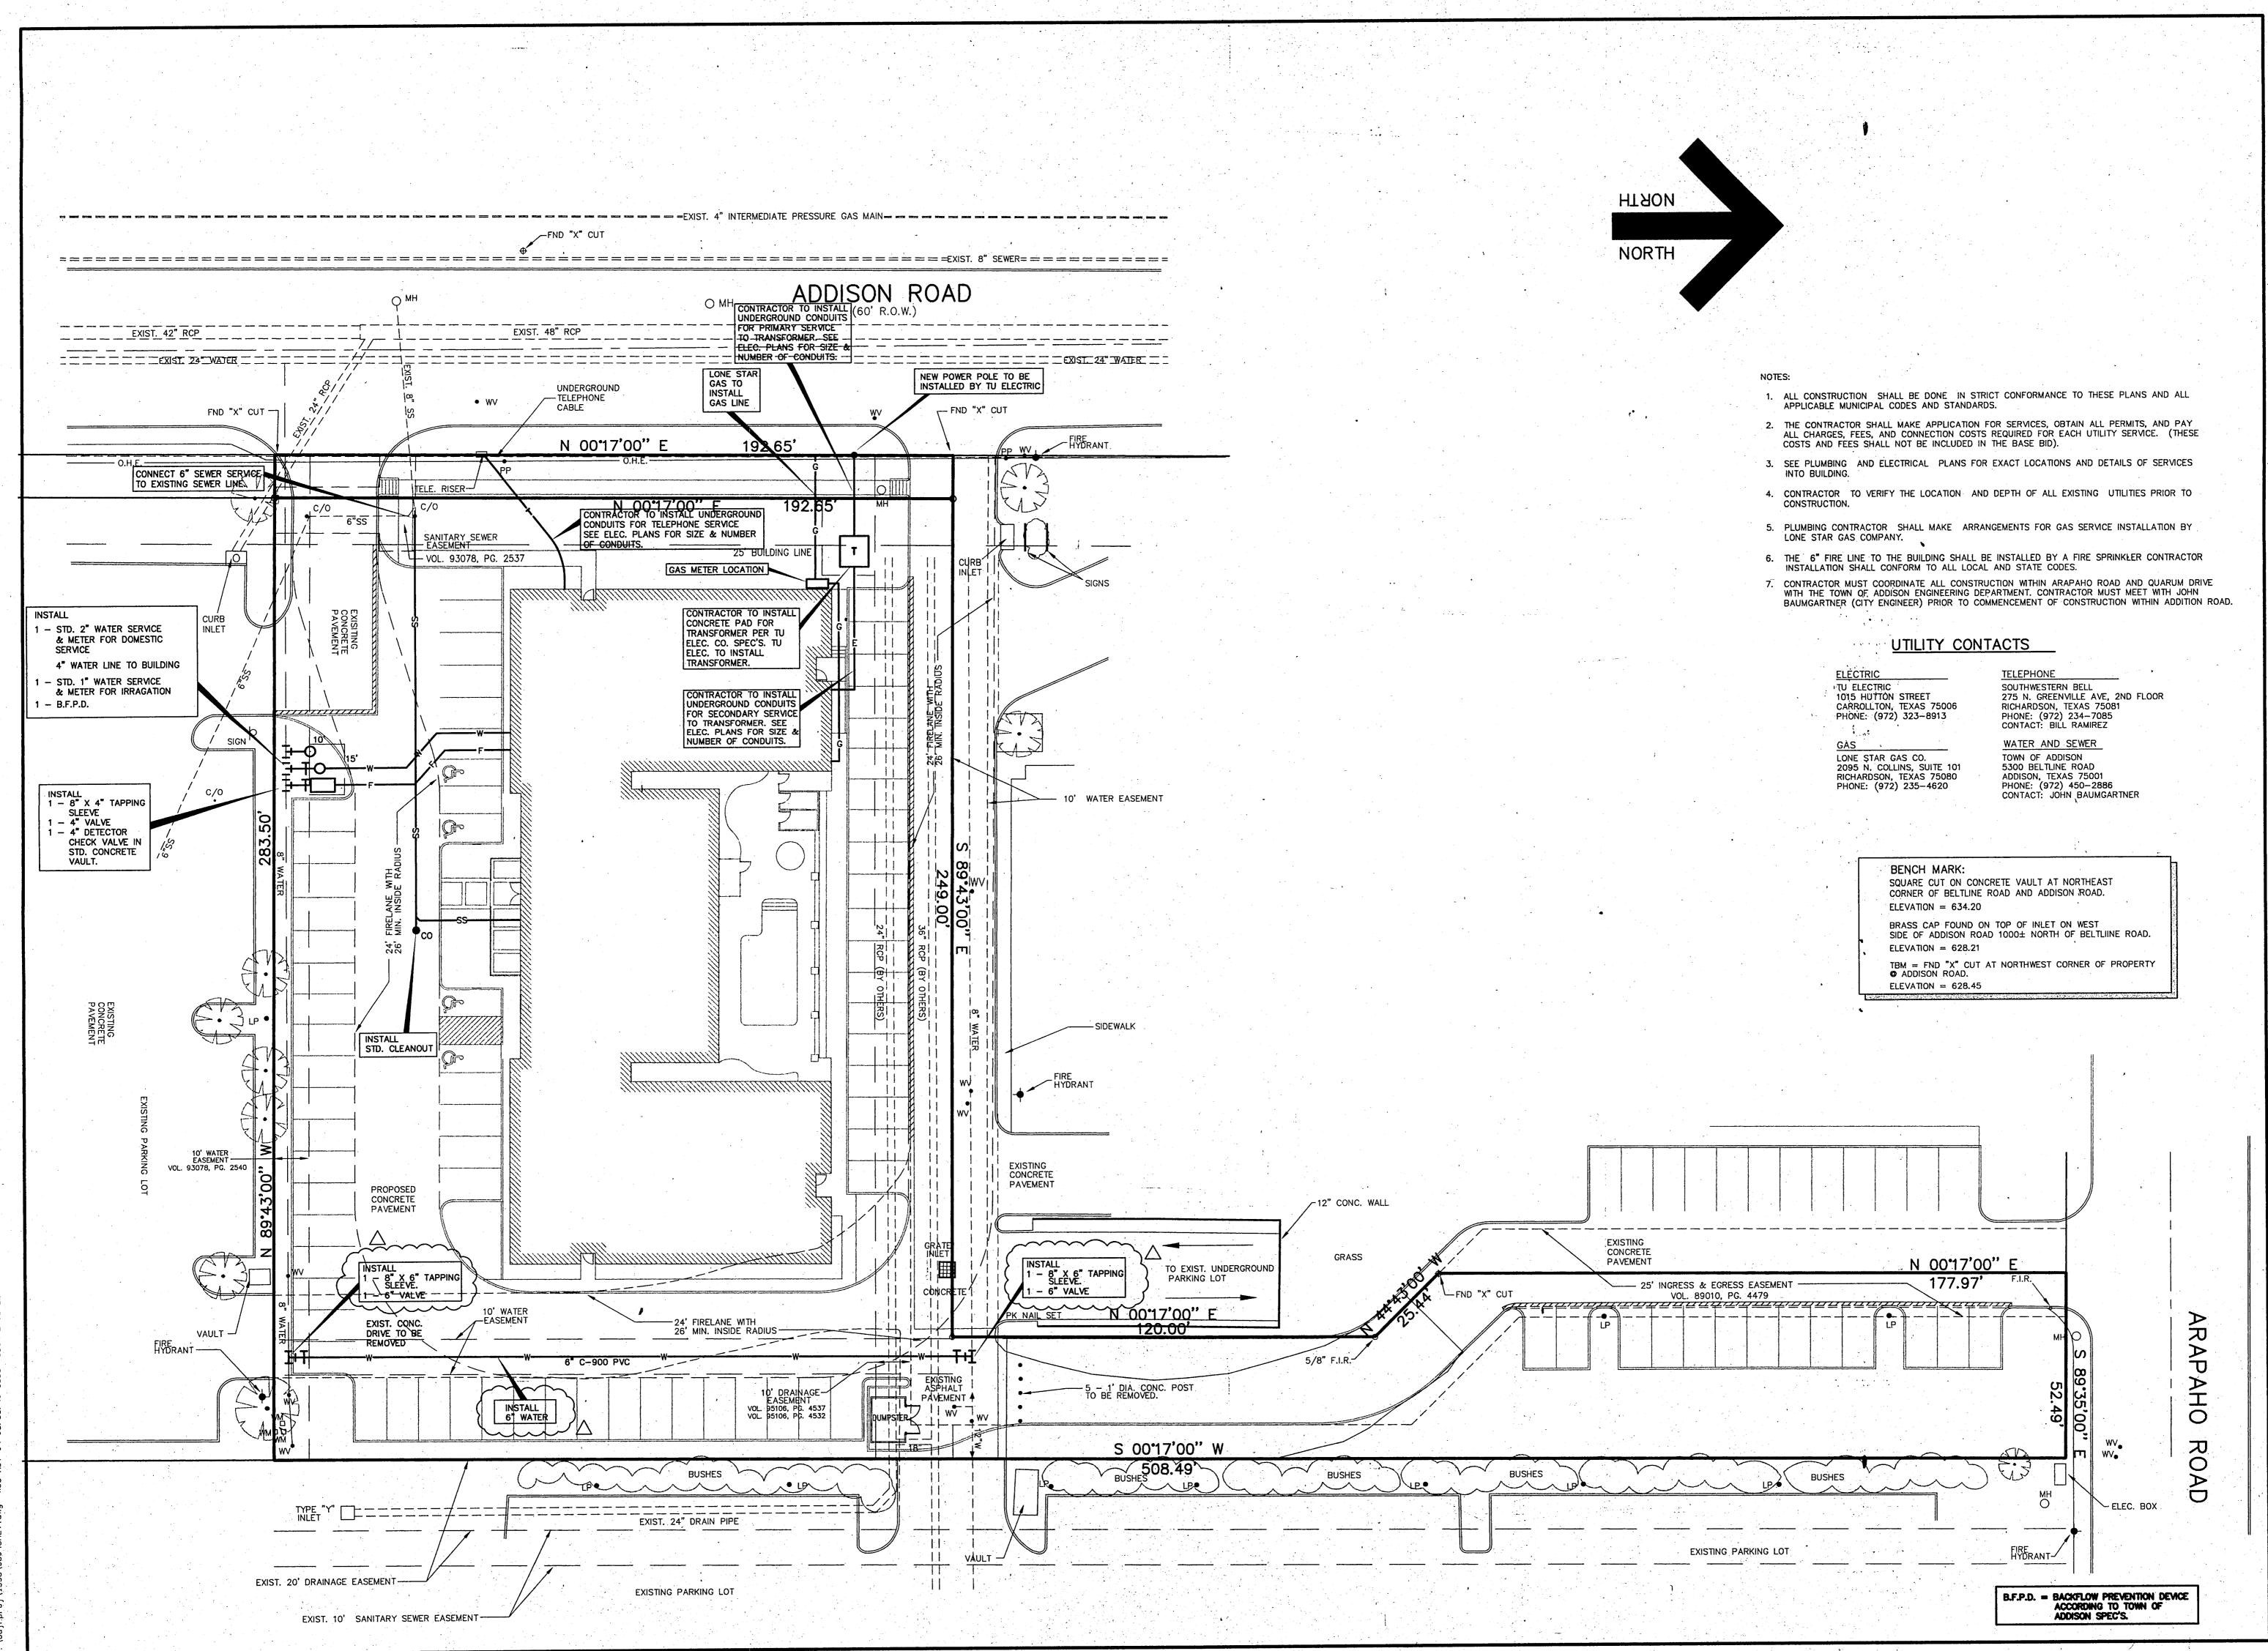
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CHECKED BY: JDJR

SHEET NO.





会 JAMES DEWEY, JR. 61480 S
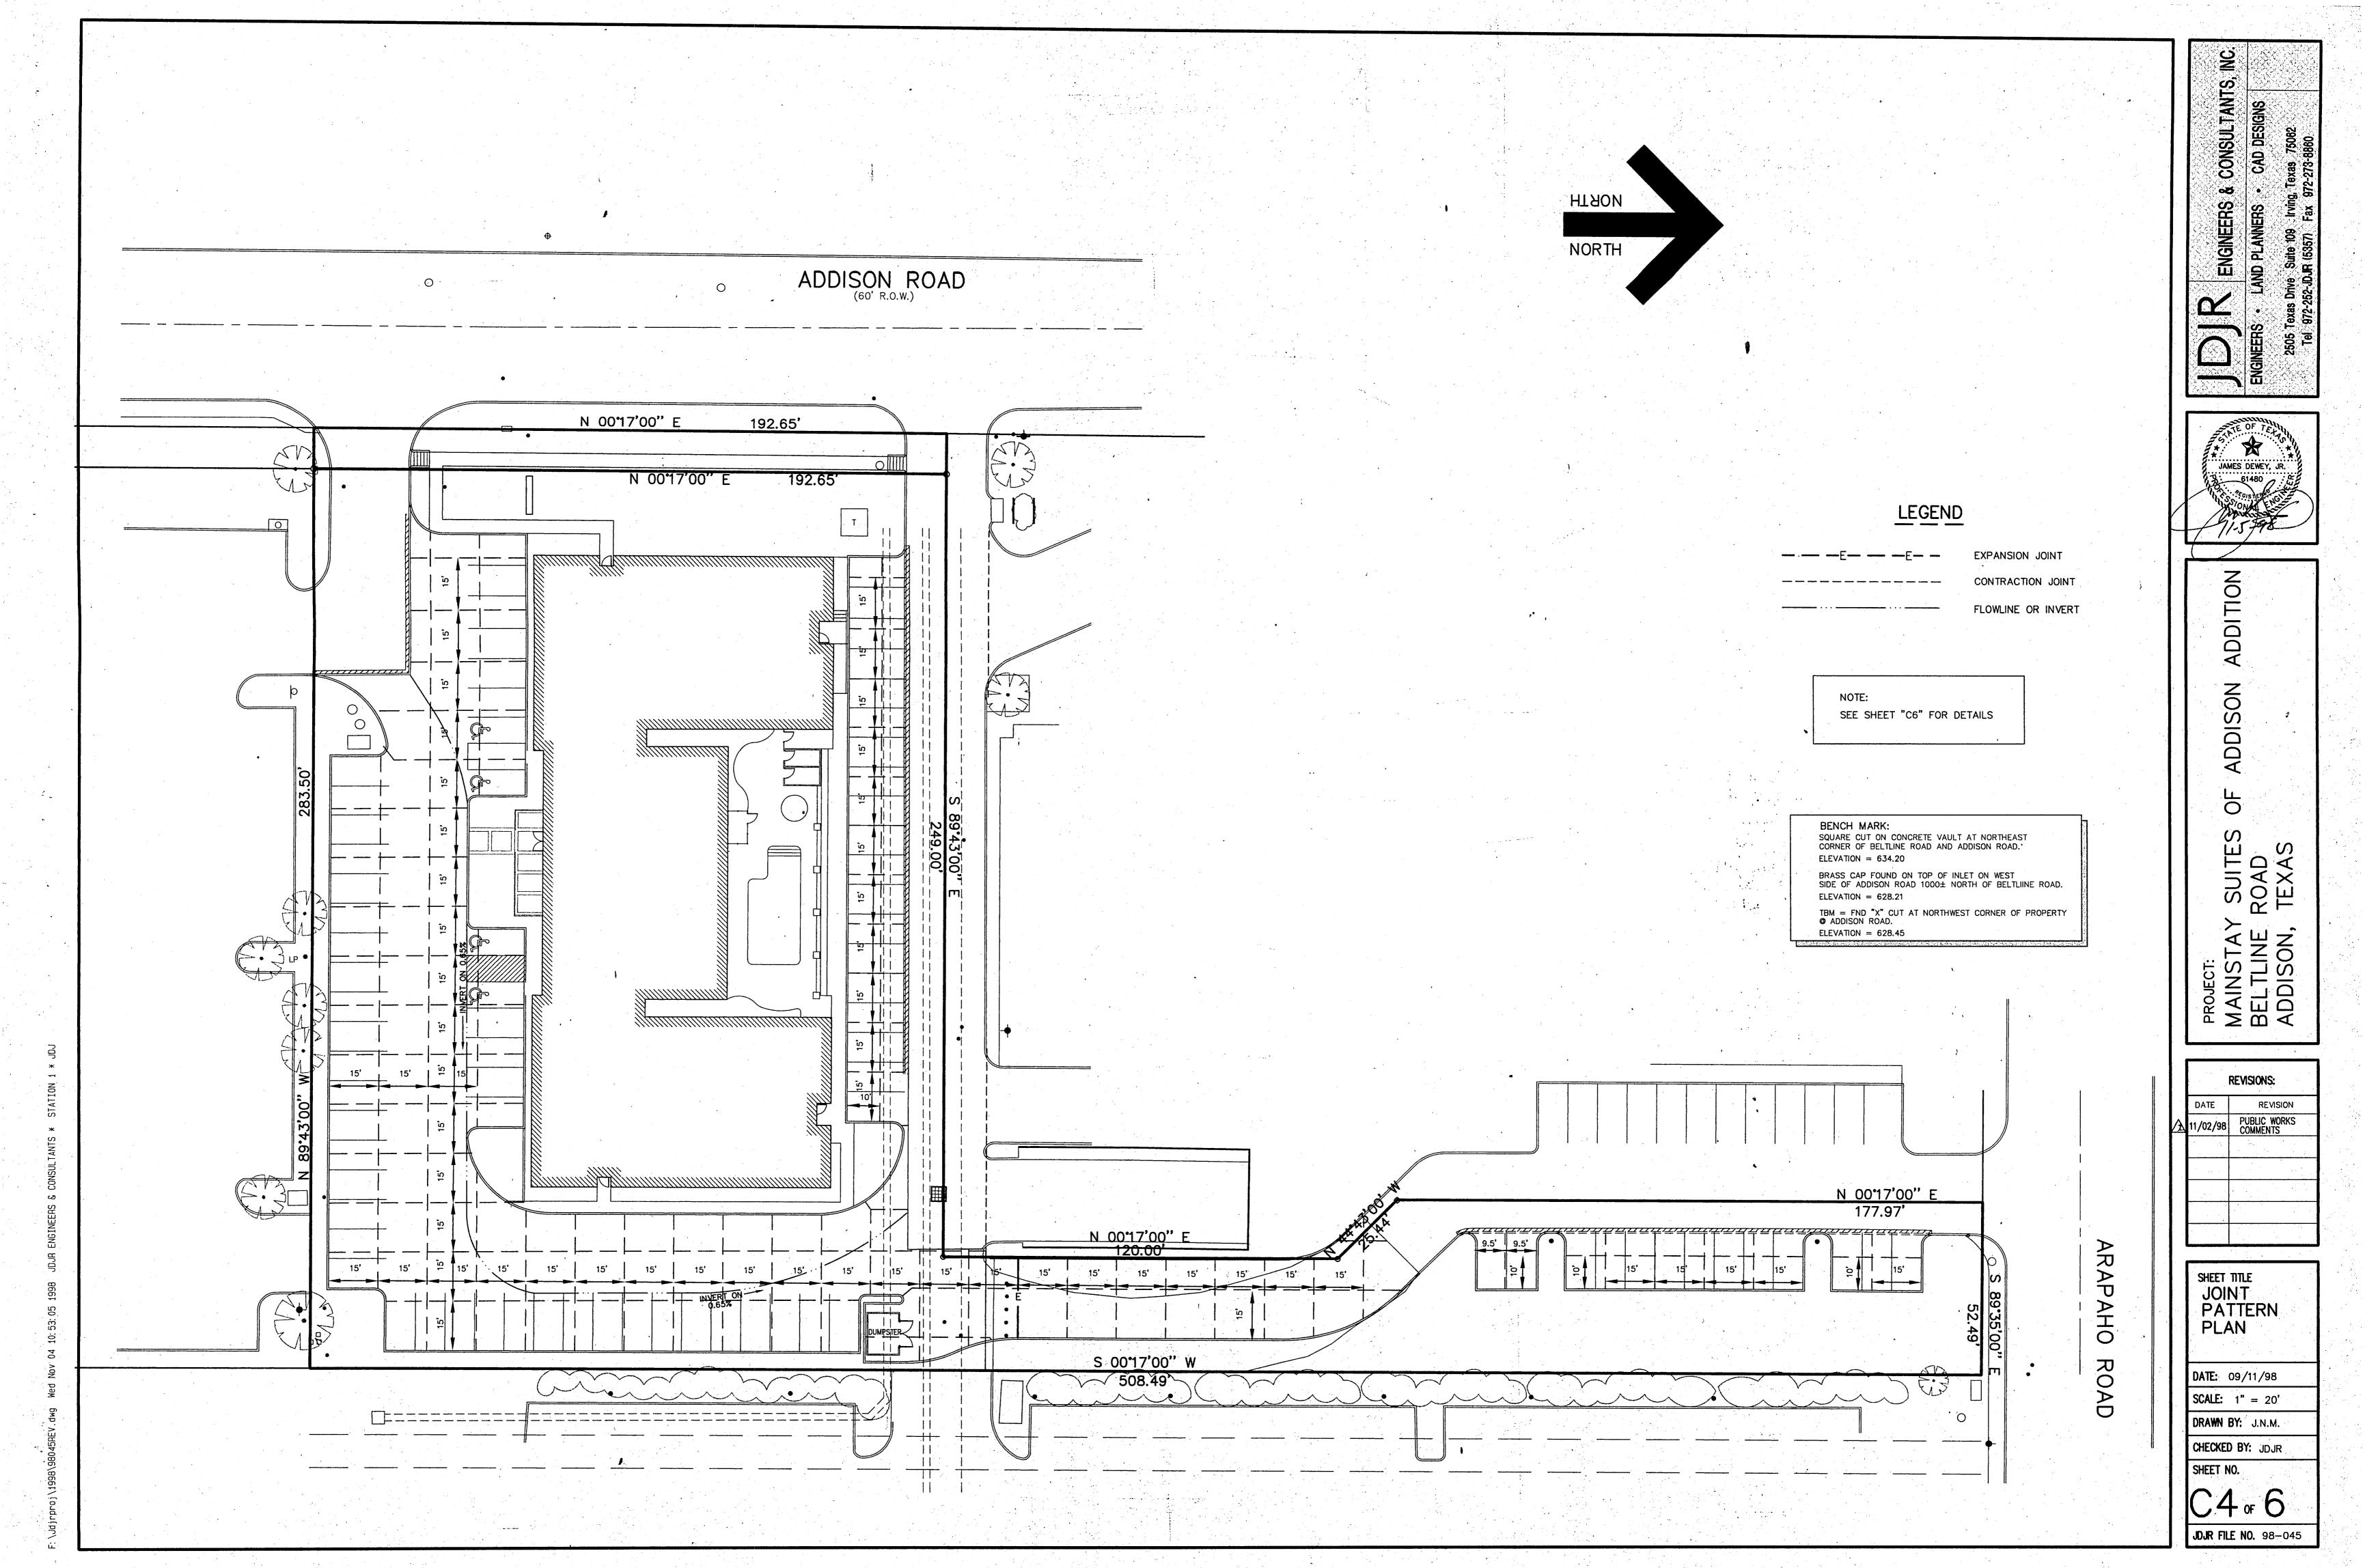
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MAINS
BELTLII
ADDISC

REVISIONS: REVISION DATE 11/02/98 PUBLIC WORKS COMMENTS

> SHEET TITLE UTILITY SERVICES PLAN **DATE:** 09/11/98


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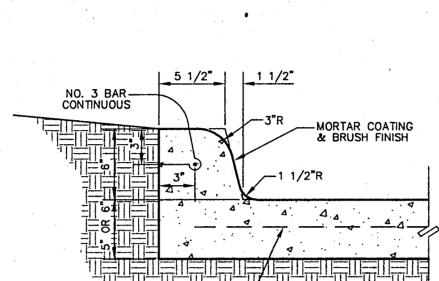
CHECKED BY: JDJR SHEET NO.

NOTE: CONSTRUCT CONSTRUCTION JOINT WHENEVER THE PLACEMENT OF CONCRETE IS SUSPENDED FOR MORE THAN 30 MINUTES.


CONSTRUCTION JOINT DETAIL




CONTRACTION JOINT DETAIL

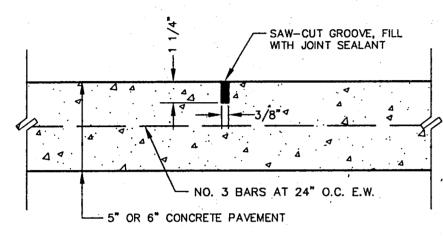


CURB VARIES - SEE PLAN VIEW

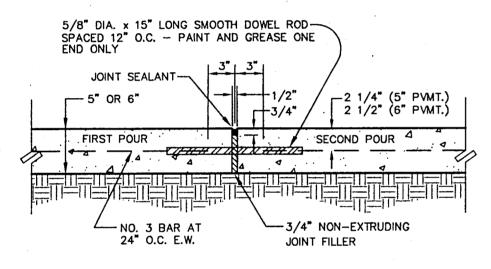


EXPANSION JOINT DETAIL

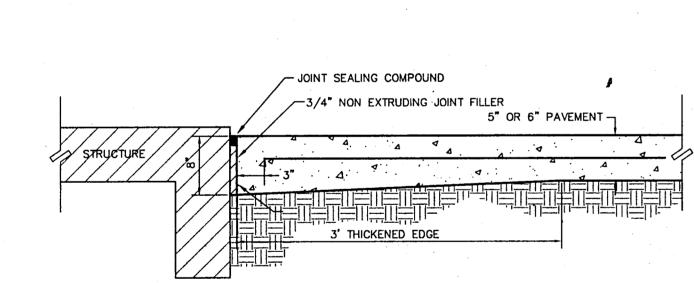


EXPANSION JOINT AT STRUCTURE DETAIL

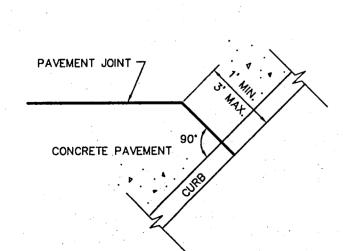


DETAIL OF PAVEMENT JOINT AT CURB NOT TO SCALE

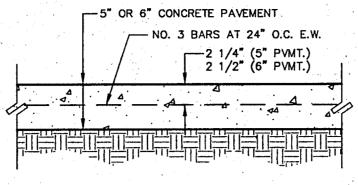

CONCRETE PAVEMENT SECTION DETAIL NOT TO SCALE

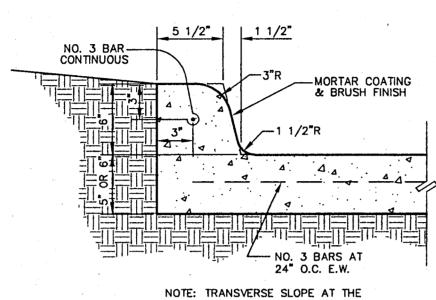


NTEGRAL CURB DETAIL

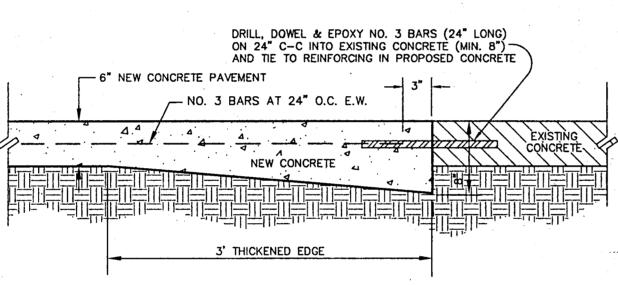


NEW CONCRETE TO EXISTING CONCRETE DETAIL

NOT TO SCALE

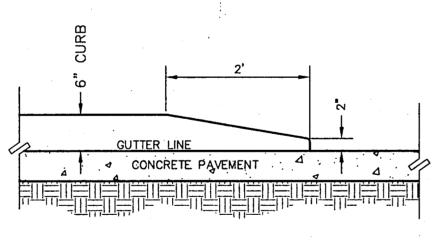

CURB TERMINAL DETAIL

NOT TO SCALE

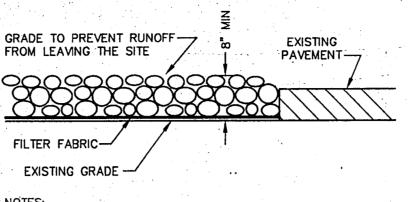

1. STONE SIZE - 3 TO 5 INCHES CRUSHED ROCK.


2. LENGTH — AS EFFECTIVE, BUT NOT LESS THAN 50', UNLESS DEPTH OF LOT IS LESS THA 150' FROM THE EDGE OF PAVEMENT WHERE LENGTH MUST ONLY BE 30'.

5. WASHING - WHEN NECESSARY, WHEELS SHALL BE CLEANED TO REMOVE SEDIMENT PRIOR TO ENTRANCE ONTO PUBLIC ROADWAY. WHEN WASHING IS REQUIRED, IT SHALL BE DONE ON AN AREA STABILIZED WITH CRUSHED STONE WHICH DRAINS INTO AN APPROVED TRAP OR SEDIMENT BASIN. ALL SEDIMENT SHALL BE PREVENTED FROM ENTERING ANY STORM DRAIN, DITCH OR WATERCOURSE USING APPROVED METHODS.

6. MAINTENANCE — THE ENTRANCE SHALL BE MAINTAINED IN CONDISTION WHICH WILL PREVENT TRACKING OR FLOWING OF SEDIMENT ONTO PUBLIC ROADWAYS. THIS MAY REQUIRE PERIODIC TOP DRESSING WITH ADDITIONAL STONE AS CONDITIONS DEMAND, AND REPAIR AND/OR CLEANOUT OF ANY MEASURES USED TO TRAP SEDIMENT. ALL SEDIMENT SPILLED, DROPPED, WASHED OR TRACKED ONTO PUBLIC ROADWAY, MUST BE REMOVED IMMEDIATELY.

7. DRAINAGE -- ENTRANCE MUST BE PROPERLY GRADED OR INCORPORATE A DRAINAGE SWALE TO PREVENT RUNOFF FROM LEAVING THE CONSTRUCTION SITE.

STABILIZED CONSTRUCTION ENTRANCE NOT TO SCALE

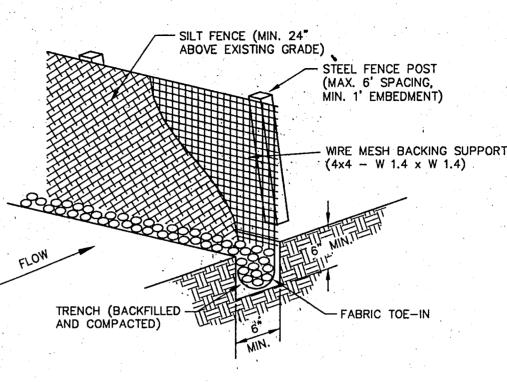


SILT FENCE DETAIL

SILT FENCE NOTES: 1. STEEL POSTS WHICH SUPPORT THE SILT FENCE SHALL BE INSTALLED ON A SLIGHT ANGLE TOWARD THE ANTICIPATED RUNOFF SOURCE. POST MUST BE EMBEDDED A MINIMUM OF ONE FOOT. 2. THE TOE OF THE SILT FENCE SHALL BE TRENCHED IN WITH A SPADE OR MECHANICAL TRENCHER, SO THAT THE DOWNSLOPE FACE OF THE TRENCH IS FLAT AND PERPENDICULAR TO THE LINE OF FLOW. WHERE FENCE CANNOT BE TRENCHED IN (e.g. PAVEMENT), WEIGHT FABRIC FLAP WITH WASHED GRAVEL ON UPHILL SIDE TO PREVENT FLOW UNDER FENCE. 3. THE TRENCH MUST BE A MIN. OF 6" DEEP AND 6" WIDE TO ALLOW FOR THE SILT FENCE FABRIC TO BE LAID IN THE GROUND AND BACKFILLED WITH COMPACTED 4. SILT FENCE SHOULD BE SECURELY FASTENED TO EACH STEEL SUPPORT POST OR WOVEN WIRE, WHICH IS IN TURN ATTACHED TO THE STEEL FENCE POST. THERE SHALL BE A 6" OVERLAP, SECURELY FASTENED WHERE ENDS OF FABRIC MEET. 5. INSPECTION SHALL BE MADE WEEKLY OR AFTER EACH RAINFALL, REPAIR OR REPLACEMENT SHALL BE MADE PROMPTLY AS NEEDED.

6. SILT FENCE SHALL BE REMOVED WHEN THE SITE IS COMPLETELY STABILIZED SO AS NOT TO BLOCK OR EMPEDE STORM FLOW OR DRAINAGE. 7. ACCUMULATED SILT SHALL BE REMOVED WHEN IT REACHES A DEPTH OF 6°. THE SILT SHALL BE DISPOSED OF IN AN APPROVED SITE AND IN SUCH A MANNER AS TO NOT CONTRIBUTE TO ADDITIONAL SILTATION.


ENGINEERS

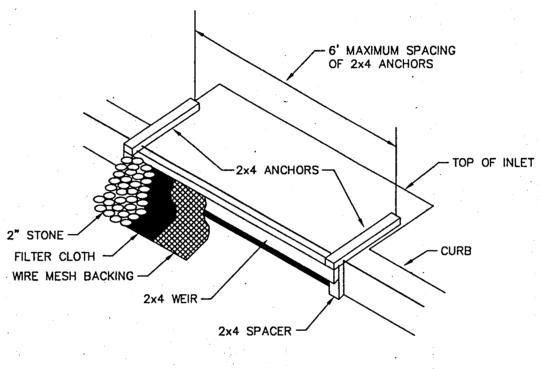

WIRE MESH BACKING MUST BE OF SUFFICIENT STRENGTH TO SUPPORT FILTER FABRIC, AND STONE FOR CURB INLETS, WITH WATER FULLY IMPOUNDED AGAINST IT.

3. FILTER CLOTH MUST BE OF A TYPE APPROVED FOR THIS PURPOSE; RESISTANT TO SUNLIGHT WITH SIEVE SIZE, EOS, 40-85, TO ALLOW SUFFICIENT PASSAGE OF WATER AND REMOVAL OF SEDIMENT.


4. STONE IS TO 2" IN SIZE AND CLEAN, SINCE FINER WOULD CLOG THE CLOTH. 5. THE ASSJEMBLY SHALL BE PLACED, SO THAT THE ENDS OF THE SPACERS ARE A MINIMUM OF 1" BEYOND ENDS OF THE THROAT OPENING.

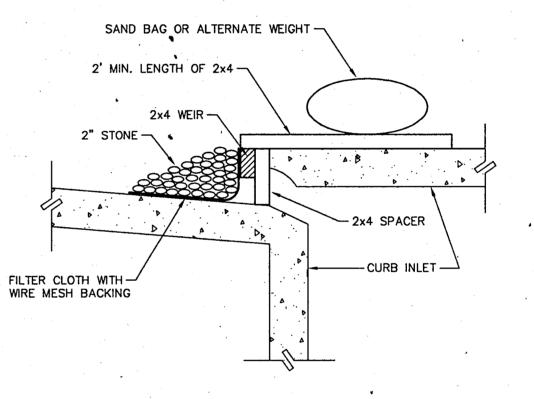

FORM THE WIRE MESH AND FILTER CLOTH TO THE CONCRETE GUTTER AND AGAINST THE FACE OF CURB ON BOTH SIDES OF THE INLET. PLACE CLEAN STONE OVER THE FILTER CLOTH IN SUCH A MANNER AS TO PREVENT WATER FROM ENTERING THE INLET UNDER OR AROUND THE CLOTH.

7. THIS TYPE OF INLET PROTECTION MUST BE INSPECTED FREQUENTLY AND THE FILTER CLOTH AND STONE REPLACED WHEN CLOGGED WITH SEDIMENT. 8. ASSURE THAT STORM FLOW DOES NOT BYPASS INLET BY INSTALLING TEMPORARY EARTH OR ASPHALT DIKES DIRECTING FLOW INTO INLET.

CURB INLET PROTECTION DETAIL

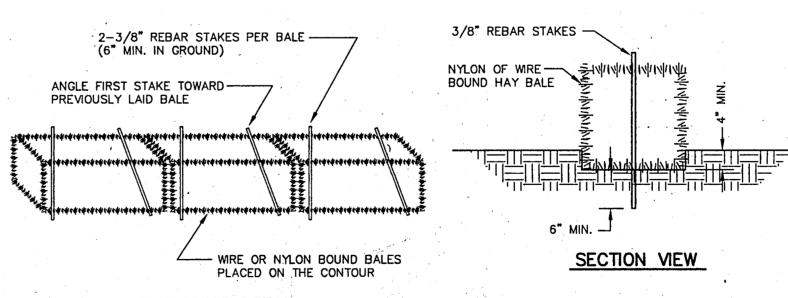

ANCHORING DETAIL

1. EACH BALE SHALL BE EMBEDDED IN THE SOIL A MINIMUM OF FOUR INCHES.

4. WHEN SILT REACHES A DEPTH OF SIX INCHES, IT SHALL BE REMOVED AND DISPOSED OF IN AN APPROVED SITE AS TO NOT CREATE A SILTATION PROBLEM. 3. INSPECTION SHALL BE WEEKLY OR AFTER EACH RAINFALL EVENT AND REPAIR OR REPLACEMENT SHALL BE MADE PROMPTLY AS NEEDED BY THE CONTRACTOR.

2. BALES SHALL BE SECURELY ANCHORED IN PLACE BY A 3/8" REBAR STAKE
DRIVEN THROUGH THE BALE. THE FIRST STAKE IN EACH BALE SHALL BE ANGLED
TOWARD PREVIOUSLY LAID BALE TO FORCE BALES TOGETHER.

DISPUSED OF IN AN APPROVED SITE AS TO NOT CREATE A SICIATION PROBLEM.

5. AFTER THE DEVELOPMENT SITE IS COMPLETELY STABILIZED, THE BALES AND ACCUMULATED SILT SHALL BE REMOVED AND DISPOSED OF AT AN APPROVED

HAY BALE DIKE DETAILS

DDIS

REVISIONS: REVISION 11/02/98 PUBLIC WORKS COMMENTS

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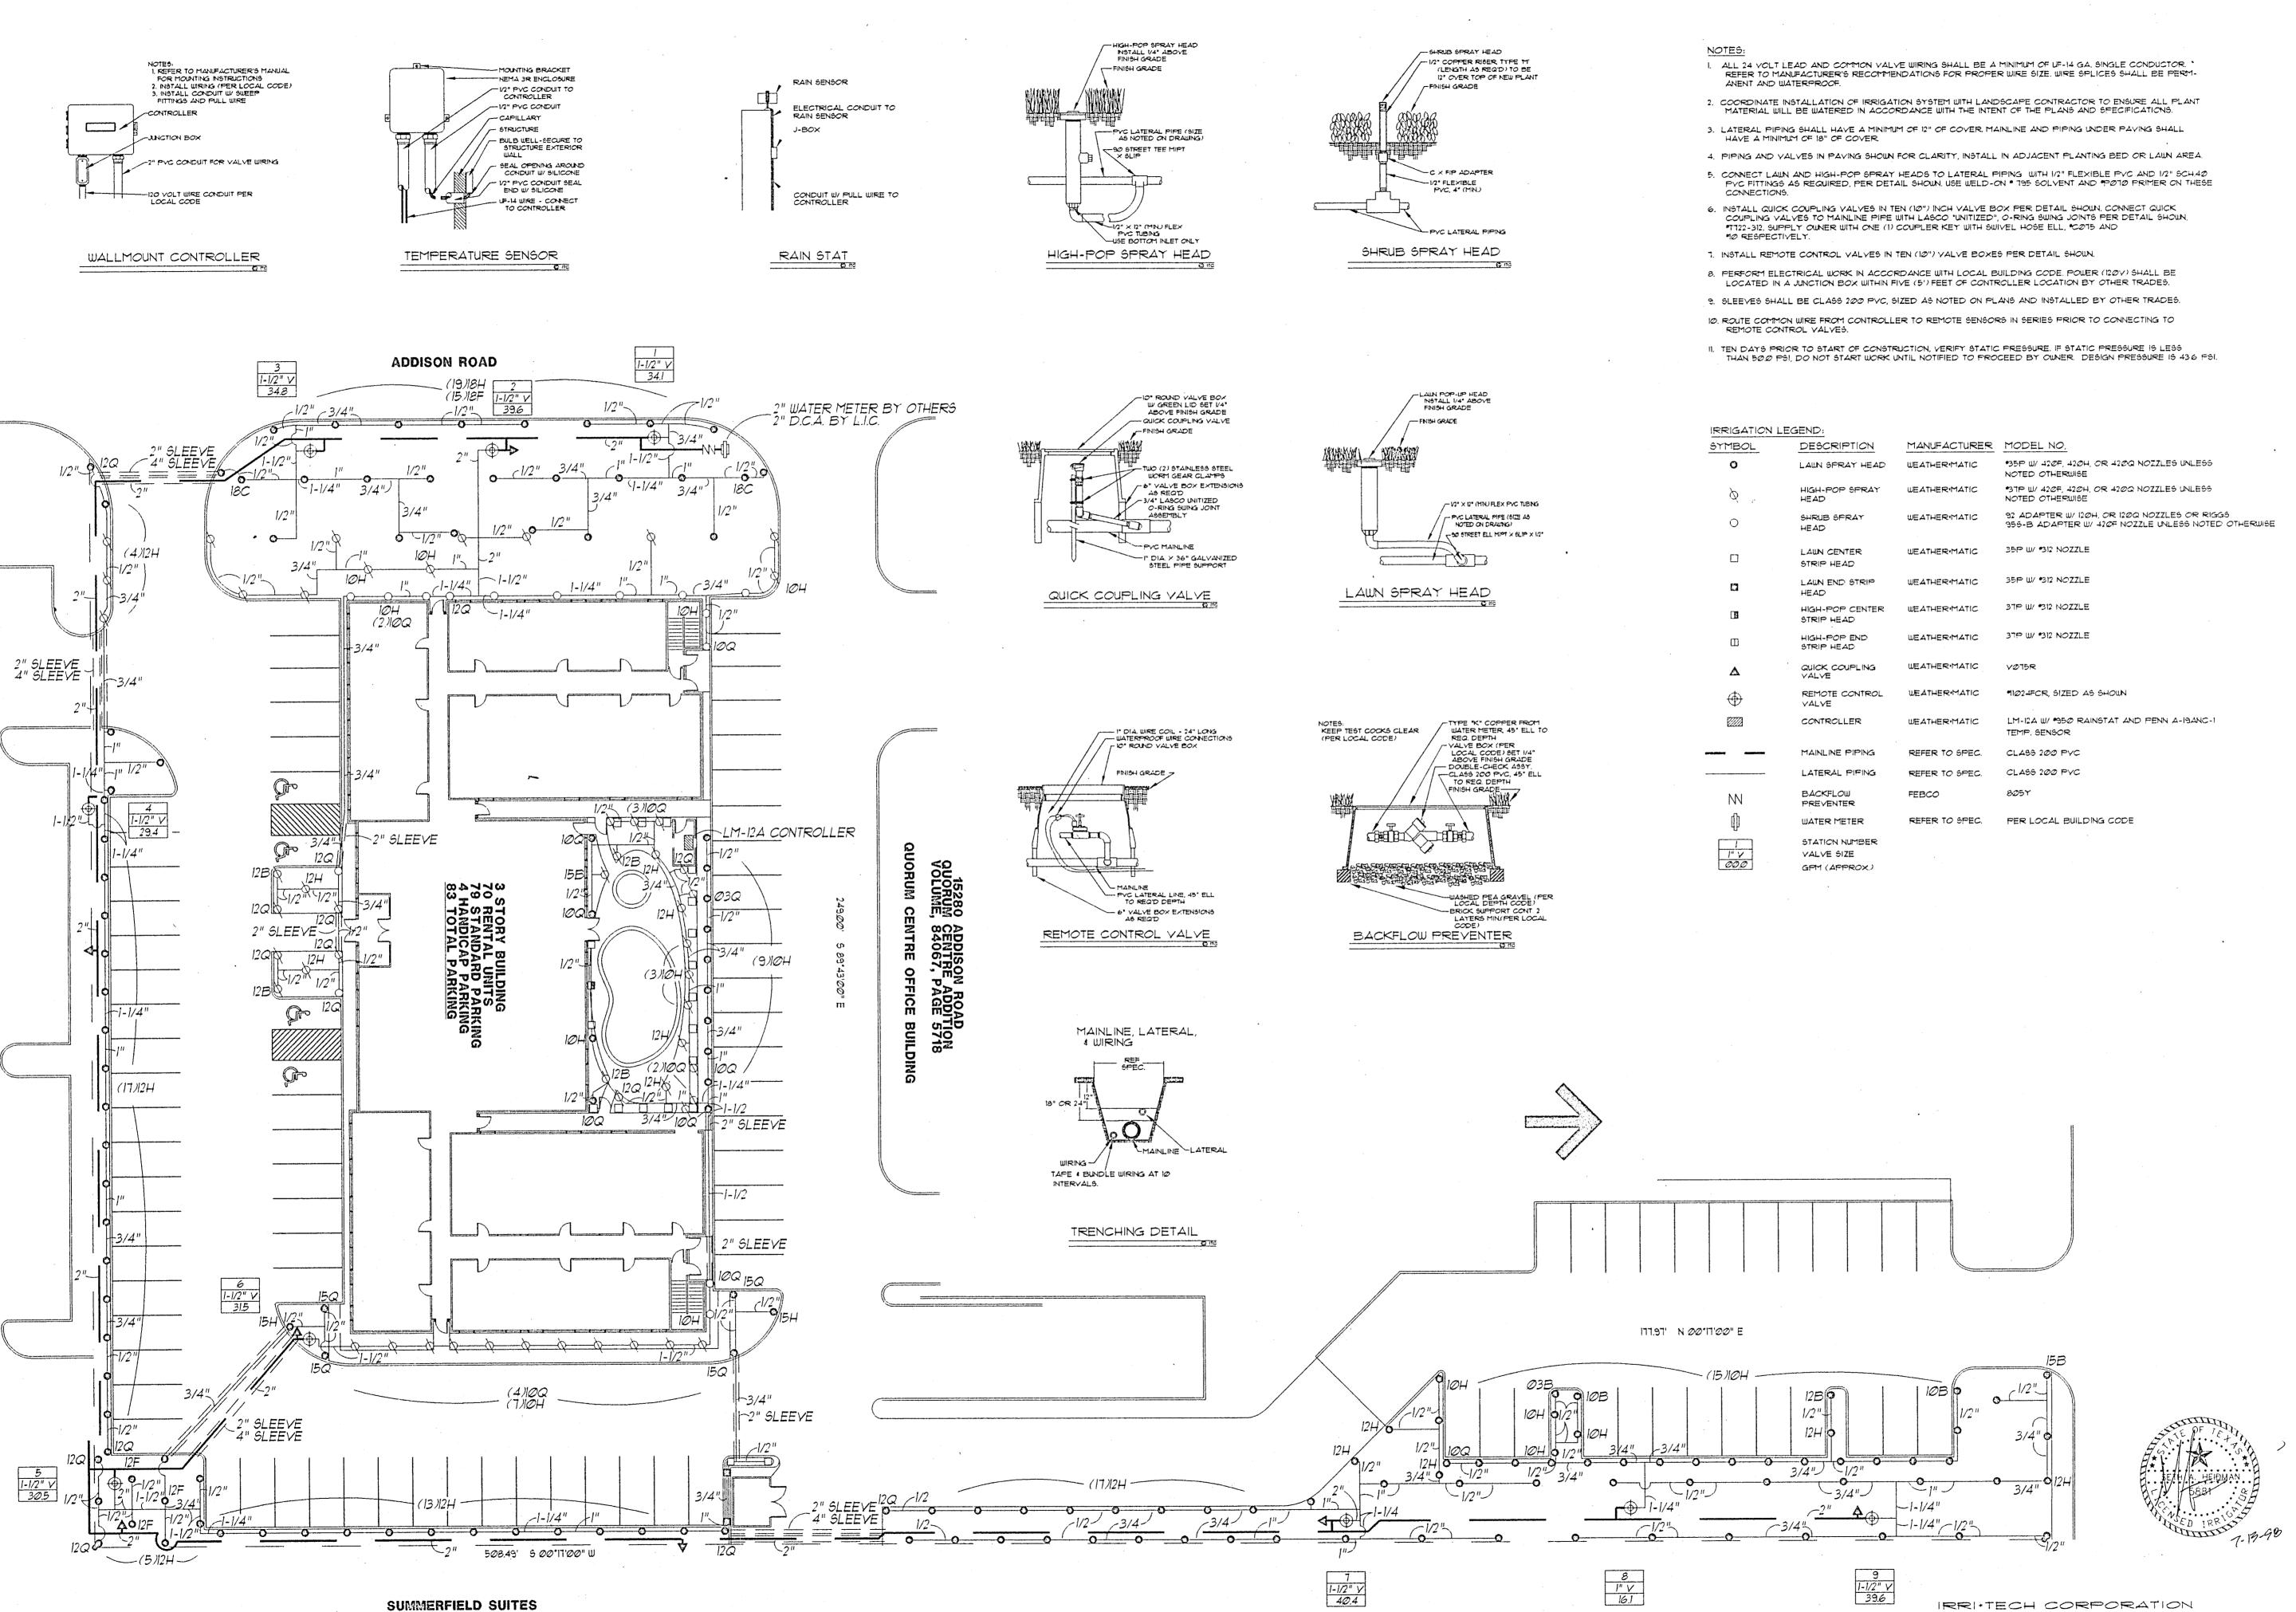
SHEET TITLE DETAIL SHEET


DATE: 09/11/98 **SCALE:** 1" = 20'

DRAWN BY: J.N.M. CHECKED BY: JDJR

SHEET NO.

PARKING LOT



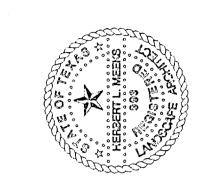

PROJECT NAME **MAINSTAY**

ADDISON, **TEXAS**

MEEKS DESIGN GROUP 1100 CENTENNIAL BLVD. #120

RICHARDSON, TEXAS 75081 (972)690-7474 FAX (972)690-7878 TITLE IRRIGATION DATE 03/23/98 SCALE


SHEET

DESIGN DEPARTMENT 12650 SCHROEDER RD.

DALLAS, TEXAS 75243

(も72/231-5151 FAX(も72/231-5172

1"=20'-0" L3.01

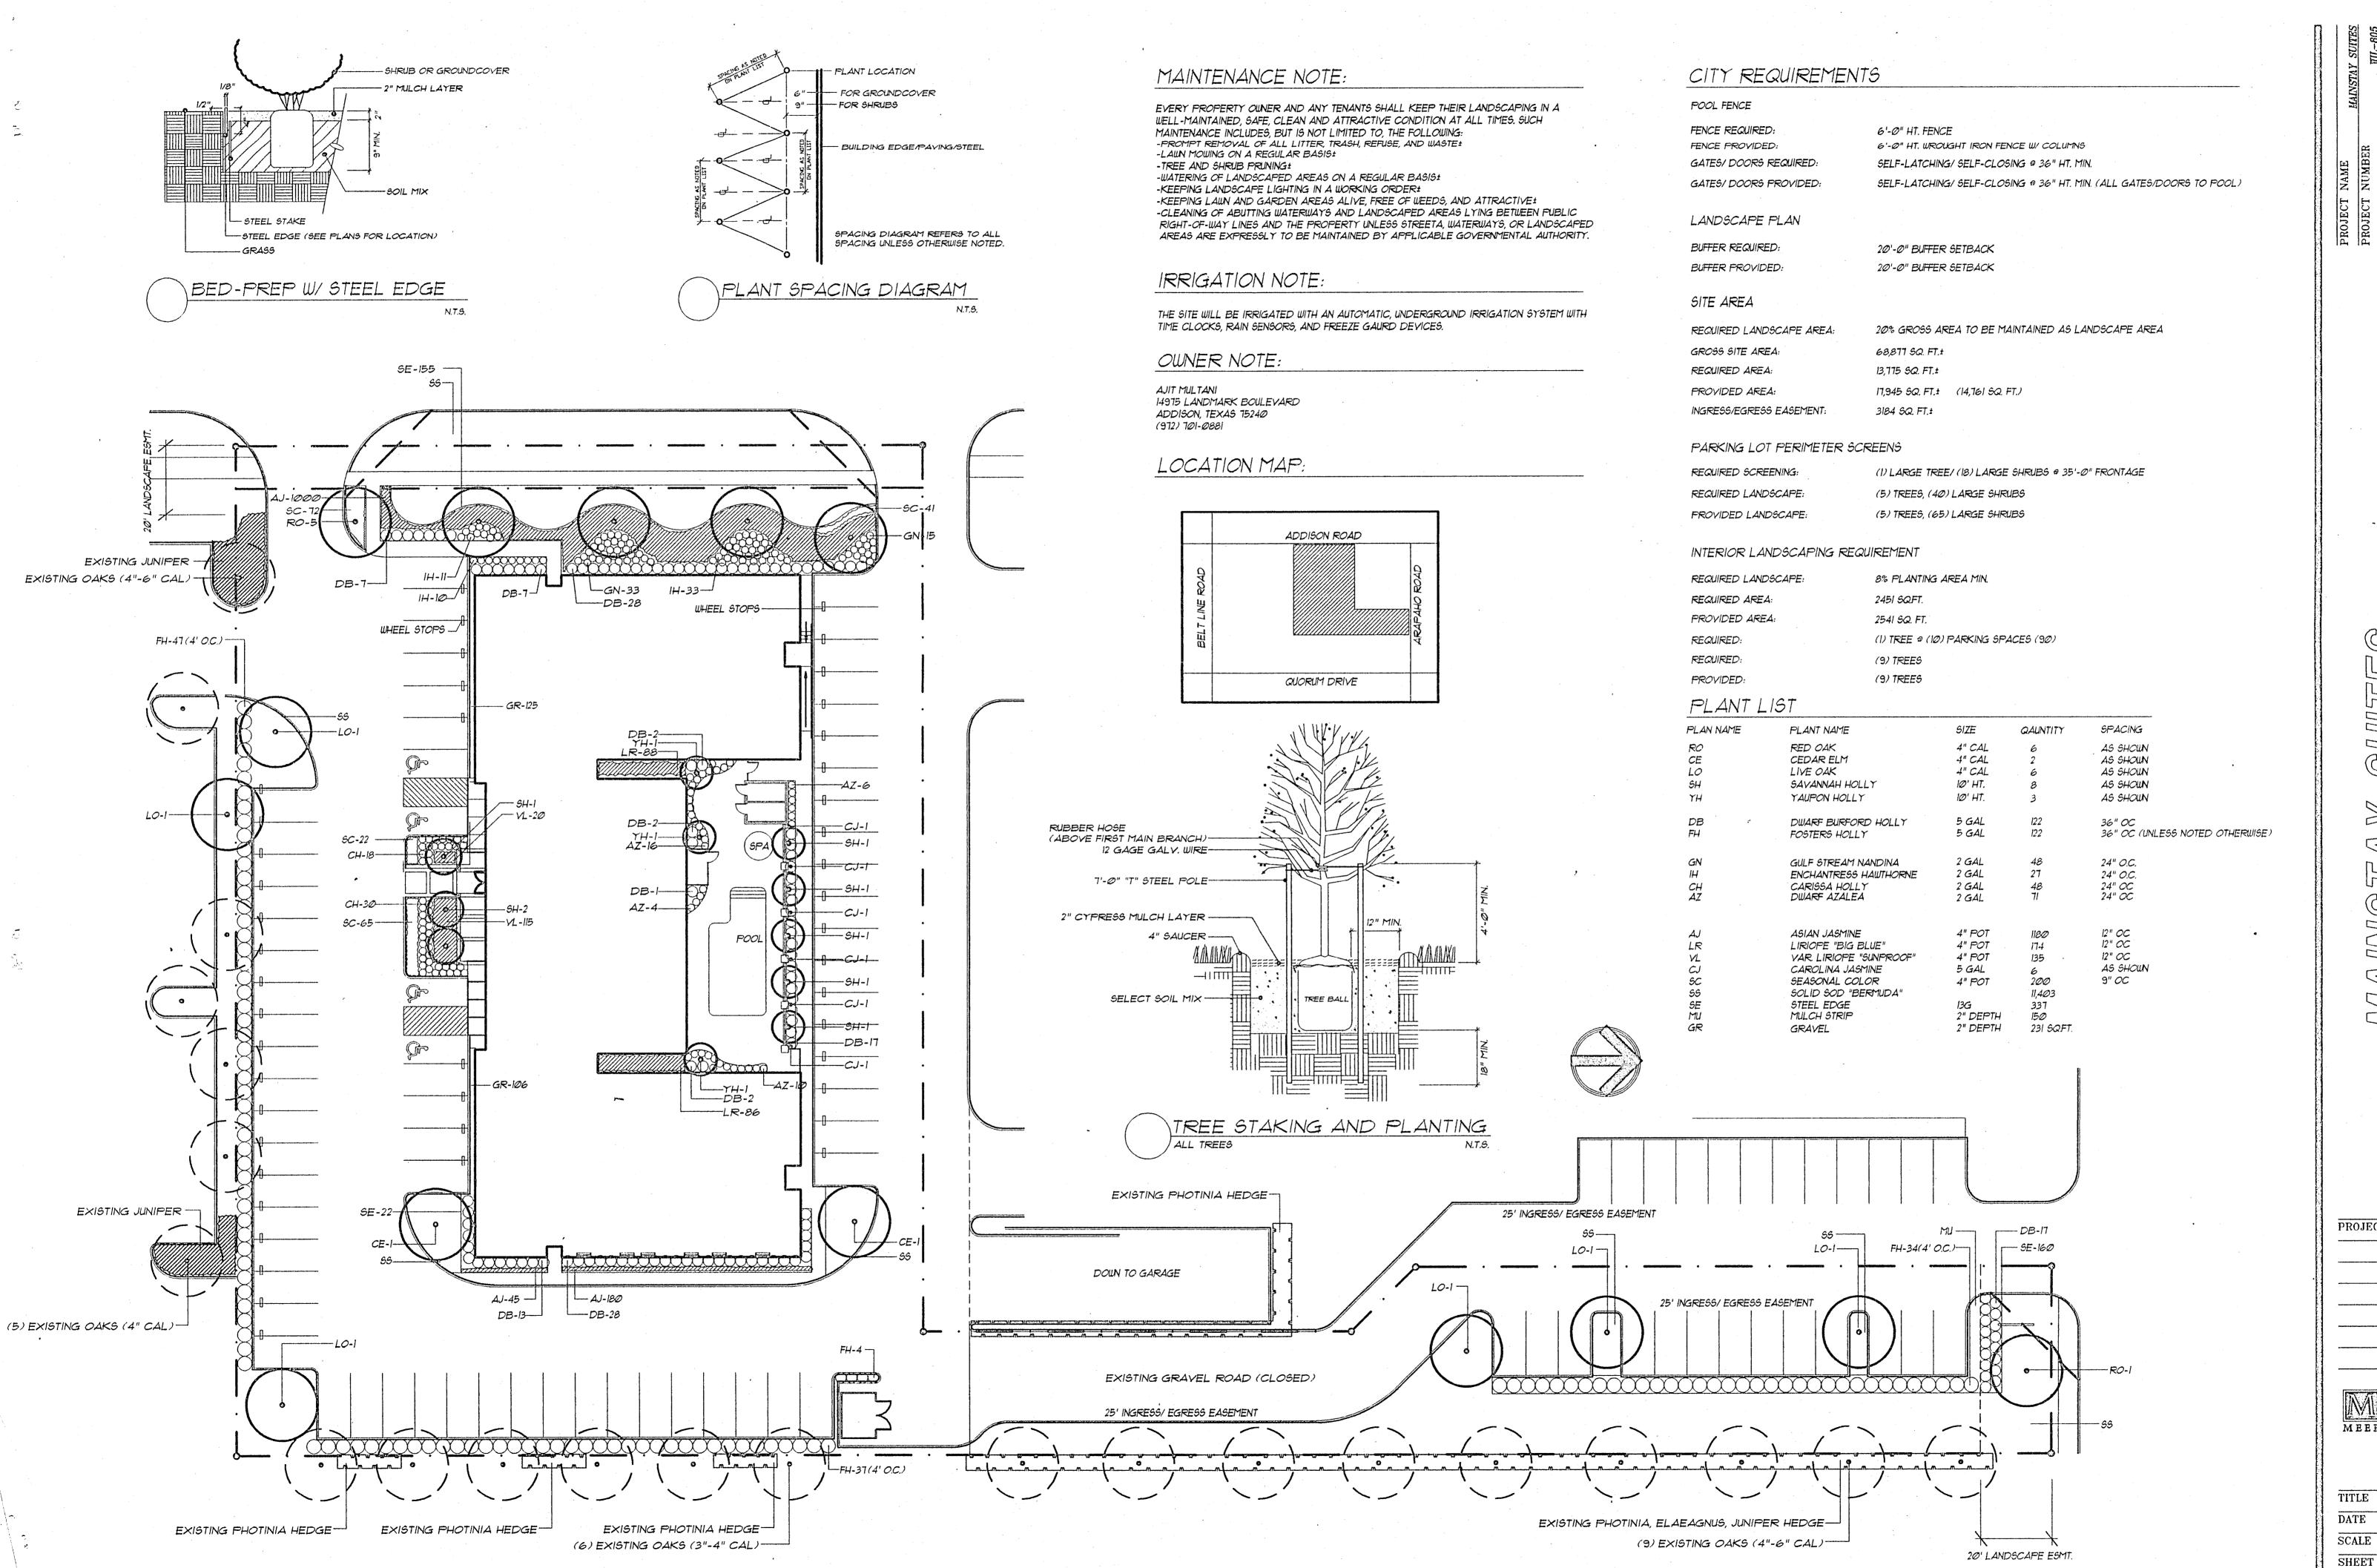

PROJECT NAME

MAINSTAY

MAIN

SUITES

ADDISON

MEEKS DESIGN GROUP

1100 CENTENNIAL BLVD. #120
RICHARDSON, TEXAS 75081
(972)690-7474
FAX (972)690-7878

 TITLE
 CITY SUBMITTAL

 DATE
 03/23/98

 SCALE
 1"=20'-0"

PL1.01