
CONSTRUCTION PLANS FOR:

PAVING AND DRAINAGE IMPROVEMENTS 15841 ADDISON ROAD

ADDISON AIRPORT ADDISON, TEXAS

SEPTEMBER 2009

PW# 2008-21

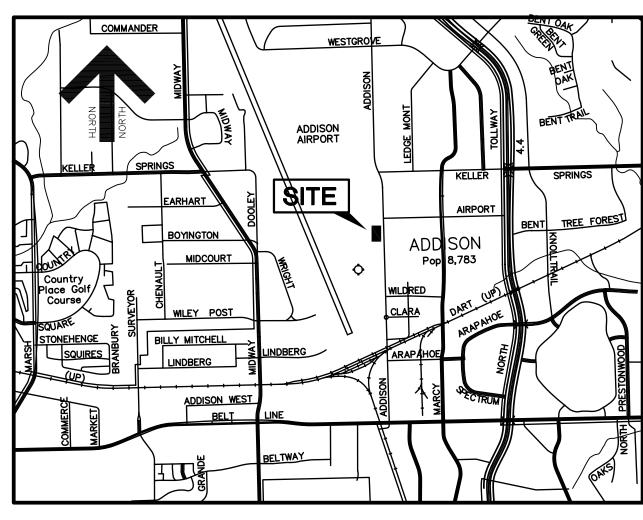

LOCATION MAP

SCALE: 1"=2000'

"AS—BUILT"

THIS AS—BUILT DRAWING IS BASED ON INFORMATION OBTAINED FROM BUILDING CONTRACTORS DURING CONSTRUCTION AS PROVIDED TO JDJR ENGINEERS & CONSULTANTS, INC..

JDJR ENGINEERS & CONSULTANTS, INC. DOES NOT GUARANTEE THE ACCURACY OR COMPLETENESS OF THESE RECORDS.

PREPARED FOR:
MSF PROPERTIES
TWO LEGACY TOWN CENTER
6900 N. DALLAS PARKWAY, SUITE 730
PLANO, TEXAS 75024
PHONE: (972) 403-0909

CONTACT: RICHARD FRENCH

SHEET INDEX

COVERSHEET

PLAT

C1A SITE DIMENSIONAL CONTROL PLAN

C1B SITE DIMENSIONAL CONTROL PLAN

C2 DEMOLITION PLAN

C3A GRADING, DRAINAGE AND PAVING PLAN

C3B GRADING, DRAINAGE AND PAVING PLAN

C3C PAVEMENT JOINT PATTERN PLAN
C3D PAVEMENT JOINT PATTERN PLAN


C4 STORM DRAIN PLAN


C5 STORM DRAIN PROFILE AND DETAILS

C6 FIRE SPRINKLER SERVICE PLAN

C7 EROSION CONTROL PLAN



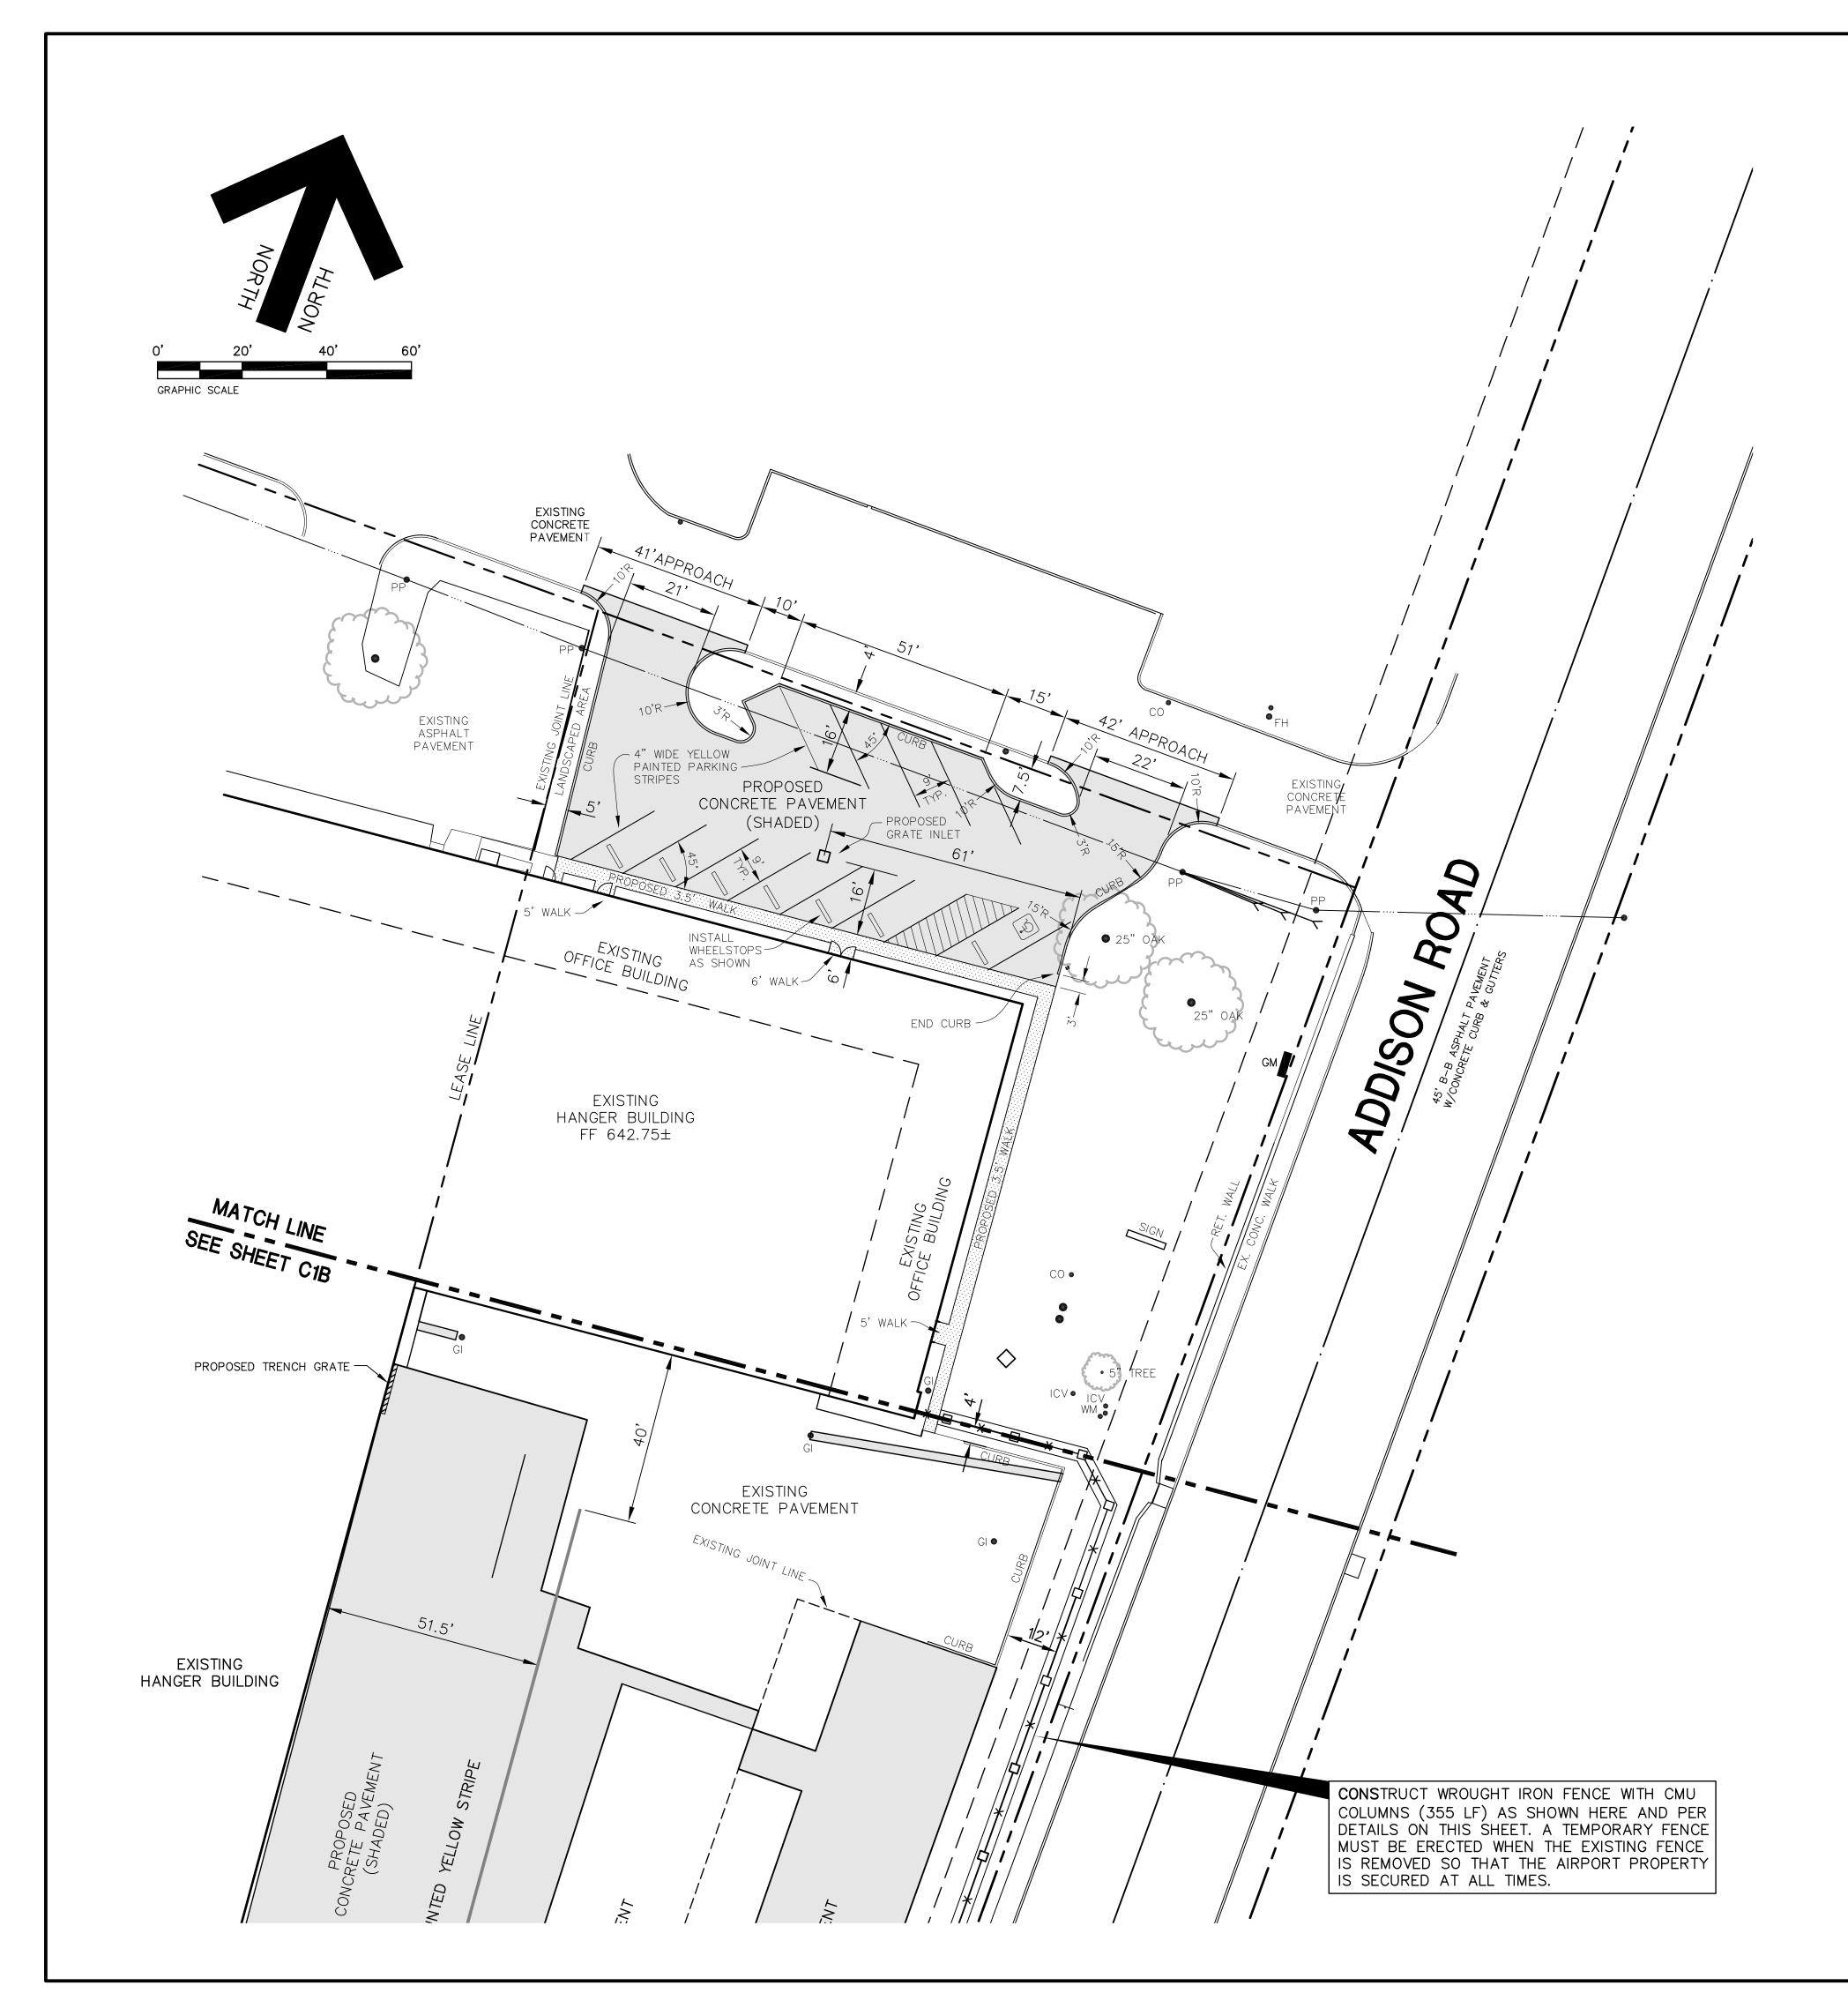

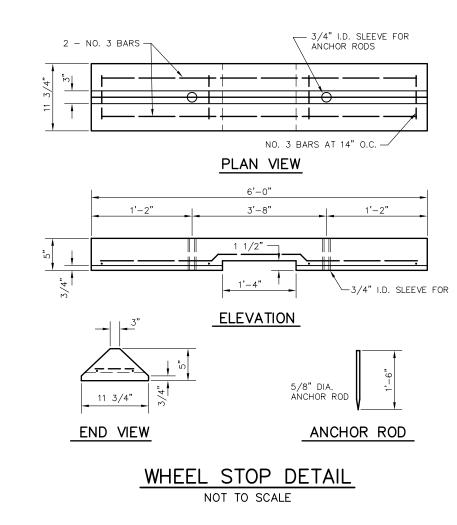



NOTES:

- 1. ALL CONSTRUCTION TO BE DONE IN STRICT ACCORDANCE TO THESE PLANS AND ALL APPLICABLE MUNICIPAL CODES AND STANDARDS.
- 2. SEE ARCHITECTURAL PLANS FOR ALL BUILDING DIMENSIONS AND DETAILS.
- 3. SEE SHEET C-2 FOR ALL SITE DEMOLITION PLAN.
- 4. SEE SHEET C-3 FOR ALL PAVING AND GRADING PLANS.
- 5. SEE SHEET C-6 FOR UTILITY PLAN OF THE SITE.
- 6. SEE SHEET C-7 FOR EROSION CONTROL PLAN OF THE SITE.

ACCESSIBILITY NOTES:

- 1. ALL ACCESSIBLE PARKING AREAS, ROUTES, RAMPS, ETC. SHALL BE CONSTRUCTED IN ACCORDANCE WITH THE TEXAS ACCESSIBILITY STANDARDS (TAS).
- 2. ALL SIDEWALK RAMPS AND/OR CURB RAMPS SHOWN SHALL HAVE A MAXIMUM VERTICAL RISE OF 6" WITH A MAXIMUM RUNNING SLOPE OF 1:12 (8.33%) AND BE CONSTRUCTED IN ACCORDANCE WITH TAS SECTIONS 4.7 AND 4.8.
- 3. ALL ACCESSIBLE ROUTES (EXCEPT FOR THE SIDEWALK AND CURB RAMPS) SHALL HAVE A MAXIMUM RUNNING SLOPE OF 1:20 (5%) AND A MAXIMUM CROSS SLOPE OF 1:50 (2%).
- 4. ALL ACCESSIBLE PARKING SPACES AND ISLES SHALL HAVE A MAXIMUM SLOPE IN ANY DIRECTION OF 1:50 (2%). REFER TO ARCHITECTURAL PLANS FOR DETAILS OF MARKINGS, SIGNS, ETC.

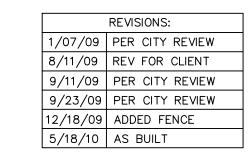

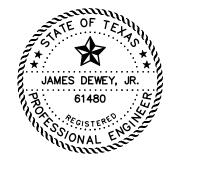

"AS-BUILT"

THIS AS—BUILT DRAWING IS BASED ON INFORMATION OBTAINED FROM BUILDING CONTRACTORS DURING CONSTRUCTION AS PROVIDED TO JDJR ENGINEERS & CONSULTANTS, INC..

JDJR ENGINEERS & CONSULTANTS, INC. DOES NOT GUARANTEE THE ACCURACY OR COMPLETENESS OF THESE RECORDS.

SITE DIMENSIONAL CONTROL PLAN


PAVING AND DRAINAGE IMPROVEMENTS 15841 ADDISON ROAD ADDISON AIRPORT ADDISON, TEXAS

ENGINEERS AND CONSULTANTS TSBPE REGISTRATION NUMBER F-8527 ENGINEERS • SURVEYORS • LAND PLANNERS

2500 Texas Drive Suite 100 Irving, Texas 75062 Tel 972-252-5357 Fax 972-252-8958

DRAWN BY: SHEET NO. DEC. 2, 2008 CHECKED BY: 1" = 20'


C1A OF 7 JDJR

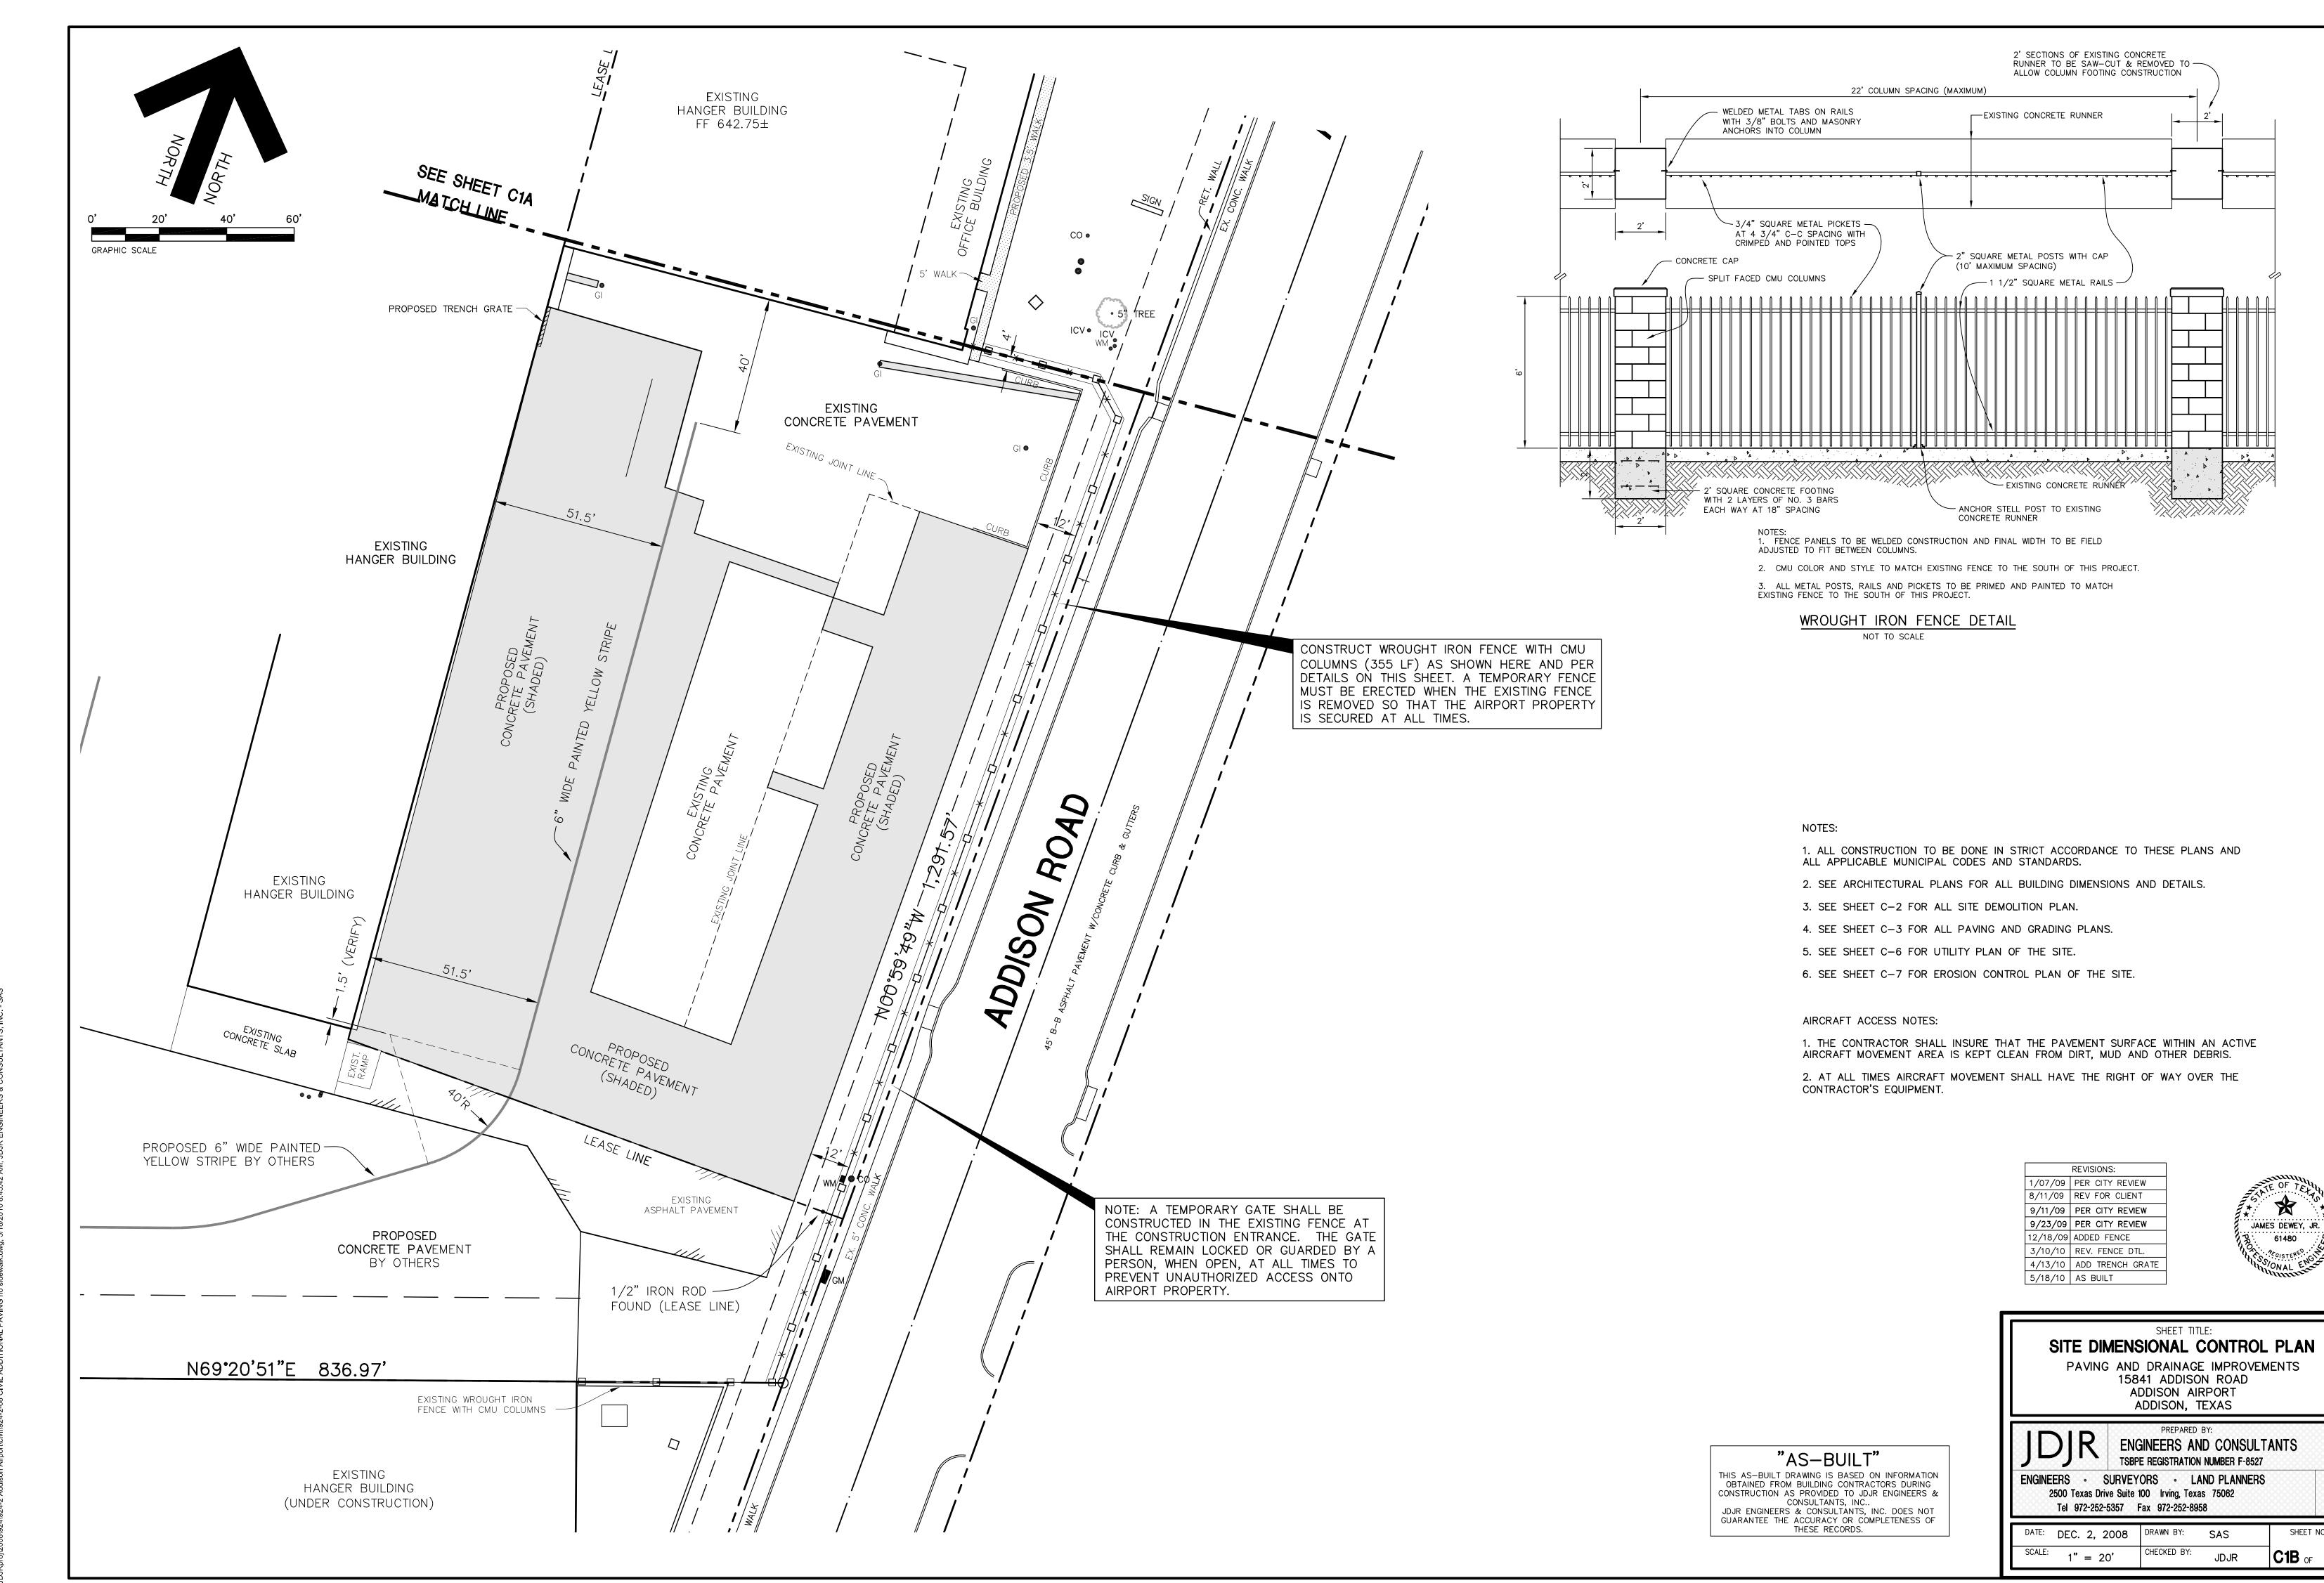

SHEET NO.

C1B OF

61480

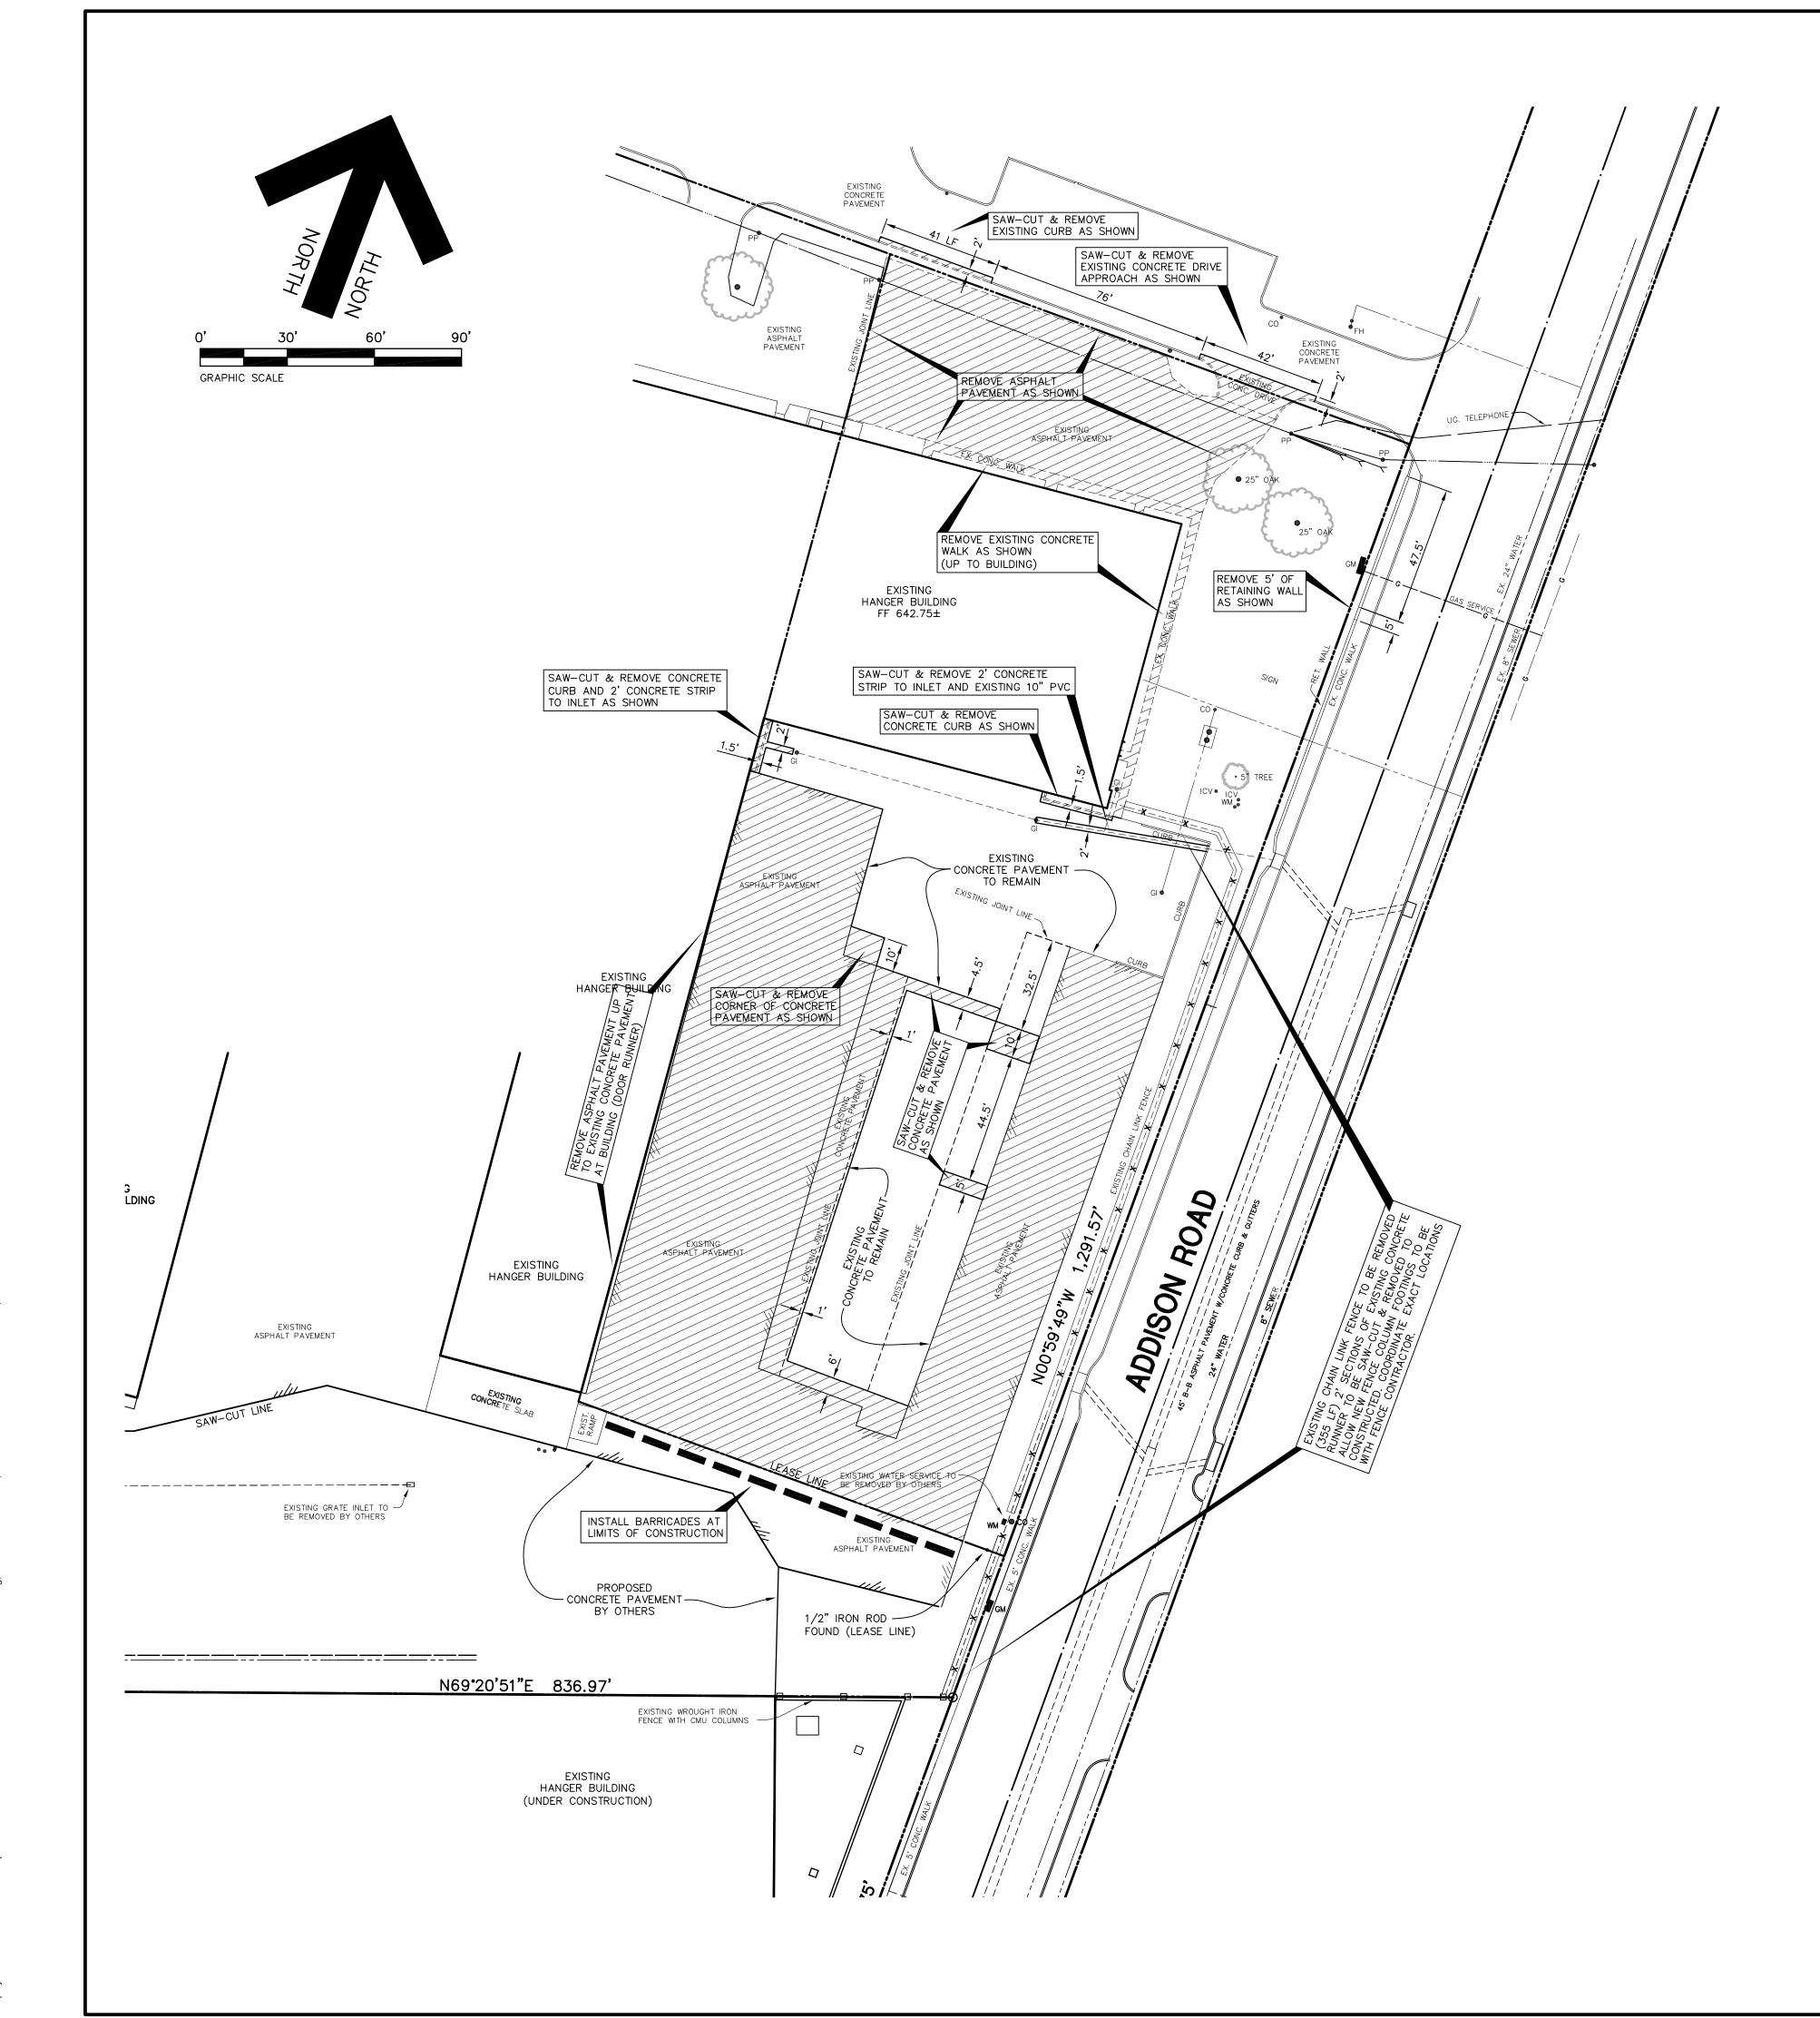


NOTES:

1. DEMOLITION CONTRACTOR TO BE FAMILIAR WITH ALL PROPOSED CONSTRUCTION PLANS BEFORE ANY SITE DEMOLITION COMMENCES.

2. DEMOLITION CONTRACTOR TO LOCATE ALL UNDERGROUND UTILITIES PRIOR TO ANY DEMOLITION WORK. CONTACT UTILITY COMPANIES AT LEAST 2 WORKING DAYS PRIOR TO ANY DEMOLITION WORK.


3. INSTALL BARRICADES AT LIMITS OF CONSTRUCTION AT THE SOUTH END OF PROJECT AS SHOWN ON PLAN. BARRICADES TO BE MULTI-BARRIER AIRPORT-RUNWAY BARRICADE AR-10x96 HDPE, AS MANUFACTURED BY OFF THE WALL PRODUCTS, DISTRIBUTED BY DALLAS LITE & BARRICADE, INC. (214) 748-5791, PART NO. P6000-101096.

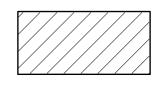

INDICATES EXISTING IMPROVEMENTS TO BE REMOVED

> "AS-BUILT" THIS AS—BUILT DRAWING IS BASED ON INFORMATION OBTAINED FROM BUILDING CONTRACTORS DURING CONSTRUCTION AS PROVIDED TO JDJR ENGINEERS & CONSULTANTS, INC..
>
> JDJR ENGINEERS & CONSULTANTS, INC. DOES NOT GUARANTEE THE ACCURACY OR COMPLETENESS OF THESE RECORDS.

	REVISIONS:				
1/07/09	PER CITY REVIEW				
8/11/09	REV FOR CLIENT				
9/11/09	PER CITY REVIEW				
9/23/09	PER CITY REVIEW				
12/18/09	FENCE REMOVAL				
5/18/10	AS BUILT				

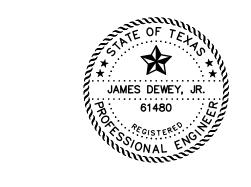

DEMOLITION PLAN

PAVING AND DRAINAGE IMPROVEMENTS 15841 ADDISON ROAD ADDISON AIRPORT ADDISON, TEXAS

ENGINEERS AND CONSULTANTS TSBPE REGISTRATION NUMBER F-8527

ENGINEERS • SURVEYORS • LAND PLANNERS 2500 Texas Drive Suite 100 Irving, Texas 75062 Tel 972-252-5357 Fax 972-252-8958

DATE: DEC. 2, 2008 DRAWN BY: SAS CHECKED BY:

C2 OF 1" = 30'

--- PROPOSED PAVEMENT

JAMES DEWEY, JR.

61480

SHEET NO.

C3A_{OF}

Tel 972-252-5357 Fax 972-252-8958

DRAWN BY:

CHECKED BY:

DEC. 2, 2008

1" = 20'


SCALE:

SITE TBM: X-CUT SET IN CONCRETE WALK ±38' NORTH

ELEVATION 642.86

OF THE NORTHEAST CORNER OF THIS TRACT.

PROPOSED CONCRETE WALK

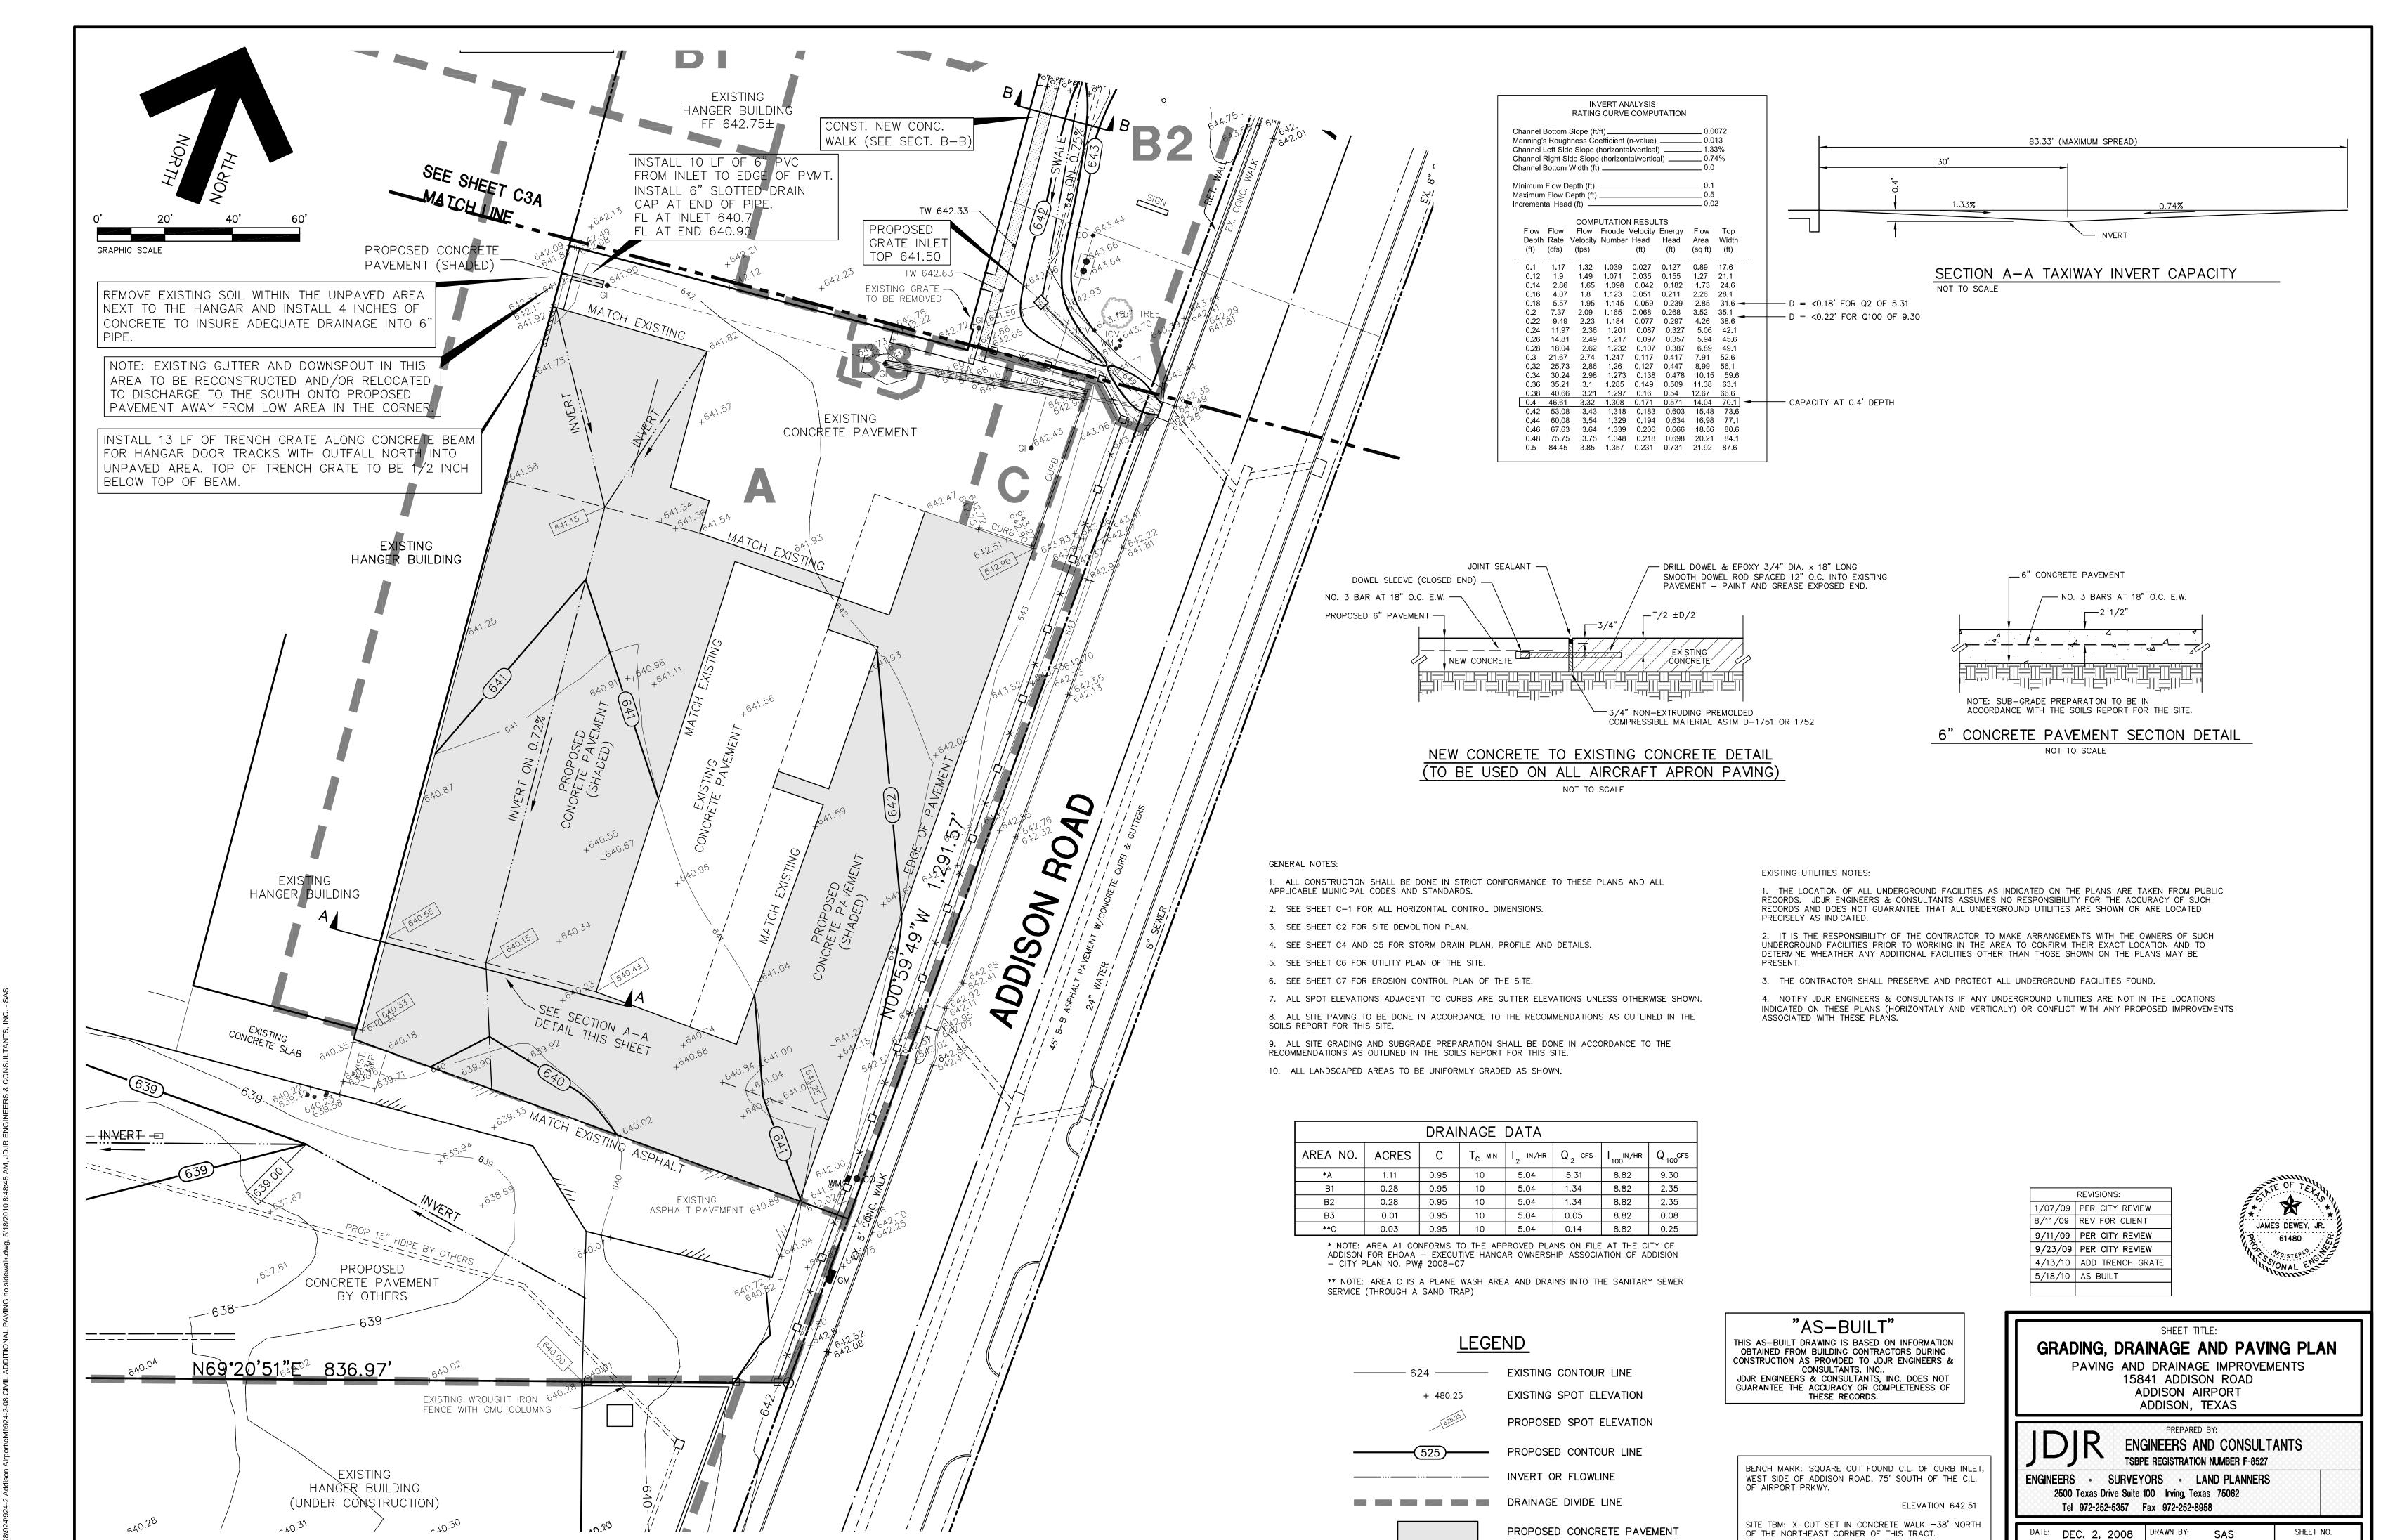


ELEVATION 642.86


SCALE:


1" = 20'

C3B_{OF}


CHECKED BY:

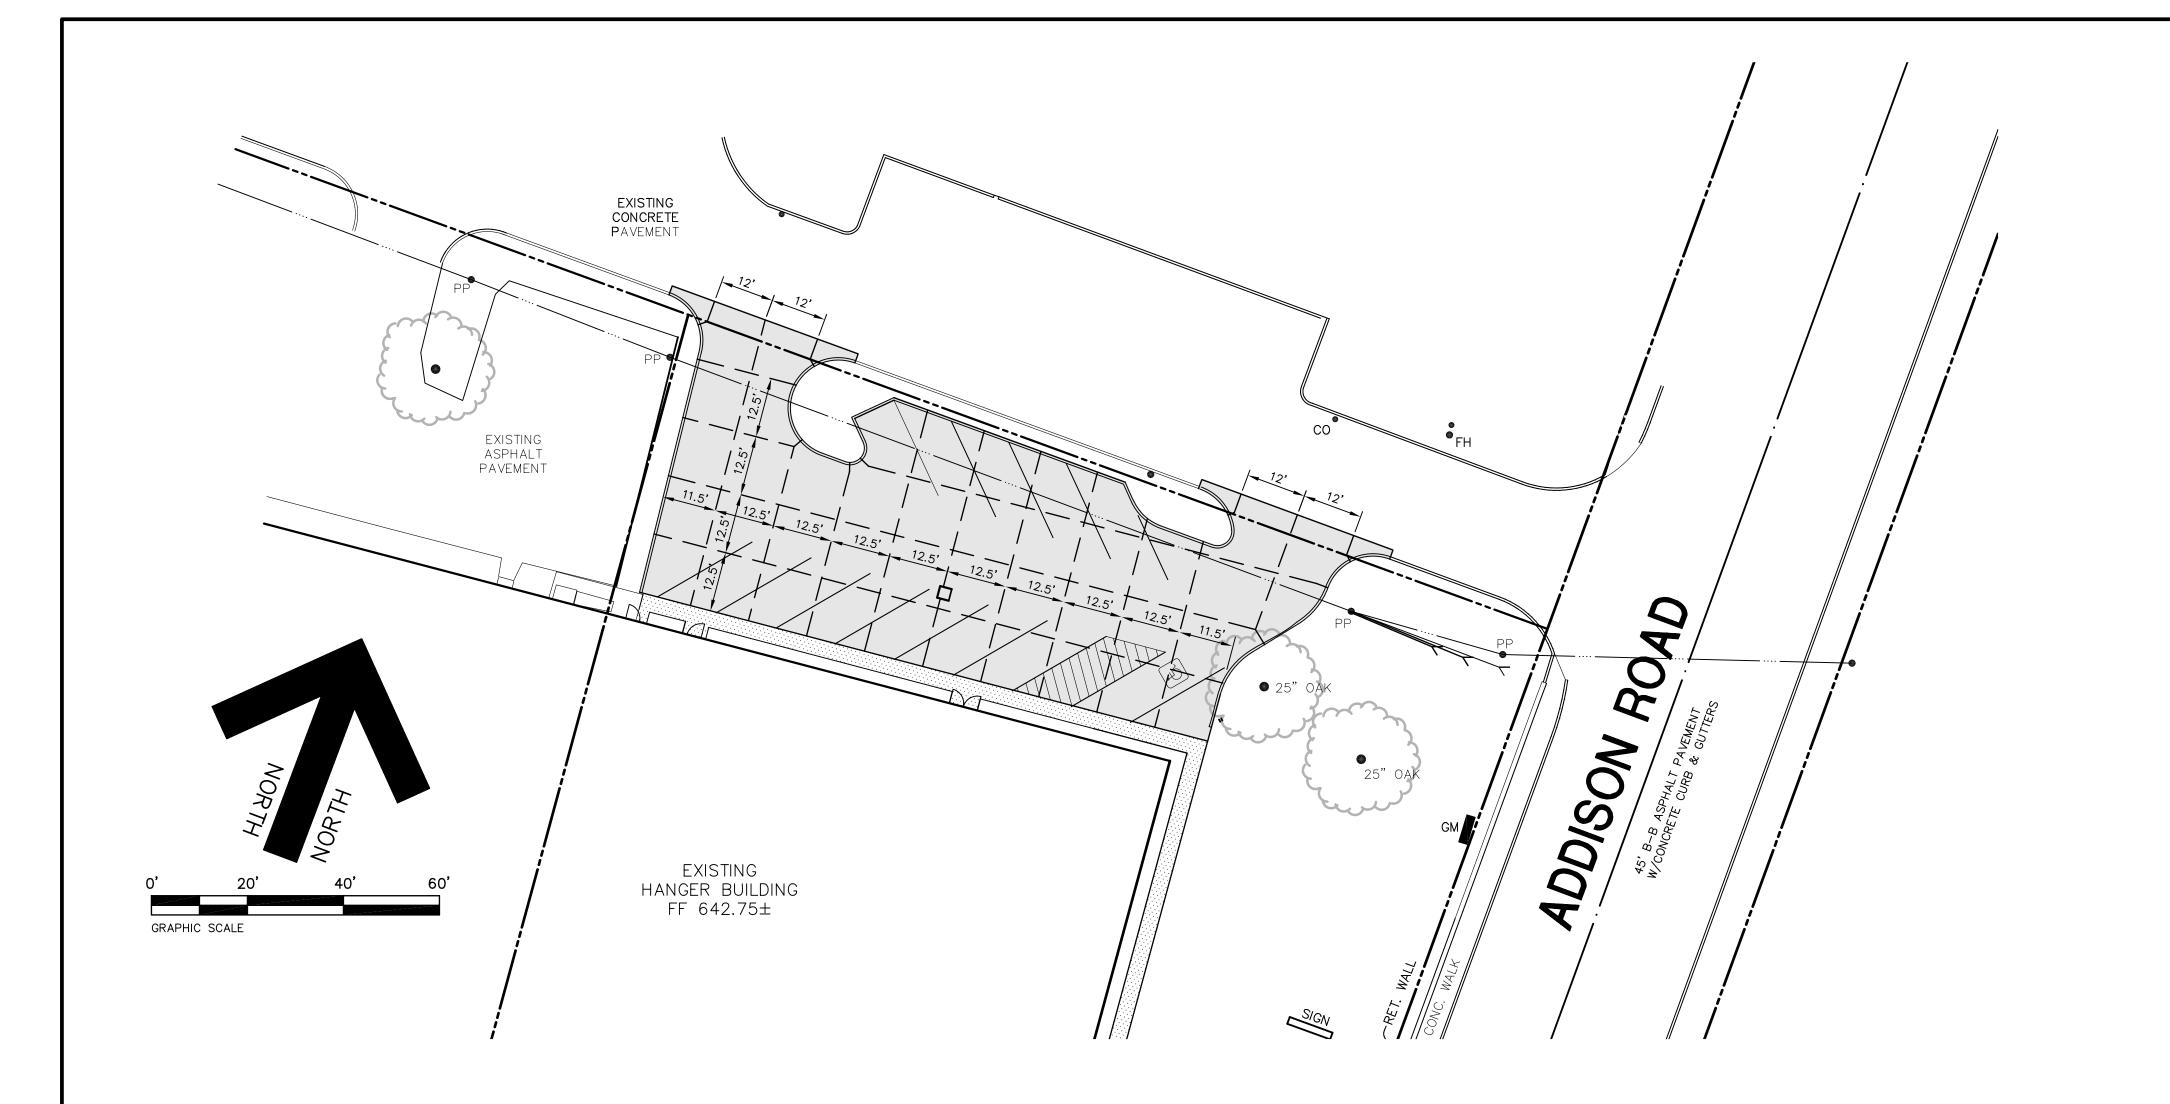

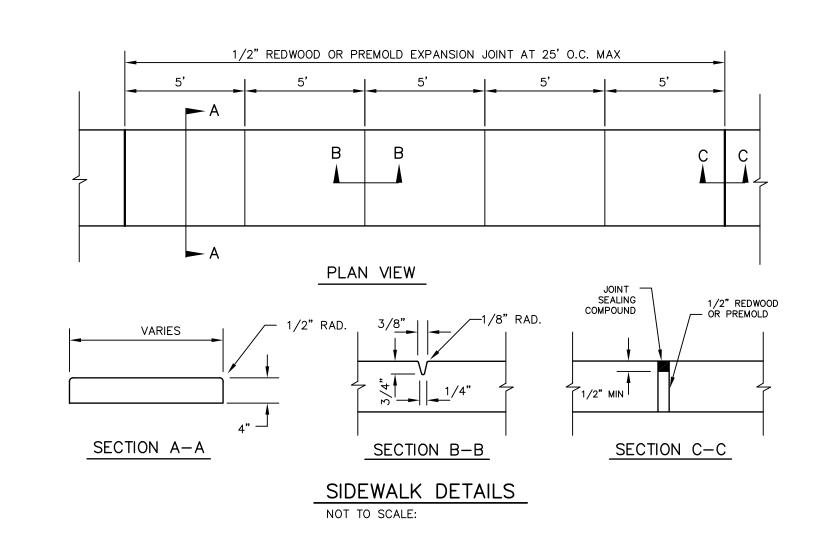


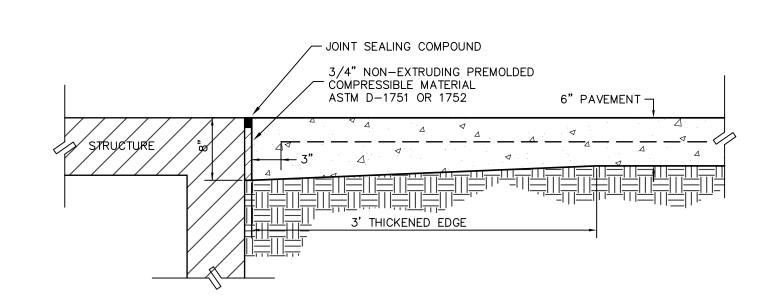

EXPANSION JOINT AT STRUCTURE DETAIL NOT TO SCALE

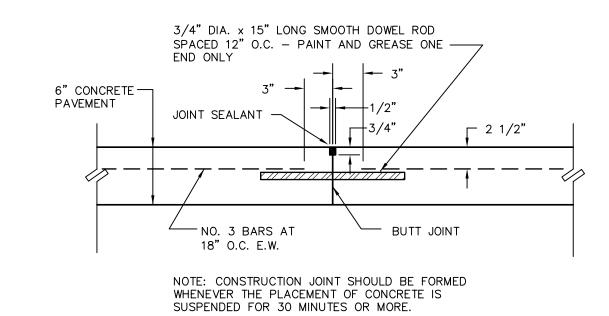


CONSTRUCTION JOINT DETAIL NOT TO SCALE

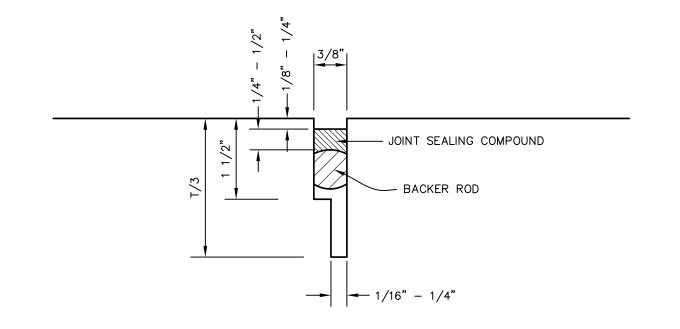

SAWED CONTRACTION JOINT DETAIL NOT TO SCALE

NOTE: T = PAVEMENT THICKNESS.

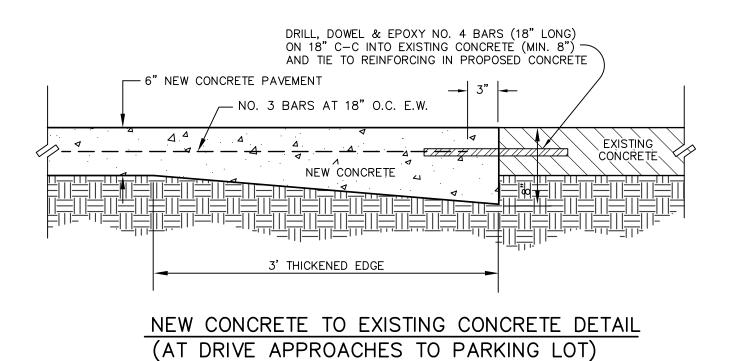

NOT TO SCALE

"AS-BUILT" THIS AS—BUILT DRAWING IS BASED ON INFORMATION OBTAINED FROM BUILDING CONTRACTORS DURING CONSTRUCTION AS PROVIDED TO JDJR ENGINEERS & CONSULTANTS, INC..

JDJR ENGINEERS & CONSULTANTS, INC. DOES NOT GUARANTEE THE ACCURACY OR COMPLETENESS OF THESE RECORDS.

_	
	PA \

SCALE:

AVEMENT JOINT PATTERN PLAN

REVISIONS: 9/11/09 PER CITY REVIEW

9/23/09 PER CITY REVIEW

5/18/10 AS BUILT

PAVING AND DRAINAGE IMPROVEMENTS 15841 ADDISON ROAD ADDISON AIRPORT ADDISON, TEXAS

SHEET TITLE:


JAMES DEWEY, JR.

ENGINEERS AND CONSULTANTS TSBPE REGISTRATION NUMBER F-8527 ENGINEERS • SURVEYORS • LAND PLANNERS

Tel 972-252-5357 Fax 972-252-8958 DATE: DEC. 2, 2008 DRAWN BY: SAS

SHEET NO. C3C_{OF} CHECKED BY: 1" = 20'


LEGEND — — — — SAWED CONTRACTION JOINT PROPOSED CONCRETE PAVEMENT PROPOSED CONCRETE WALK 2500 Texas Drive Suite 100 Irving, Texas 75062

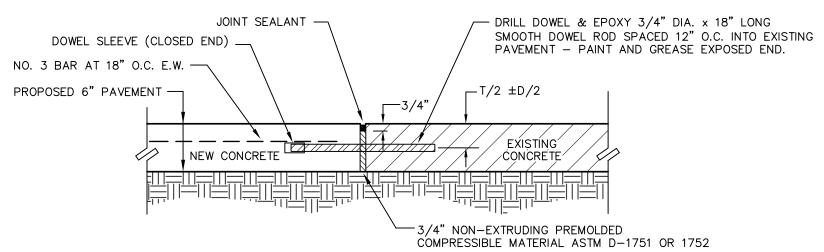

NEW CONCRETE TO EXISTING CONCRETE DETAIL


(TO BE USED ON ALL TAXI—WAY PAVING)

NOT TO SCALE

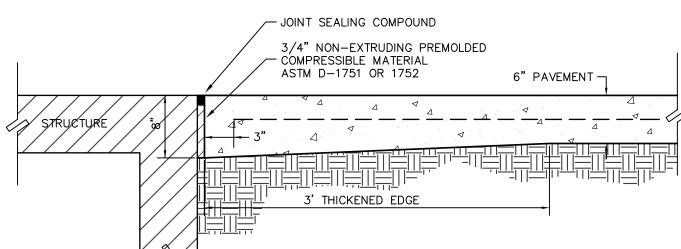

EXPANSION JOINT AT STRUCTURE DETAIL


NOT TO SCALE

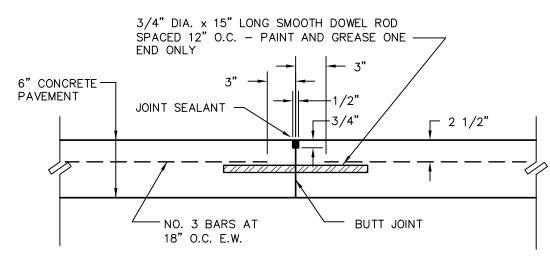

NOTE: CONSTRUCTION JOINT SHOULD BE FORMED WHENEVER THE PLACEMENT OF CONCRETE IS SUSPENDED FOR 30 MINUTES OR MORE.

CONSTRUCTION JOINT DETAIL


NOT TO SCALE

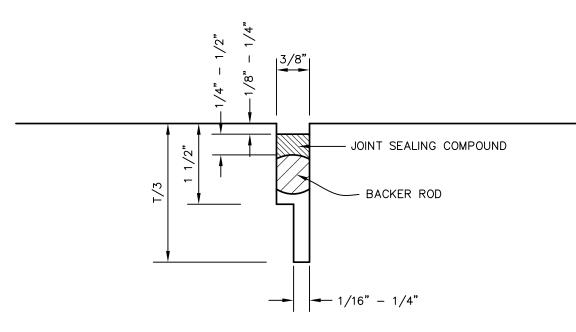

NOTE: T = PAVEMENT THICKNESS.

SAWED CONTRACTION JOINT DETAIL
NOT TO SCALE

REVISIONS:					
9/11/09	PER CITY REVIEW				
9/23/09	PER CITY REVIEW				
5/18/10	AS BUILT				

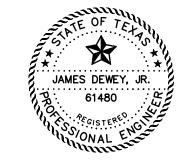

<u>LEGEND</u>

— — — — SAWED CONTRACTION JOINT

PROPOSED CONCRETE PAVEMENT

PROPOSED CONCRETE WALK

SHEET TITLE:
PAVEMENT JOINT PATTERN PLAN

"AS-BUILT"

THIS AS—BUILT DRAWING IS BASED ON INFORMATION OBTAINED FROM BUILDING CONTRACTORS DURING CONSTRUCTION AS PROVIDED TO JDJR ENGINEERS & CONSULTANTS, INC..

JDJR ENGINEERS & CONSULTANTS, INC. DOES NOT GUARANTEE THE ACCURACY OR COMPLETENESS OF THESE RECORDS.

PAVEMENT JOINT PATTERN PLAN
PAVING AND DRAINAGE IMPROVEMENTS
15841 ADDISON ROAD
ADDISON AIRPORT

ADDISON AIRPORT
ADDISON, TEXAS

PREPARED BY:


ENGINEERS AND CONSULTANTS
TSBPE REGISTRATION NUMBER F-8527

ENGINEERS - SURVEYORS - LAND PLANNERS
2500 Texas Drive Suite 100 Irving, Texas 75062

Tel 972-252-5357 Fax 972-252-8958


DATE: DEC. 2, 2008 DRAWN BY: SAS


: 1" = 20' CHECKED BY: JDJR C3D_{OF}

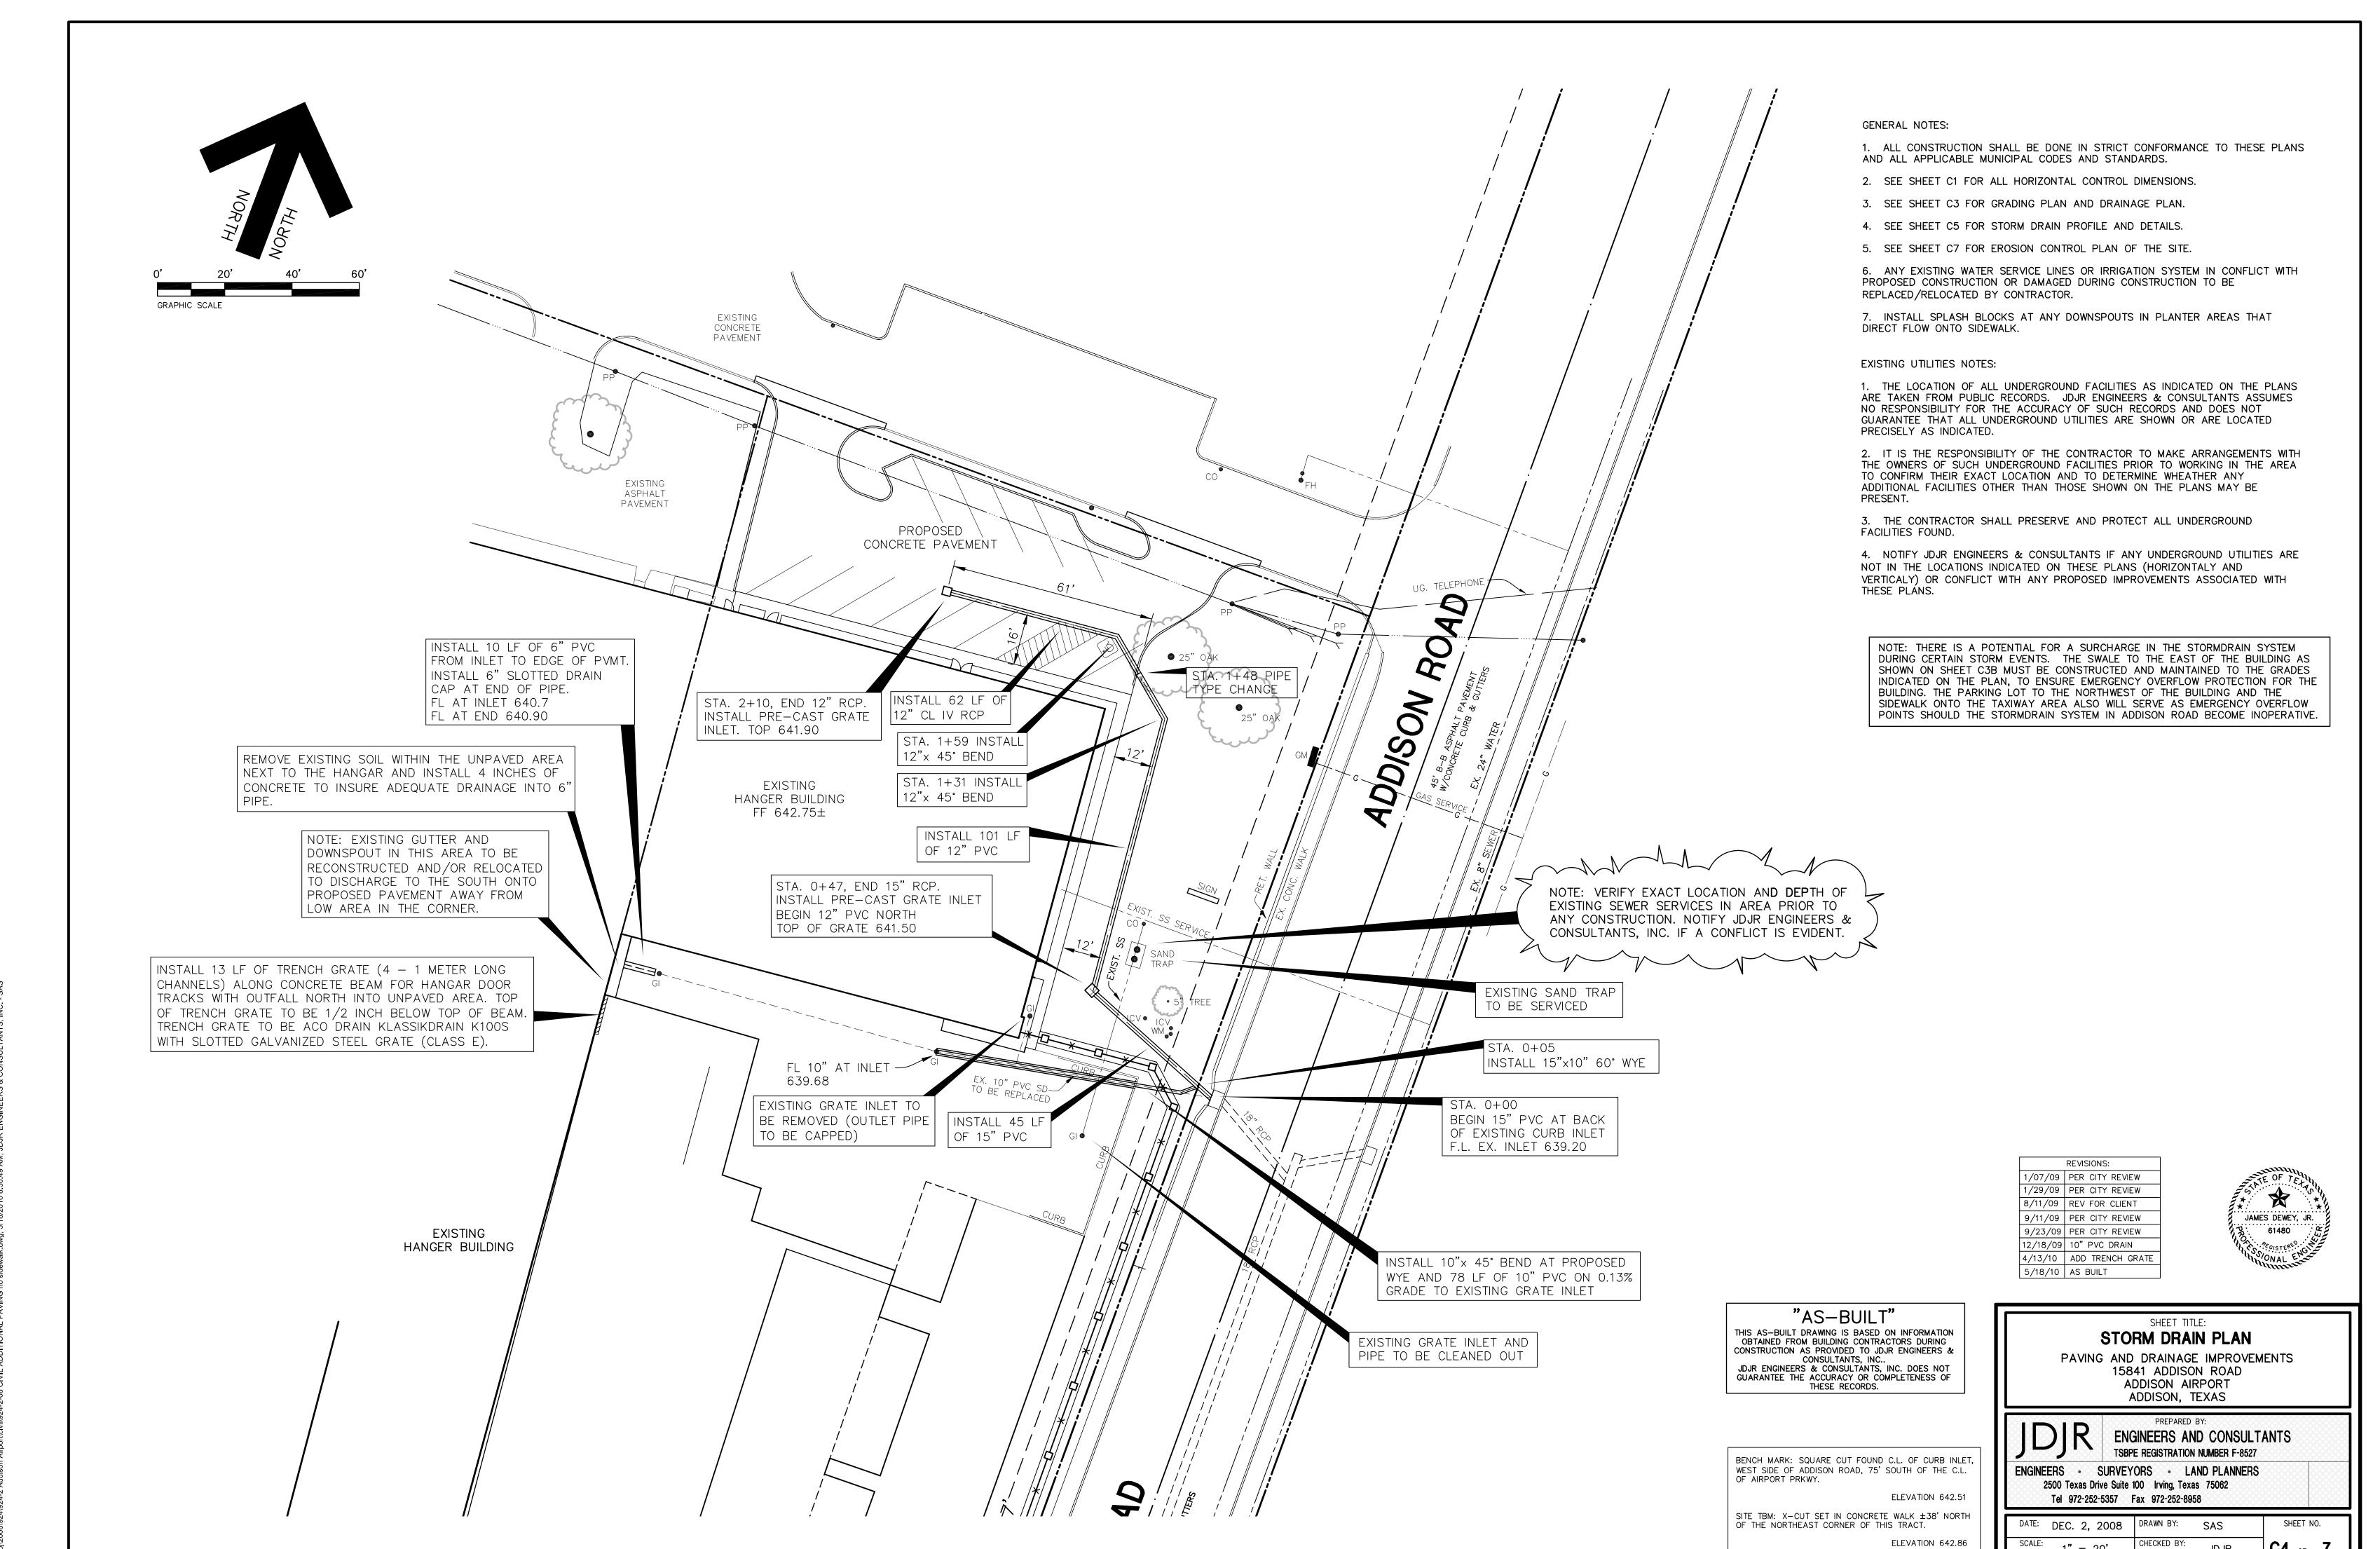

C4 of 7

1" = 20'

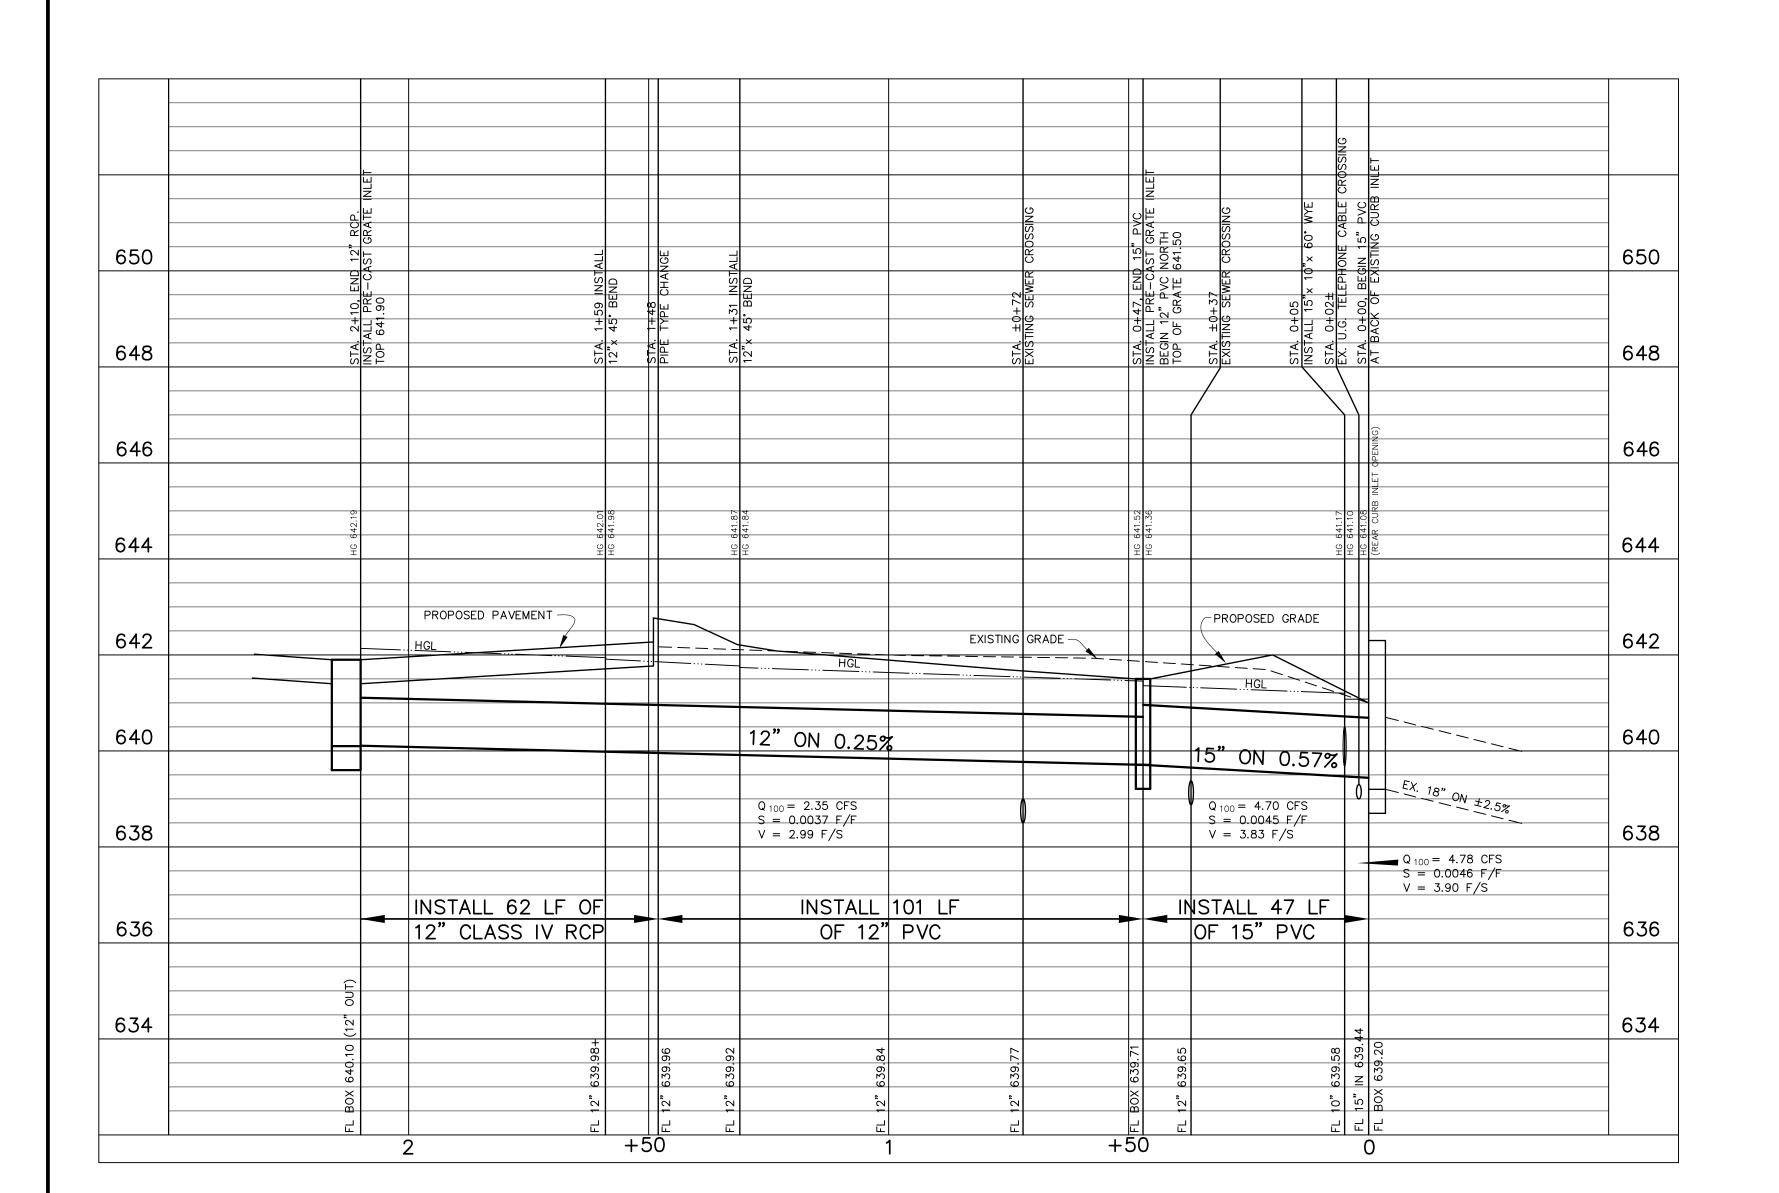

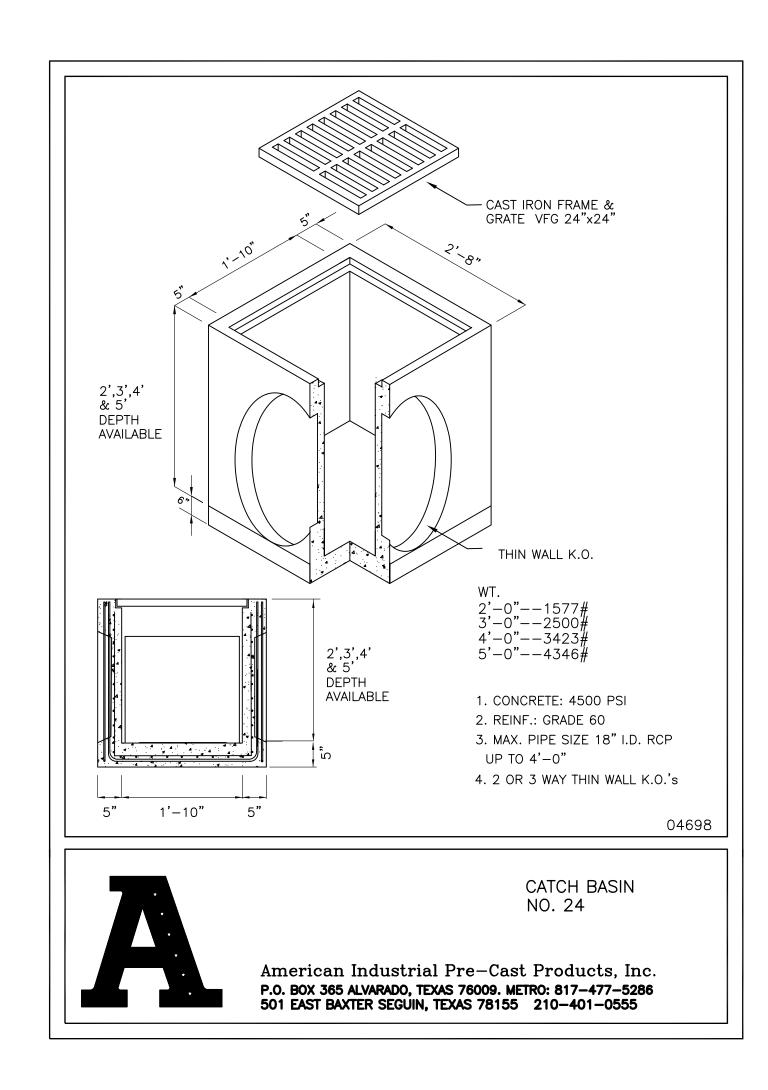


NOTE: THERE IS A POTENTIAL FOR A SURCHARGE IN THE STORMDRAIN SYSTEM DURING CERTAIN STORM EVENTS. THE SWALE TO THE EAST OF THE BUILDING AS SHOWN ON SHEET C3B MUST BE CONSTRUCTED AND MAINTAINED TO THE GRADES INDICATED ON THE PLAN, TO ENSURE EMERGENCY OVERFLOW PROTECTION FOR THE BUILDING. THE PARKING LOT TO THE NORTHWEST OF THE BUILDING AND THE SIDEWALK ONTO THE TAXIWAY AREA ALSO WILL SERVE AS EMERGENCY OVERFLOW POINTS SHOULD THE STORMDRAIN SYSTEM IN ADDISON ROAD BECOME INOPERATIVE.


"AS-BUILT"

THIS AS-BUILT DRAWING IS BASED ON INFORMATION OBTAINED FROM BUILDING CONTRACTORS DURING CONSTRUCTION AS PROVIDED TO JDJR ENGINEERS &

CONSULTANTS, INC..

JDJR ENGINEERS & CONSULTANTS, INC. DOES NOT GUARANTEE THE ACCURACY OR COMPLETENESS OF THESE RECORDS.

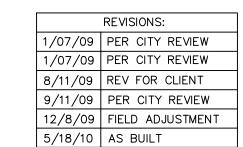

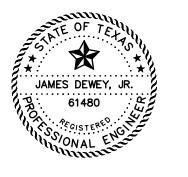

STORM DRAIN PROFILE AND DETAILS PAVING AND DRAINAGE IMPROVEMENTS


15841 ADDISON ROAD ADDISON AIRPORT ADDISON, TEXAS

ENGINEERS AND CONSULTANTS TSBPE REGISTRATION NUMBER F-8527 ENGINEERS • SURVEYORS • LAND PLANNERS

2500 Texas Drive Suite 100 Irving, Texas 75062 Tel 972-252-5357 Fax 972-252-8958

DATE: DEC. 2, 2008 DRAWN BY: SAS SHEET NO. C5 of 7

SCALE: 1"=20'H, 1"=2V CHECKED BY:

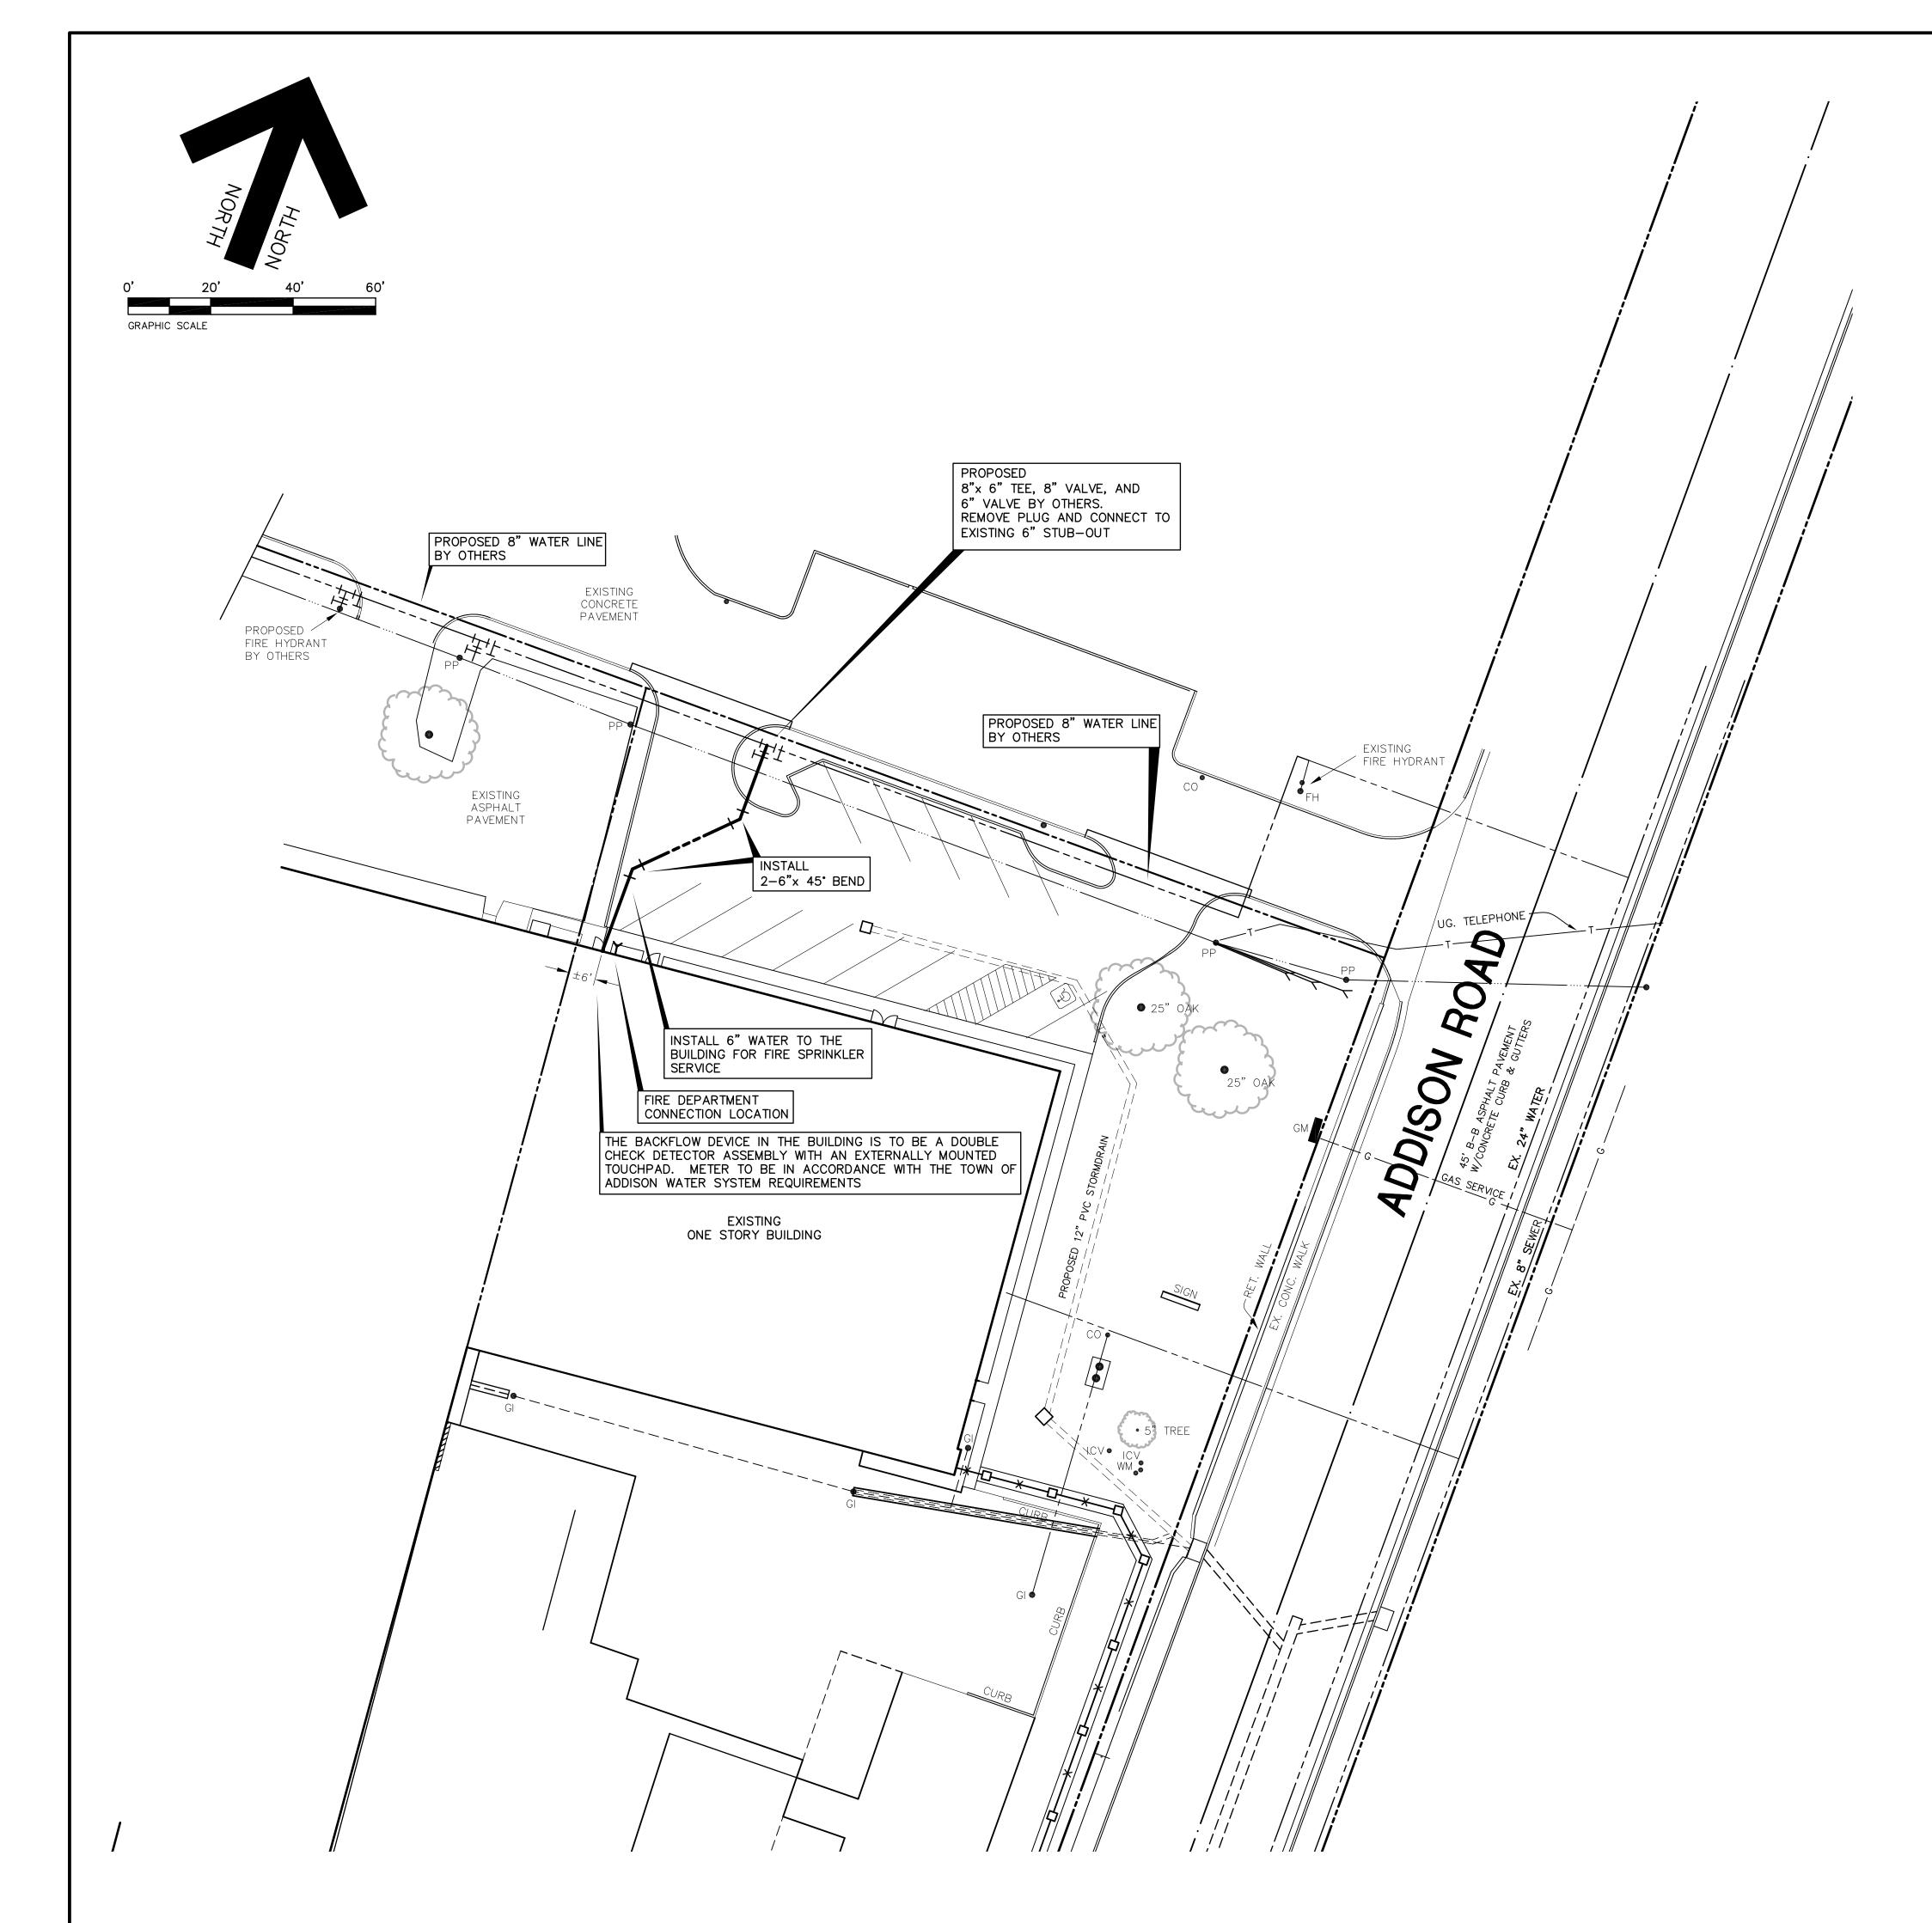

GENERAL NOTES:

1. ALL CONSTRUCTION SHALL BE DONE IN STRICT CONFORMANCE TO THESE PLANS AND ALL APPLICABLE MUNICIPAL CODES AND STANDARDS.

2. THE CONTRACTOR SHALL MAKE APPLICATION FOR SERVICES, OBTAIN ALL PERMITS, AND PAY ALL CHARGES, FEES, AND CONNECTION COSTS REQUIRED FOR EACH UTILITY SERVICE. (THESE COSTS AND FEES SHALL NOT BE INCLUDED IN THE BASE BID).

3. SEE PLUMBING PLANS FOR EXACT LOCATIONS AND DETAILS OF SERVICES INTO BUILDING.

4. CONTRACTOR TO VERIFY THE LOCATION AND DEPTH OF ALL EXISTING UTILITIES PRIOR TO CONSTRUCTION.

5. ANY EXISTING WATER SERVICE LINES OR IRRIGATION SYSTEM IN CONFLICT WITH PROPOSED CONSTRUCTION OR DAMAGED DURING CONSTRUCTION TO BE REPLACED BY CONTRACTOR.

6. ALL WATER MAINS SHALL BE AWWA C909 PVC WATER PIPE.

7. ALL WATER MAINS SHALL HAVE A MINIMUM COVER AS FOLLOWS: 48" BELOW FINISHED STREET GRADE OR 60" DEPTH IN UNIMPROVED AREAS OR AS REQUIRED TO CLEAR OTHER UTILITIES.

8. CONTRACTOR SHALL COORDINATE ALL TAPS TO EXISTING WATER MAINS WITH CITY INSPECTOR TO MINIMIZE DISRUPTION TO WATER SERVICE.

9. CONTRACTOR SHALL COORDINATE EXCAVATION AROUND POWER POLES AND GUY-WIRES WITH POWER COMPANY.

10. THE BACKFLOW DEVICE IN THE BUILDING IS TO BE A DOUBLE CHECK DETECTOR ASSEMBLY WITH AN EXTERNALLY MOUNTED TOUCHPAD. METER TO BE IN ACCORDANCE WITH THE TOWN OF ADDISON WATER SYSTEM REQUIREMENTS

EXISTING UTILITIES NOTES:

1. THE LOCATION OF ALL UNDERGROUND FACILITIES AS INDICATED ON THE PLANS ARE TAKEN FROM PUBLIC RECORDS. JDJR ENGINEERS & CONSULTANTS ASSUMES NO RESPONSIBILITY FOR THE ACCURACY OF SUCH RECORDS AND DOES NOT GUARANTEE THAT ALL UNDERGROUND UTILITIES ARE SHOWN OR ARE LOCATED PRECISELY AS INDICATED.

2. IT IS THE RESPONSIBILITY OF THE CONTRACTOR TO MAKE ARRANGEMENTS WITH THE OWNERS OF SUCH UNDERGROUND FACILITIES PRIOR TO WORKING IN THE AREA TO CONFIRM THEIR EXACT LOCATION AND TO DETERMINE WHEATHER ANY ADDITIONAL FACILITIES OTHER THAN THOSE SHOWN ON THE PLANS MAY BE PRESENT.

3. THE CONTRACTOR SHALL PRESERVE AND PROTECT ALL UNDERGROUND FACILITIES FOUND.

4. NOTIFY JDJR ENGINEERS & CONSULTANTS IF ANY UNDERGROUND UTILITIES ARE NOT IN THE LOCATIONS INDICATED ON THESE PLANS (HORIZONTALY AND VERTICALY) OR CONFLICT WITH ANY PROPOSED IMPROVEMENTS ASSOCIATED WITH THESE PLANS.

5. ANY EXISTING UTILITY APPERTUNANCES (MH, VALVES, METER BOXES, ETC.) TO BE ADJUSTED TO MATCH THE PROPOSED FINISHED GRADES AS INDICATED ON THESE PLANS. NOTIFY JDJR ENGINEERS & CONSULTANTS, INC. IF THERE IS A PROBLEM MAKING SAID ADJUSTMENTS.

> **REVISIONS:** 1/07/09 | PER CITY REVIEW 1/29/09 PER CITY REVIEW 8/11/09 REV FOR CLIENT 9/11/09 PER CITY REVIEW 5/18/10 AS BUILT



"AS-BUILT" THIS AS-BUILT DRAWING IS BASED ON INFORMATION OBTAINED FROM BUILDING CONTRACTORS DURING CONSTRUCTION AS PROVIDED TO JDJR ENGINEERS & CONSULTANTS, INC..

JDJR ENGINEERS & CONSULTANTS, INC. DOES NOT GUARANTEE THE ACCURACY OR COMPLETENESS OF THESE RECORDS.

BENCH MARK: SQUARE CUT FOUND C.L. OF CURB INLET WEST SIDE OF ADDISON ROAD, 75' SOUTH OF THE C.L. OF AIRPORT PRKWY.

ELEVATION 642.51

SITE TBM: X-CUT SET IN CONCRETE WALK ± 38 ' NORTH OF THE NORTHEAST CORNER OF THIS TRACT.

ELEVATION 642.86


FIRE SPRINKLER SERVICE PLAN PAVING AND DRAINAGE IMPROVEMENTS

15841 ADDISON ROAD ADDISON AIRPORT ADDISON, TEXAS

ENGINEERS AND CONSULTANTS TSBPE REGISTRATION NUMBER F-8527

ENGINEERS • SURVEYORS • LAND PLANNERS 2500 Texas Drive Suite 100 Irving, Texas 75062 Tel 972-252-5357 Fax 972-252-8958

DEC. 2, 2008 DRAWN BY: SCALE: 1" = 20'

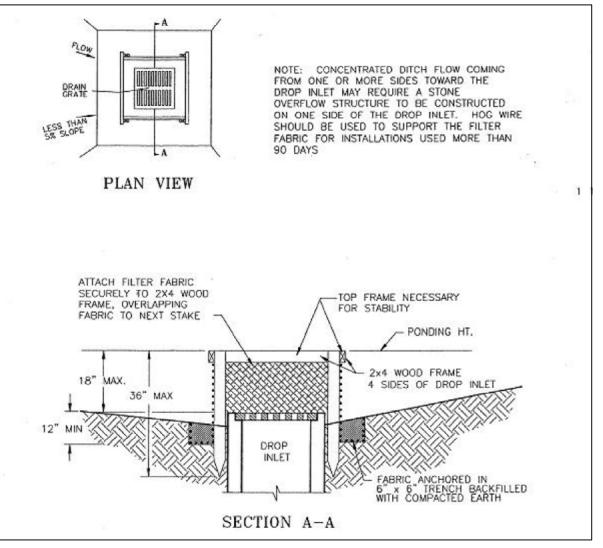

1. SILT FENCE SOULD BE CONSTRUCTED SURROUNDING INLET AS INLETS ARE CONSTRUCTED AND MAINTAINED UNTIL AREAS DRAINING TO THE INLET ARE ESTABLISHED WITH VEGETATION OR ARE


. FOR INLETS IN PAVED AREAS, 10" DIAAMETER STRAW WATTLES SHOULD BE INSTALLED IN A CONTINOUS RING AROUND THE INLET AFTER PAVEMENT IS POURED. STRAW WATTLES AS DISTRIBUTED BY: HANEY GEO COMPONENTS, P.O. BOX 535547, GRAND PRAIRIE, TX, PHONE: 469-523-0444, OR APPROVED EQUAL.

INLET CONTROL DETAIL

GENERAL NOTES:

- 1. THE GENERAL CONTRACTOR AND OWNER RESPONSIBLE FOR PREVENTING SEDIMENT AND OTHER POLLUTANTS FROM LEAVING THE SITE. CARE SHALL BE EXERCISED TO PREVENT THE FLOW OR OFF-SITE TRACKING OF SEDIMENT AND OTHER POLLUTANTS TO ADJACENT PAVED DRIVEWAYS, ROADWAYS, INLETS AND STORM DRAIN SYSTEM.
- 2. ALL LOCATIONS USED AS AN EXIT MUST HAVE ROCK STABILIZATION 50' MINIMUM LENGTH, 3" DIAMETER STONE OVER GEOTEXTILE FABRIC.
- 3. THE STABILIZED CONSTRUCTION ENTRY/EXIT SHALL BE USED AS A WHEEL WASH AREA FOR ALL TRUCKS LEAVING THE SITE.
- 4. A BERM OR OTHER SPILL PROTECTION MEASURE SHALL BE CONSTRUCTED FOR ANY TEMPORARY FUEL STORAGE TANKS ON SITE DURING CONSTRUCTION.
- 5. ALL TRASH SHALL BE CONTAINED IN AN ENCLOSURE UNTIL PROPER DISPOSAL AT OFF-SITE FACILITIES.
- 6. VEHICLE PARKING AREAS, STAGING AREAS, STOCKPILES, SPOILS, ETC. SHALL BE LOCATED SUCH THAT THEY WILL NOT ADVERSELY AFFECT STORM WATER QUALITY. OTHERWISE, COVERING OR ENCIRCLING THE AREAS WITH PROTECTIVE MEASURES SHALL BE NECESSARY.
- 7. A DENSITY OF TEMPORARY OR PERMANENT GROUND COVER (I.E., VEGETATION, EROSION CONTROL, MATTING, ETC.) SUFFICIENT TO PREVENT EROSION SHALL BE ESTABLISHED ON ALL SWALES AND SLOPES IN A TIMELY MANNER IN ORDER TO PREVENT EROSION PROBLEMS FROM DEVELOPING IN THESE AREAS.
- 8. ALL SURFACE AREAS DISTURBED WITHIN OR ADJACENT TO THE CONSTRUCTION LIMITS MUST BE PERMANENTLY STABILIZED. STABILIZATION IS OBTAINED WHEN THE SITE IS COVERED WITH IMPERVIOUS STRUCTURES, PAVING OR A UNIFORM PERENNIAL VEGETATIVE COVER. THE PERENNIAL VEGETATION MUST HAVE A COVERAGE DENSITY OF AT LEAST 70 PERCENT. STABILIZATION IS REQUIRED BEFORE TERMINATING MAINTENANCE AND REMOVAL OF EROSION CONTROL MEASURES.
- 9. ALL PERIMETER EROSION CONTROL MEASURES AND A ROCK STABILIZED ENTRY/EXIT MUST BE IN PLACE BEFORE STARTING SOIL DISTURBING ACTIVITIES.
- 10. EROSION CONTROL MEASURES THAT PROVE TO BE INEFFECTIVE SHALL BE REPLACED WITH MORE EFFECTIVE MEASURES OR ADDITIONAL MEASURES.
- 11. A MAINTENANCE PROGRAM FOR ALL PROPOSED EROSION CONTROL MEASURES SHALL BE ESTABLISHED.
- 12. TO PREVENT ENTRY OF SEDIMENT INTO PROPOSED STORM SEWERS DURING CONSTRUCTION, INSTALL PIPE SEDIMENT FILTER OR SEDIMENT FILTER OR SEDIMENT BARRIER AT THE END OF EACH WORK DAY.
- 13. CONTRACTOR TO CONSTRUCT A PIT OR WASH BASIN ON-SITE FOR WASH-OUT OF CONCRETE TRUCKS.
- 14. IF PUMPS ARE USED TO REMOVE WATER FROM PONDED AREAS, FILTER THE DISCHARGE TO REMOVE SEDIMENT AND OTHER POLLUTANTS BEFORE THE WATER LEAVES THE SITE OR ENTERS STORM DRAIN SYSTEM. DO NOT BYPASS SILT BARRIERS OR INLET SEDIMENT FILTERS WITH THE DISCHARGE.
- 15. TO PREVENT DAMAGE TO VEGETATION IN DOWNSTREAM WATER COURSES, LIMIT ANY PROPOSED LIME STABILIZATION OPERATIONS TO THAT WHICH CAN BE MIXED AND COMPACTED BY THE END OF EACH WORK DAY. A SILT FENCE IS NOT EFFECTIVE IN FILTERING LIME SINCE THE GRAIN SIZE IS SIGNIFICANTLY SMALLER THAN THE OPENING IN THE FABRIC.
- 16. THE CONTRACTOR(S) SHALL INSPECT EROSION CONTROL MEASURES AT LEAST ONCE EACH WEEK AND WITHIN 24 HOURS AFTER A STORM EVENT OF 1/2 INCH OR GREATER. REPAIR OR REPLACE DAMAGED MEASURES AS NECESSARY TO RETAIN SEDIMENT ON SITE. EROSION CONTROL MEASURES THAT PROVE TO BE INEFFECTIVE SHALL BE REPLACED WITH MORE EFFECTIVE MEASURES OR ADDITIONAL MEASURES WITHIN SEVEN (7) CALENDAR DAYS.
- 17. FOR ALTERNATIVE STABILIZATION AND EROSION CONTROL MEASURES, REFER TO THE CONSTRUCTION BEST MANAGEMENT PRACTICES (BMP) MANUAL PUBLISHED BY NORTH CENTRAL TEXAS COUNCIL OF GOVERNMENTS.
- 18. CONTRACTOR TO CHECK AREAS ADJACENT TO PROPERTY DAILY FOR CONSTRUCTION WASTE MATERIALS AND DEBRIS THAT HAVE BLOWN OR WASHED OFF-SITE AND REMOVE IMMEDIATELY.
- 19. CONTAIN ALL RUNOFF FROM MATERIALS USED IN THE SUBGRADE STABILIZATION PROCESS.

"AS-BUILT" THIS AS-BUILT DRAWING IS BASED ON INFORMATION OBTAINED FROM BUILDING CONTRACTORS DURING CONSTRUCTION AS PROVIDED TO JDJR ENGINEERS & CONSULTANTS, INC. JDJR ENGINEERS & CONSULTANTS, INC. DOES NOT GUARANTEE THE ACCURACY OR COMPLETENESS OF THESE RECORDS.

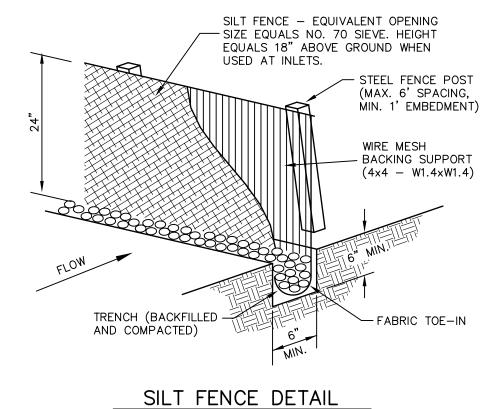

SILT FENCE NOTES:

STEEL POSTS WHICH SUPPORT THE SILT FENCE SHALL BE INSTALLED ON A SLIGHT ANGLE TOWARD THE ANTICIPATED RUNOFF SOURCE. POST MUST BE

SIDE TO PREVENT FLOW UNDER FENCE.

EMBEDDED A MINIMUM OF ONE FOOT. 2. THE TOE OF THE SILT FENCE SHALL BE TRENCHED IN WITH A SPADE OR MECHANICAL TRENCHER, SO THAT THE DOWNSLOPE FACE OF THE TRENCH IS FLAT FENCE CANNOT BE TRENCHED IN (e.g. PAVEMENT), WEIGHT FABRIC FLAP WITH WASHED GRAVEL ON UPHILL

WIDE TO ALLOW FOR THE SILT FENCE FABRIC TO BE LAID IN THE GROUND AND BACKFILLED WITH COMPACTED EACH STEEL SUPPORT POST OR WOVEN WIRE, WHICH IS IN TURN ATTACHED TO THE STEEL FENCE POST.
THERE SHALL BE A 6" OVERLAP, SECURELY FASTENED

THE TRENCH MUST BE A MIN. OF 6" DEEP AND 6

5. INSPECTION SHALL BE MADE WEEKLY OR AFTER EACH RAINFALL, REPAIR OR REPLACEMENT SHALL BE MADE PROMPTLY AS NEEDED. 6. SILT FENCE SHALL BE REMOVED WHEN THE SITE IS COMPLETELY STABILIZED SO AS NOT TO BLOCK OR

EMPEDE STORM FLOW OR DRAINAGE. 7. ACCUMULATED SILT SHALL BE REMOVED WHEN IT

REACHES A DEPTH OF 6". THE SILT SHALL BE DISPOSE OF IN AN APPROVED SITE AND IN SUCH A MANNER AS TO NOT CONTRIBUTE TO ADDITIONAL SILTATION.


LEGEND

——545—— **EXISTING CONTOUR LINE**


PROPOSED SILT FENCE



INLET CONTROL SILT FENCE CONSTRUCTED CONTINUOUSLY AROUND INLET.

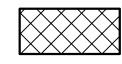

PROPOSED STABILIZED CONSTRUCTION ENTRANCE

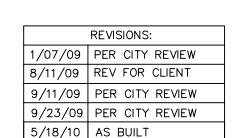



SHEET TITLE:

EROSION CONTROL PLAN

PAVING AND DRAINAGE IMPROVEMENTS 15841 ADDISON ROAD ADDISON AIRPORT ADDISON, TEXAS




SCALE:

ENGINEERS AND CONSULTANTS TSBPE REGISTRATION NUMBER F-8527 ENGINEERS • SURVEYORS • LAND PLANNERS

2500 Texas Drive Suite 100 Irving, Texas 75062 Tel 972-252-5357 Fax 972-252-8958

DEC. 2, 2008 DRAWN BY: CHECKED BY: 1" = 30'

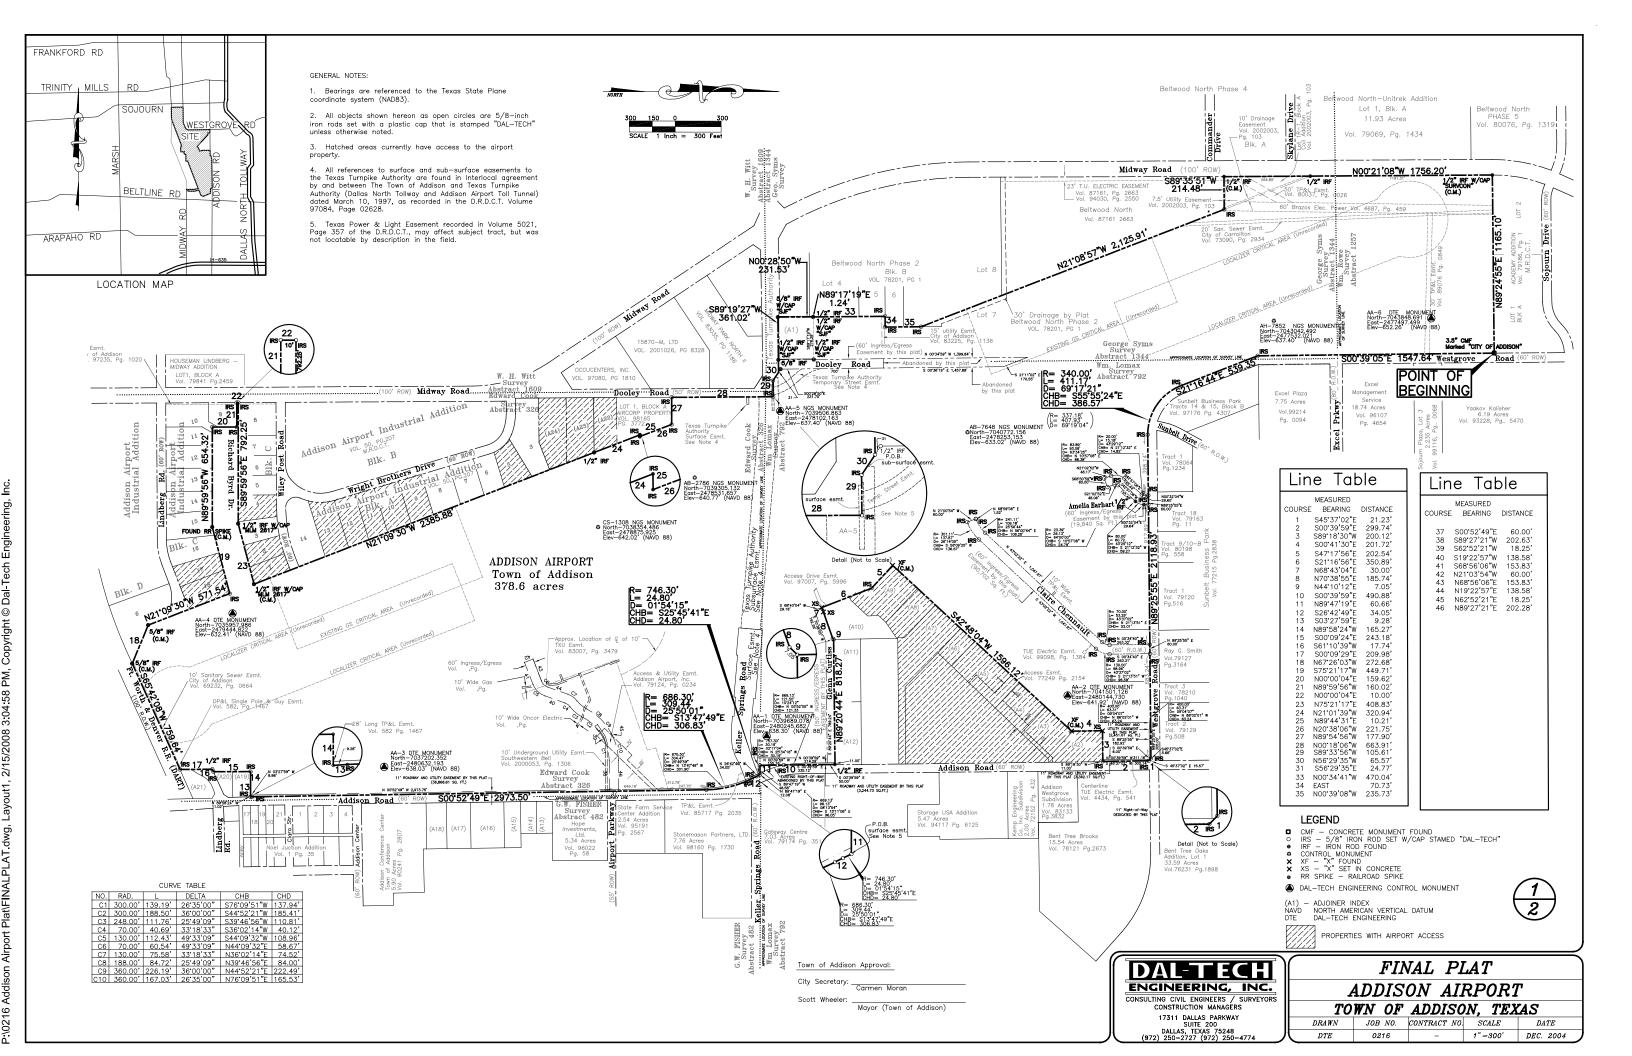

Index	Owner	Vol.	Page
A1	Texas Turnpike Authority	96197	4724
A2	Texas Federal Subdivision, No.2	79039	133
A3	Blakely Airport Addition	84088	4359
A4	Van-Hoff Subdivision	79122	1831
A5	Aweco Subdivision	79136	2610
A6	Replat Aweco Subdivision	97093	2846
A7	Personal Way Aviation Addison	90241	2840
A8	Hangin' Out L.L.C	98245	3525
A9	Airport Land Development Subdivision	79078	1702
A10	1.950-acre Wolfe Subdivision	84108	3030
A11	Airport Plaza	85070	2982
A12	Addison Storage Addition	99018	78
A13	Eleanor W. Dedmon Marital Trust No. 1	98004	3173
A14	Tom J. Shepherd et ux Sandra D. Shepherd	92229	4451
A15	Crossroads Aviation Inc.	67044	213
A16	D.A. Cody	71165	2799
A17	Barco Mirror & Glass	79020	875
A18	General Public	83083	1059
A19	Town of Addison	97247	4072
A20	White Rock Masonic Lodge #234	3981	416
A21	George P. Kondos and Čarol C. Kondos	91084	2102
A22	15800 Dooley Road Ltd.	2000039	4255
A23	John-Mac Joint Venture	82001	4089
A24	Midway Road Condo's.	81115	0016

Control Monument

(NAD 8	3, TEXAS	NORTH	CENTRA	_ L – 4202)
North 703968 704150 703720 703595 703950 704384	39.078 2 01.126 2 02.352 2 57.986 2 06.863 2	Tast 2480245. 2480144. 2480632. 2479444. 2478102.	.682 .730 .193 .822	Elevation 638.30 641.92 638.03 632.41 637.40	Desc. AA-1 AA-2 AA-3 AA-4 AA-5 AA-6
703930 704077 704304 703835	72.156 2 12.492 2	478531. 478253. 477532. 478875.	.153 .021	633.02	AB278 AB764 AH785 CS130

Parent Iracts

Conner: City of Addison
Address: 15333 Addison Road City of Addison, Texas
Legal Description: Being all the certain tract of land 373.332 acres, more or
less, out of the Edward Cook Survey Abstract 326, the William Lomar Survey
Abstract 792, the George Syms Survey Abstract 1344, the William Rowe Survey
Abstract 1257, Lot 1 R-1, Block A of Coil Addition, Vol. 2002003, Pg. 130,
Dallas County, Texas, and part of Lot 1 and Lot 2 of Block "A" of The Carroll
Estates Addition, Volume 10 Page 473, Dallas County, Texas

Grantor: Ray V. Ki Grantor: Ray V. Kincaid, Jr. Grantee: Town of Addison

Grantee: City of Addison WD Vol.77010 Pg. 1391

Grantor: W. H. Laffity Grantee: City of Addison Judgment Cause# 80-1894-D Vol.91079 Pg.2687

Grantor: Beltwood North Joint Venture, et al

Grantor: Bob Chester and William F. Chester Grantee: City of Addison Vol.98015 Pg.2143 Re: Chester Addition Vol.84216 Pg.3066

Grantor: Protecta—Cab, Inc. Grantee: Town of Addison Vol.97217 Pg.1350

Grantor : Charles Cayce, Independent Executor of the Estate of William L. Gray and Independent Executor of the Estate of Kathy L. Gray Crontee: Town of Addison, Texas Vol. 2003105, Pg. 11725

Re: Lot 1R-1, Block A, Coil Addition, Vol. 2002003, Pg. 103

Vol. 2003105 Pg. 1991

Re: 1/4th Interest

Vol. 2003105, Pg. 11725

Grantor: Annie Ruth Harg Crontee: City of Addison Vol. 2002003, Pg. 103

Vol. 2003105 Pg. 1991

Re: 1/4th Interest

Vol. 2003105 Pg. 1993

Vol. 2003105 Pg. 1991

Grantor: North Texas Tollway Authority Grantee: Town of Addison Vol. 2002150, Pg. 10404

Grantor: Donnell Jones, et al Grantee: City of Addison Vol.81150 Pg.1993 Grantor: Annie Ruth Harge, et al

Vol.99155 Pg.2291 Re: Kincaid Addition Vol.84087 Pg.0048

Grantor: George Marko, Trustee, et al

Grantor: Bobbie L. Odom, et al Grantee: City of Addison Vol.81150 Pg.1985 Re: 1/4th Interest

Grantee: Town of Addison Vol.99249 Pg.5436 Re; Mullins Addition Vol.85157 Pg.4674 and Barnett Addition Vol.85160 Pg.1680

Grantee: Town of Addison Vol.99078 Pg.1254 Re: a portion of Aircorp Property Addition Vol.98165 Pg.3772

Grantor: Billy Joe Mullins, Jr.

Re: 1/4th Interest Grantor: Oswald Coleman, et al

Grantee: City of Addison Vol.81150 Pg.1989 Re: 1/4th Interest

That the TOWN OF ADDISON ("Owner") does hereby adopt this plat designating the hereinabove property as ADDISON AIRPORT ADDITION, on addition to the Town of Addison, Texas, and, subject to the conditions, restrictions and reserval stated hereinafter, owner dedicates to the public use forever the streets and alleys shown thereon.

The easements shown on this plat are hereby reserved for the purposes as indicated, including, but not limited to, the installation and maintenance of water, sanitary sewer, storm sewer, drainage, electric, telephone, gas and cable television. Owner shall have the right to use these easements, provided however, that it does not unreasonably interfere or impede with the provision of the services to others. Soid utility easements are hereby being eserved by mutual use and accommodation of all public utilities using or desiring to use the same. An express easement of ingress and egress is hereby expressly granted on, over and across all such easements for the benefit of the provider of services for which easements are granted.

easements are 'granted.

Any drainage and floodway easement shown hereon is hereby dedicated to the public's use forever, but including the following covenants with regards to maintenance responsibilities. The existing channels or creeks traversing the drainage and floodway easement will remain as an open channel, unless required to be enclosed by ordinance, at all times and shall be maintained by the individual owners of the lot or lots that are traversed by or adjacent to the drainage and floodway easement. The City will not be responsible for the maintenance and operation of said creek or creeks or for any damage or injury of private property or person that results from the flow of water along said creek, or for any damage or injury of private property or person that results from the flow of water along said creek, or for any damage or injury of private property or person that results from the flow of water along said creek, or for the control of erosion. No obstruction to the natural flow of water run—off shall be permitted by construction of any type building, fence or any other structure within the drainage and floodway easement. Provided, however, it is understood that in the event it becomes necessary for the City to channelize or consider erecting any type of drainage structure in order to improve the storm drainage, then in such event, the City shall have the right, but not the obligation, to net upon the drainage and floodway easement at any point, or points, with all rights of ingress and egress to investigate, survey, erect, construct or maintain any drainage channels and creeks traversing the drainage and floodway easement adjacent to his property clean and free of debris, silt, growth, vegetation, weaks, rubbish, refuse matter and any substance which would result in unsanitary conditions or obstruct the flow of water, and the City shall have the right of ingress and egress for the purpose of inspection and supervision and maintenance work by the property owner to alleviate any undesirable conditi of each lot shall be shown on the plat

The maintenance or paying of the utility and fire lane easements is the responsibility of the property owner. All public The maintenance or paving of the utility and fire lane easements is the responsibility of the property owner. All public utilities shall at all times have the full right of ingress and egress to and from and upon the said utility easements for the purpose of constructing, reconstructing, inspecting, patrolling, maintaining and adding to or removing all or parts of its respective system without the necessity at any time of procuring the permission of anyone. Any public utility shall have the right of ingress and egress to private property for the purpose of reading meters and any maintenance and service required or ordinarily performed by that utility. Buildings, fences, trees, shrubs or other improvements or growth may be constructed, reconstructed or placed upon, over or across the utility easements as shown; provided, however, that owner shall at its sole cost and expense be responsible under any and all circumstances for the maintenance and repair of such improvements or growth, any public utility shall have the right to remove and keep removed all or parts of any buildings, fences, trees, shrubs or other improvements or growth which in any way endanger or interfere with the construction, maintenance or efficiency of its respective system or service.

Water main and sanitary sewer easements shall also include additional area of working space for construction and maintenance of the systems. Additional easement area is also conveyed for installation and maintenance of manholes, cleanouts, fire hydrants, water service and sewer services from the main to curb or pavement line, and the descriptions of such additional easements herein granted shall be determined by their locations as installed.

This plat is approved subject to all platting ordinances, rules, regulations and resolutions of the Town of Addison. Texa

PROPERTY DESCRIPTION

Being a tract of land out of the E. Cook Survey, Abstract No. 326, the William Lomax Survey, Abstract No. 792, the George Syms Survey, Abstract 1344, and the William Rowe Survey, Abstract 1257, and being all of a tract of land described in deed to the City of Addison recorded in Volume 77010, Page 1391 of the Deed Records of Dalias County, Texas (D.R.D.C.T.), all of a tract of land described in Judgment to the City of Addison recorded in Volume 91079, Page 2687, D.R.D.C.T., LOT, Block B of Beltwood North Addition, Phase II, an Addition to the City of Dalias, Texas, according to the map thereof recorded in Volume 8201, Page 0001, D.R.D.C.T., as drescribed in deed to the City of Addison recorded in Volume 98015, Page 2143, D.R.D.C.T., a tract of land described in deed to the Town of Addison recorded in Volume 98015, Page 2143, D.R.D.C.T., a tract of land described in Volume 97217, Page 1350, D.R.D.C.T., Lot T., Block 1, of Kincaid Addition, an Addition to the City of Addison, Dalias County, Texas, according to the Plat thereof recorded in Volume 84087, Page 48, D.R.D.C.T., a tract of land described in deed to the Town of Addison recorded in Volume 99249, Page 5436, D.R.D.C.T., a tract of land described in deed to Volume 99078, Page 1254, D.R.D.C.T., a tract of land described in Deed to the City of Addison recorded in Volume 99249, Page 15450, D.R.D.C.T., a tract of land described in Deed to the City of Addison recorded in Volume 98015, D.R.D.C.T., and a tract of land described in Deed to the City of Addison recorded in Volume 98015, D.R.D.C.T., and a tract of land described in Deed to the City of Addison recorded in Volume 98015, D.R.D.C.T., and a tract of land described in Deed to the City of Addison recorded in Volume 98015, D.R.D.C.T., and a tract of land described in Deed to the City of Addison recorded in Volume 98016, D.R.D.C.T., and a tract of land described in Deed to the City of Addison recorded in Volume 98016, D.R.D.C.T., and a tract of land described in Deed to the City of Addiso

Beginning at a concrete monument found with a 3 1/2 inch disk stamped "City of Addison" lying in the west right-of-way line of Westgrove Road (a 60 foo wide right-of-way) said point being the most northerly northeast corner of said Addison Airport tract and the southeast corner of Lot 1, Block A, Academy Addition, an addition to the City of Carrollton, Dallas County, Texas according to the Plat thereof recorded in Volume 79186, Page 1, D.R.D.C.T.;

THENCE South 00 degrees 39 minutes 05 seconds East, along the west right-of-way line of said Westgrove Road, a distance of 1547.64 feet to a 5/8 inch iron rod set with cap stamped "DAL-TECH";

THENCE South 21 degrees 16 minutes 44 seconds East, continuing along said west right-of-way line of Westgrove Road, a distance of 539.35 feet to a 5/8 inch iron rod set with cap stamped "DAL-TECH";

THENCE along a curve to the left of said Westgrove Road having a radius of 340,00 feet, a central angle of 69 degrees 17 minutes 21 seconds and an arc length of 411.17 feet, being subtended by a chord of South 55 degrees 55 minutes 24 seconds East for a distance of 386.57 feet to a 5/8 inch iron rod set with cap stamped "DAL-TECH"

THENCE North 89 degrees 25 minutes 55 seconds East, along the southerly right-of-way line of Westgrove Road for a distance of 2.118.93 feet to a 5/8 inch iron rod set with cap stamped "DAL-TECH" at the corner clip of said southerly right-of-way line of Westgrove Road and the west right-of-way line of Addison Road (a 60 foot wide right-of-way) line of Addison Road (a 60 foot wide right-of-way).

THENCE South 45 degrees 37 minutes 02 seconds East, along said corner clip, a distance of 21.23 feet to a 5/8 inch iron rod set with cap stamped "DAL—TECH".

THENCE South 00 degrees 39 minutes 59 seconds East, along said west right-of-way line of Addison Road, a distance of 299.74 feet to a 5/8 inch iron rod set with cap stamped "DAL-TECH";

THENCE South 89 degrees 18 minutes 30 seconds West, departing said west right-of-way line of Addison Road, a distance of 200.12 feet set in concrete;

THENCE South 00 degrees 41 minutes 30 seconds East, a distance of 201.72 feet to a found "X";

THENCE South 42 degrees 48 minutes 04 seconds West, a distance of 1,596.12

THENCE South 47 degrees 17 minutes 56 seconds East, a distance of 202.54 feet to a 5/8 inch iron rod set with cap stamped "DAL—TECH";

THENCE South 21 degrees 16 minutes 56 seconds East, a distance of 350.89 feet to a chiseled "X" set in concrete:

THENCE North 68 degrees 43 minutes 04 seconds East, a distance of 30.00

THENCE North 70 degrees 38 minutes 55 seconds East, a distance of 185.74 feet to a 5/8 inch iron rod set with cap stamped "DAL-TECH":

THENCE North 44 degrees 10 minutes 12 seconds East, a distance of 7.05 feet Inclined North 44 degrees to minutes 12 seconds cases, a disance of 7.05 ret to a 5/8 inch iron rod set with cap stamped "DAL-TECH", said point is the common corner between the aforesaid Addison Airport tract and the southwest corner of a tract of land described in deed to 0.J. Broughton and E.E. Ericson recorded in Volume 4350, Page 491 of D.R.D.C.T.;

THENCE North 89 degrees 20 minutes 44 seconds East, along the common line of said Addison Airport tract and the south line of said 0.J. Broughton tract for a distance of 818.27 feet to a 5/8 inch iron rod set with cap stamped "DAL—TECH" in the west right-of-way line of aforesaid Addison Road;

THENCE South 00 degrees 39 minutes 59 seconds East, a distance of 490.88 feet to a 5/8 inch iron rod set with cap stamped "DAL-TECH" in the apparent common survey line between the aforesaid William Lomax Survey, Abstract No. 792 and the aforesaid E. Cook Survey, Abstract No. 326;

THENCE North 89 degrees 47 minutes 19 seconds East, a distance of 60.66 feet to a 1/2 inch iron rod set with cap stamped "DAL—TECH" in the aforesaid west right-of-way line of Addison Road;

THENCE along a curve to the left in the said west right-of-way line of Addison Road, having a radius of 746.30 feet, a central angle of 01 degree 54 minutes 15 seconds and an arc length of 24.80 feet, being subtended by a chord of South 25 degrees 45 minutes 41 seconds East for a distance of 24.80 feet to a 5/8 inch iron rod set with cap stamped "DAL-TECH";

THENCE South 26 degrees 42 minutes 49 seconds East, along said west right-of-way line of Addison Road, a distance of 34.05 feet to a 5/8 inch iron rod set with cap stamped "DAL-TECH";

THENCE along a curve to the right in the said west right-of-way line of Addison Road having a radius of 686.30 feet, a central angle of 25 degrees 50 minutes 01 second and an arc length of 309.44 feet, being subtended by a chord of South 13 degrees 47 minutes 49 seconds East for a distance of 306.83 feet to a 5/8 inch iron rod set with cap stamped "DAL-TECH";

THENCE South 00 degrees 52 minutes 49 seconds East, along said west right—of—way line of Addison Road, a distance of 2,973.50 feet to a 5/8 inch iron rod set with cap stamped "DAL—TECH";

THENCE South 03 degrees 27 minutes 59 seconds East, along said west right-of-way line of Addison Road, a distance of 9.28 feet to a 5/8 inch iron rod set with cap stamped "DAL-TECH";

THENCE North 89 degrees 58 minutes 24 seconds West departing said west right-of-way line of Addison Road, a distance of 165.27 feet to a 5/8 inch iron rod set with cap stamped "DAL-TECH";

THENCE South 00 degrees 09 minutes 24 seconds East, a distance of 243.18 feet to a 5/8 inch iron rod set with cap stamped "DAL-TECH"

THENCE South 61 degrees 10 minutes 39 seconds West, a distance of 17.74 feet to a 1/2 inch iron rod found:

THENCE South 00 degrees 09 minutes 29 seconds East, a distance of 209.98 feet to a 5/8 inch iron rod set with cap stamped "DAL—TECH" in the north right—of—way line of the Fort Worth and Denver Railroad spur;

THENCE South 65 degrees 42 minutes 08 seconds West, glong said north ight-of-way line of said Forth Worth and Denver Railroad sour, a distance of right—oft—way line of Sala Fofth worth and between namious span, a discounce of 59.6 inch iron rod found at the most easterly corner of the Addison Airport Industrial District, an Addition to the City of Addison according the plat thereof recorded in Volume 50, Page 207, D.R.D.C.T.;

THENCE North 67 degrees 26 minutes 03 seconds West, along the said easterly line of Addison Airport Industrial District addition, a distance of 272.68 feet to a

THENCE North 21 degrees 09 minutes 30 seconds West, along the said easterly line of Addison Airport Industrial District addition, a distance of 571.54 feet to a 5/8 inch iron rod set with cap stamped "DAL—TECH";

THENCE South 75 degrees 21 minutes 17 seconds West, a distance of 449.71 feet to a found railroad spike:

THENCE North 89 degrees 59 minutes 56 seconds West, a distance of 654.32 feet to a 5/8 inch iron rod set with cap stamped "DAL-TECH";

THENCE North 00 degrees 00 minutes 04 seconds East, a distance of 159.62 feet to a 5/8 inch iron rod set with cap stamped "DAL—TECH";

feet to a 5/8 inch iron rod set with cap stamped "DAL—TECH" in the east right—of—way line of Midway Road (a 100 foot wide right—of—way);

THENCE North 00 degrees 00 minutes 04 seconds East, along said east ight-of-way line of Midway Road, a distance of 10.00 feet to a 5/8 inch iron od set with cap stamped "DAL-TECH";

THENCE South 89 degrees 59 minutes 56 seconds East, a distance of 792.25 feet to a 1/2 inch iron rod found with cap stamped "MLM #2617;

THENCE North 75 degrees 21 minutes 17 seconds East, a distance of 408.83 feet to a 1/2 inch iron rod found with cap stamped "MLM #2617;

THENCE North 21 degrees 09 minutes 30 seconds West, along the aforesaid 2.385.88 feet record to a 1/2 inch iron rod found;

THENCE North 21 degrees 01 minute 39 seconds West, a distance of 320.94 feet to a 5/8 inch iron rod set with cap stamped "DAL-TECH"

THENCE North 89 degrees 44 minutes 31 seconds East, a distance of 10.21 feet to a 5/8 inch iron rod set with cap stamped "DAL-TECH"

THENCE North 20 degrees 38 minutes 06 seconds West, a distance of 221.75 feet to a 5/8 inch iron rod set with cap stamped "DAL-TECH";

THENCE North 89 degrees 54 minutes 56 seconds West, a distance of 177.90 feet to a 5/8 inch iron rod set with cap stamped "DAL—TECH" in the east right—of—way line of Dooley Road (a 50 foot wide right—of—way)

THENCE North 00 degrees 18 minutes 06 seconds West, along the said east right—of—way line of Dooley Road, a distance of 663.91 feet to a 5/8 inch iron rod set with cap stamped "DAL—TECH" for the apparent intersection of said east right—of-way line of Dooley Road and the north right—of-way line of the old Keller Springs Road (a 50 foot wide right—of-way);

THENCE South 89 degrees 33 minutes 56 seconds West, with the said north line of Keller Springs Road, a distance of 105.61 feet to a 5/8 inch iron rod se with cap stamped "DAL-TECH";

THENCE North 56 degrees 29 minutes 35 seconds West, a distance of 65.57 feet to a 5/8 inch iron rod set with cap stamped "DAL—TECH" in the aforesaid east right—of—way line of Dooley Road (a 60 foot wide right—of—way);

THENCE South 89 degrees 19 minutes 27 seconds West, a distance of 361.02

THENCE North 00 degrees 28 minutes 50 seconds West, a distance of 231.53 feet to a 1/2 inch iron rod found;

THENCE North 89 degrees 17 minutes 19 seconds East, a distance of 1.24 feet to a 1/2 inch iron rod found with cap stamped SJ&F

THENCE North 00 degrees 34 minutes 41 seconds West, a distance of 470.04 feet to a 5/8 inch iron rod set with cap stamped "DAL—TECH" in the east line of Beltwood North Phase 2, an addition to the City of Dallas, Texas, according to the Plat thereof recorded in Volume 78201, Page 1, D.R.D.C.T.;

THENCE East, a distance of 70.73 feet along said Beltwood North Phase 2addition to a 5/8 inch iron rod set with cap stamped "DAL-TECH"

THENCE North 00 degrees 39 minutes 08 seconds West, along said Beltwood North Phase 2 addition, a distance of 235.73 feet to a 5/8 inch iron rod set with ap stamped "DAL-TECH" for the most southerly corner of Lot 7 of said Beltwood North Phase 2 addition;

THENCE North 21 degrees 08 minutes 57 seconds West, passing the north line of said Beltwood North Phase 2 addition at a called distance of 576.04 feet of said Beltwood North Phase 2 addition at a called distance of 5.76.04 feet and continuing on for a total distance of 2,125.91 feet to a 5/8 inch iron rod set with cap stamped "DAL—TECH" for the northeast corner of Beltwood North Addition, according to the plat thereof recorded in Volume 78201, Page 1, D.R.D.C.T., same being the southeast corner of Lot 1R-1, Block A, Coil Addition, according to the plat thereof recorded in Volume 2002003, Page 103, D.R.D.C.T.;

THENCE South 89 degrees 35 minutes 51 seconds West, along the common line between the north line of said Beltwood Addition and the south line of said Coil Addition, a distance of 214.48 feet to a 1/2 inch iron rod found in the east right-of-way line of Midway Road (a 100 foot wide right-of-way);

THENCE North 00 degrees 21 minutes 08 seconds West, along said east right-of-way line of Midway Road, passing a 1/2 inch iron rod found for the North corner of said Lot 1R-1, Block A, at a distance of 564.89 feet and continuing for a total distance of 1.756.20 feet to a 1/2 inch iron rod found with cap stamped "SURVCON":

THENCE North 89 degrees 24 minutes 55 seconds East, a distance of 1,165.10 feet to the POINT OF BEGINNING and CONTAINING 16,492,399 square foot or; 378.6 acres of land, more or less.

l, Alan Moore, a Registered Professional Land Surveyor in the State of Texas, do herby certify that I prepared this Plat from an actual survey of the land under my supervision in accordance with the "Minimum Standards of Practice" approved by the Texas Board of Professional Land Surveyors.

DTE

Alan Moore, RPLS No. 5537



Town of Addison Approval:

City Secretary: _____Carmen Moran

DAL-TECH ENGINEERING, INC. CONSULTING CIVIL ENGINEERS / SURVEYORS CONSTRUCTION MANAGERS

17311 DALLAS PARKWAY SUITE 200 DALLAS, TEXAS 75248 (972) 250-2727 (972) 250-4774

FINAL PLAT ADDISON AIRPORT TOWN OF ADDISON, TEXAS DRAWN JOB NO. CONTRACT NO. SCALE DATE

0216 - 1"=300' DEC. 2004