



REF. 1.106 FOR EXPANSION JOINT LOCATIONS  
 NOTE: JOINT FILLER SHALL BE HOT OR COLD AT CONTRACTORS OPTION

PROVIDE #6 AT 18" O.C. SET IN 7/8" DIA. HOLES x 8" LONG FILLED WITH EPOXY GEL. APPLY BONDING AGENT TO EXISTING CONCRETE PAVEMENT BEFORE POURING NEW PAVEMENT, OR SAW CUT AND EXPOSE 3/8 BAR DIAMETERS OF EXISTING REINFORCING STEEL AND LAP NEW REINFORCING STEEL.

CURB DETAIL SCALE: 1 1/2"=1'-0" 103

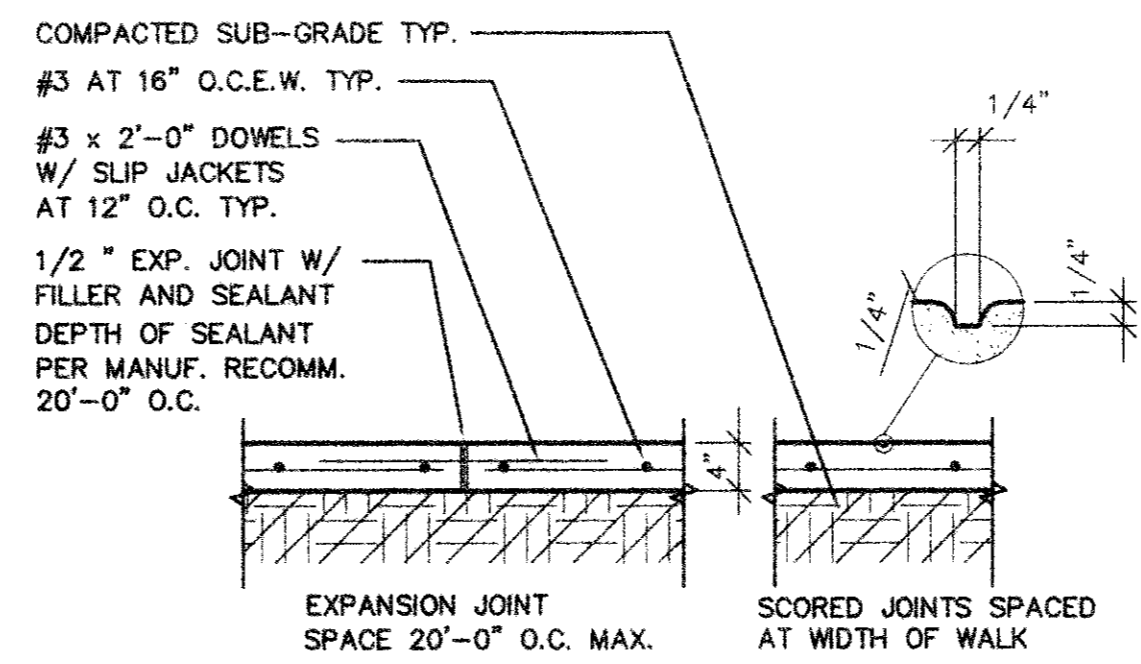


CONC. WALK SCALE: 3/4"=1'-0" 104

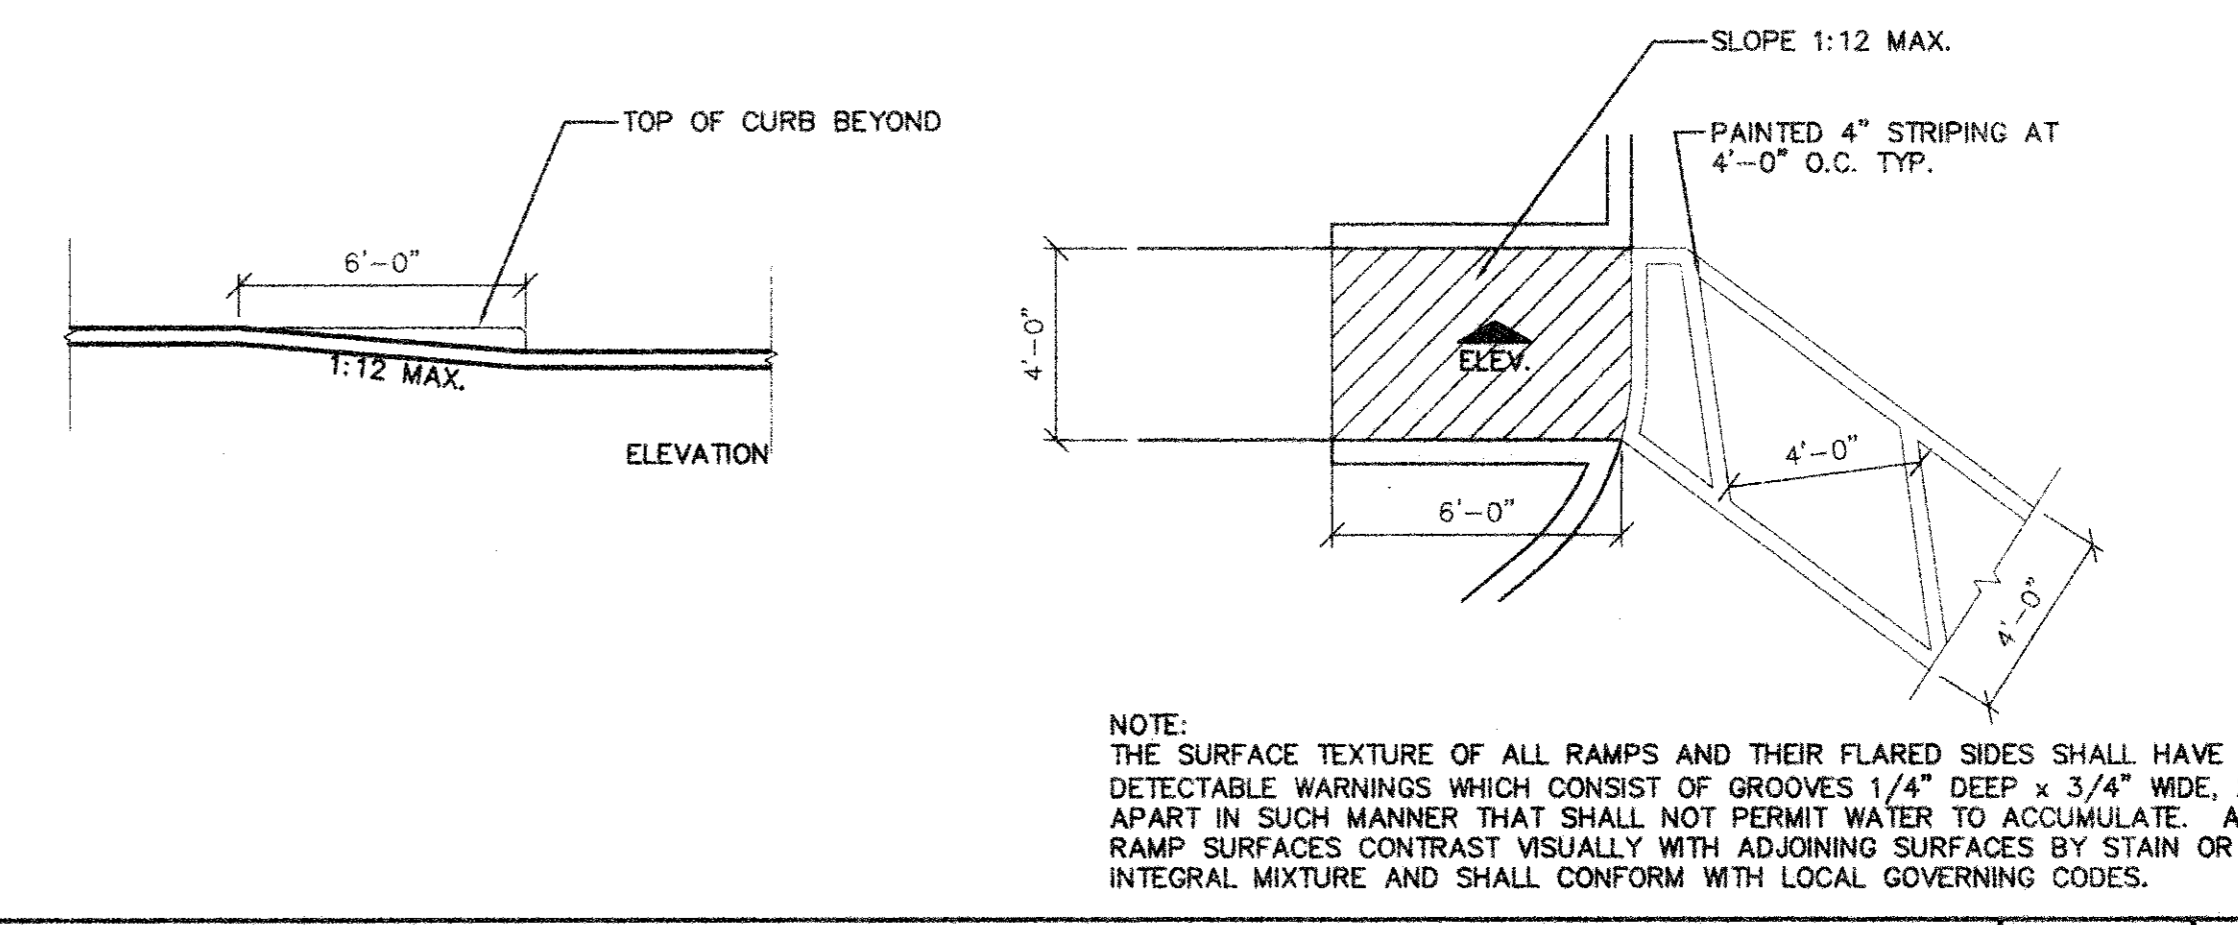

NOTE: THE SURFACE TEXTURE OF ALL RAMPS AND THEIR FLARED SIDES SHALL HAVE DETECTABLE WARNINGS WHICH CONSIST OF GROOVES 1/4" DEEP x 3/4" WIDE, 2" APART IN SUCH MANNER THAT SHALL NOT PERMIT WATER TO ACCUMULATE. ALL RAMP SURFACES CONTRAST VISUALLY WITH ADJOINING SURFACES BY STAIN OR INTEGRAL MIXTURE AND SHALL CONFORM WITH LOCAL GOVERNING CODES.

HANDICAP PARKING SCALE: 1/4"=1'-0" 102

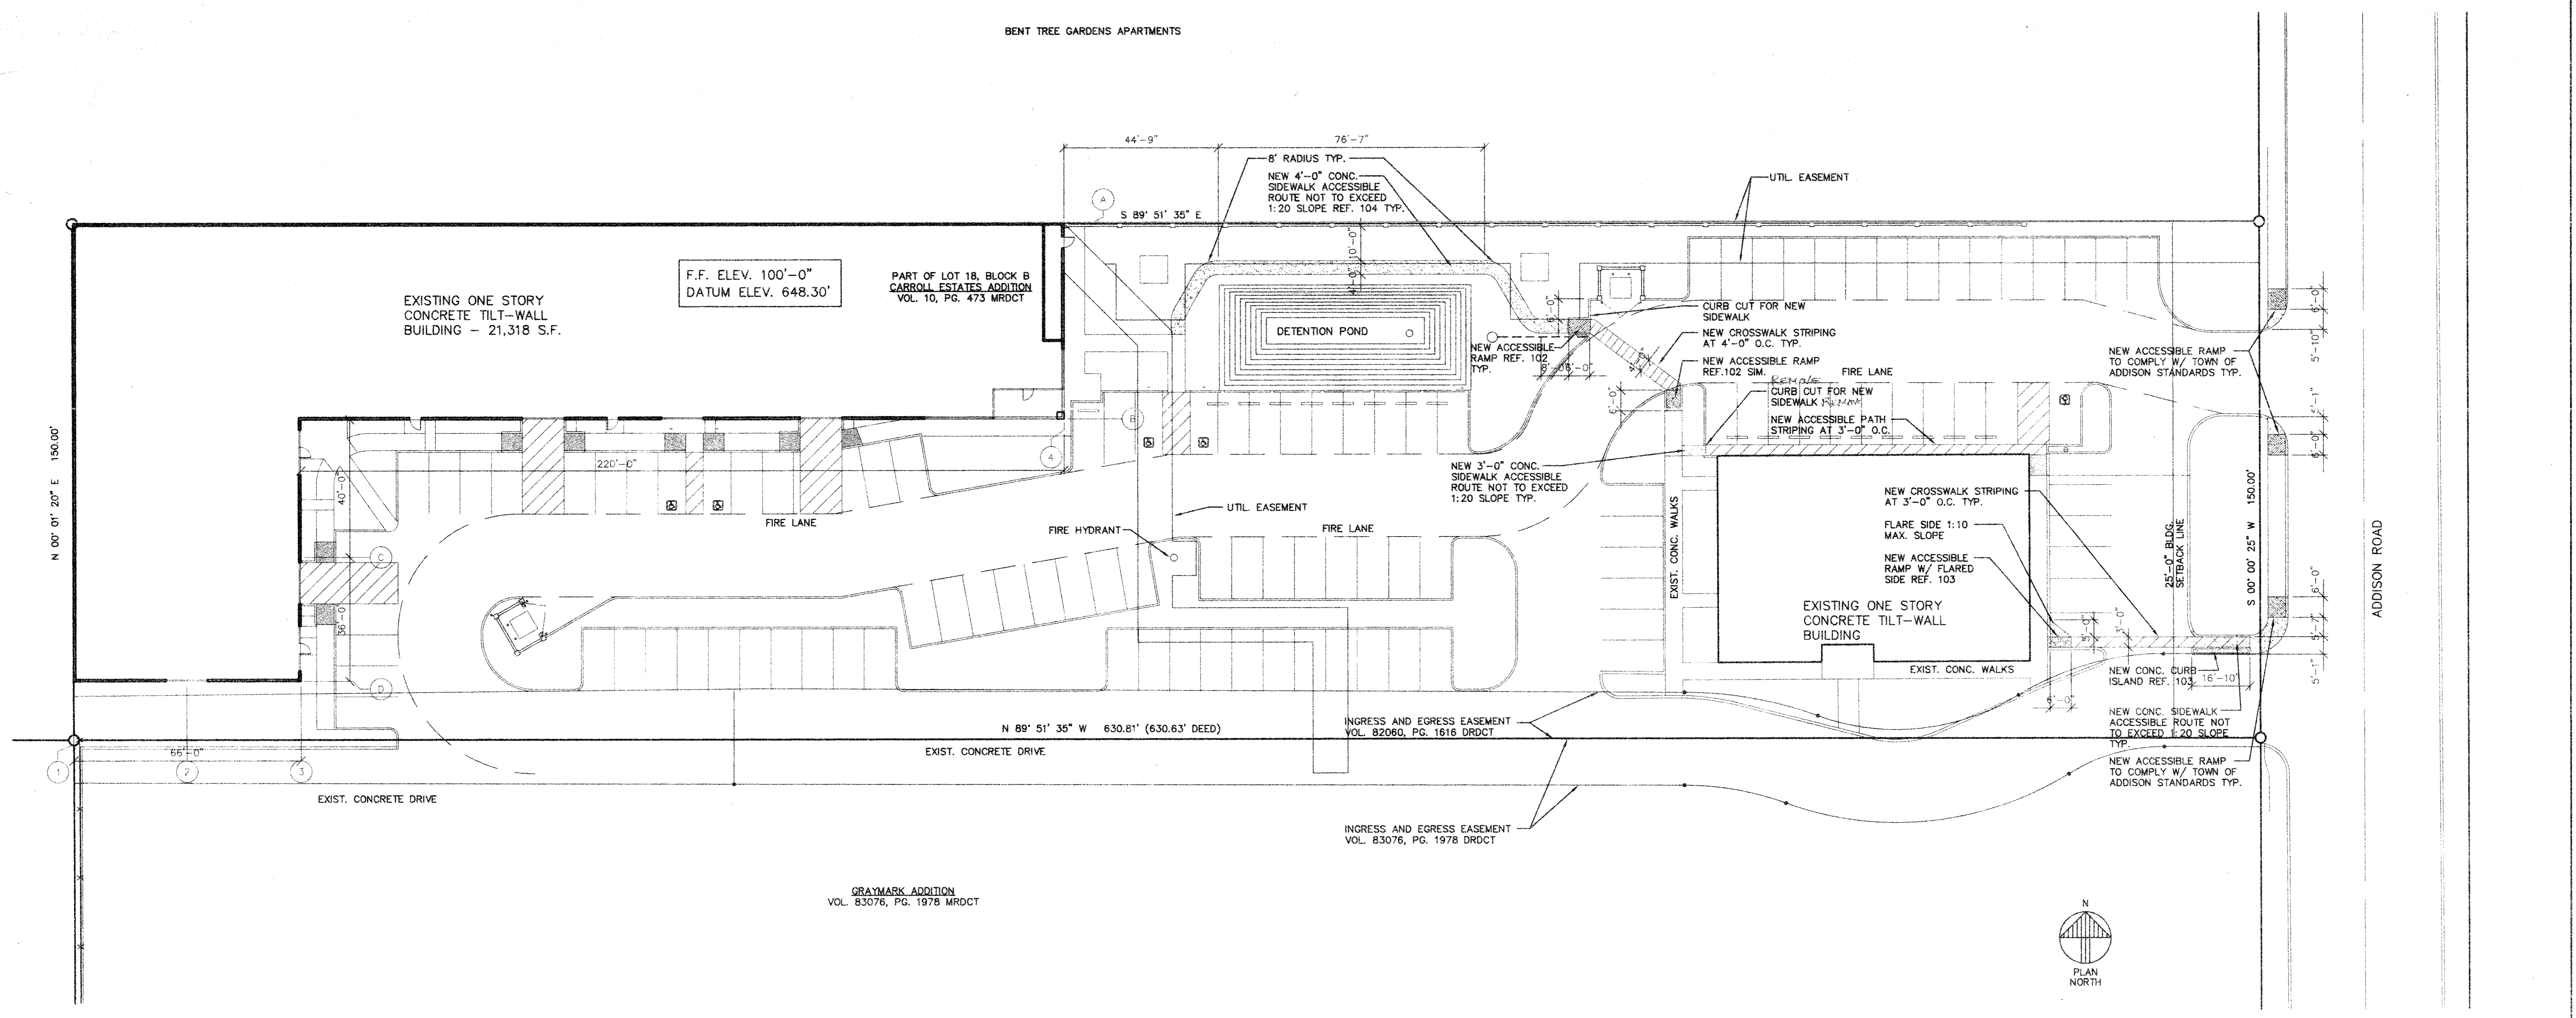

SITE PLAN SCALE: 1"=20'-0" 101

AMO  
 18835 ADDISON ROAD  
 SUITE 101  
 ADDISON, TX 75001  
 TEL: 972-250-0119  
 FAX: 972-250-3157

ADDISON PARK CENTRE  
 OFFICE/TECH./FLEX.  
 PHASE 1  
 16835 ADDISON ROAD ADDISON, TEXAS


to  
 T.S. Orendon Associates Inc.  
 Architectural & Interior Design

16835 Addison Road  
 Suite 101  
 Addison, Texas 75001  
 (972) 250-0119


JOB: 8396.01 DATE: 10-17-01  
 DRAWN: T.S.O. CHECKED: T.S.O.

Date	Issued For / Description


SITE PLAN AND DETAILS

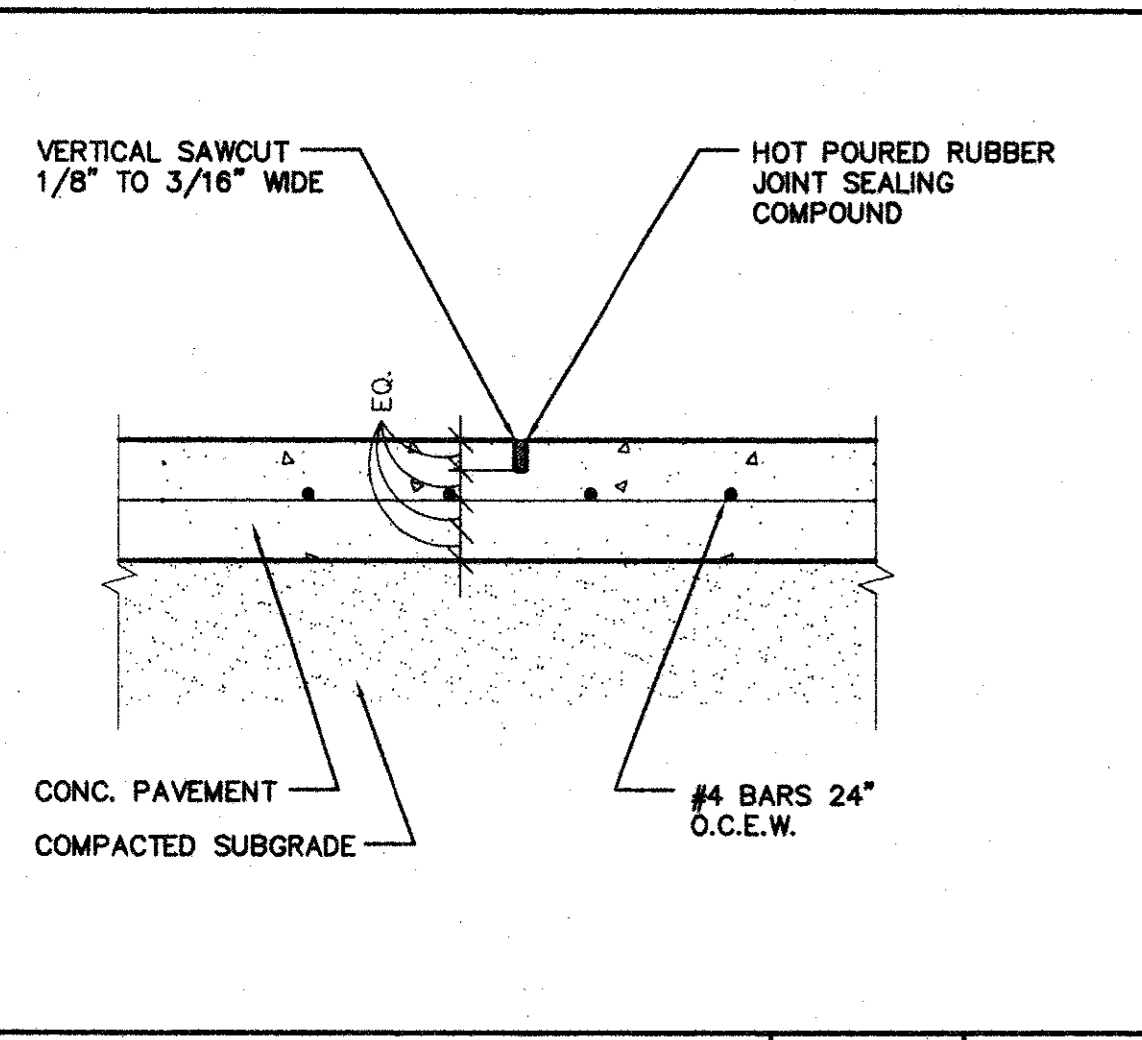


SAWCUT DETAIL SCALE: 1 1/2"=1'-0" 1.112

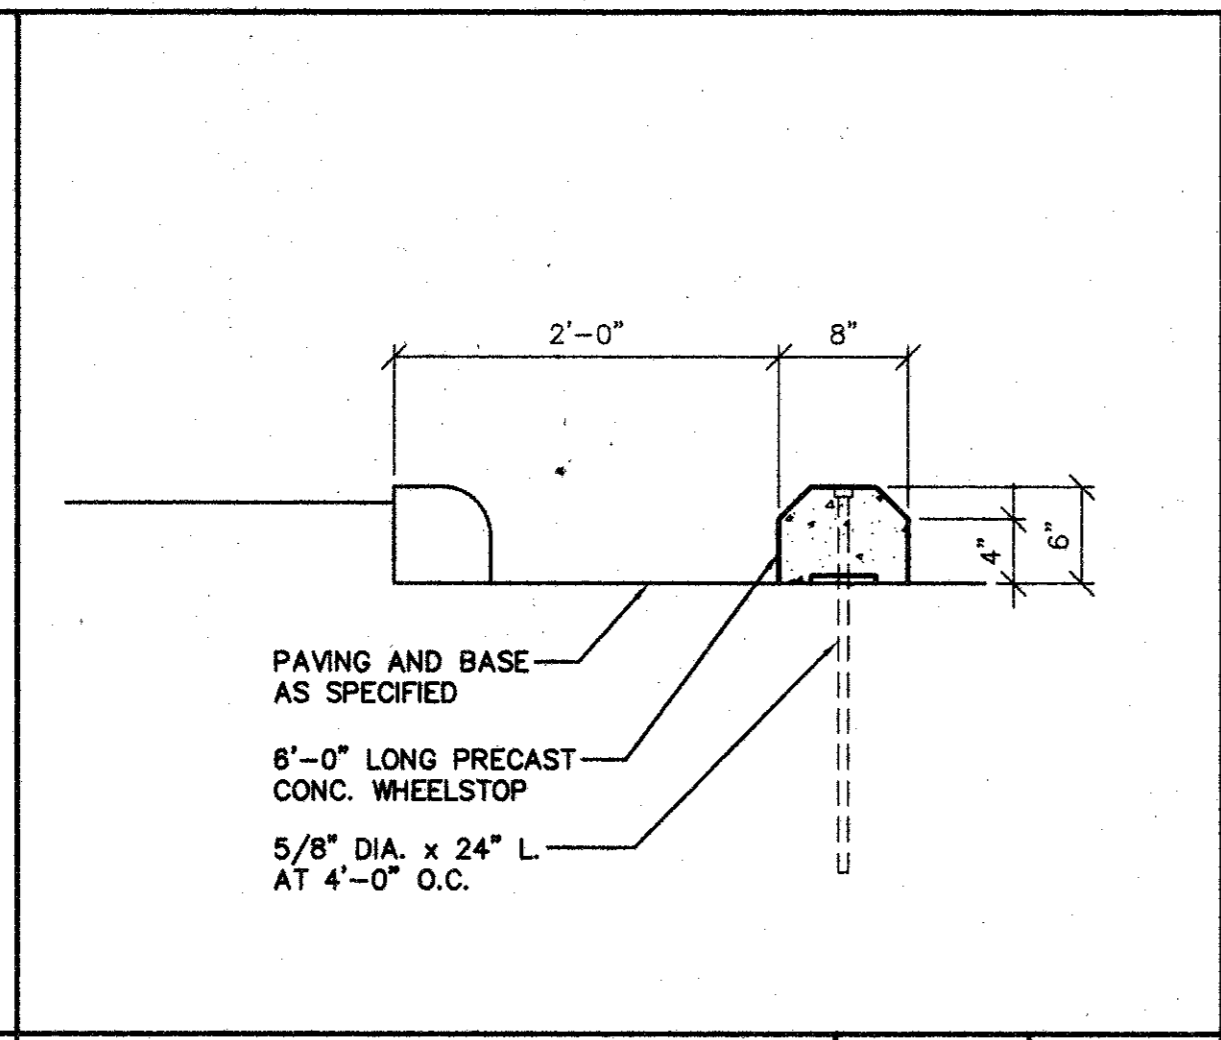


WHEELSTOP SCALE: 1"=1'-0" 1.110

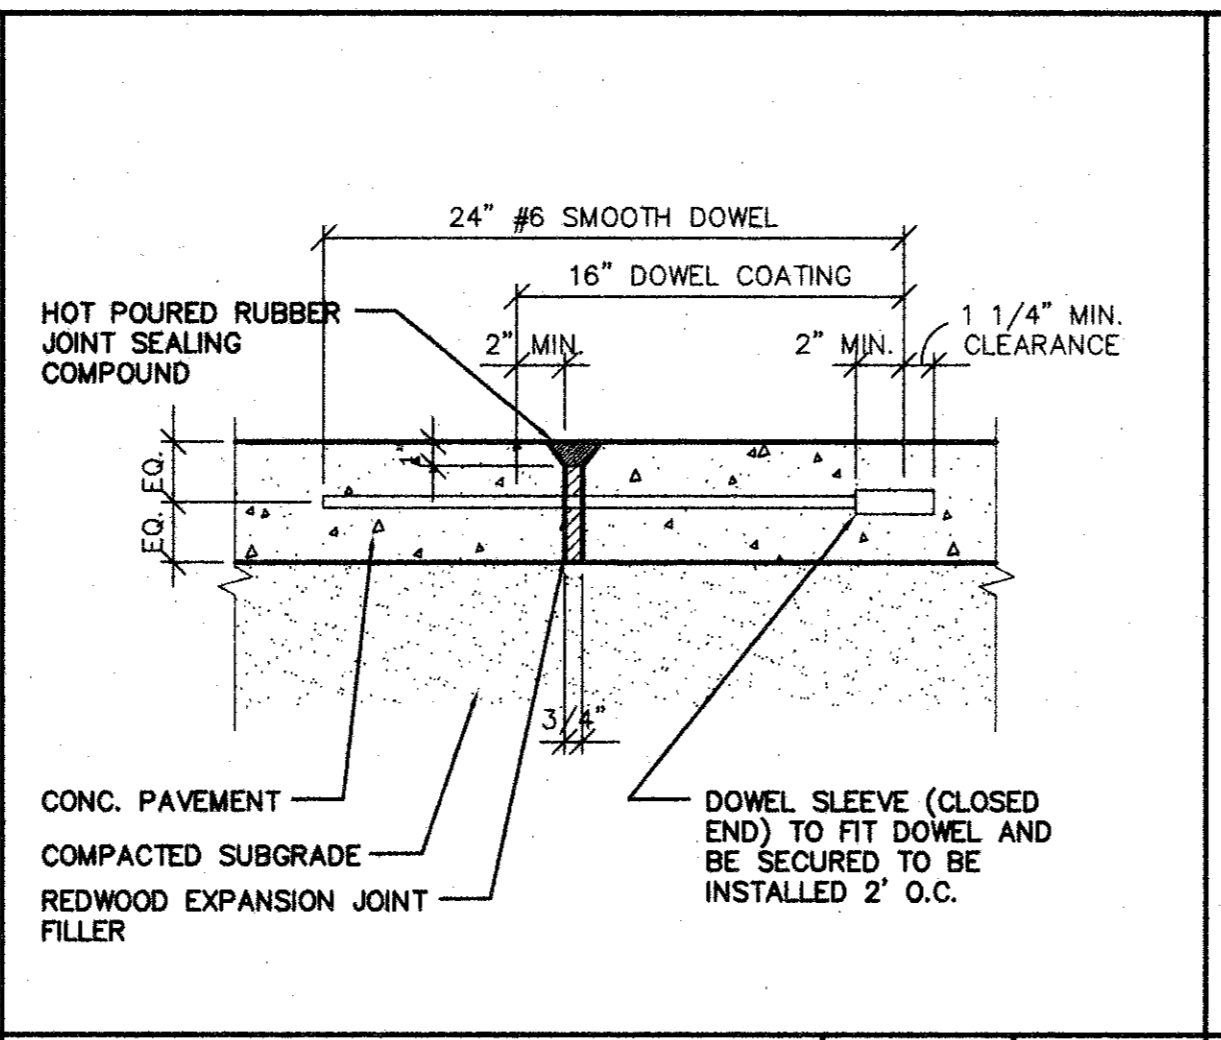


EXPANSION JOINT SCALE: 1 1/2"=1'-0" 1.108

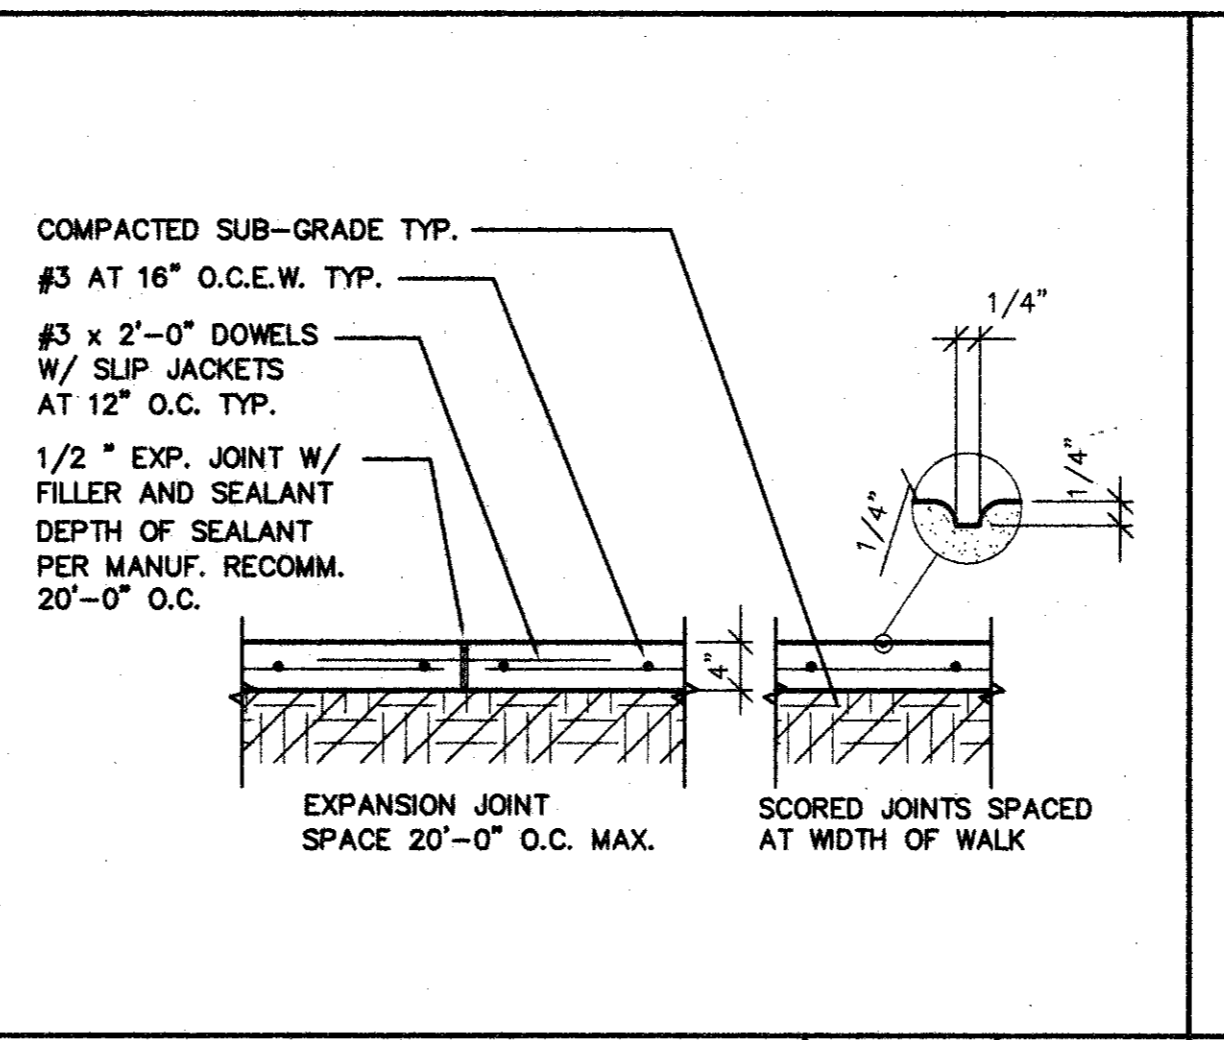


CONC. WALK SCALE: 3/4"=1'-0" 1.106

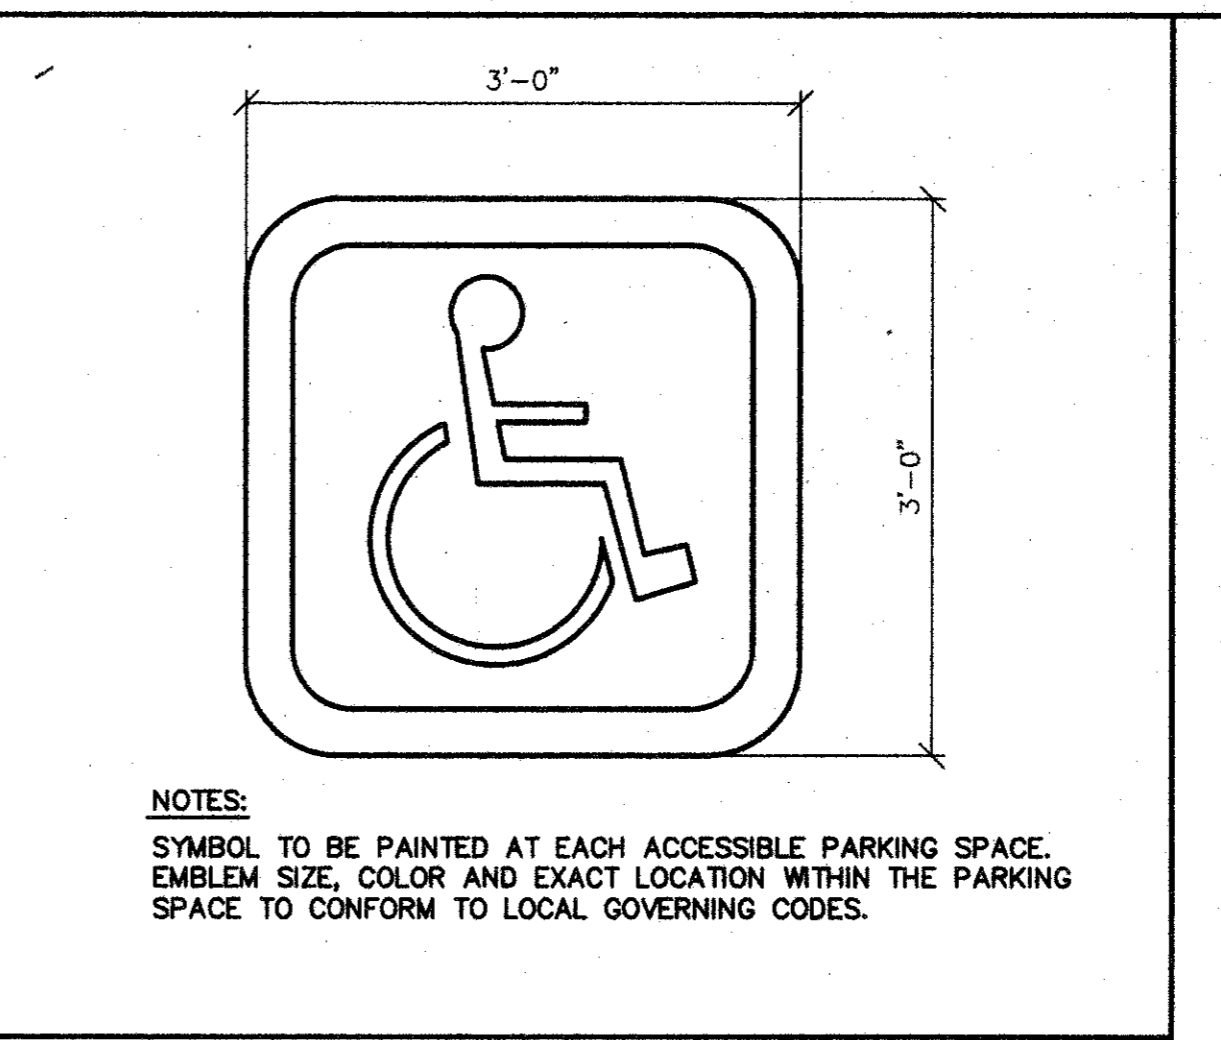


HANDICAP SYMBOL SCALE: 1"=1'-0" 1.104

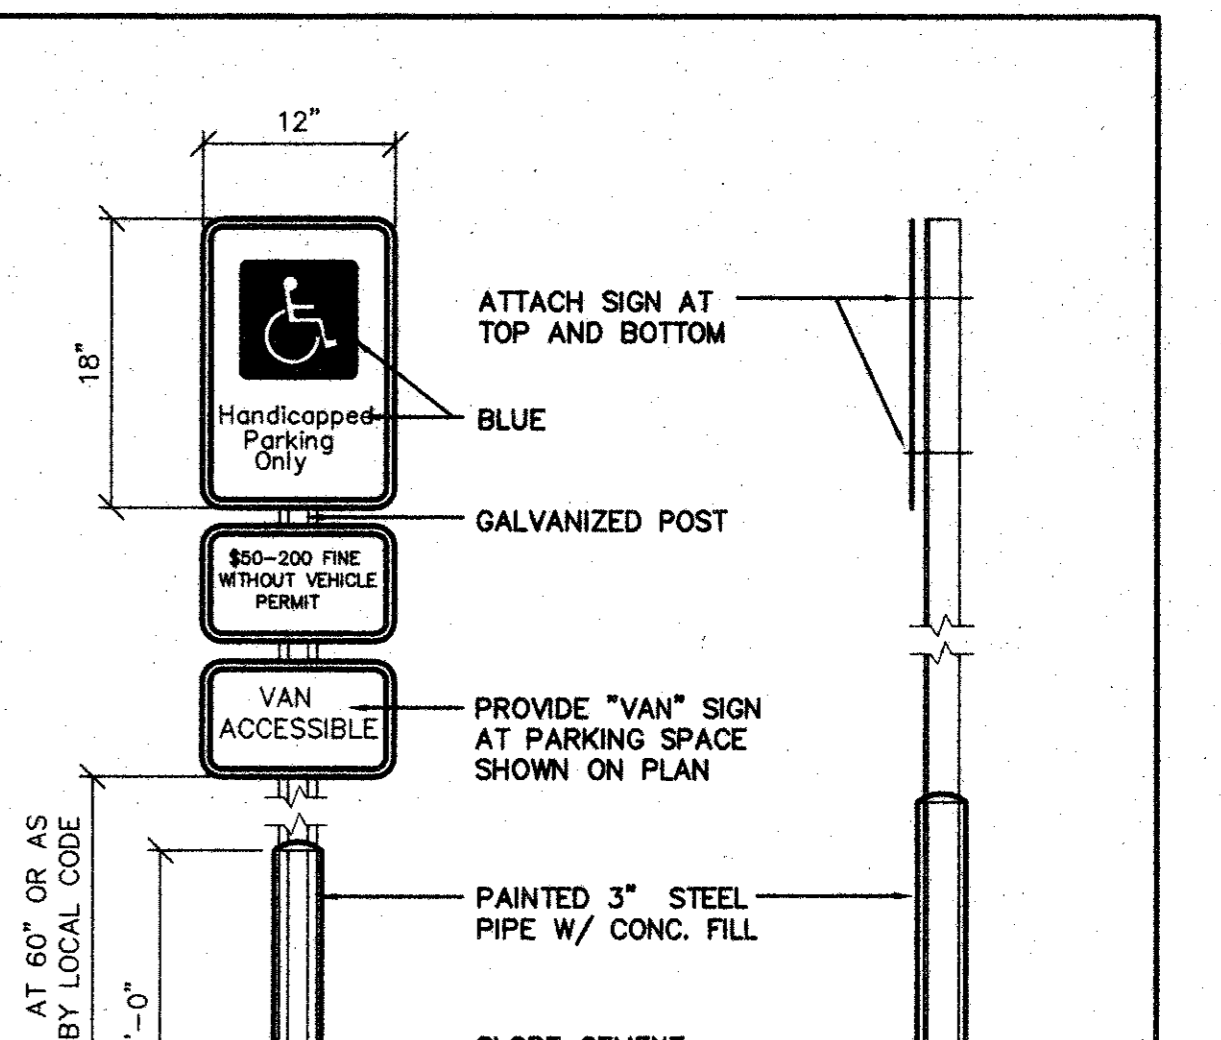


HANDICAP SIGN SCALE: 1"=1'-0" 1.102

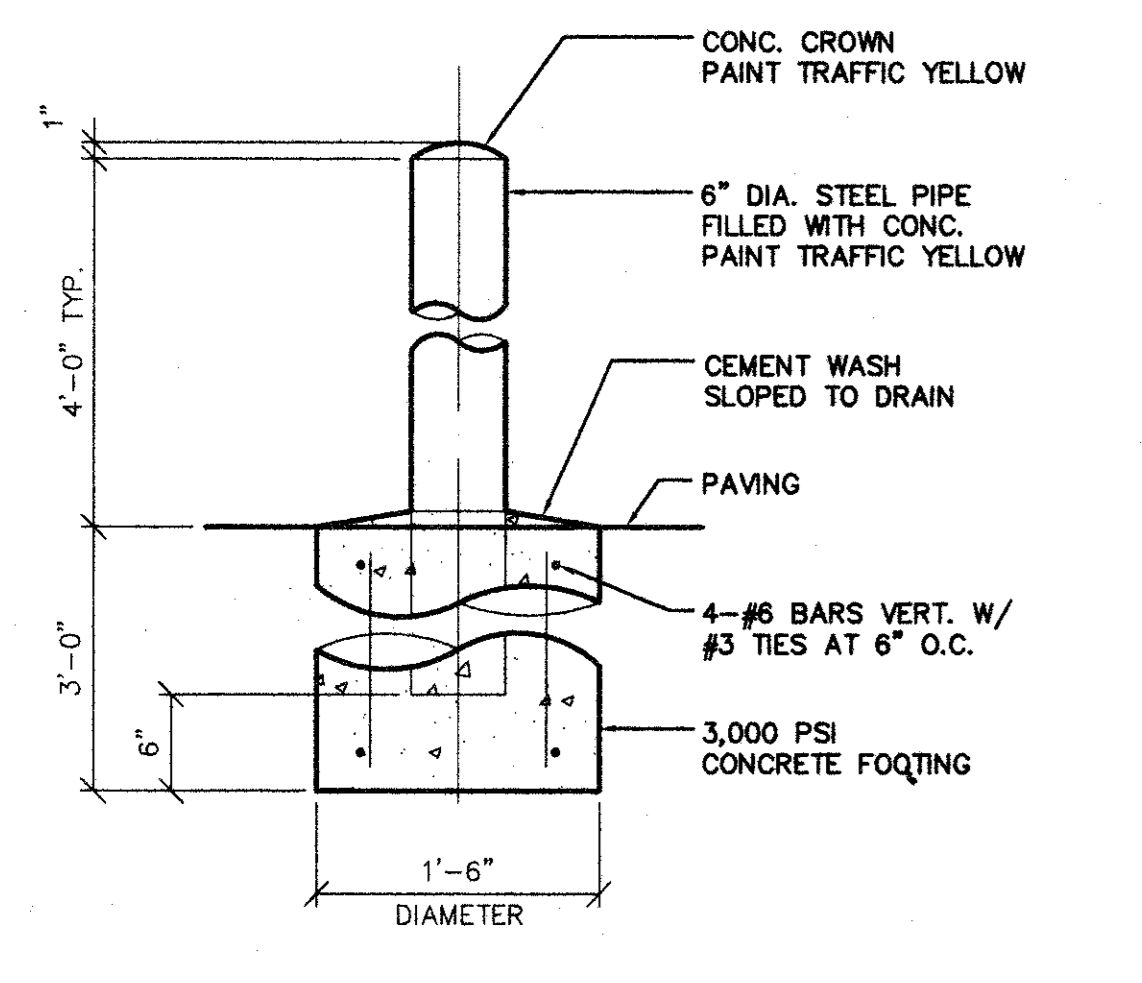


PIPE BOLLARD SCALE: 1"=1'-0" 1.109

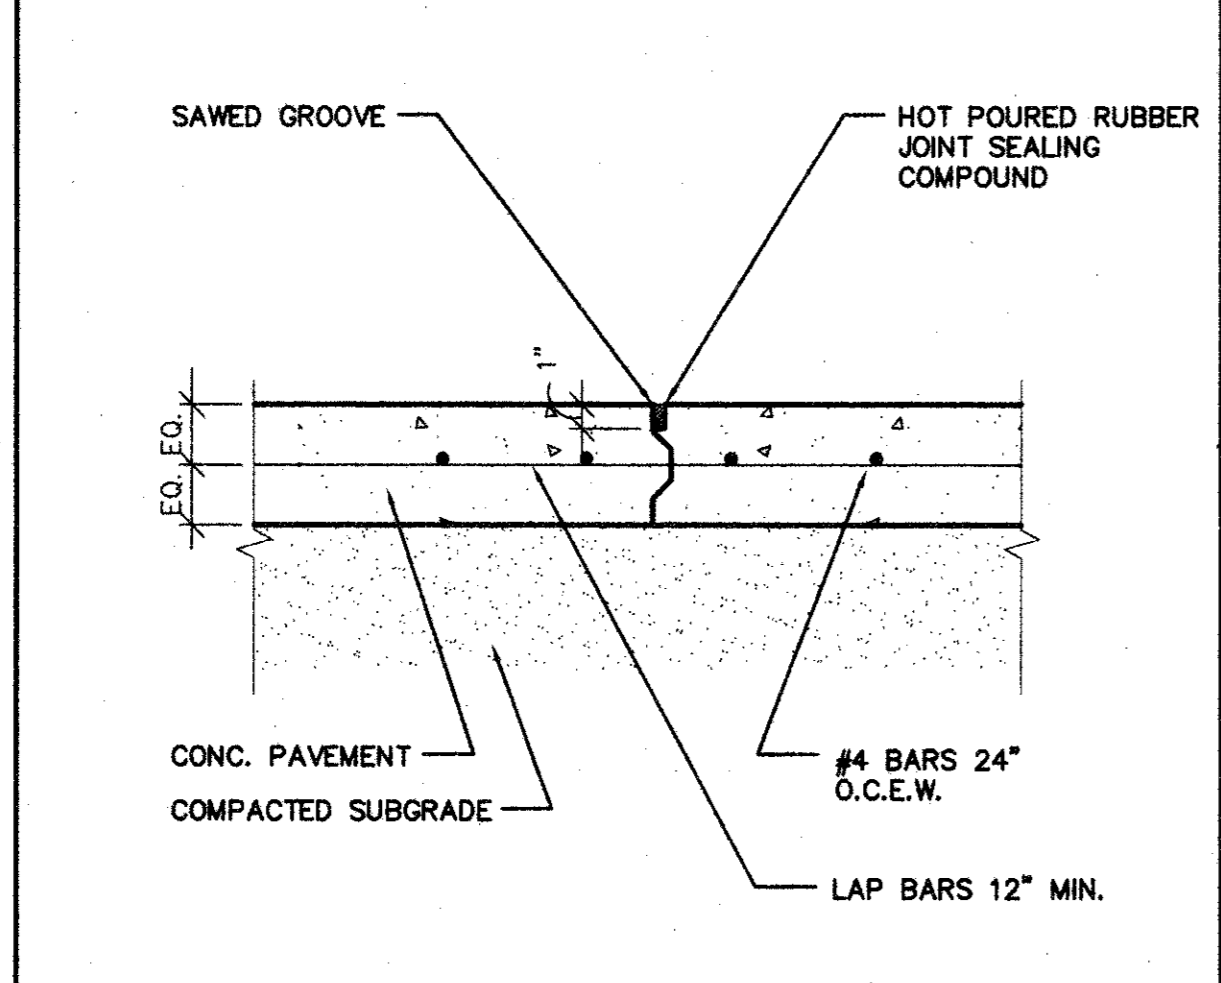


KEYWAY JOINT SCALE: 1 1/2"=1'-0" 1.107

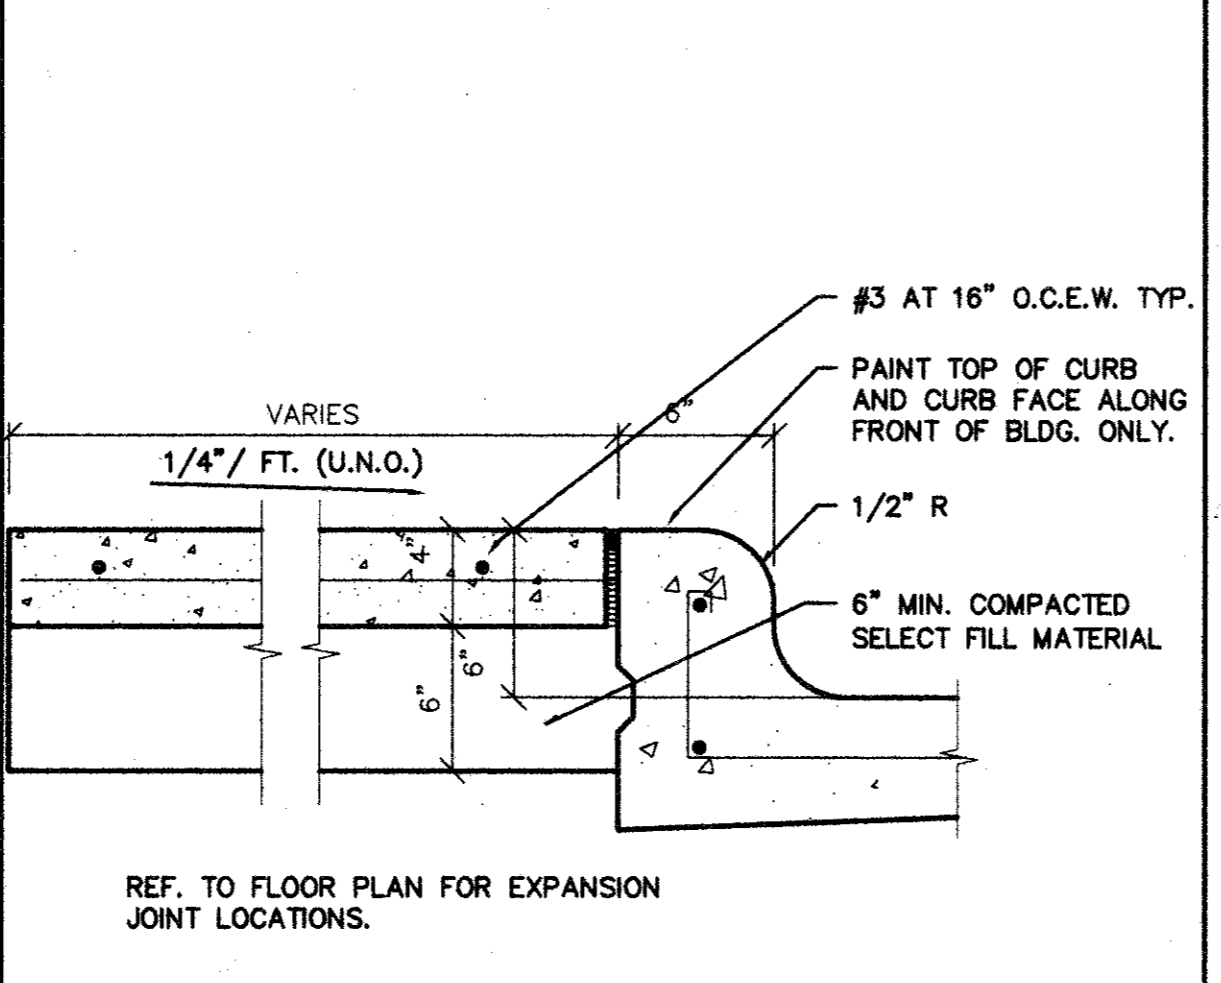


CURB DETAIL SCALE: 1 1/2"=1'-0" 1.105

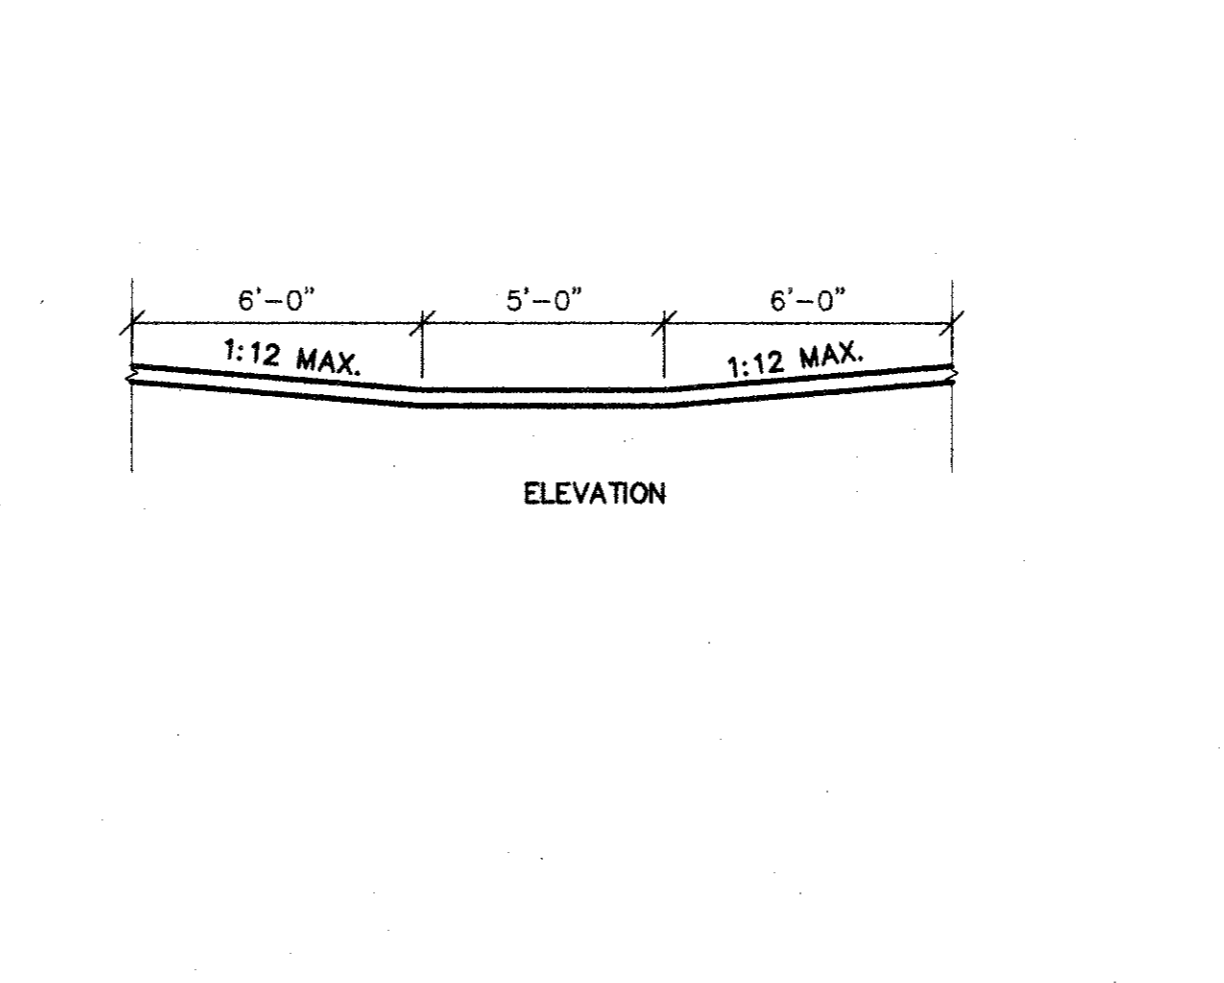

HANDICAP PARKING SCALE: 1/4"=1'-0" 1.103

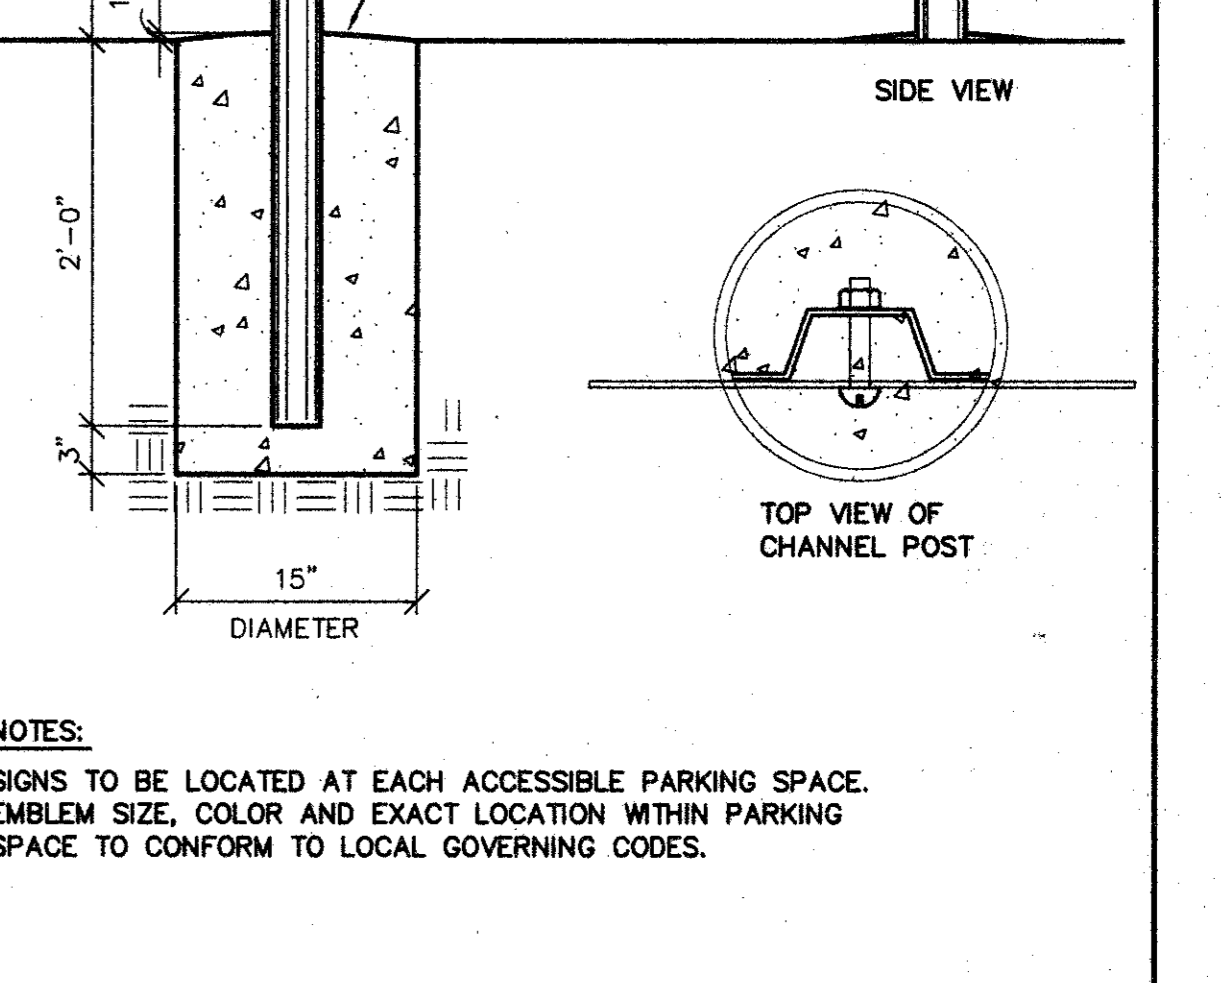

HANDICAP SIGN SCALE: 1"=1'-0" 1.102

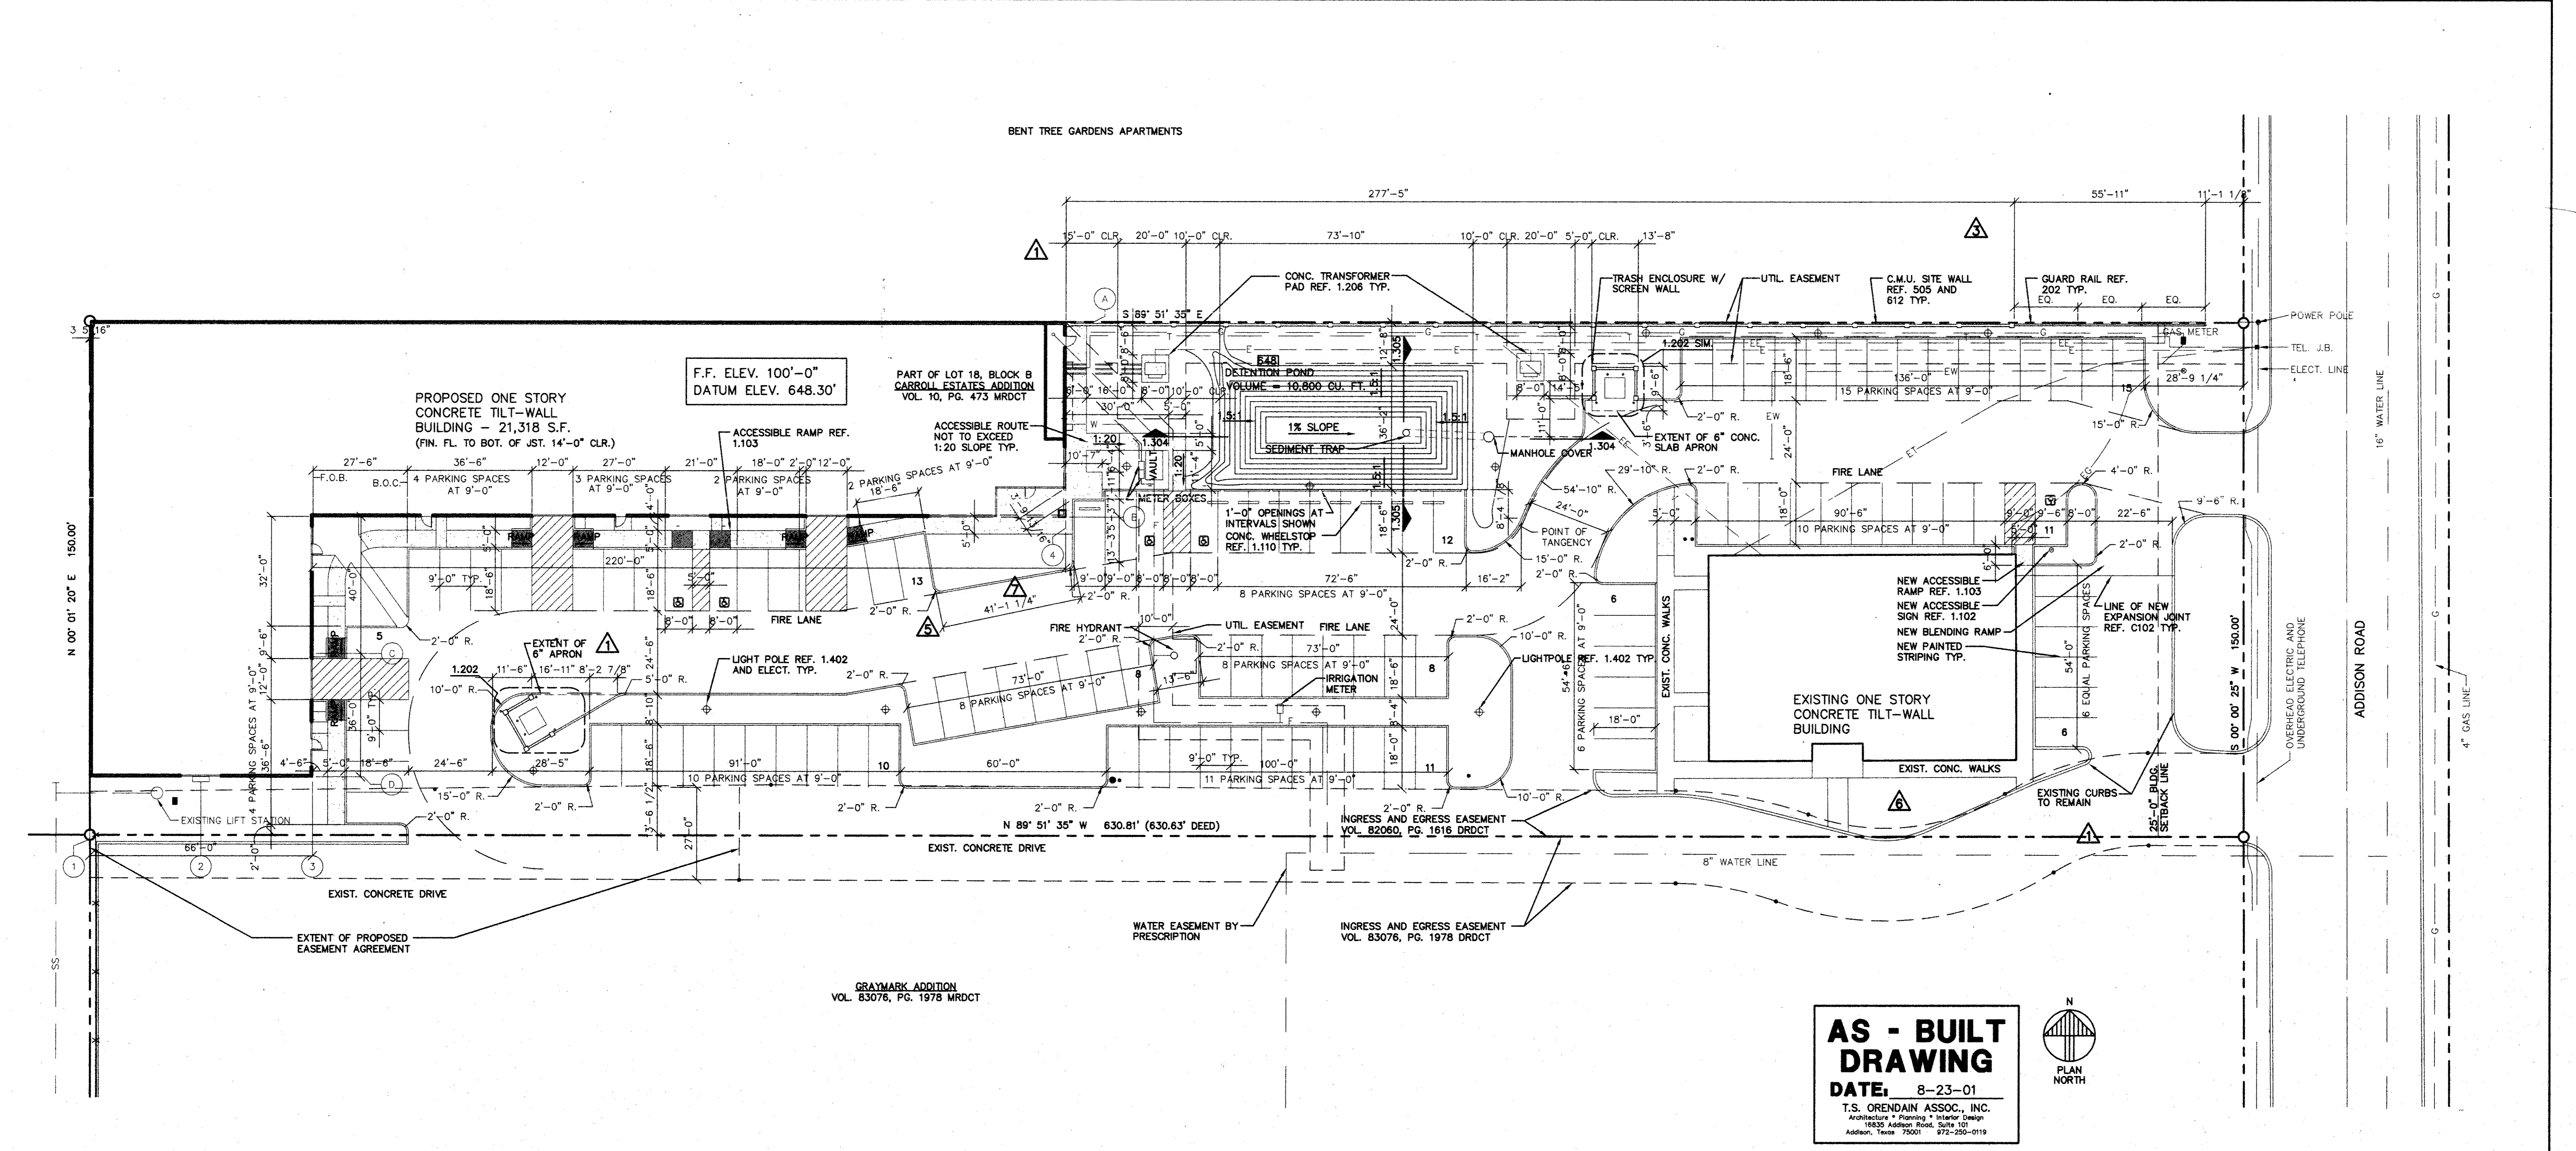


**AS - BUILT DRAWING**  
 DATE: 8-23-01  
 T.S. OREDAIN ASSOC., INC.  
 Architecture • Planning • Interior Design  
 16835 Addison Road, Suite 101  
 Addison, Texas 75001 972-250-0119

SITE PLAN SCALE: 1"=20'-0" 1.101

**AMO**  
 16835 ADDISON ROAD  
 ADDISON, TX 75001  
 TEL: 972-250-0119  
 FAX: 972-250-3157

**ADDISON PARK CENTRE  
 OFFICE/TECH./FLEX.  
 PHASE 1**  
 16835 ADDISON ROAD ADDISON, TEXAS

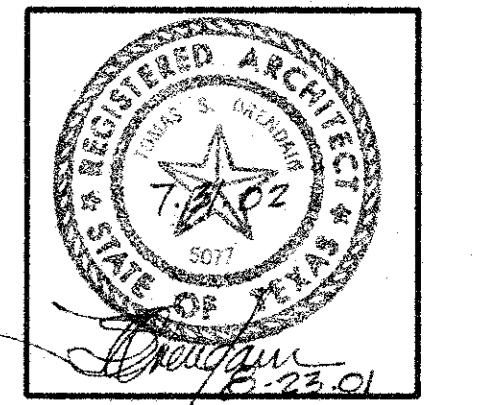


**T.S. Orendain Associates Inc.**  
 Architecture • Planning • Interior Design  
 16835 Addison Road  
 Suite 101  
 Addison, Texas 75001  
 (972) 250-0119


JOB: 8396 DATE: 2/25/2000  
 DRAWN: T.S.O. CHECKED: T.S.O.

Date	Issued For / Description
2-25-2000	100% ISSUED FOR CONSTRUCTION
8-9-2000	GENERAL REVISION
9-13-2000	SITE WALL REVISION
11-20-2000	DRIVE ADDED
12-8-2000	EXIST. PARKING REVISION
2-9-2001	GENERAL REVISION


SITE PLAN AND DETAILS

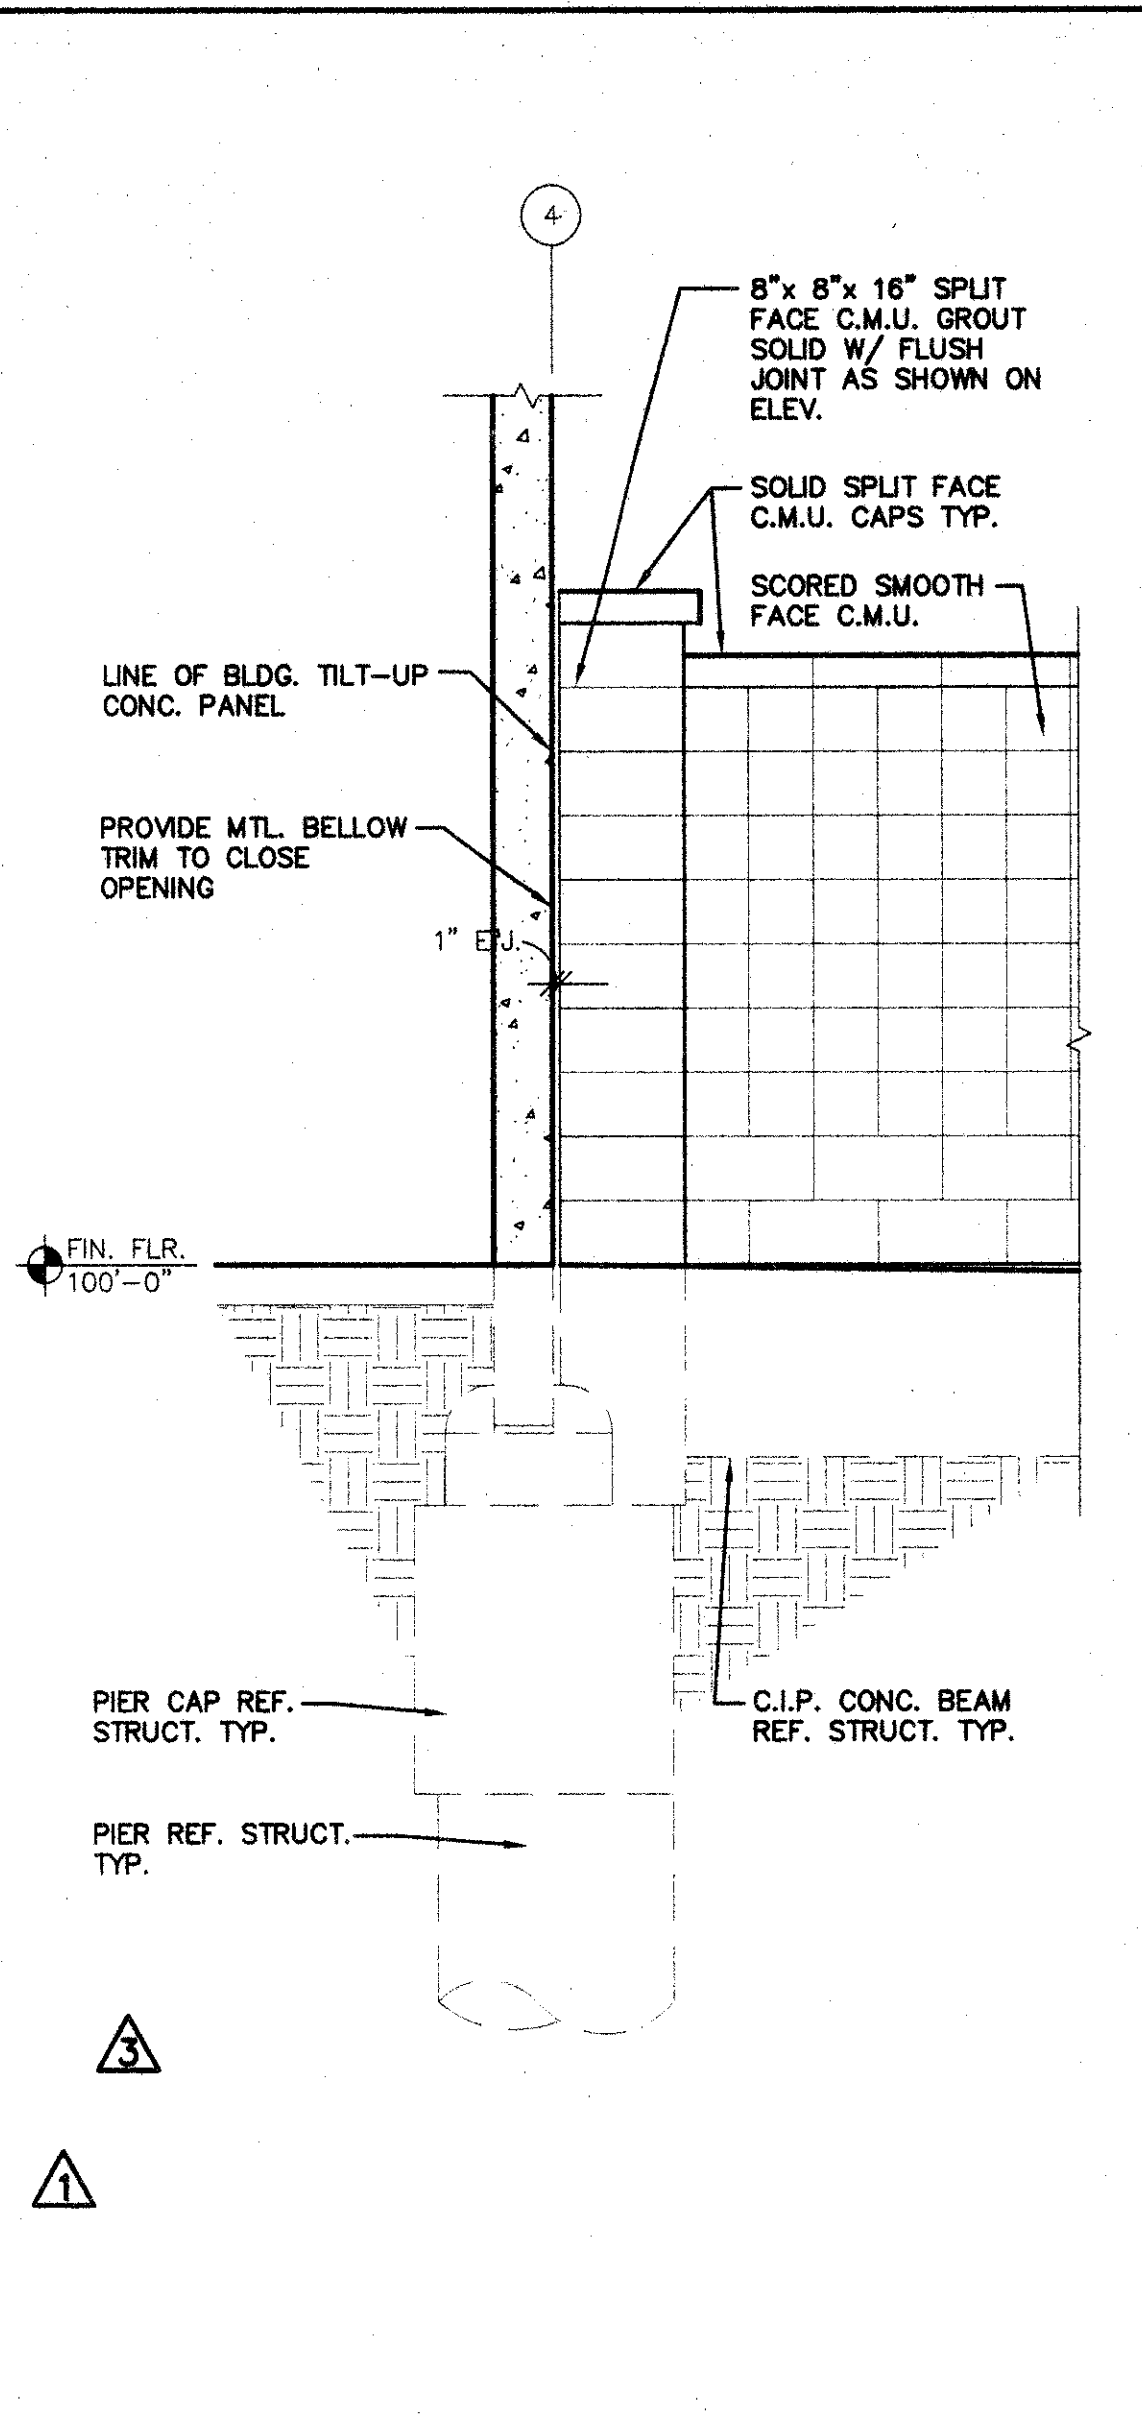


WALL DETAIL SCALE: 1/2"=1'-0" 1.207

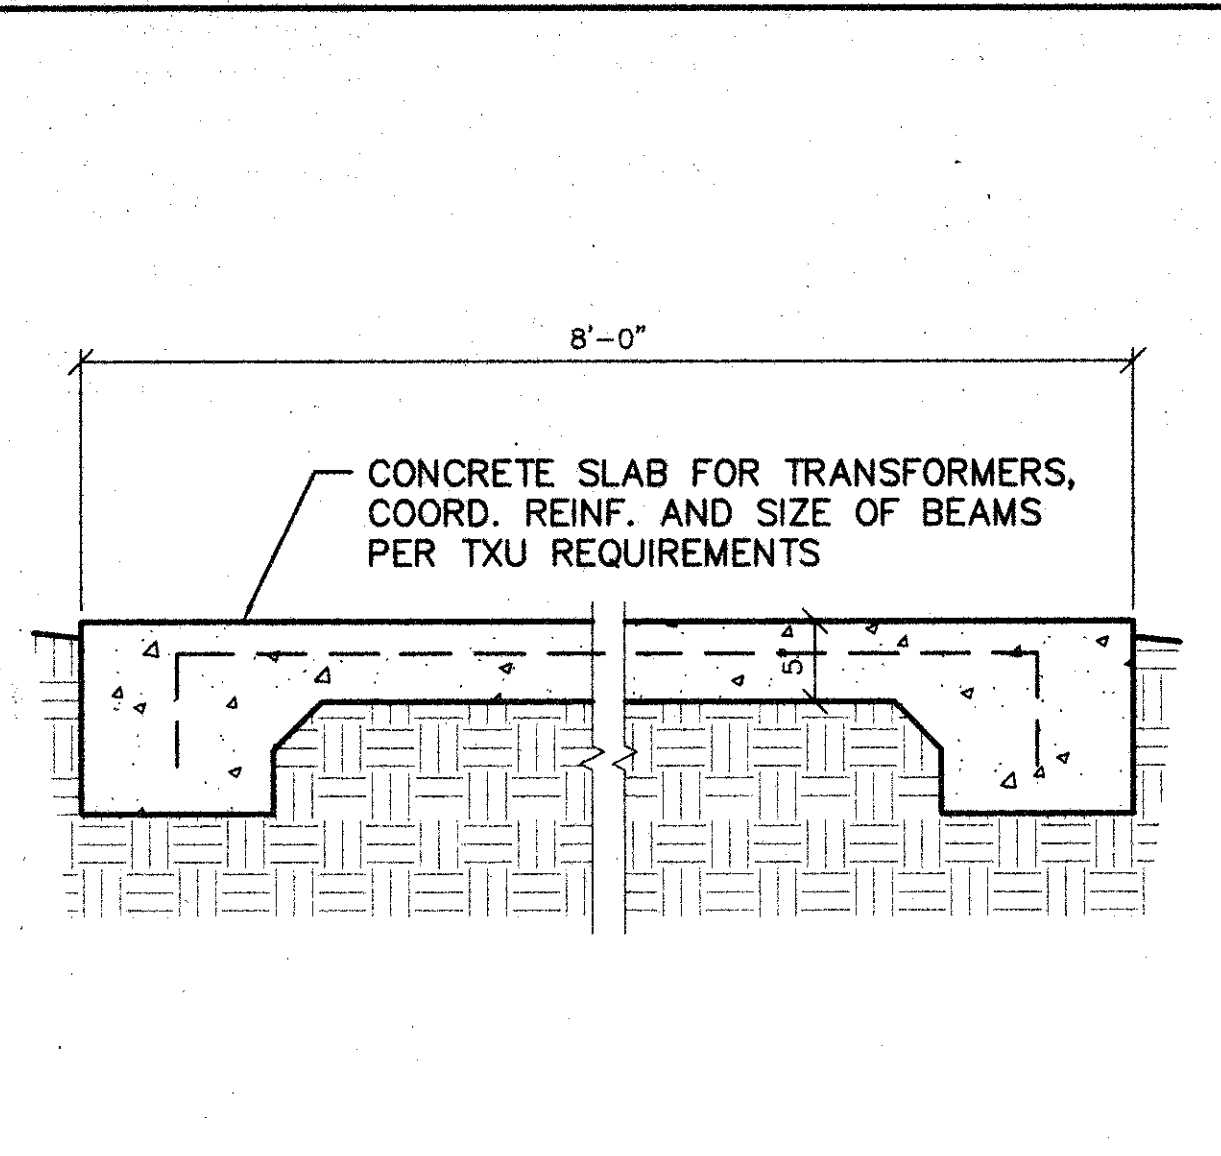


DIKE DETAIL SCALE: 1"=1'-0" 1.206

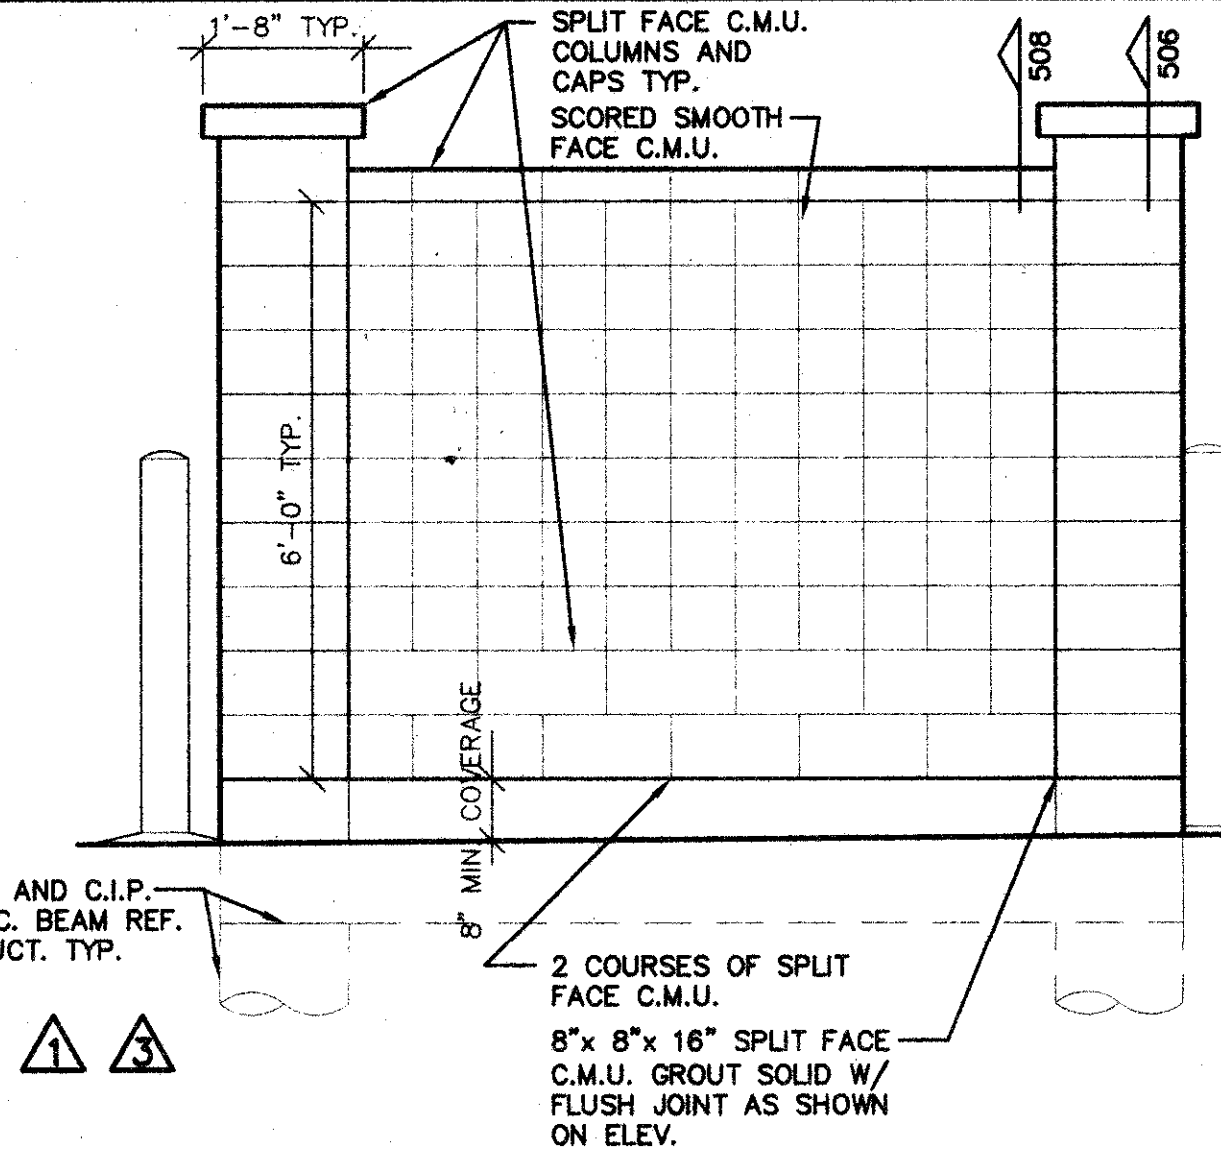


SCREEN ELEVATION SCALE: 1/2"=1'-0" 1.204

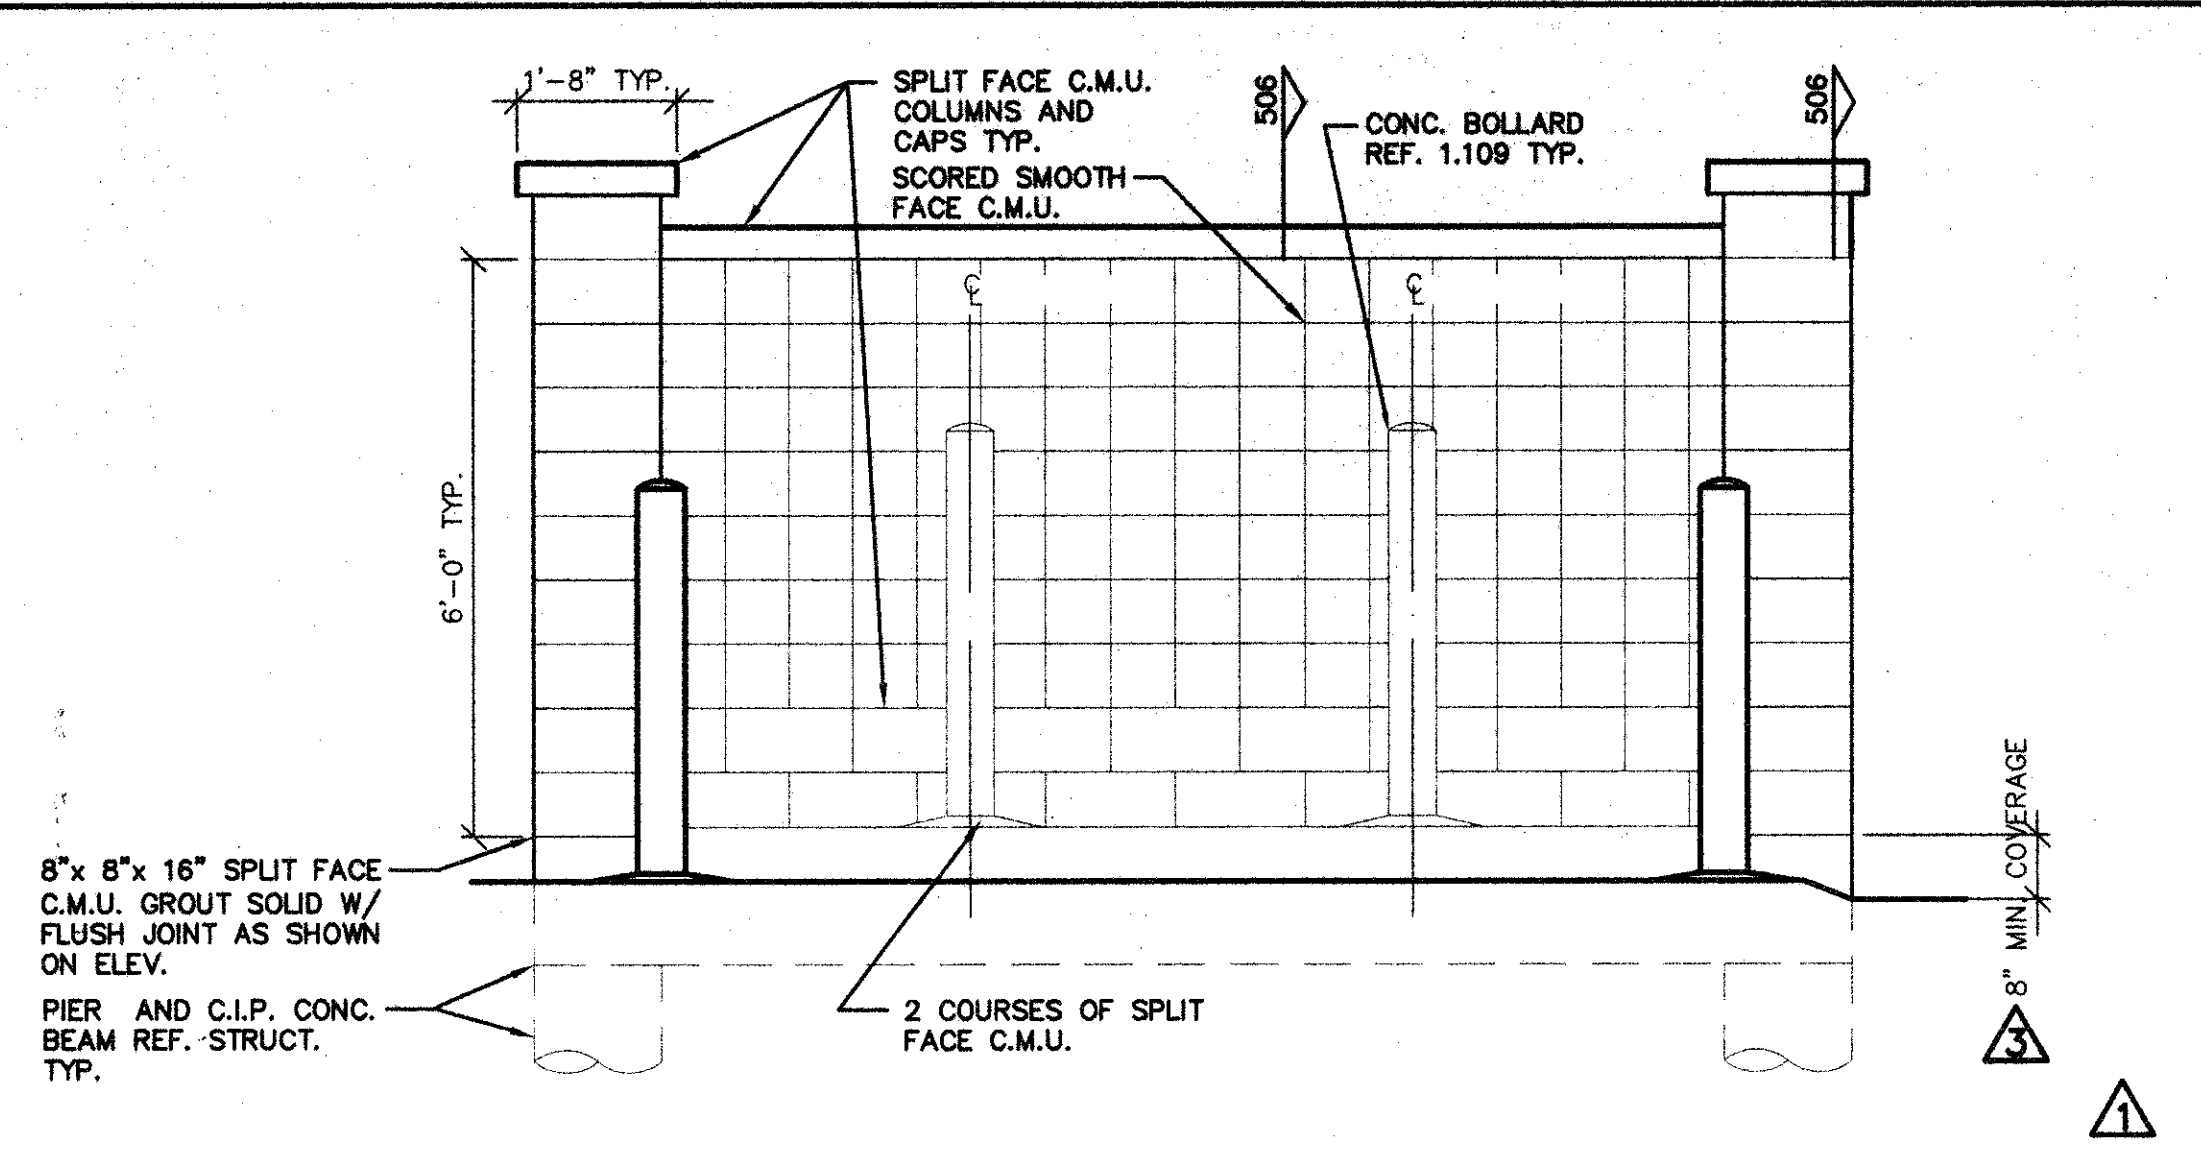


SCREEN ELEVATION SCALE: 1/2"=1'-0" 1.205

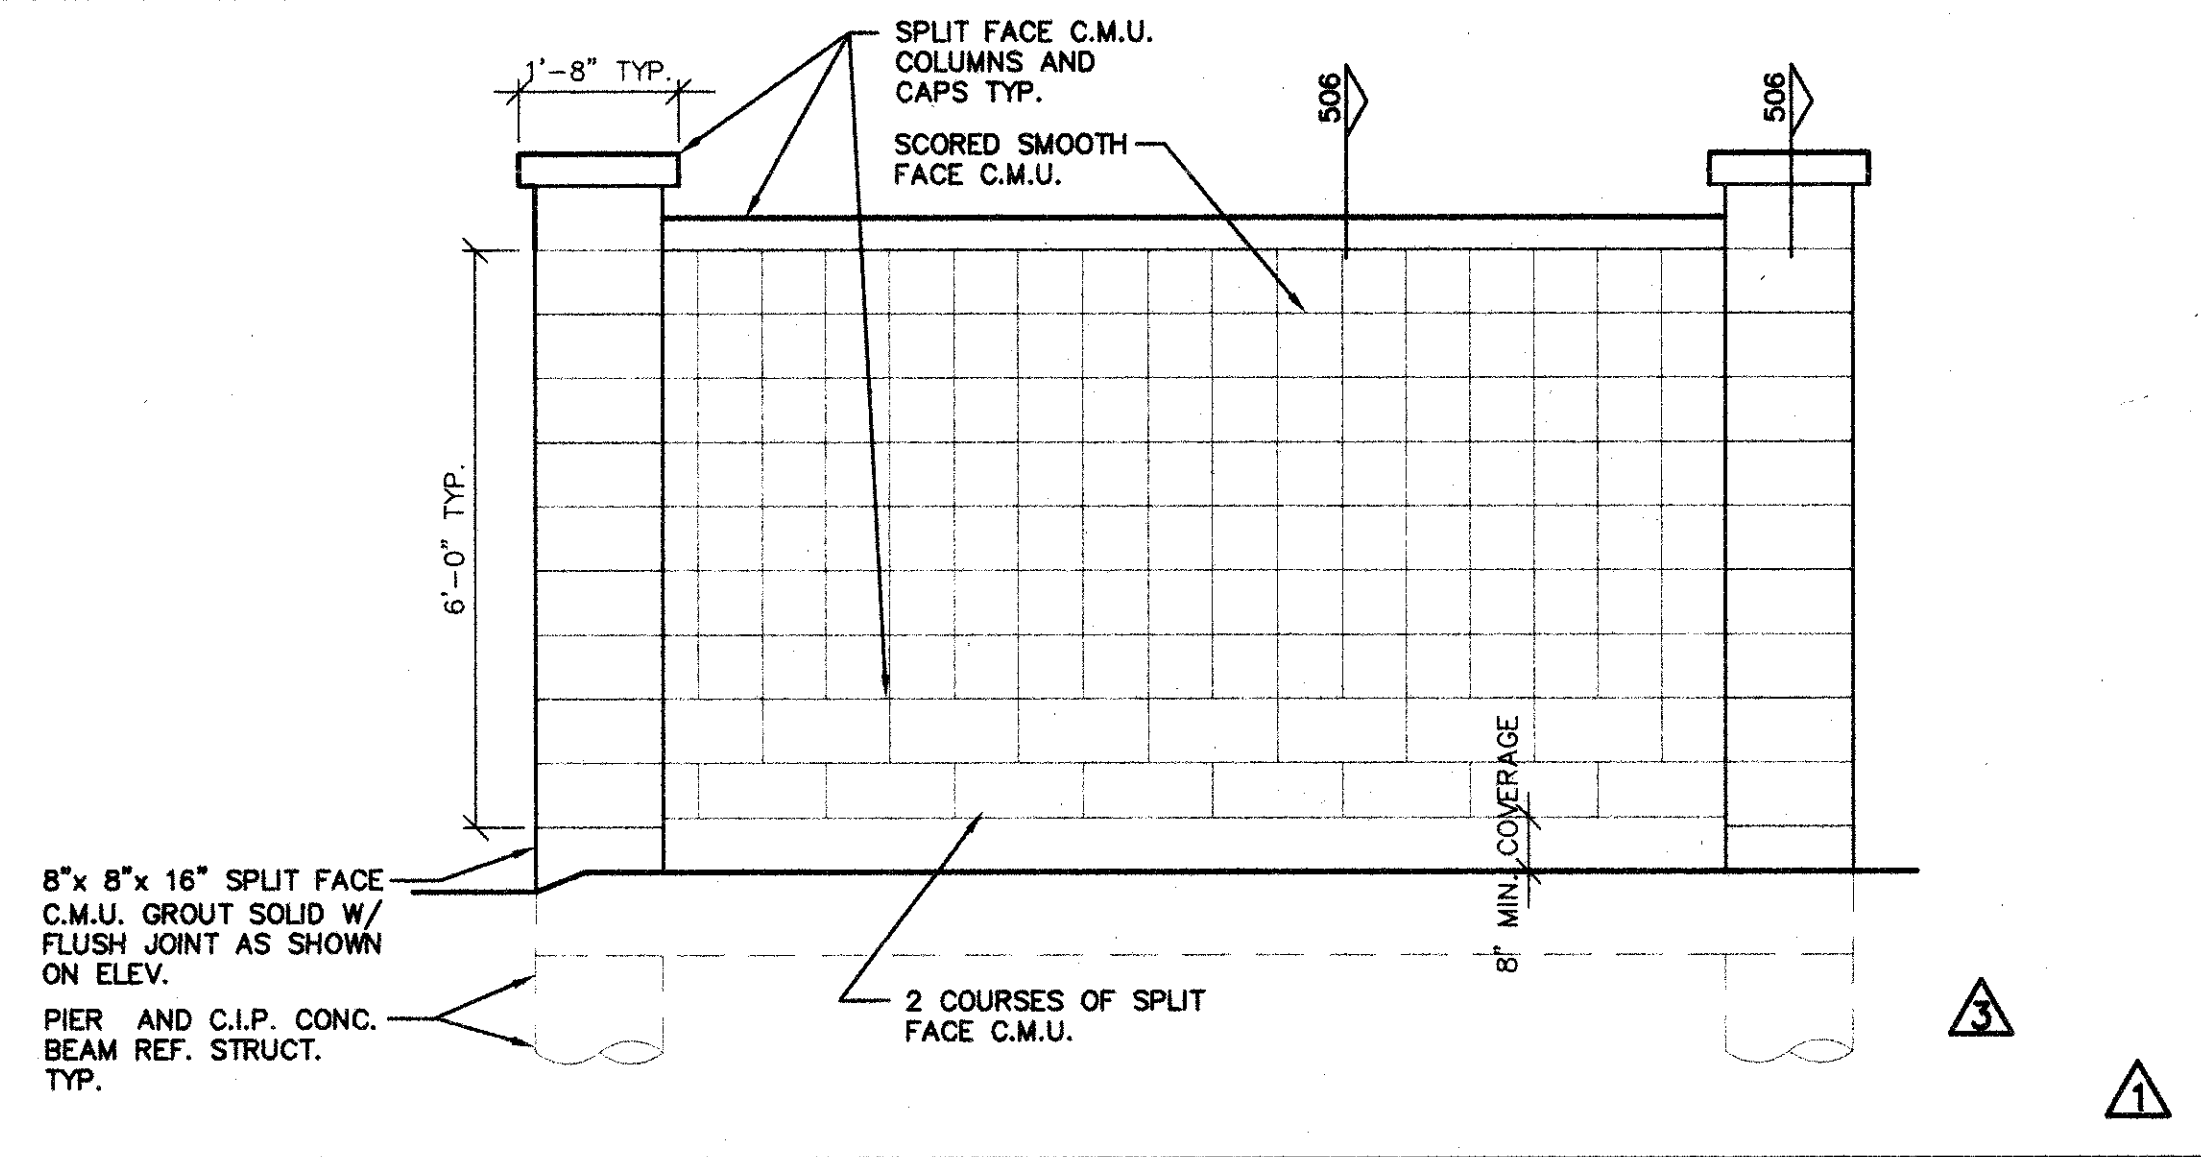

SCREEN ELEVATION SCALE: 1/2"=1'-0" 1.203

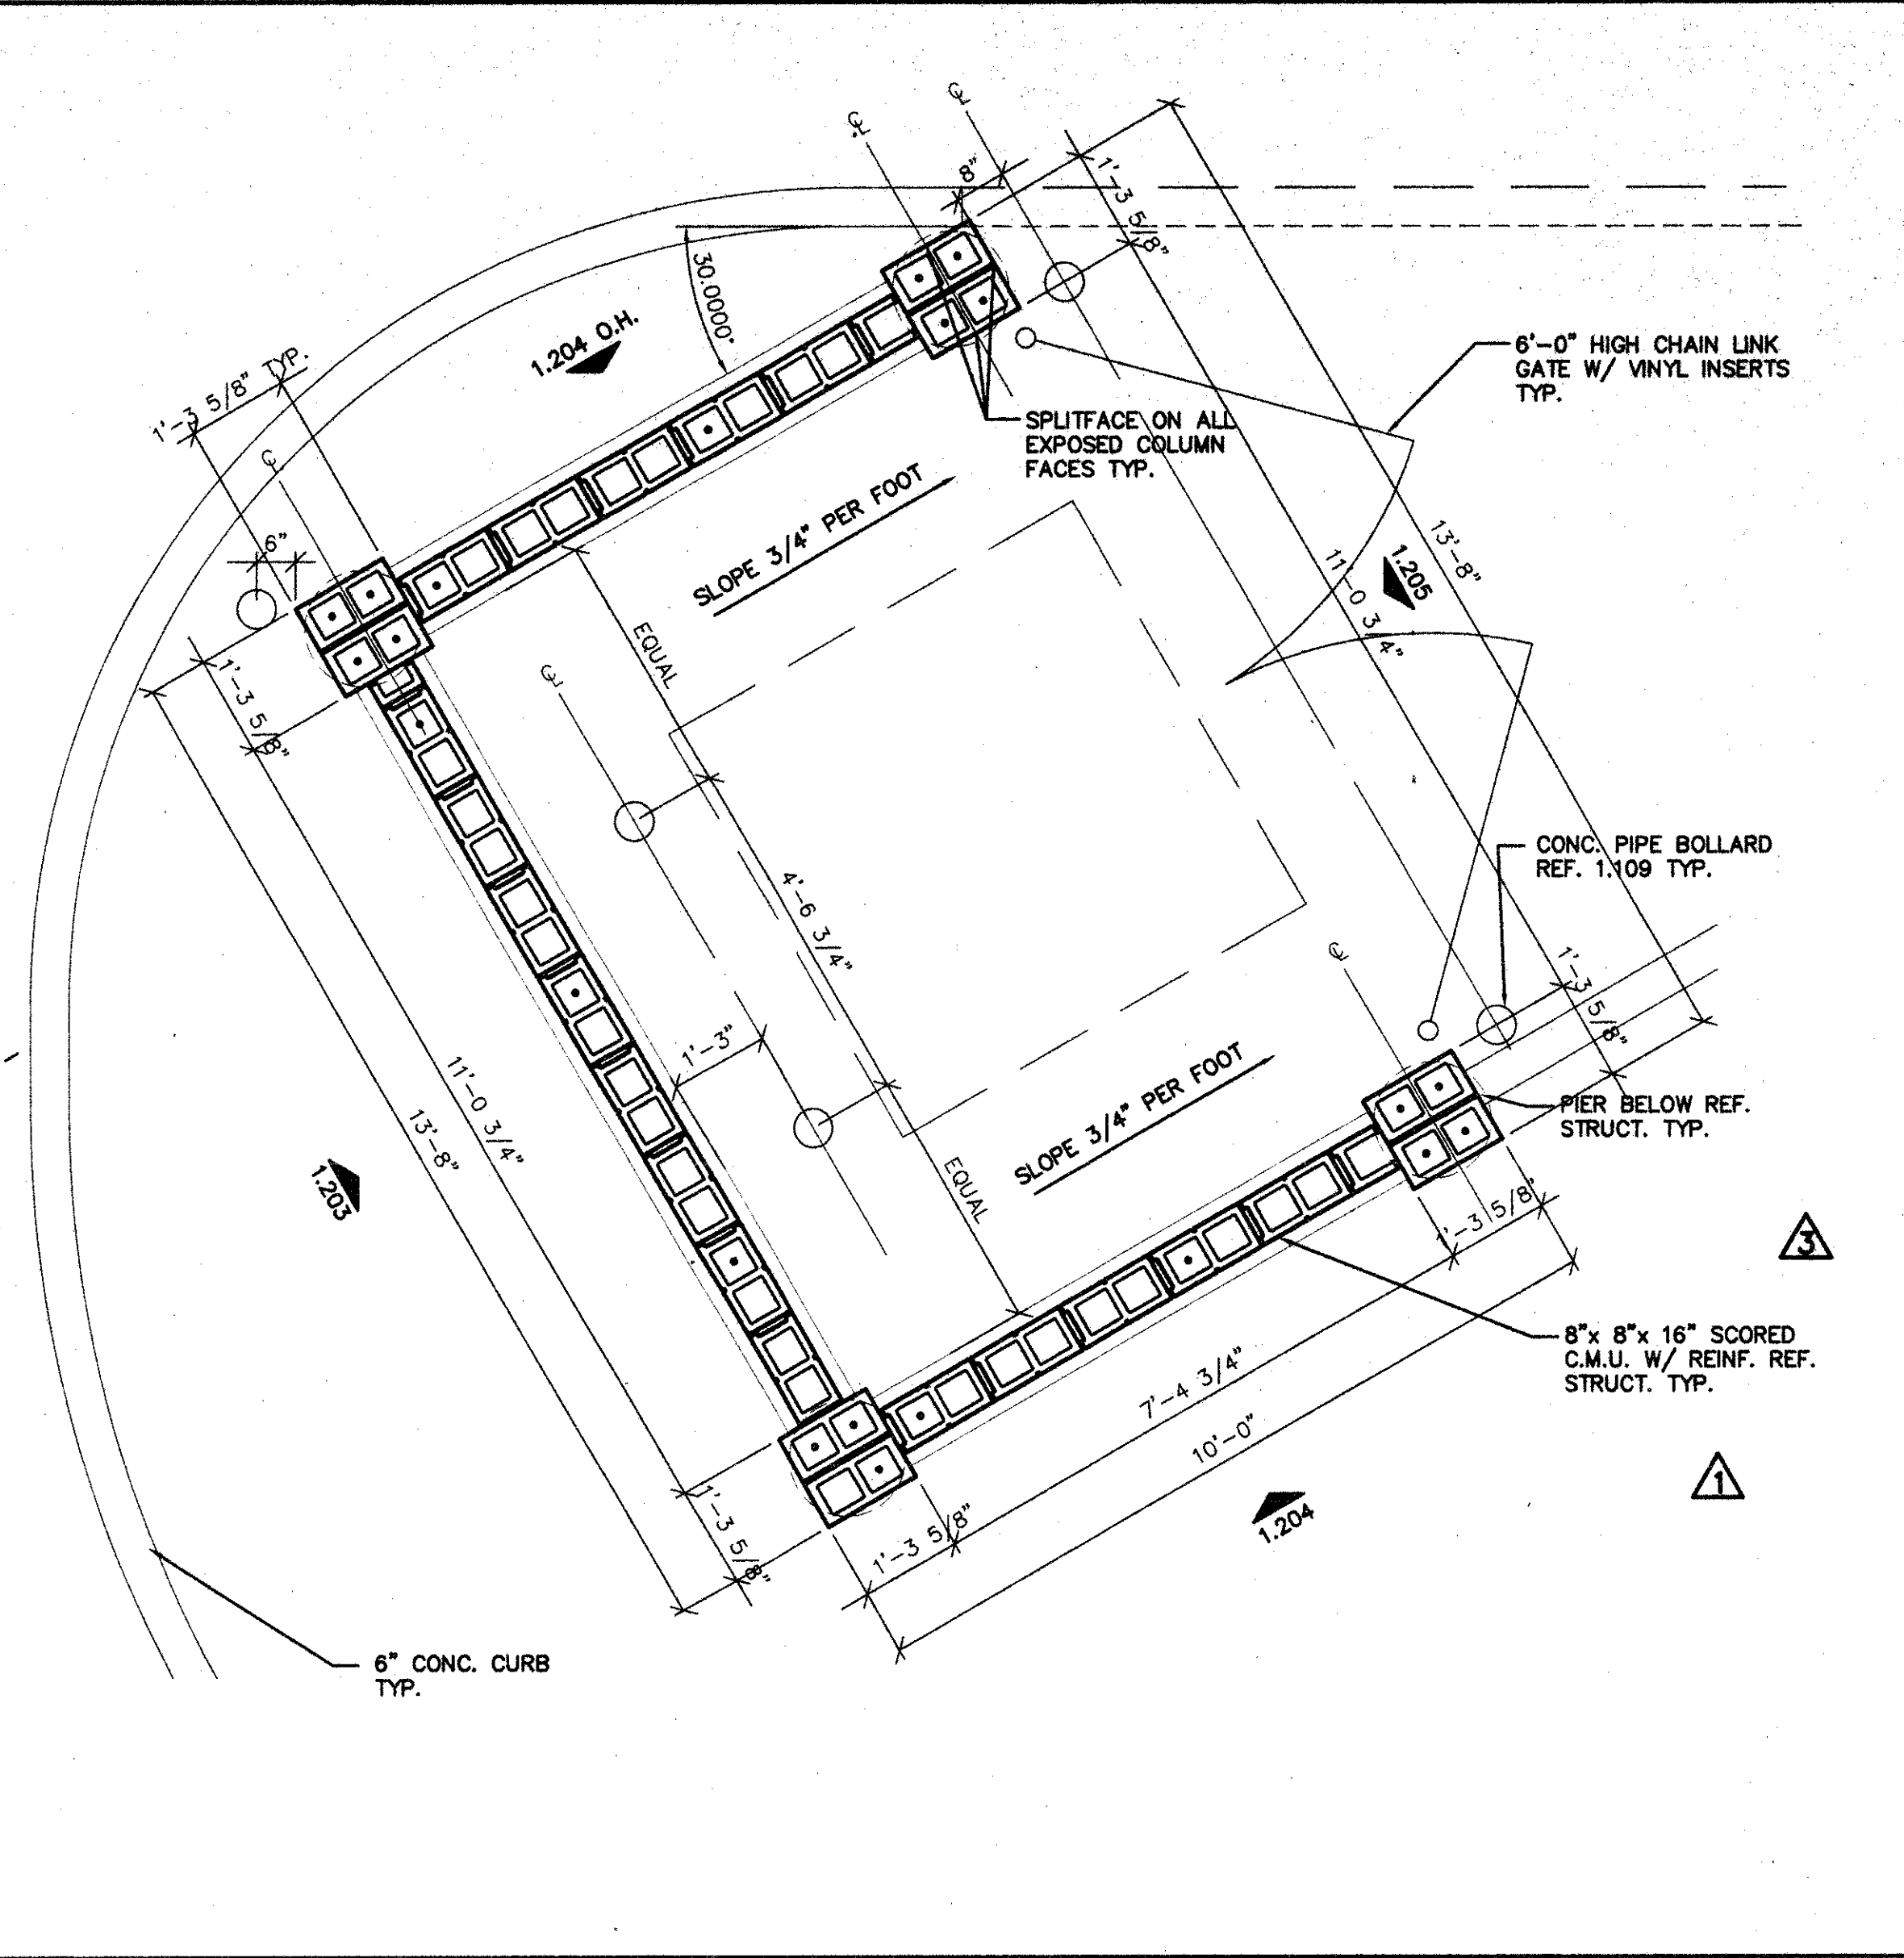

DUMPSTER PLAN SCALE: 1/2"=1'-0" 1.202

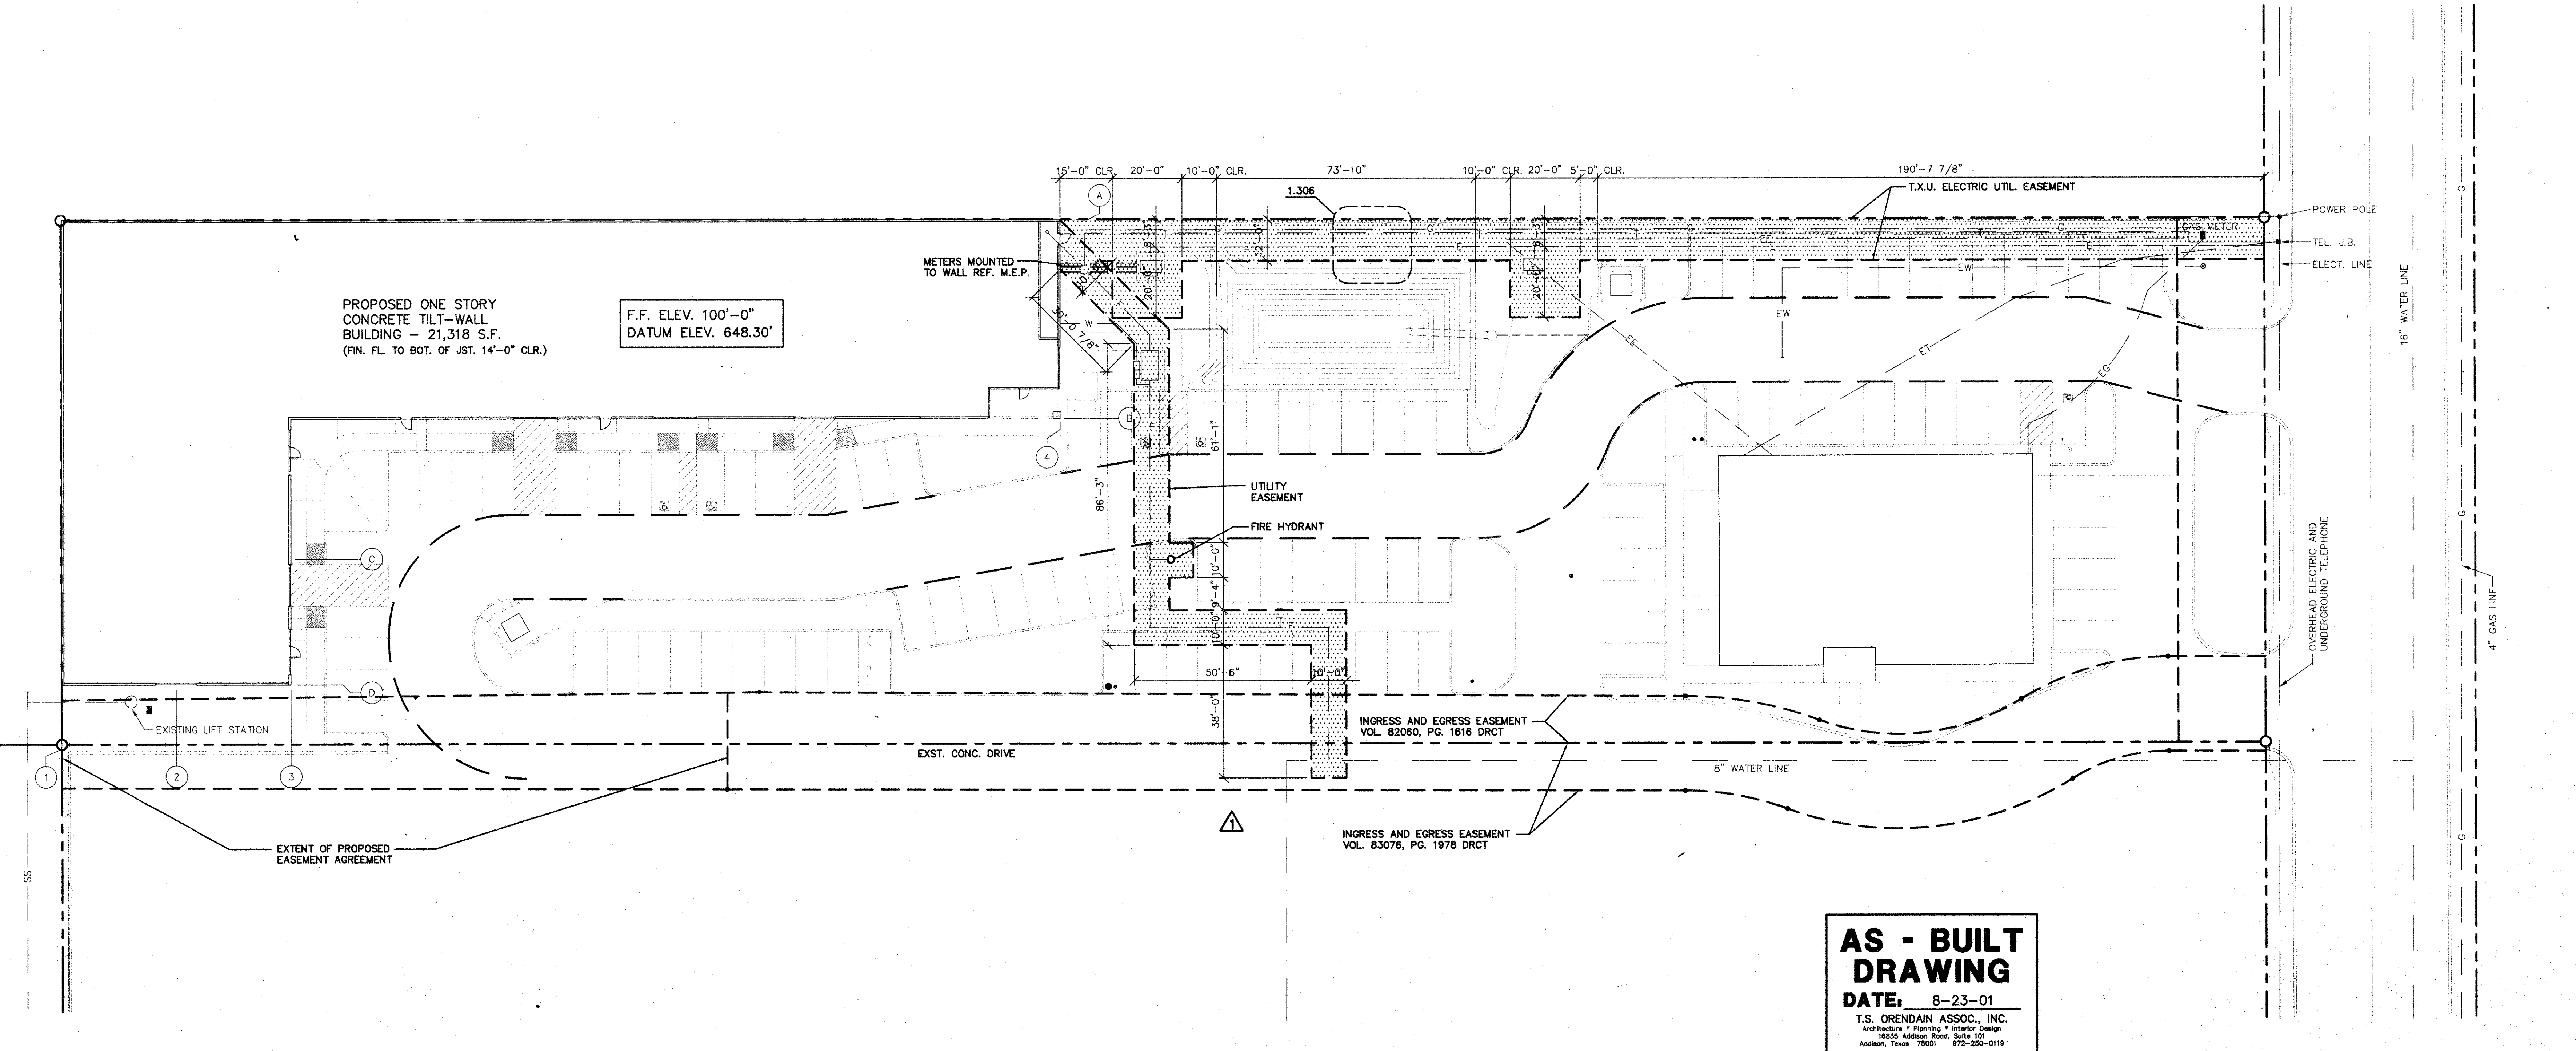


**AS - BUILT DRAWING**  
 DATE: 8-23-01  
 T.S. ORENDAIN ASSOC., INC.  
 Architecture • Planning • Interior Design  
 16835 Addison Road, Suite 101  
 Addison, Texas 75001 972-250-0119

UTILITY EASEMENT LAYOUT SCALE: 1"=20'-0" 1.201

**AMO**  
 16835 ADDISON ROAD  
 SUITE 101 ADDISON, TX 75001  
 ADDISON, TX 75001  
 FAX: 972-250-3157

**ADDISON PARK CENTRE  
 OFFICE/TECH./FLEX.  
 PHASE 1**  
 16835 ADDISON ROAD ADDISON, TEXAS

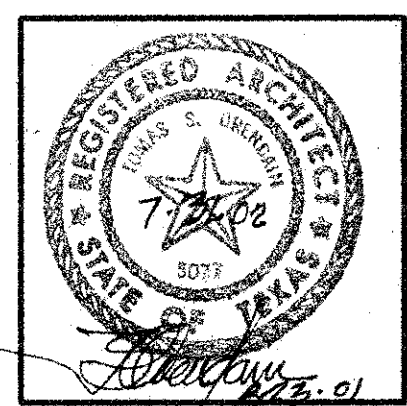


**to**  
 T.S. Orendain Associates Inc.  
 Architecture • Planning • Interior Design  
 16835 Addison Road  
 Suite 101  
 Addison, Texas 75001  
 (972) 250-0119


JOB: 8396 DATE: 2/25/2000  
 DRAWN: T.S.O. CHECKED: T.S.O.

Date	Issued For / Description
3-22-99	UTILITY EASEMENT REVISION
2-25-2000	100% ISSUED FOR CONSTRUCTION
8-9-2000	GENERAL REVISION
9-13-2000	SITE WALL REVISION


UTILITY EASEMENT LAYOUT

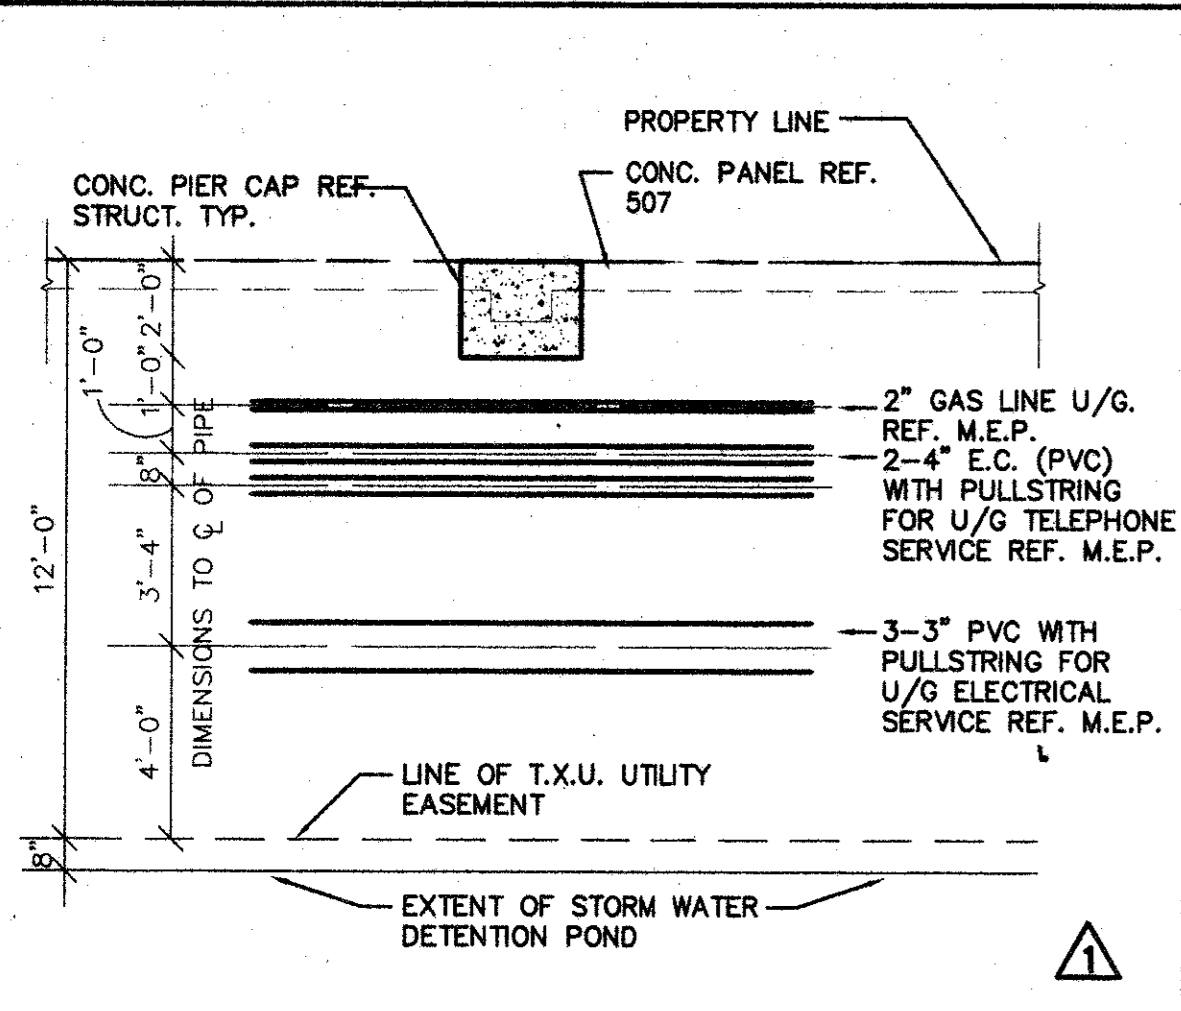


UTILITY DETAIL SCALE: 1/4"=1'-0" 1.306

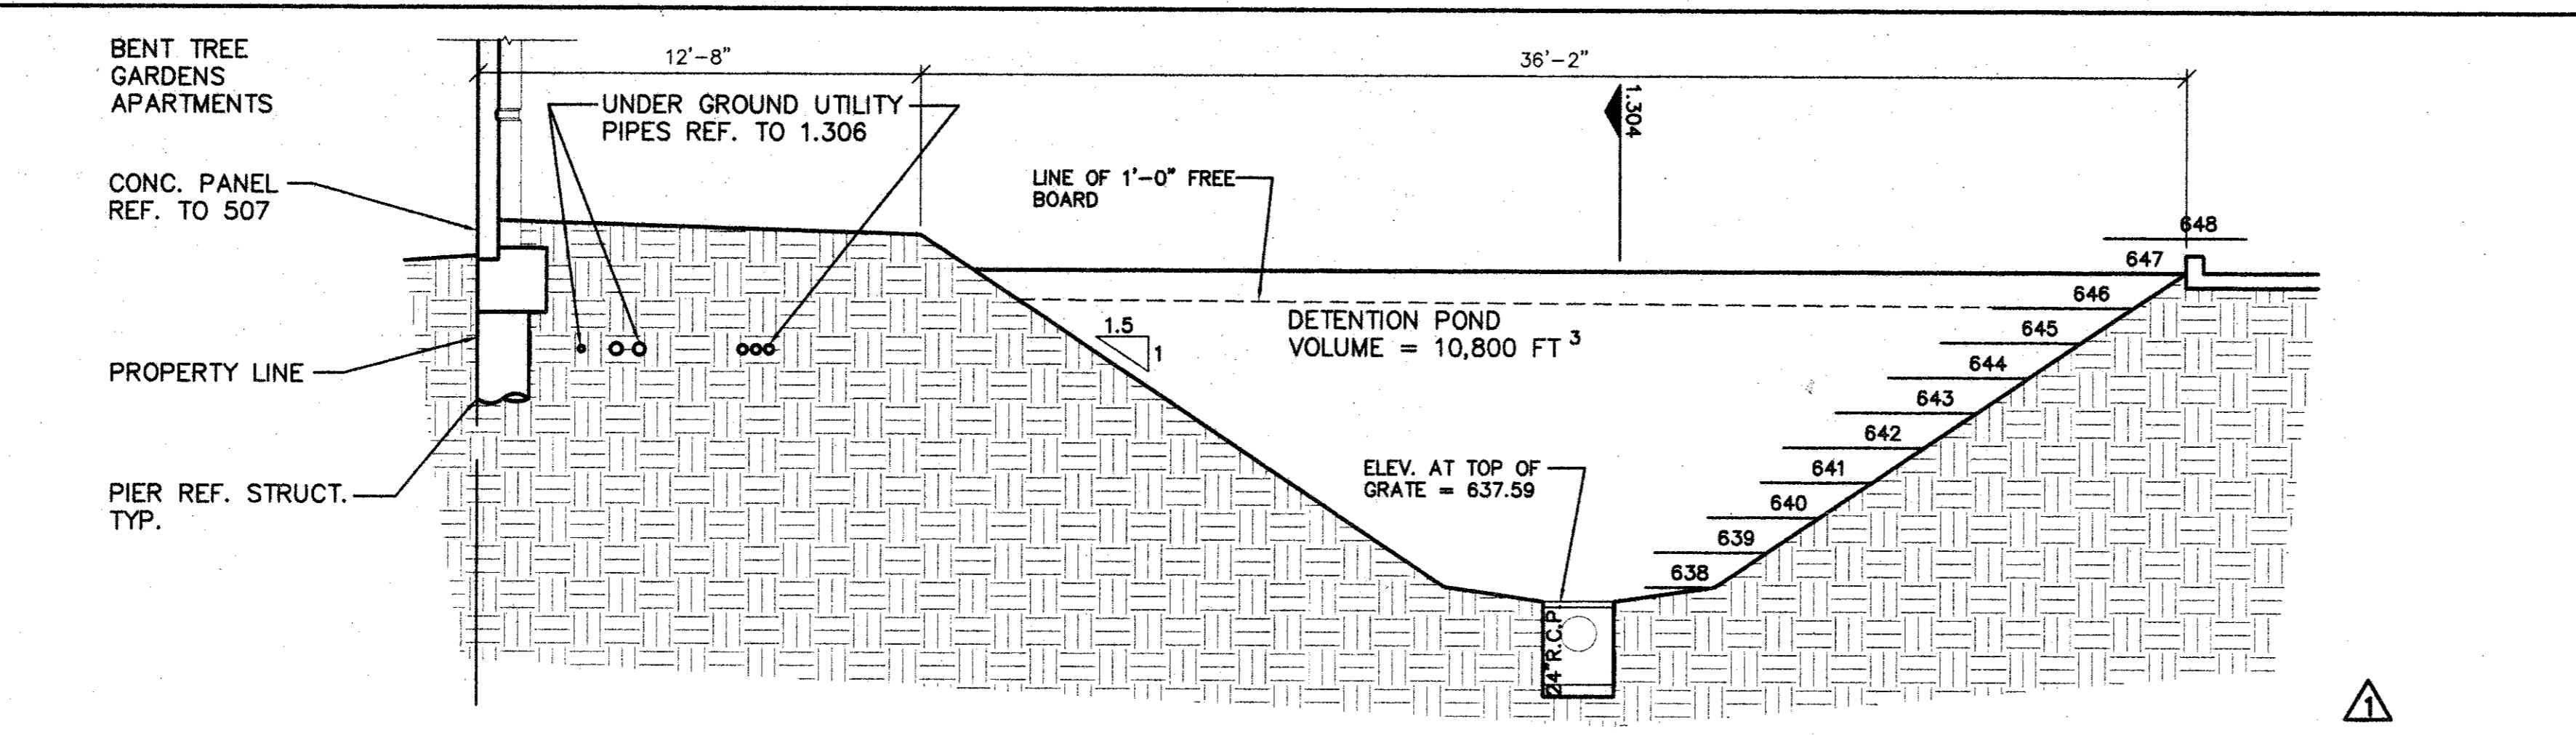


SECTION SCALE: 1/4"=1'-0" 1.305

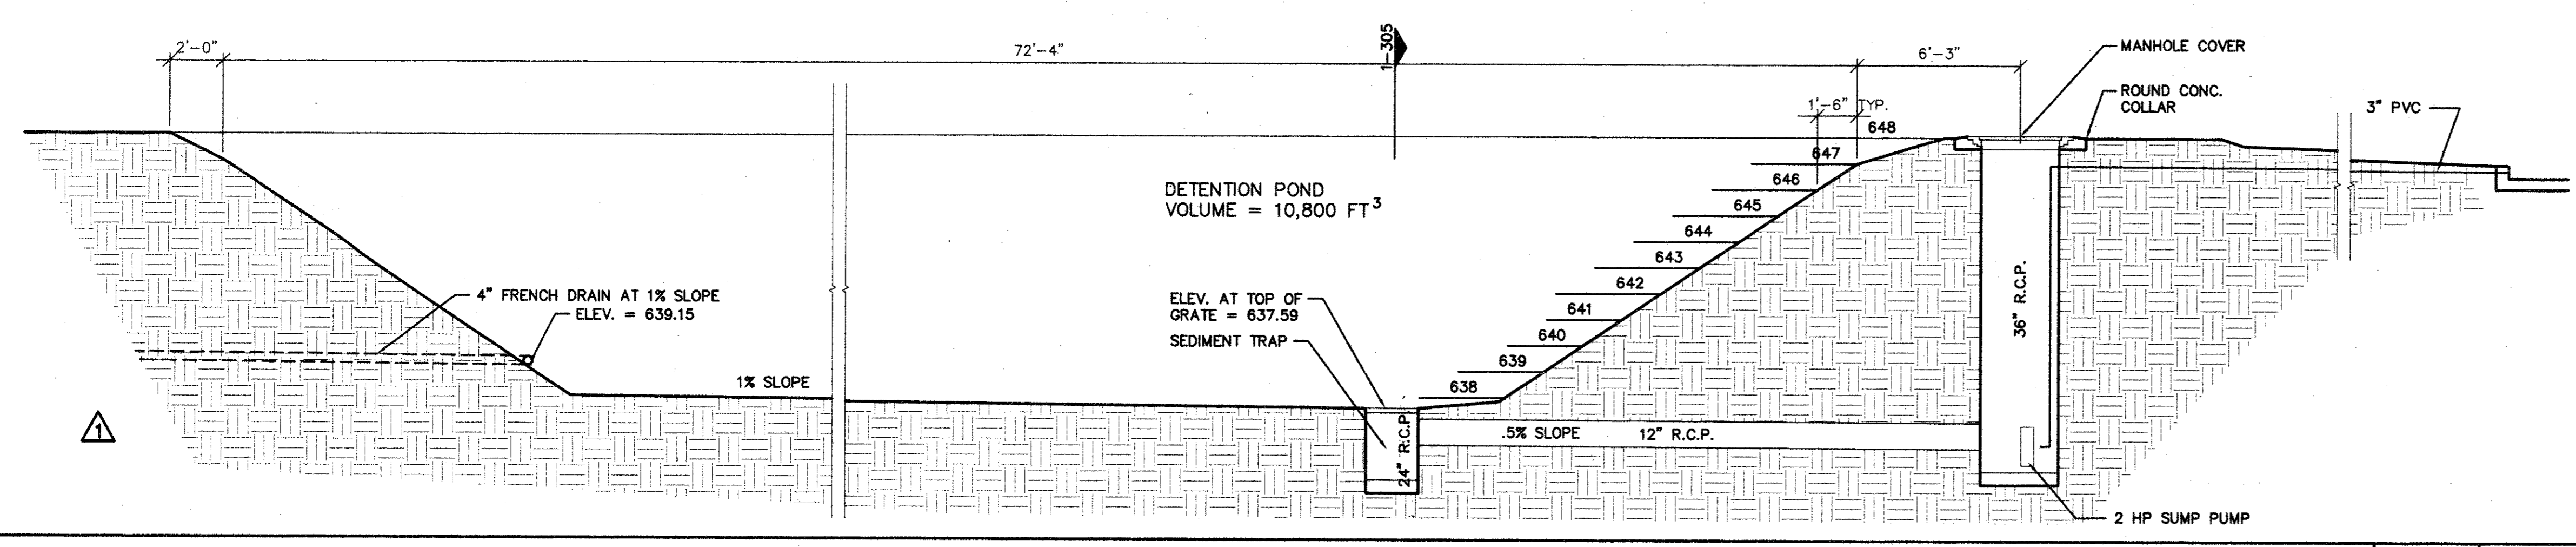


SECTION SCALE: 1/4"=1'-0" 1.304

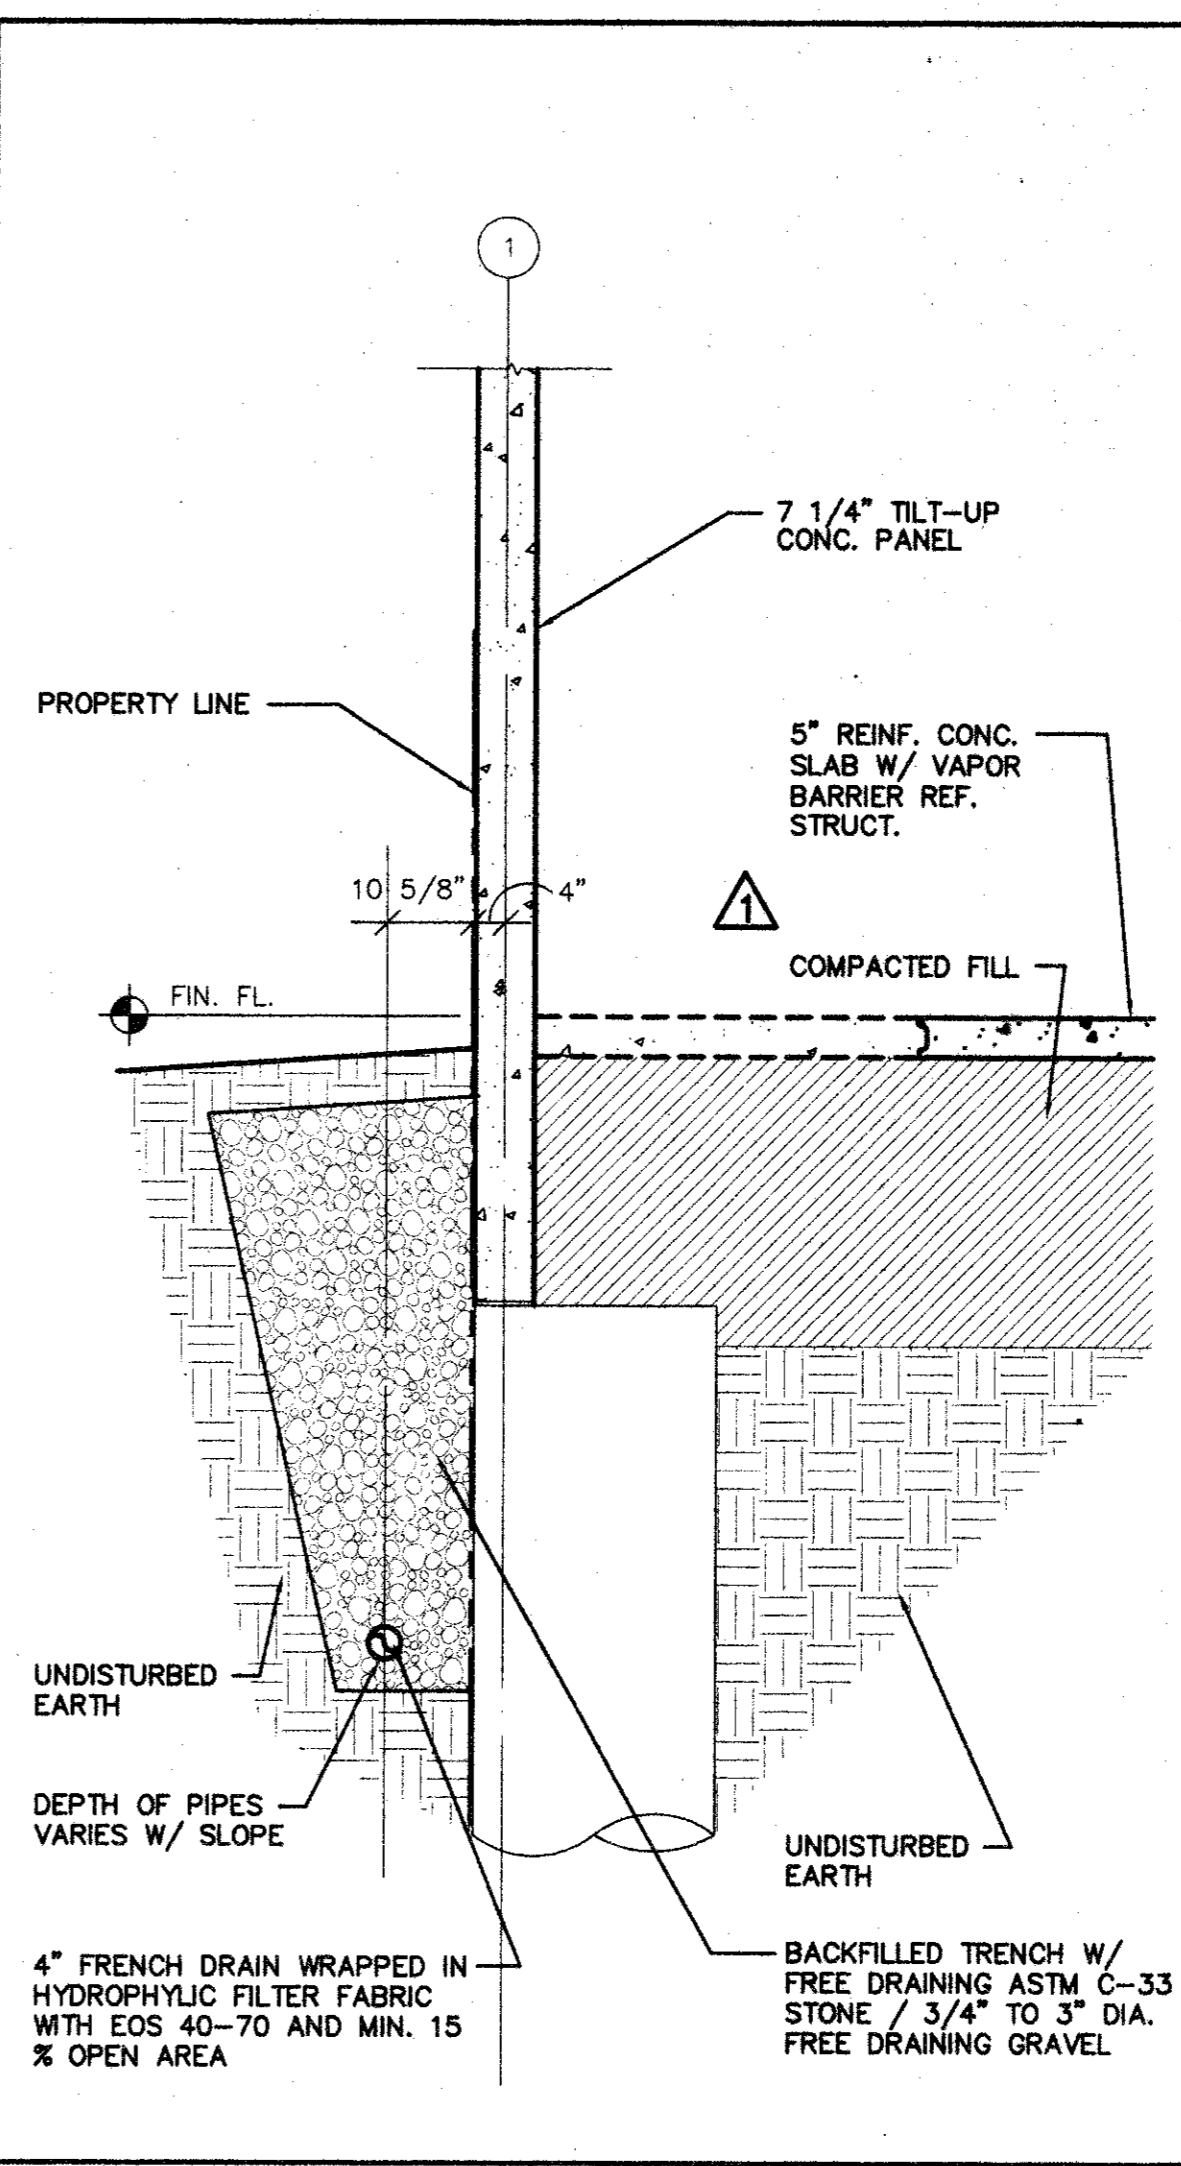

SECTION SCALE: 1/2"=1'-0" 1.303

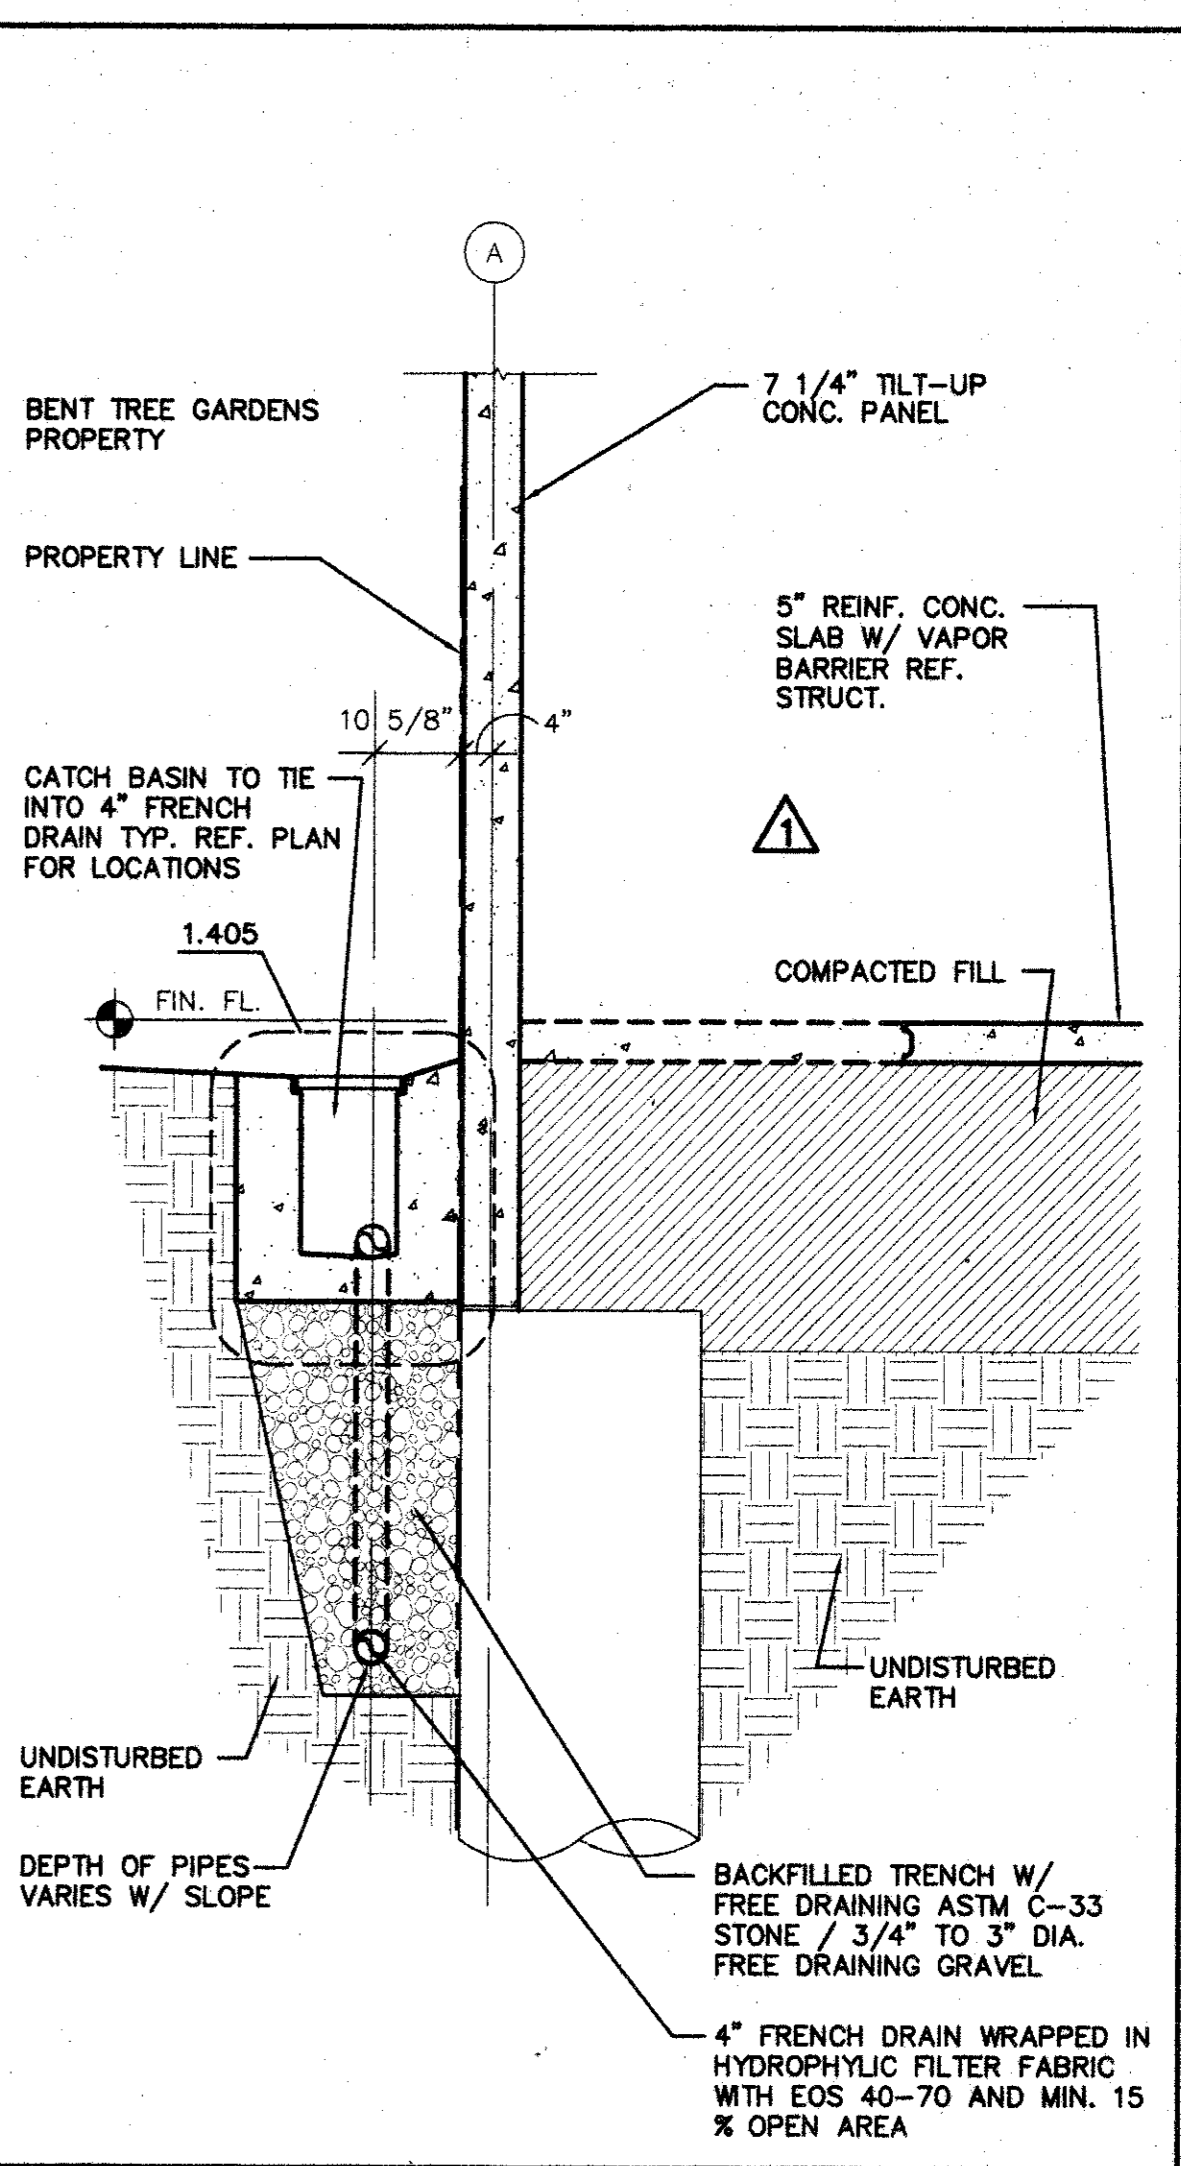

SECTION SCALE: 1/2"=1'-0" 1.302

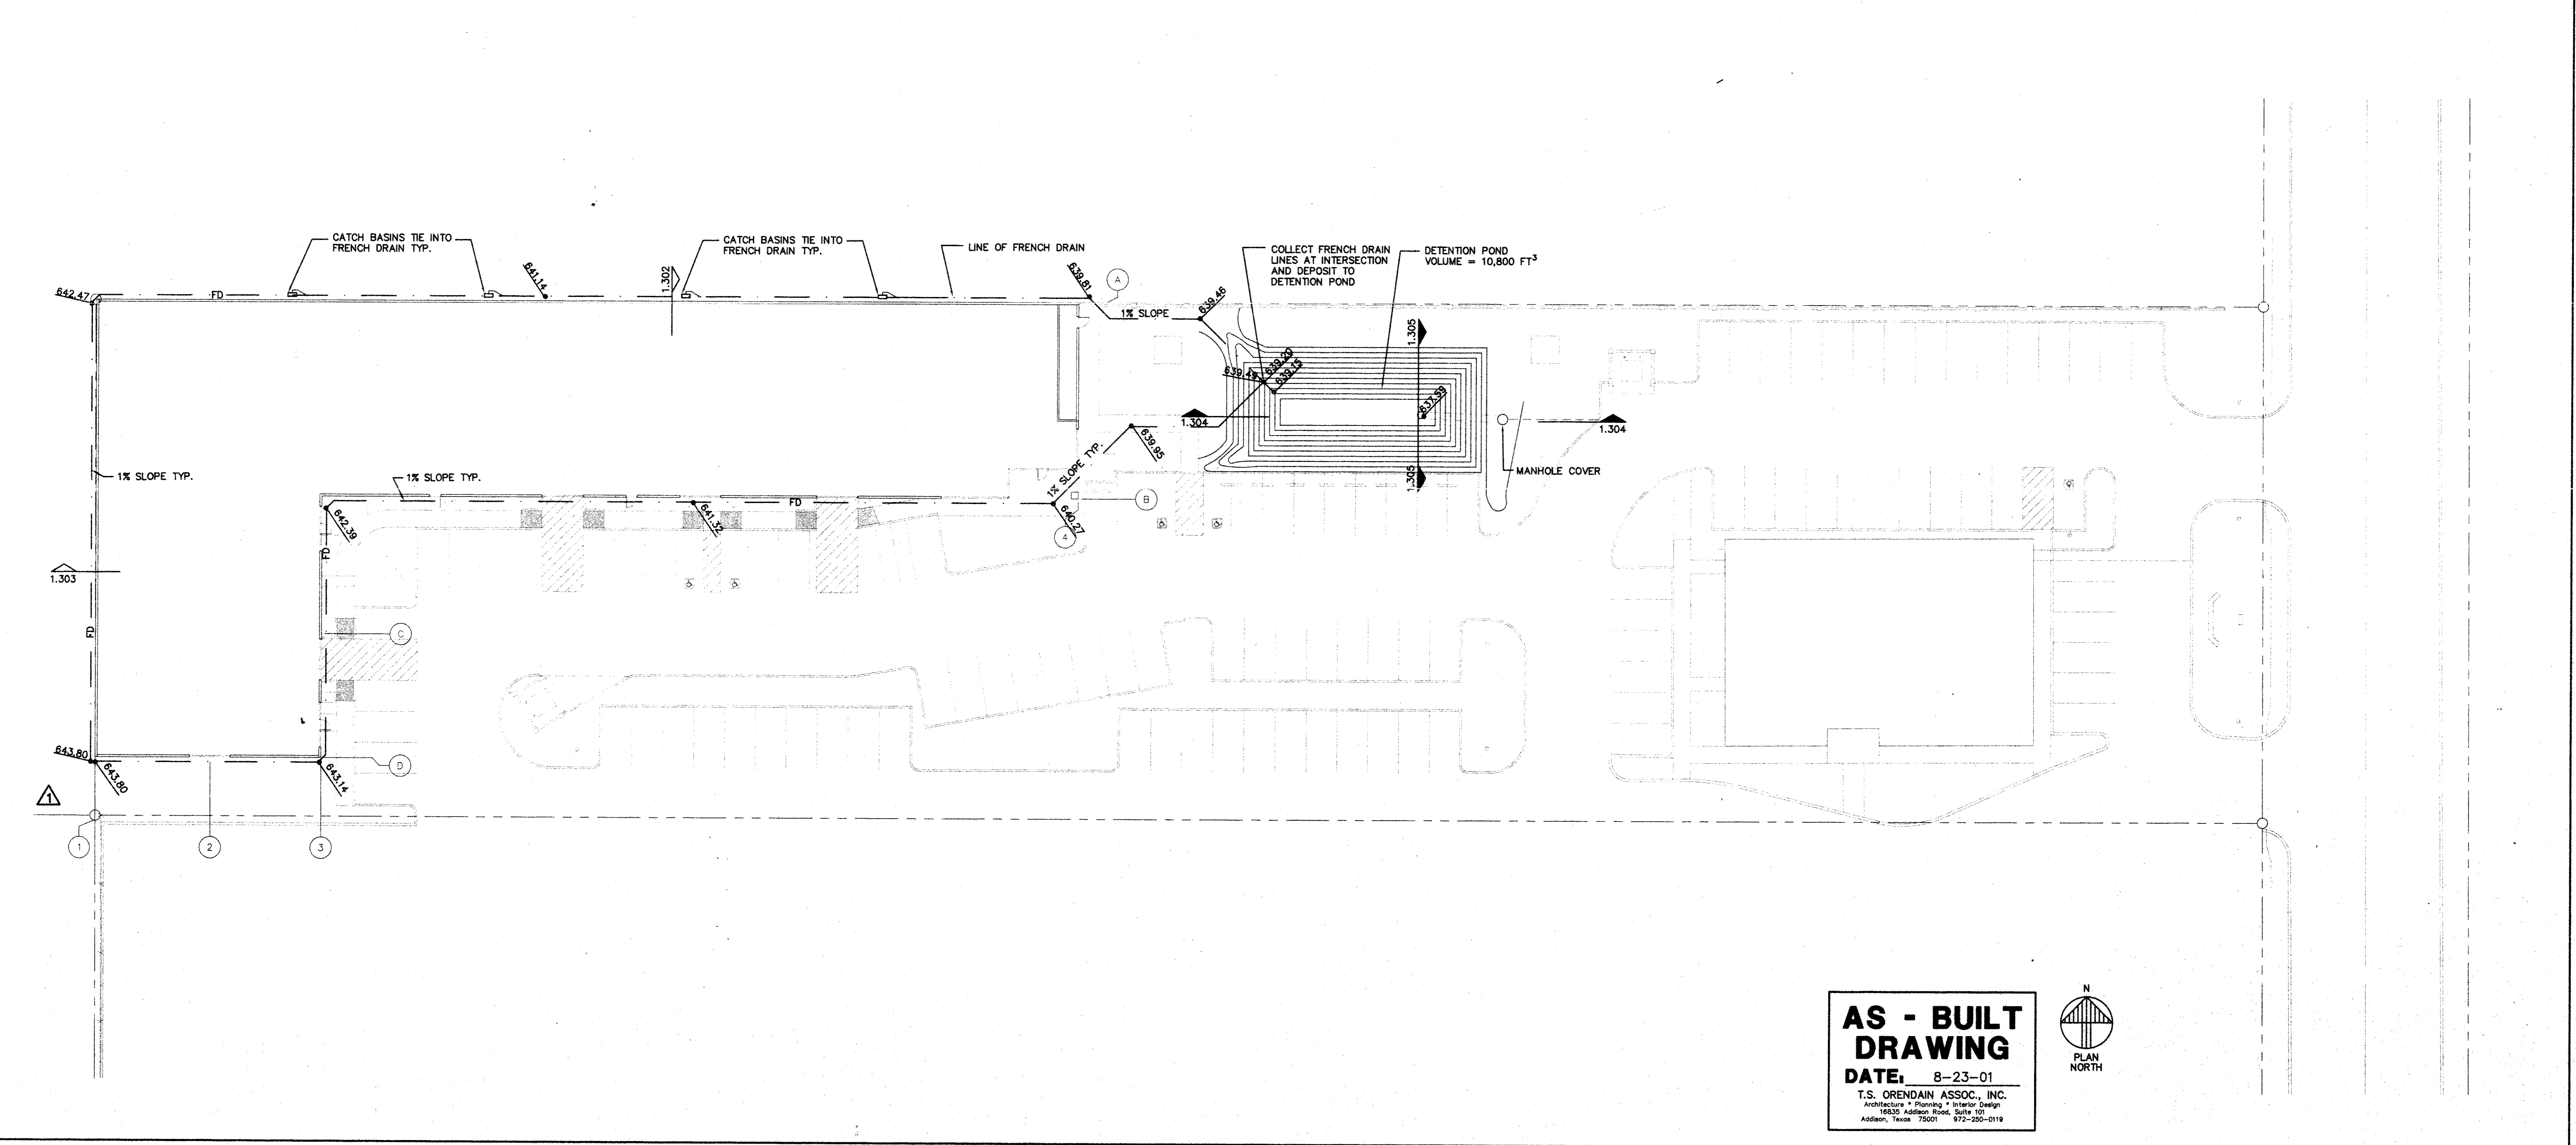


FRENCH DRAIN PLAN AND DETAILS SCALE: 1"=20'-0" 1.301

**AS - BUILT DRAWING**  
 DATE: 8-23-01  
 T.S. ORENDAIN ASSOC., INC.  
 Architecture • Planning • Interior Design  
 16835 Addison Road, Suite 101  
 Addison, Texas 75001 972-250-0119



**AMO**  
 16835 ADDISON ROAD  
 SUITE 101  
 ADDISON, TX 75001  
 PHONE: 972-250-3157  
 FAX: 972-250-3157


**ADDISON PARK CENTRE OFFICE/TECH./FLEX. PHASE 1**  
 16835 ADDISON ROAD ADDISON, TEXAS

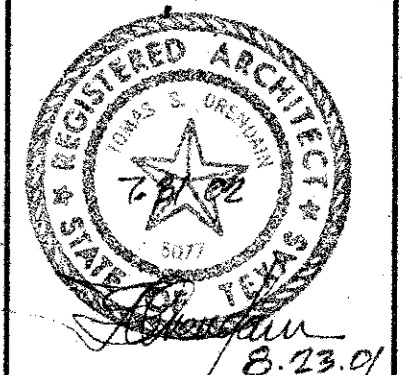

**to**  
 T.S. Orendain Associates Inc.  
 Architecture • Planning • Interior Design  
 16835 Addison Road  
 Suite 101  
 Addison, Texas 75001  
 (972) 250-0119  
 JOB: 8396 DATE: 2-25-2000  
 DRAWN: T.S.O. CHECKED: T.S.O.

Date	Issued For / Description
2-25-2000	100% ISSUED FOR CONSTRUCTION
6-9-2000	GENERAL REVISION

FRENCH DRAIN PLAN AND DETAILS

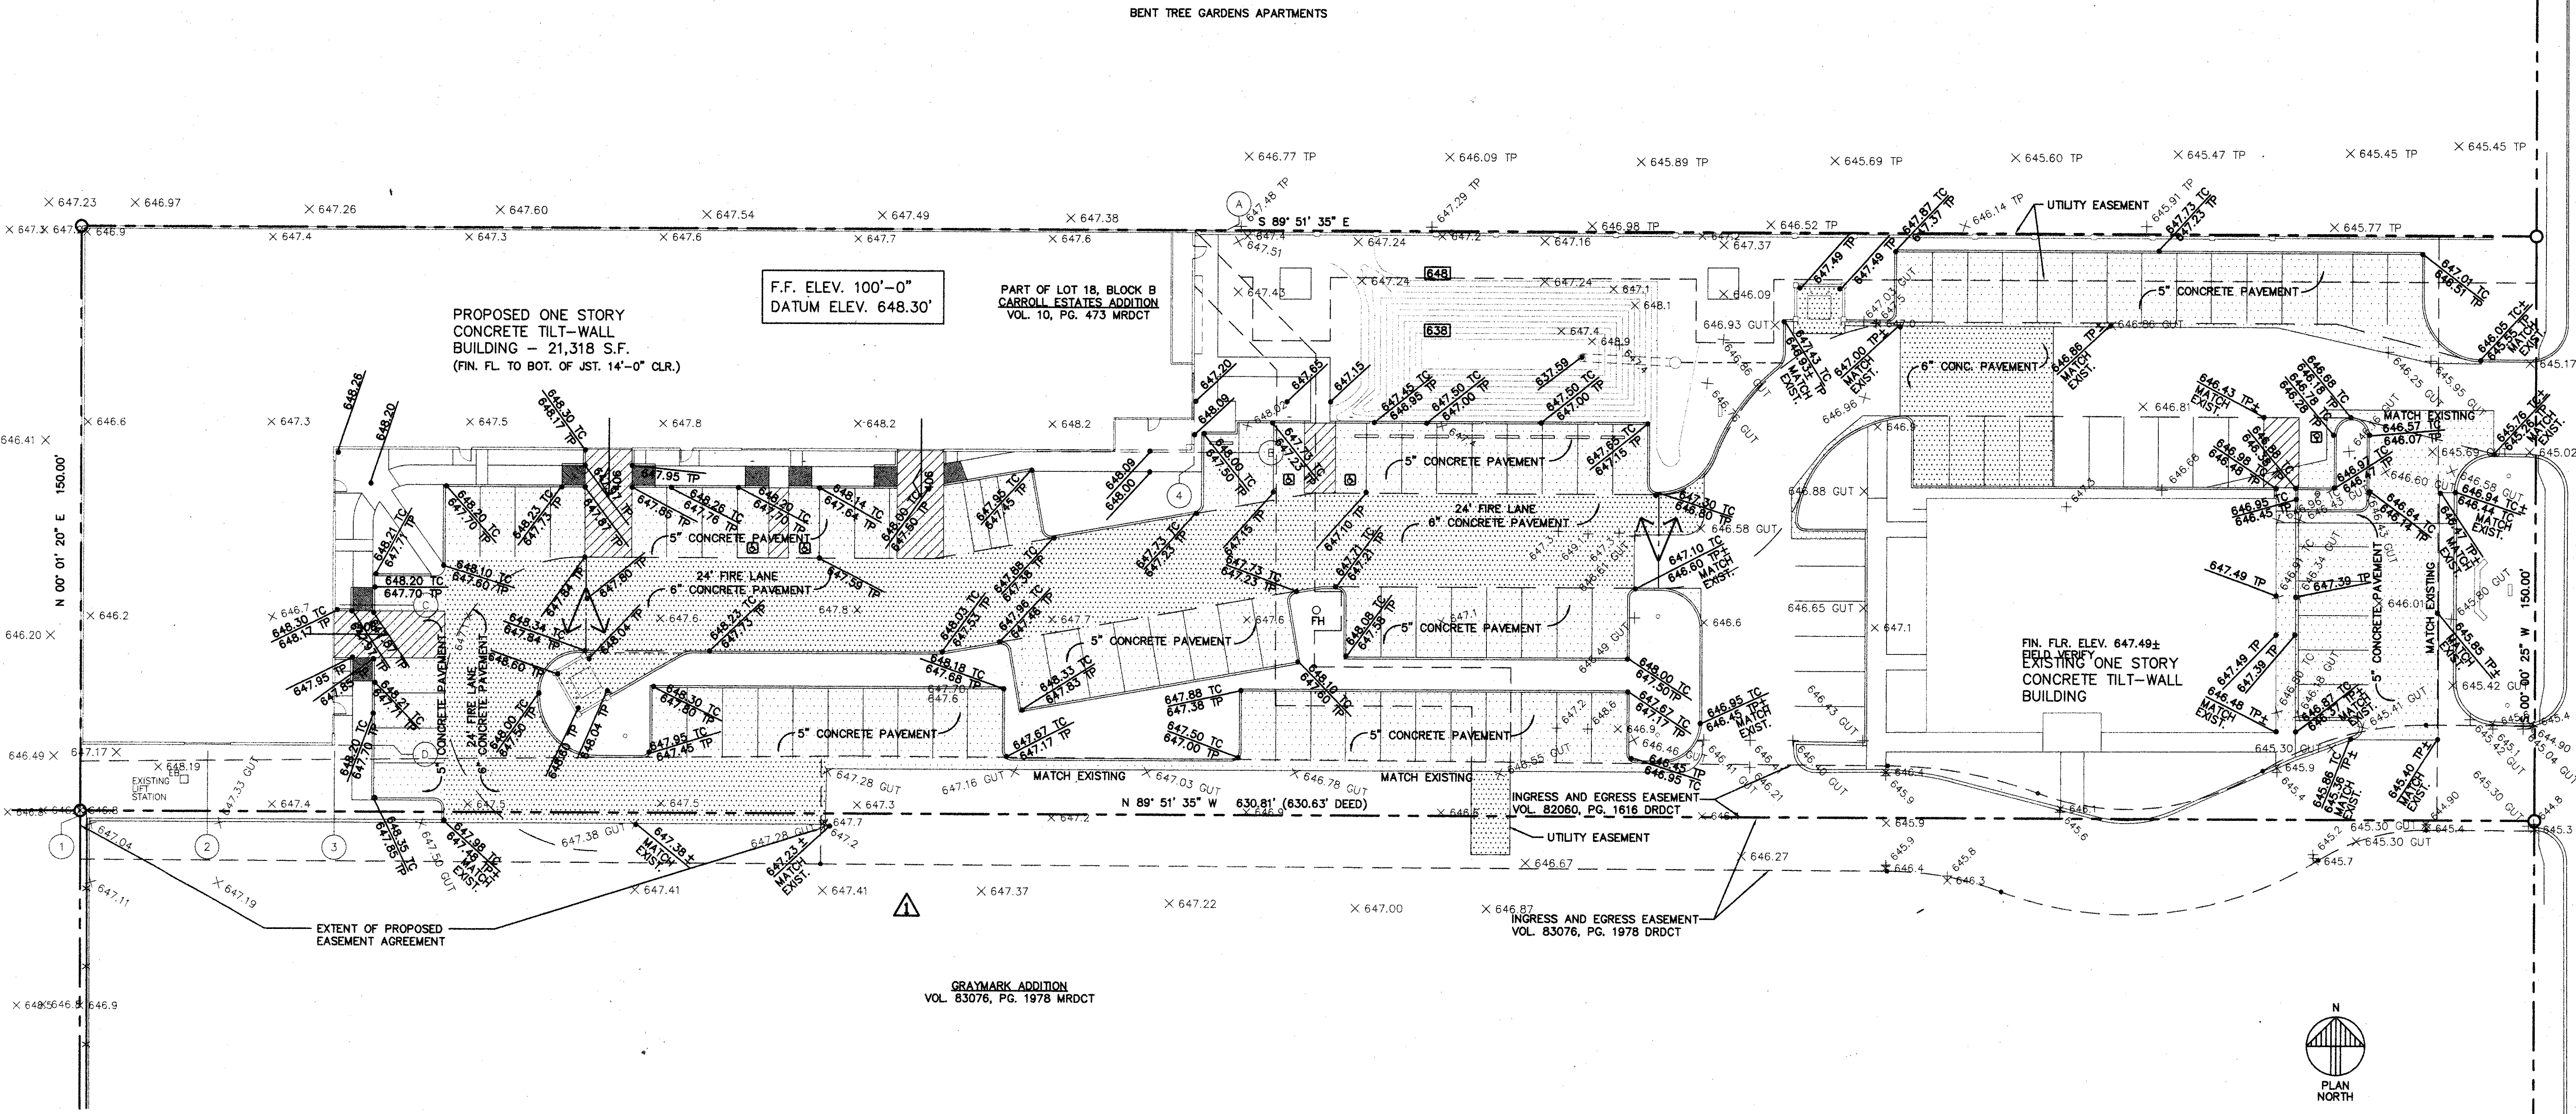

PROPOSED ONE STORY CONCRETE TILT-WALL BUILDING - 21,318 S.F. (FIN. FL. TO BOT. OF JST. 14'-0" CLR.)

F.F. ELEV. 100'-0" DATUM ELEV. 648.30'

PART OF LOT 18, BLOCK B CARROLL ESTATES ADDITION VOL. 10, PG. 473 MRDCT

FIN. FLR. ELEV. 647.49± EXISTING ONE STORY CONCRETE TILT-WALL BUILDING

GRAYMARK ADDITION VOL. 83076, PG. 1978 MRDCT

INGRESS AND EGRESS EASEMENT VOL. 82080, PG. 1616 DRDCT

UTILITY EASEMENT

INGRESS AND EGRESS EASEMENT VOL. 83076, PG. 1978 DRDCT

ADDISON ROAD




PLAN NORTH

**GRADING AND PAVEMENT PLAN** SCALE: 1"=20'-0" C105

- GENERAL NOTES**
- IT IS THE RESPONSIBILITY OF THE CONTRACTOR TO SUPPLY AND INSTALL ALL MATERIALS SO AS TO MEET OR EXCEED PROJECT SPECIFICATIONS STATE CODES, AND CITY OF ADDISON STANDARDS AND SPECIFICATIONS.
  - THE CONTRACTOR SHALL VERIFY ALL CONDITIONS AT THE JOB SITE AND NOTIFY THE OWNER'S REPRESENTATIVE OF ANY OMISSIONS, DISCREPANCIES, OR DIMENSIONAL ERRORS PRIOR TO BEGINNING OR FABRICATING ANY WORK. OTHERWISE THE CORRECTIONS (AND ASSOCIATED COST), WILL BE THE RESPONSIBILITY OF THE CONTRACTOR.
  - DIMENSIONS, LOCATIONS SHOWN, OR NOTES MARKED "VERIFY" ARE TO BE VERIFIED IN THE FIELD BY THE CONTRACTOR. REPORT ANY DISCREPANCIES TO THE OWNER'S REPRESENTATIVE PRIOR TO CONSTRUCTION.
  - ALL DEMOLITION AND EXCAVATED MATERIALS SHALL BE LEGALLY DISPOSED OFF THE SITE BY THE GENERAL CONTRACTOR.
  - IN THE EVENT THAT UNCHARTED UTILITIES OR OTHER UNFORESEEN FIELD CONDITIONS REQUIRE MODIFICATIONS OF THE DRAWINGS, THE CONTRACTOR SHALL OBTAIN THE APPROVAL OF THE OWNER'S REPRESENTATIVE BEFORE PROCEEDING WITH THE WORK.
  - THE CONTRACTOR SHALL BE RESPONSIBLE FOR PAYING AND OBTAINING PERMITS FROM THE CITY, STATE OR OTHER REGULATORY AGENCIES TO PERFORM ALL WORK.
  - ALL NEW CONCRETE PAVING SHALL HAVE A MINIMUM COMPRESSIVE STRENGTH OF 3600 P.S.I., AT 28 DAYS. CONCRETE MIX DESIGN SHALL BE PROPORTIONED WITH A MINIMUM OF 5% AIR ENTRAINMENT AND A MAXIMUM SLUMP OF 4 INCHES. COPIES OF THE PROPOSED MIX DESIGN SHALL BE SUBMITTED IN ACCORDANCE WITH THE SPECIFICATIONS, FOR APPROVAL, BEFORE PROCEEDING WITH WORK.
  - UNLESS NOTED OTHERWISE, FOR ALL CONCRETE SIDEWALKS, PROVIDE TOOLED SCORED JOINTS AT 5 FT. O.C. AND EXPANSION JOINTS WITH FILLERS AT 20 FT. O.C.
  - UNLESS OTHERWISE NOTED PROVIDE SAWCUT DUMMY JOINTS @ 15' O.C.E.W. FOR ALL CONCRETE PAVING.
  - REFER TO GEOTECHNICAL INVESTIGATION FOR PREPARATION OF SUBGRADE & BUILDING PAD.
  - REFER TO ARCHITECTURAL PLANS, FOR LANDSCAPE REQUIREMENTS. AS A MINIMUM PROVIDE HYDROMULCHED BERMUDA GRASS AT ALL GRADED AREAS NOT COVERED WITH PAVEMENT.
  - SIDESLOPES MAY BE PROTECTED BY ANY MEANS APPROVED BY THE OWNER TO INCLUDE BUT NOT TO BE LIMITED TO: "GRASSCORETE", "GEOROCK", "GRASSPAVE", GUNIT, OR REINFORCED CONCRETE RIP-RAP. THE CONTRACTOR SHALL ISSUE A 2 YEAR WARRANTY FOR WORKMANSHIP AND MATERIAL OF THE METHOD SELECTED.


- SUMP PUMP GENERAL NOTES**
- FURNISH AND INSTALL 24" AND 36" R.C.P. FOR SEDIMENT TRAP AND SUMP PUMP PIT, POUR 6" CONCRETE BOTTOMS, PROVIDE A CONCRETE COVER, REINFORCED TO ACCOMMODATE AN AUTOMOBILE WHEEL LOAD FOR THE SUMP PUMP PIT.
  - FURNISH AND INSTALL ONE SUBMERSIBLE NON-CLOG WASTEWATER PUMP. THE PUMP SHALL BE EQUIPPED WITH A 2 H.P. SUBMERSIBLE ELECTRIC MOTOR CONNECTED FOR OPERATION ON 240 VOLTS, 3 PHASE, 60 HERTZ, 4 WIRE SERVICE, WITH 20 FEET OF SUBMERSIBLE CABLE (SUBCAB) SUITABLE FOR SUBMERSIBLE PUMP APPLICATIONS. THE POWER CABLE SHALL BE SIZED ACCORDING TO NEC AND IECA STANDARDS AND ALSO MEET WITH P-MSHA APPROVAL. THE PUMP SHALL BE SUPPLIED WITH A MATING CAST IRON 3 INCH DISCHARGE CONNECTION AND BE CAPABLE OF DELIVERING 390 GPM AT 2.8 TDH. AN ADDITIONAL POINT ON THE SAME CURVE SHALL BE 320 GPM AT 8.2 FEET TOTAL HEAD. SHUT OFF HEAD SHALL 32 FEET (MINIMUM). THE PUMP SHALL BE FITTED WITH 8 FEET OF 3/16 INCH LIFTING CHAIN OR #304 STAINLESS STEEL CABLE. THE WORKING LOAD OF THE LIFTING SYSTEM SHALL BE 50% GREATER THAN THE PUMP UNIT WEIGHT. THE PUMP SHALL BE FLYGT MODEL C-3085-43B IMPELLER OR AN APPROVED EQUAL.
  - FURNISH AND INSTALL A NEMA# 12 ELECTRICAL CONTROL PANEL, EQUIPPED WITH POWER MONITOR, SURGE ARRESTOR AND RUN LIGHT. SEE ELECTRICAL DRAWINGS FOR POWER TO THE PUMP.

**AS - BUILT DRAWING**  
 DATE: 8-23-01  
 T.S. ORENDAIN ASSOC., INC.  
 Architecture • Planning • Interior Design  
 16835 Addison Road, Suite 101  
 Addison, Texas 75001 972-250-0119

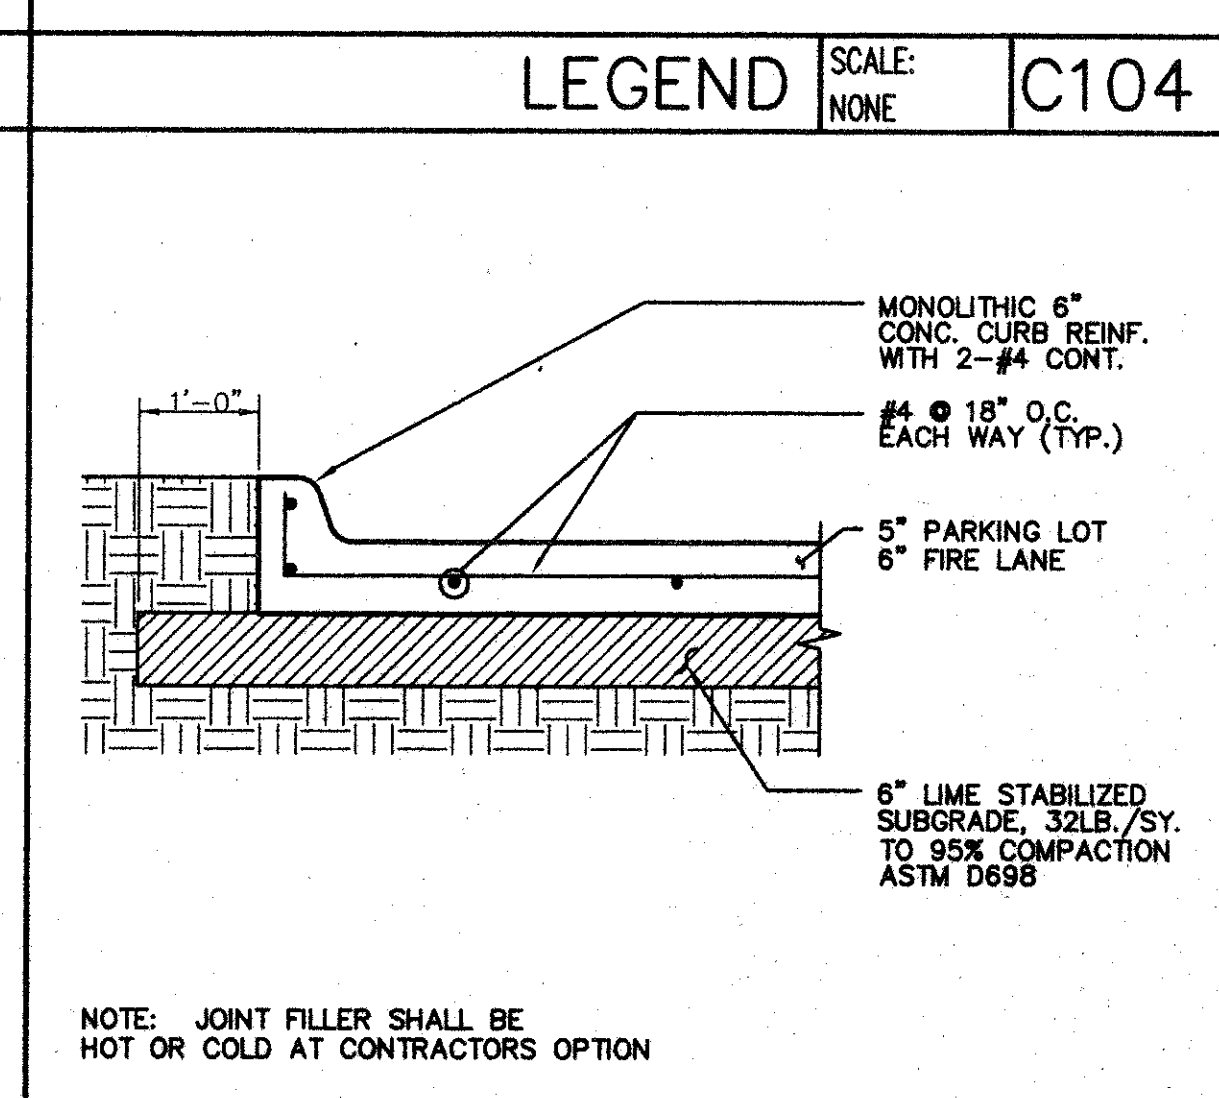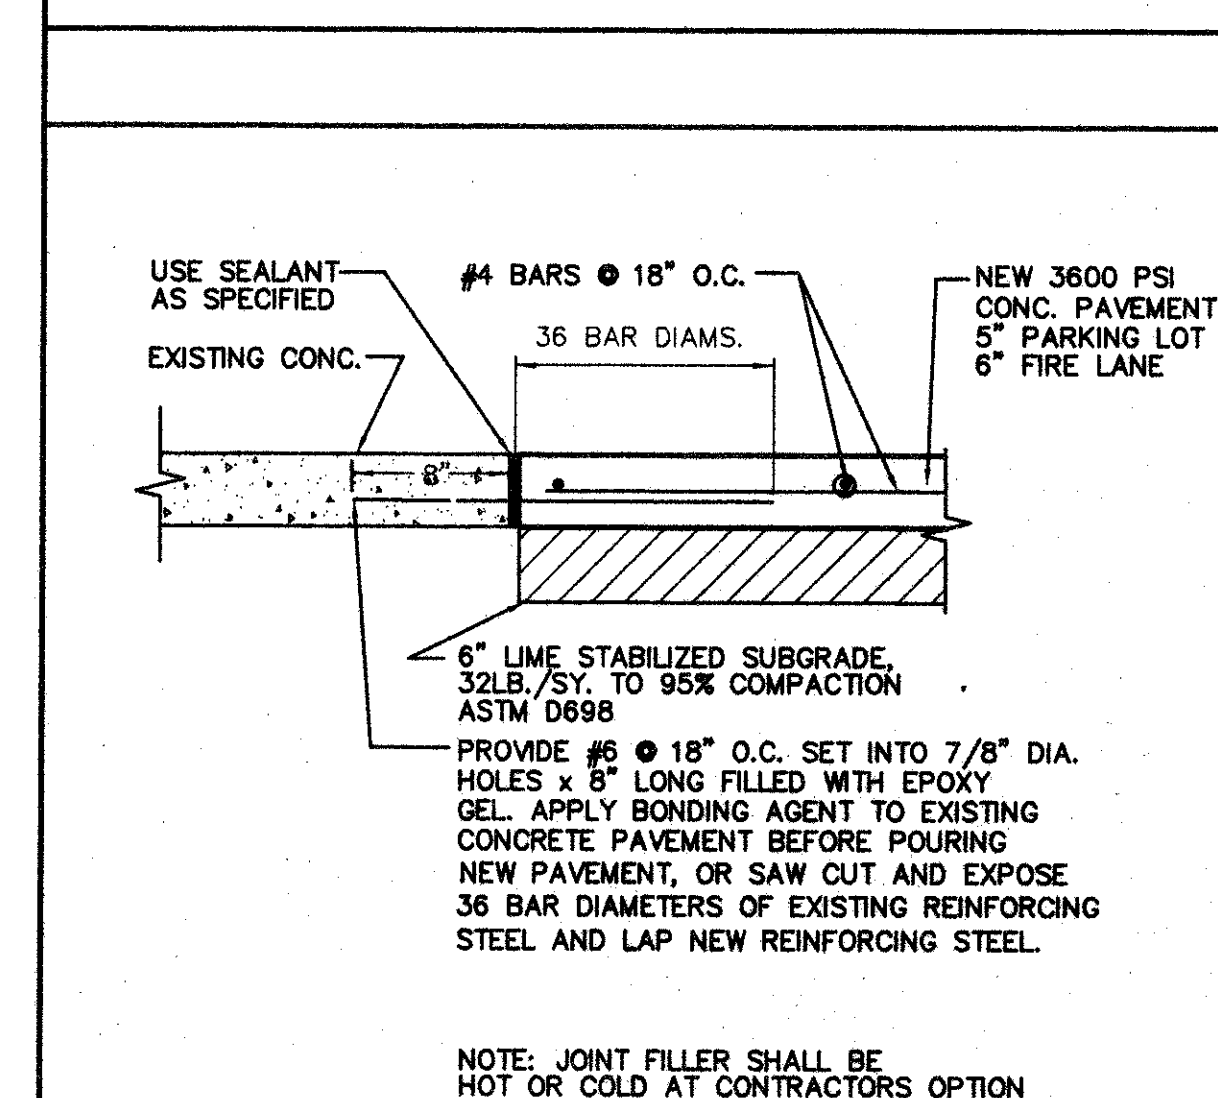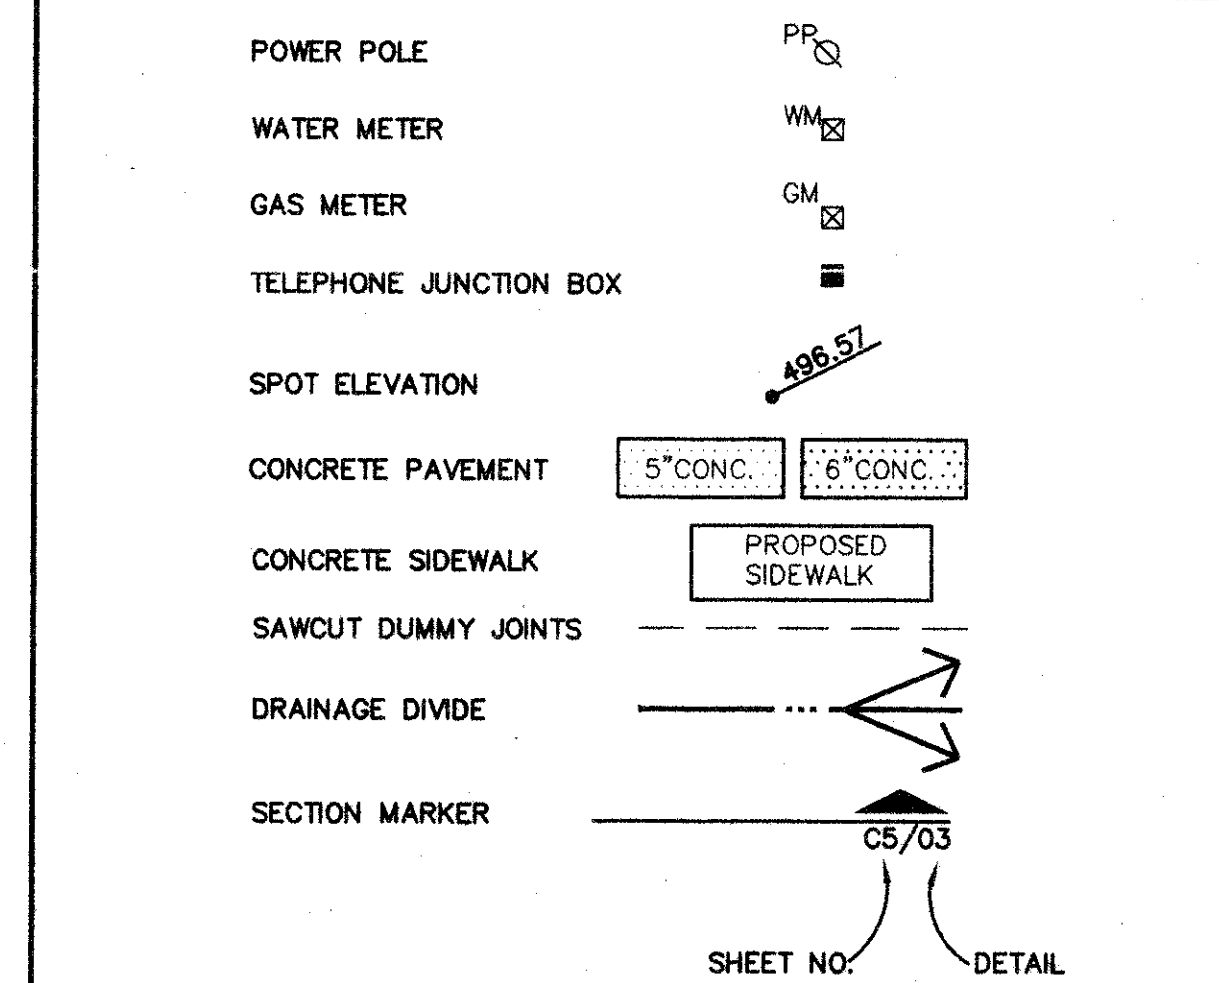

**AMO**  
 16835 ADDISON ROAD  
 SUITE 101  
 ADDISON, TX 75001  
 FAX: 972-250-3197

**ADDISON PARK CENTRE OFFICE/TECH./FLEX. PHASE 1**  
 16835 ADDISON ROAD ADDISON, TEXAS

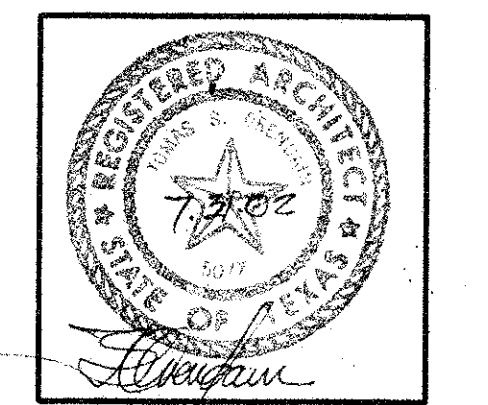

**to**  
 T.S. Orendain Associates Inc.  
 Architecture • Planning • Interior Design


16835 Addison Road  
 Suite 101  
 Addison, Texas 75001  
 (972) 250-0119

JOB: 8396 DATE: 2-25-2000  
 DRAWN: CHECKED:

Date	Issued For / Description
11-1-99	T.D.L.R.
2-25-2000	100% ISSUED FOR CONSTRUCTION
6-9-2000	GENERAL REVISION


**GRADING AND PAVEMENT PLAN**

C-1

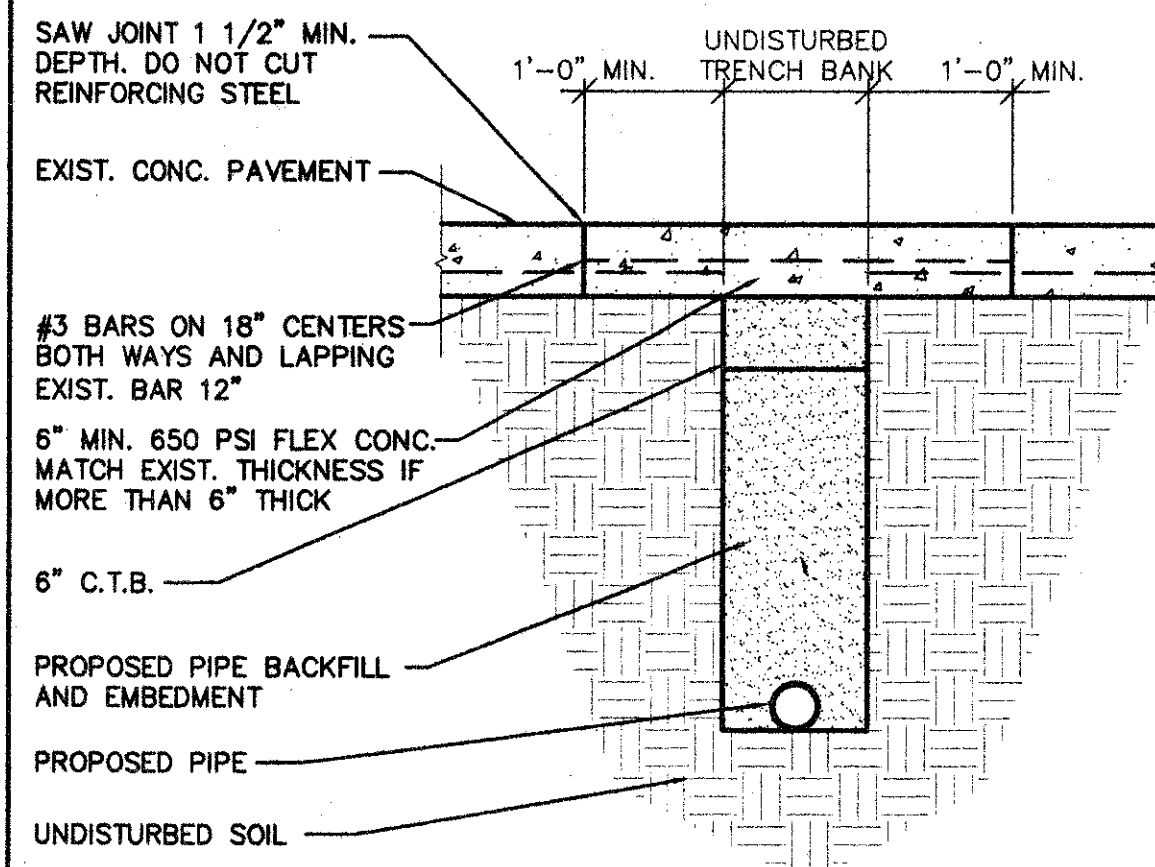

STREET REPAIR DTL. SCALE: 3/4"=1'-0" C202

CAUTION !! UNDERGROUND UTILITIES IN THIS AREA  
 CONTACT:  
 LONE STAR GAS 1-800-668-8344  
 SOUTHWESTERN BELL 1-800-395-0440  
 TEXAS UTILITY ELECTRIC (214) 812-7310  
 48 HOURS PRIOR TO CONSTRUCTION

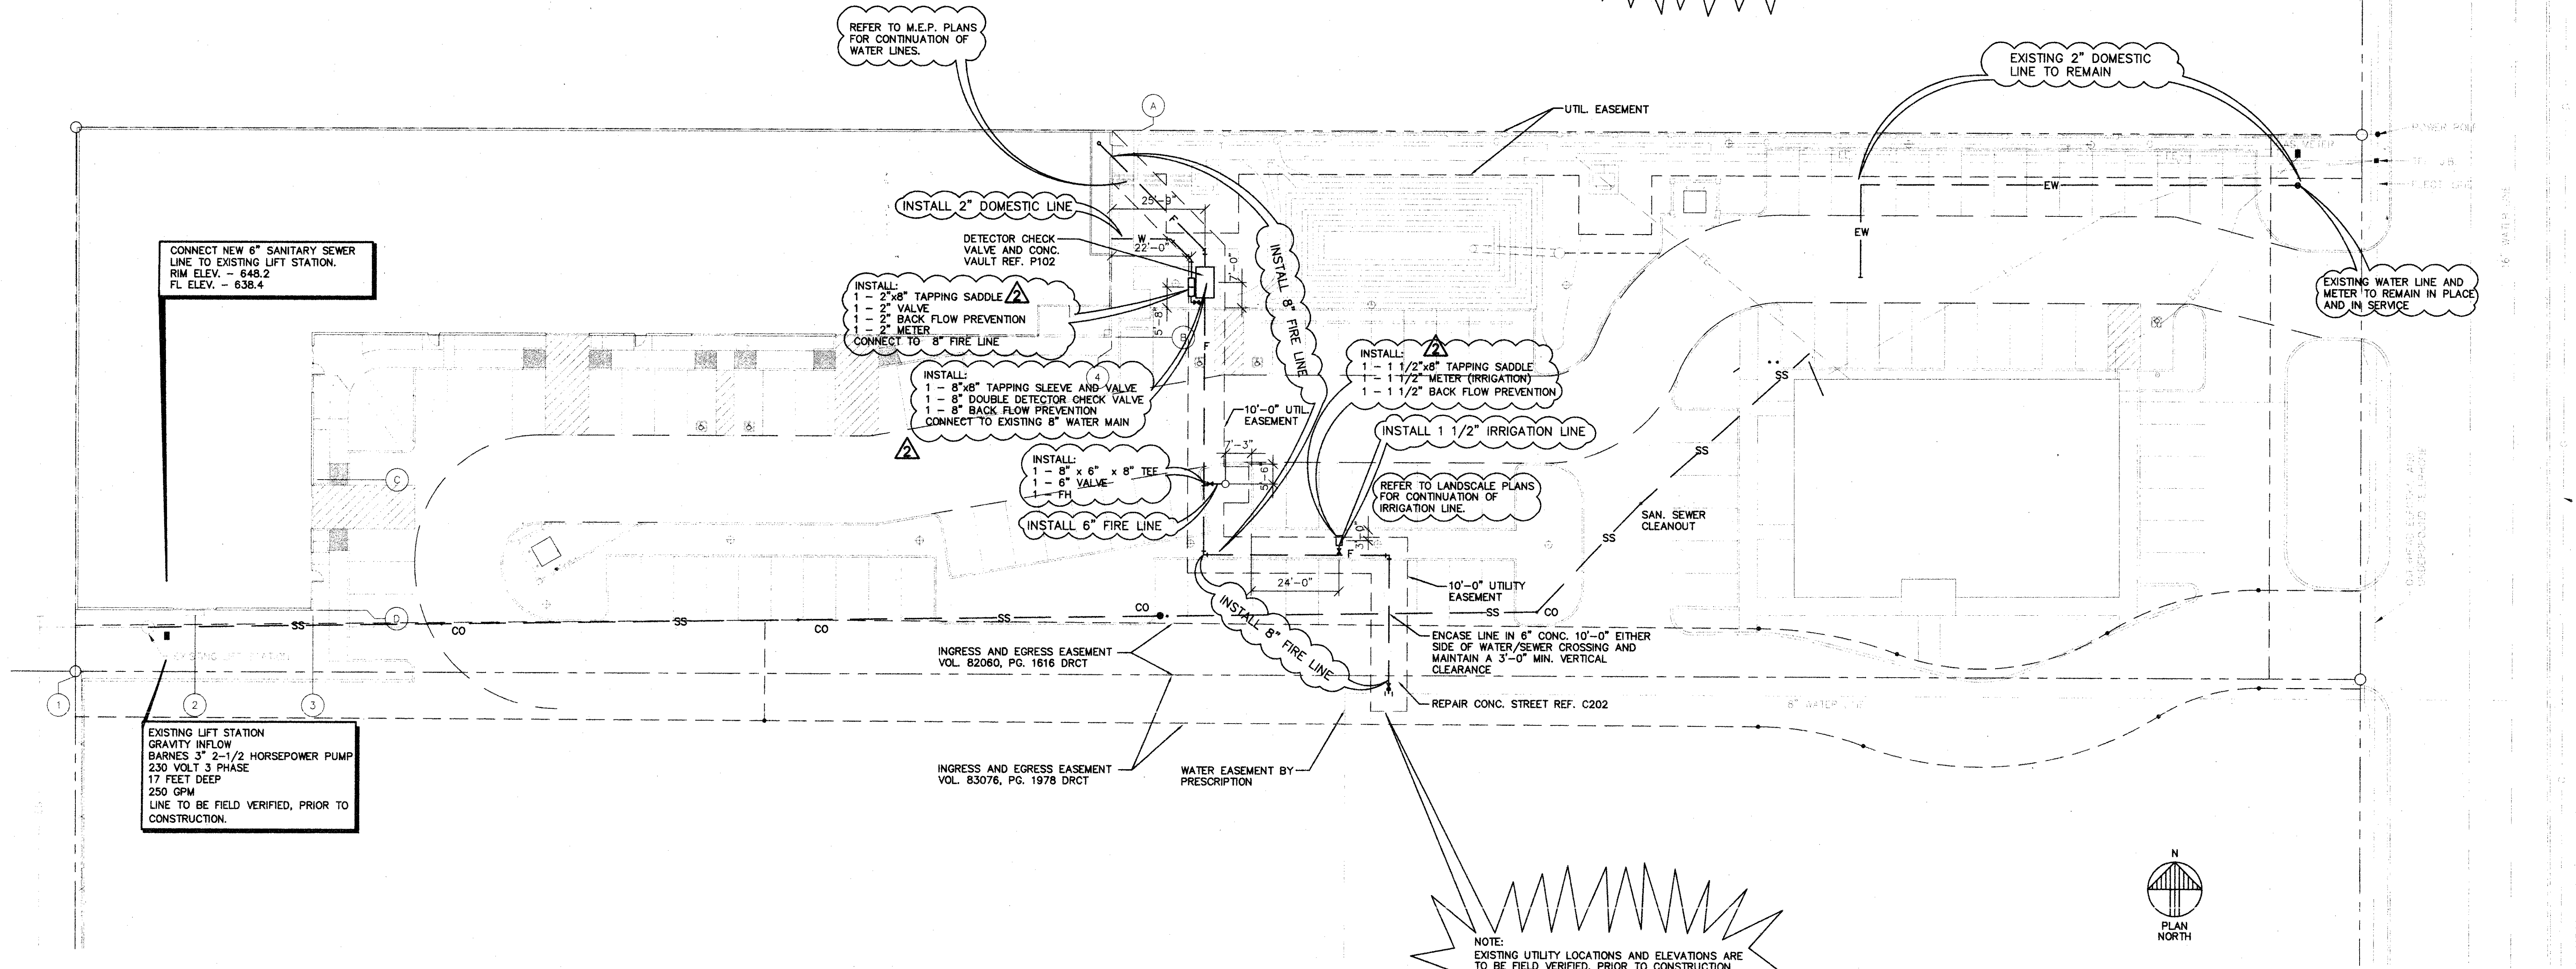

NOTE:  
 EXISTING UTILITY LOCATIONS AND ELEVATIONS ARE TO BE FIELD VERIFIED, PRIOR TO CONSTRUCTION.

**UTILITY NOTES**

- CONTRACTOR SHALL BE RESPONSIBLE FOR MAINTAINING TRENCH SAFETY REQUIREMENTS IN ACCORDANCE WITH CITY STANDARDS, TEXAS STATE LAW, AND O.S.H.A. STANDARDS FOR ALL EXCAVATION IN EXCESS OF FIVE FEET IN DEPTH.
- THE LOCATION OF ALL UTILITIES LOCATED ON THESE PLANS ARE TAKEN FROM EXISTING PUBLIC RECORDS. THE EXACT LOCATION AND ELEVATION OF ALL PUBLIC UTILITIES MUST BE DETERMINED BY THE CONTRACTOR. IT SHALL BE THE DUTY OF THE CONTRACTOR TO ASCERTAIN WHETHER ANY ADDITIONAL FACILITIES OTHER THAN THOSE SHOWN ON THE PLANS MAY BE PRESENT.
- IT WILL BE THE RESPONSIBILITY OF THE CONTRACTOR TO PROTECT ALL PUBLIC UTILITIES IN THE CONSTRUCTION OF THIS PROJECT.
- ANY UTILITY INSTALLED OUTSIDE OF AN EASEMENT SHALL BE INSTALLED BY A LICENSED PLUMBER AND INSPECTED BY CODE ENFORCEMENT.
- BACKFILL FOR UTILITY LINES SHALL BE 95% DENSITY STD. PROCTOR.
- IF ROCK IS ENCOUNTERED IN THE TRENCH, ROCK SPOIL SHALL NOT BE USED IN THE UPPER 1.5 FEET OF THE TRENCH. THE UPPER 1.5 FEET OF THE TRENCH IS TO BE BACKFILLED ONLY WITH QUALITY SELECT FILL.
- WATER MAINS SHALL BE CLASS 50 OR 51 CEMENT LINED DUCTILE IRON; EXCEPT WHERE NOTED OTHERWISE. ALTERNATE: C900 PVC CLASS 200, DR-14, WATER PIPE.
- ALL WATER MAINS SHALL HAVE A MINIMUM COVER OF 48", OR SUFFICIENT COVER TO CLEAR OTHER UTILITIES AS MEASURED FROM TOP OF PIPE TO EXISTING GROUND LEVEL OR FINISHED GRADE, WHICHEVER IS GREATER.
- ALL GATE VALVES SHALL BE CITY APPROVED.
- CONCRETE BLOCKING SHALL BE PROVIDED ON WATER MAINS AT ALL TEES, FIRE HYDRANTS, AND BENDS PER TOWN OF ADDISON STANDARDS.
- FIRE SPRINKLER LINE SHALL BE SIZED AND INSTALLED BY A STATE LICENSED FIRE SPRINKLER CONTRACTOR.
- ALL WATER METERS TO BE PLACED IN A NON-TRAFFIC AREA.
- SEWER PIPE SHALL BE MINIMUM SDR-35 PVC, OR ULTRA-RIB PVC. WHERE DEPTH OF COVER IS LESS THAN 3.5 FEET.
- IT IS THE RESPONSIBILITY OF THE CONTRACTOR TO LOCATE ALL EXISTING UTILITIES.

**LEGEND**


- WATER METER
- TEE
- WATER VALVE
- 90° BEND
- SANITARY SEWER LINE
- WATER LINE

**AS - BUILT DRAWING**  
 DATE: 8-23-01  
 T.S. ORENDAIN ASSOC., INC.  
 Architecture • Planning • Interior Design  
 16835 Addison Road, Suite 101  
 Addison, Texas 75001 972-250-0119

UTILITY SITE PLAN SCALE: 1"=20'-0" C201

**AMO**  
 16835 ADDISON ROAD  
 SUITE 101  
 ADDISON, TX 75001  
 TEL: 972-250-3157  
 FAX: 972-250-3157

**ADDISON PARK CENTRE OFFICE/TECH./FLEX. PHASE 1**  
 16835 ADDISON ROAD ADDISON, TEXAS

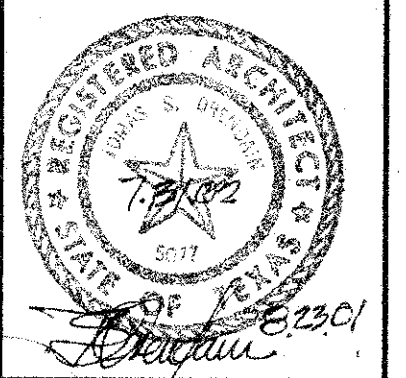



**to**  
 T.S. Orendain Associates Inc.  
 Architecture • Planning • Interior Design

16835 Addison Road  
 Suite 101  
 Dallas, Texas 75248  
 (972) 250-0119

JOB: 8398 DATE: 6-2-00  
 DRAWN: CHECKED:


Date	Issued For / Description	T.D.L.R.
11-1-99	100% ISSUED FOR CONSTRUCTION	
2-25-2000	GENERAL REVISION	
6-9-2000	REVISION PER CITY COMMENTS	
9-11-2000		

UTILITY SITE PLAN

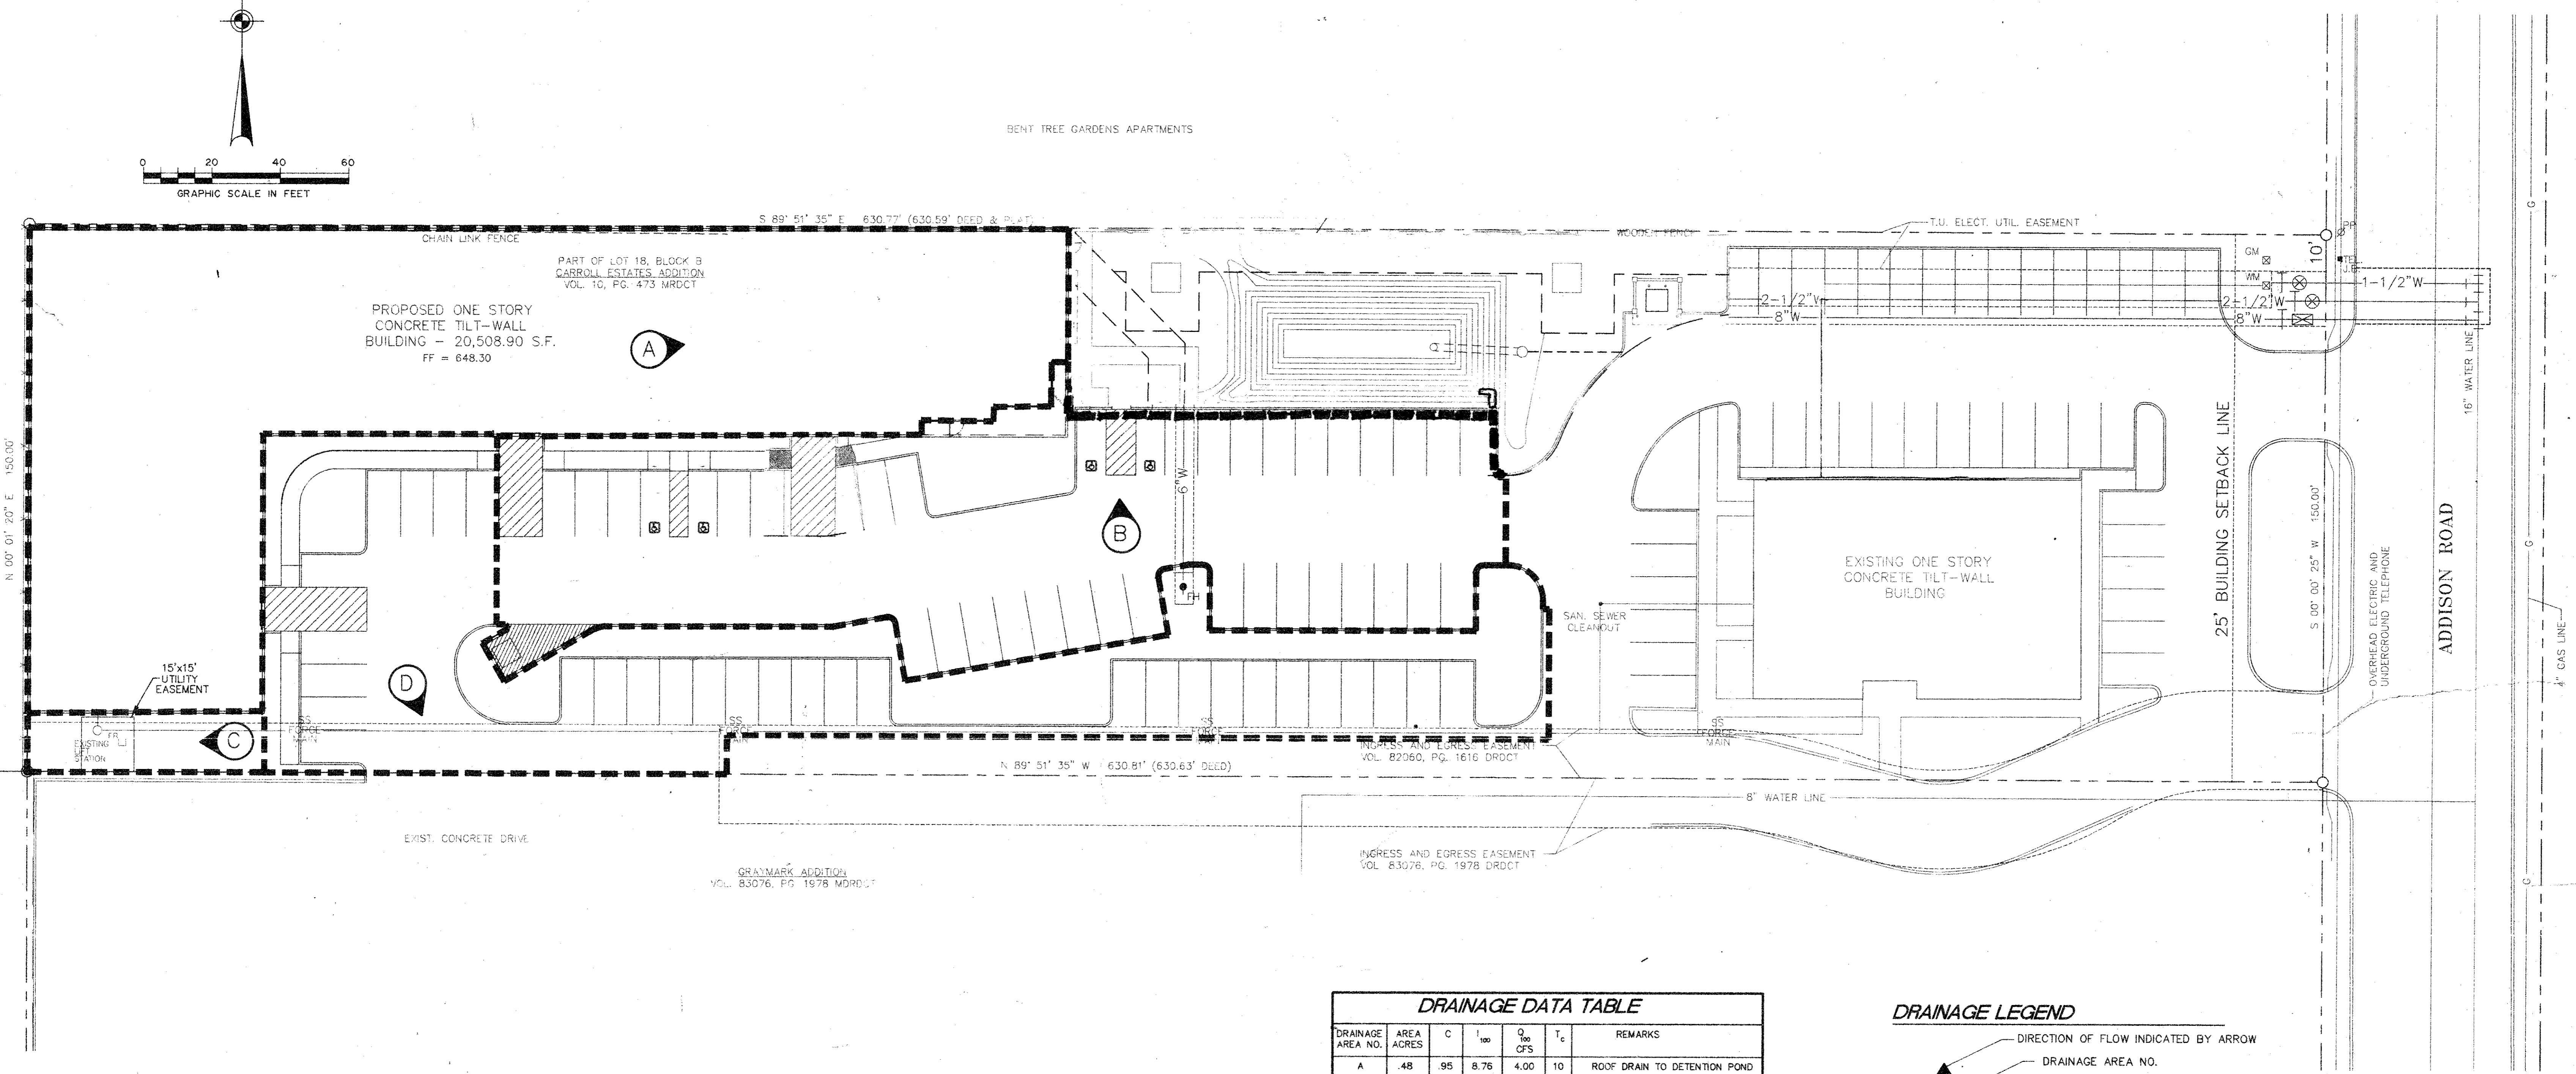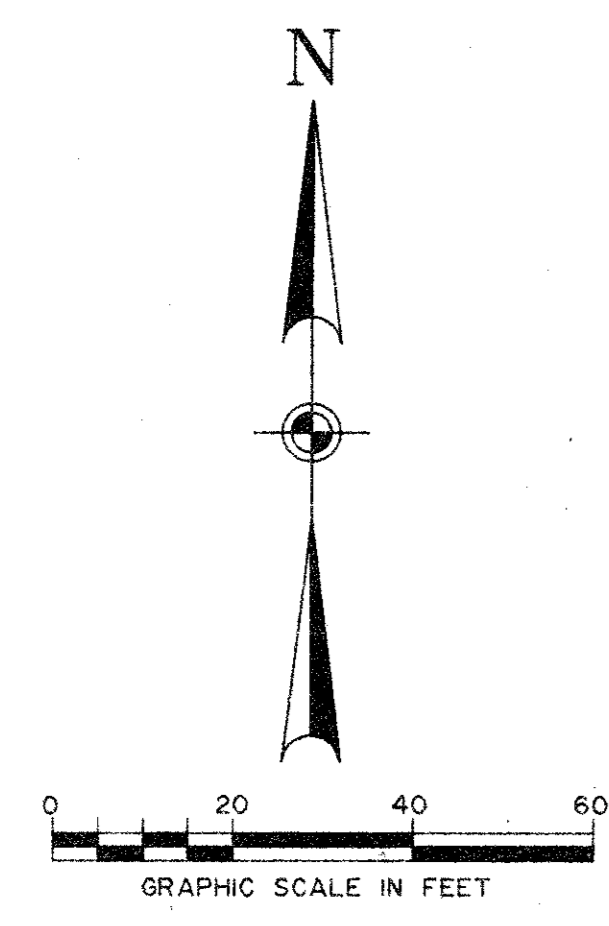

**DRAINAGE DATA TABLE**

DRAINAGE AREA NO.	AREA ACRES	C	$1000$	$Q_{100}$ CFS	$T_c$	REMARKS
A	.48	.95	8.76	4.00	10	ROOF DRAIN TO DETENTION POND
B	.36	.90	8.76	3.00	10	TO DETENTION POND
C	.02	.50	8.76	.09	10	SHEET FLOW
D	.34	.90	8.76	2.68	10	SHEET FLOW TO PARKING LOT

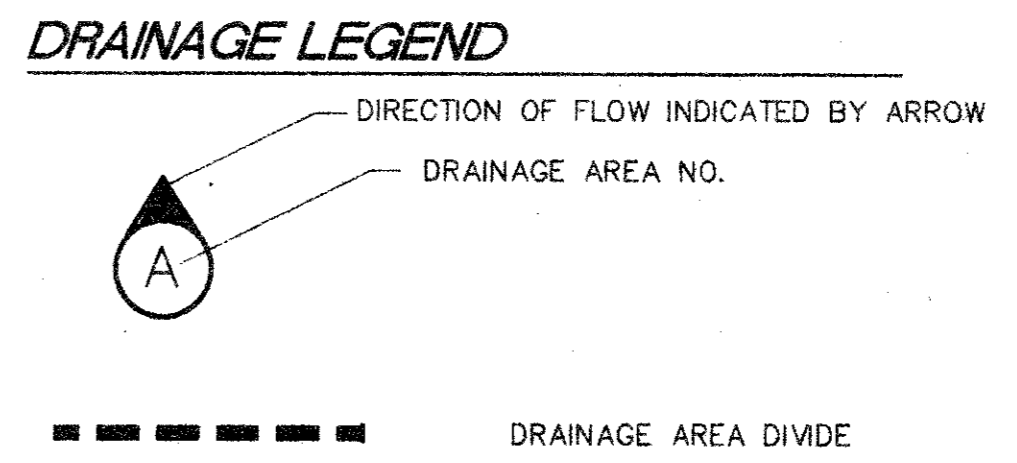


**DRAINAGE CRITERIA**

Q = CIA  
 C = 0.90  
 I<sub>avg</sub> = 8.76 in/hr  
 t<sub>c</sub> = 10 min.

**AS - BUILT DRAWING**  
 DATE: 8-23-01  
 T.S. OREDAIN ASSOC., INC.  
 Architecture • Planning • Interior Design  
 16835 Addison Road, Suite 101  
 Addison, Texas 75001 972-250-0119

**AMO**  
 16835 ADDISON ROAD  
 SUITE 101  
 DALLAS, TEXAS 75248  
 TEL: 972-250-0119  
 FAX: 972-250-3157

**OFFICE WAREHOUSE PHASE I**  
 16835 ADDISON ROAD ADDISON, TEXAS

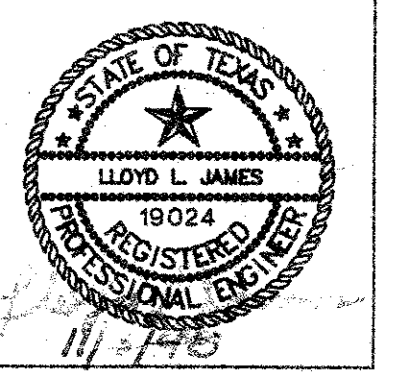

**to**  
 T.S. OREDAIN Associates Inc.  
 Architecture • Planning • Interior Design



16835 Addison Road  
 Suite 101  
 Dallas, Texas 75248  
 (972) 250-0119

JOB: 8396	DATE: 10-26-98
DRAWN:	CHECKED:

Date	Issued For / Description
11-1-99	TRDR
10-1-98	TRDR
10-1-98	TRDR


DRAINAGE PLAN



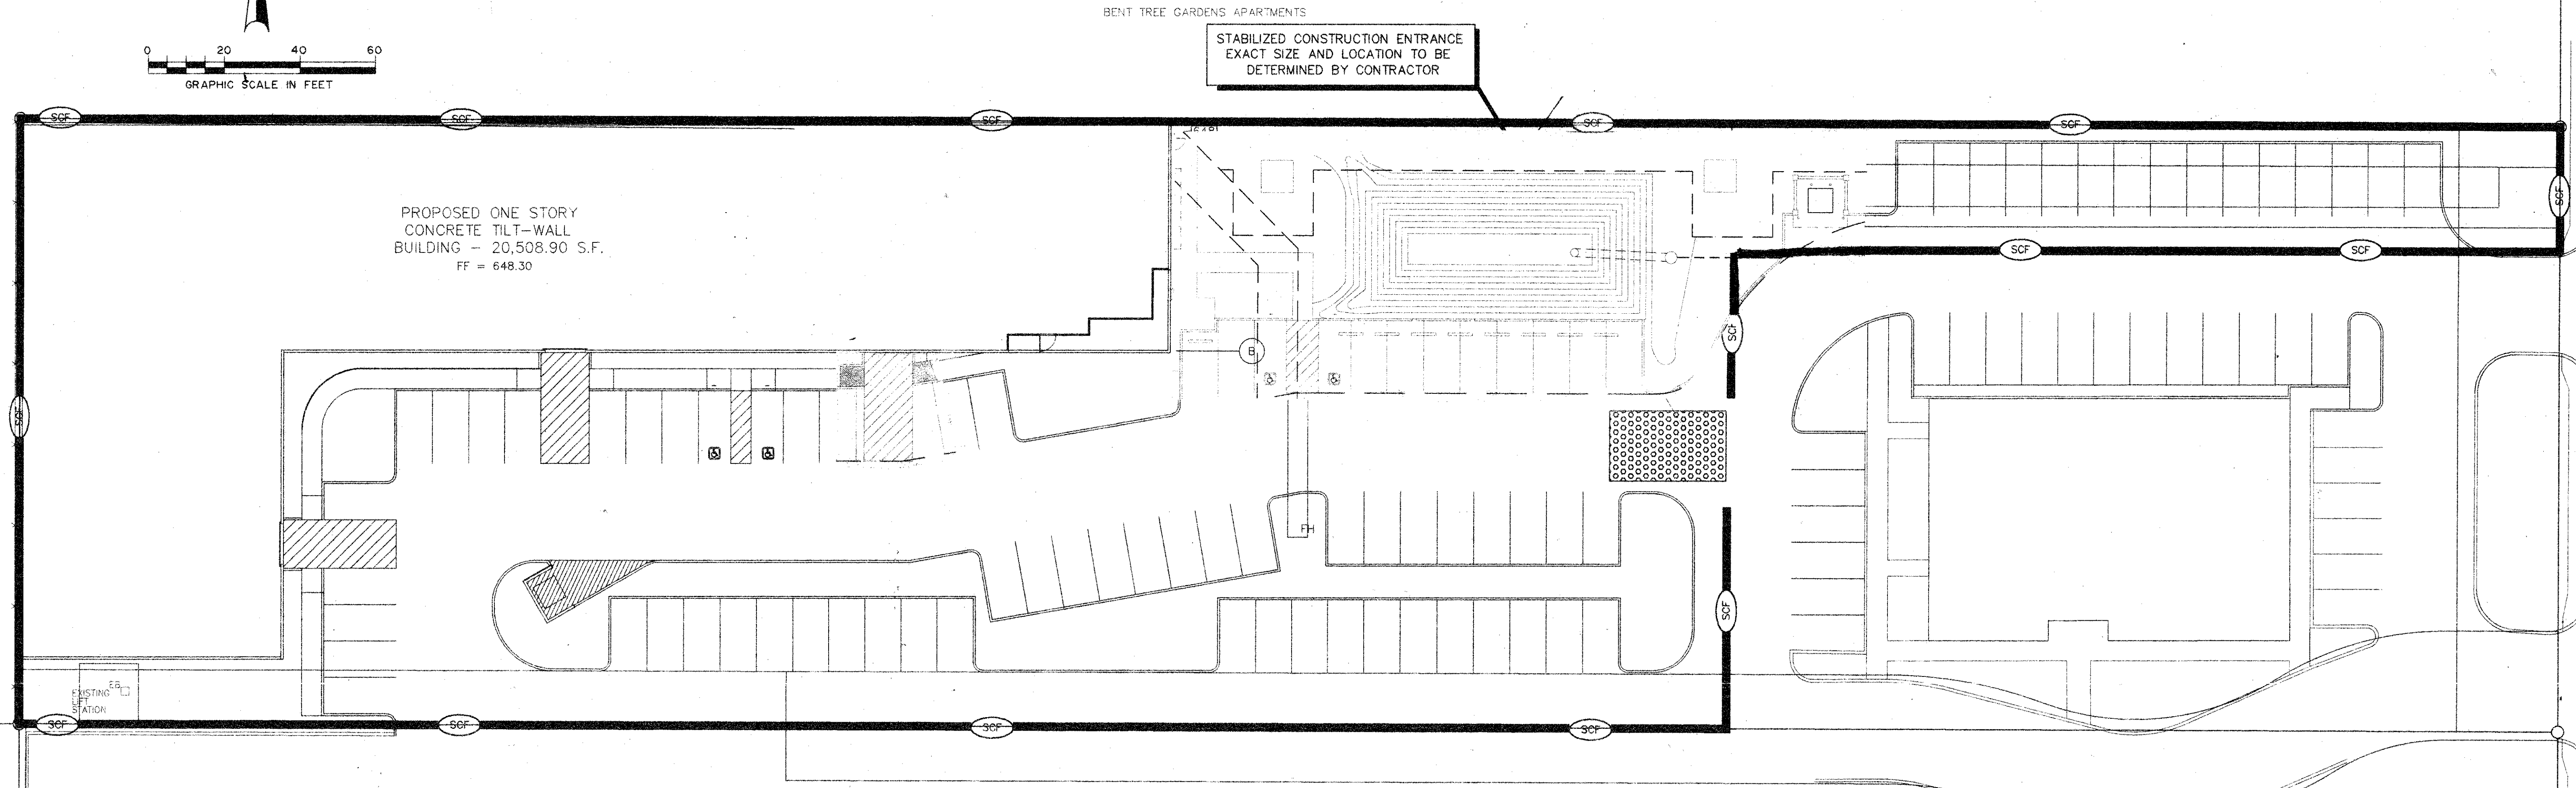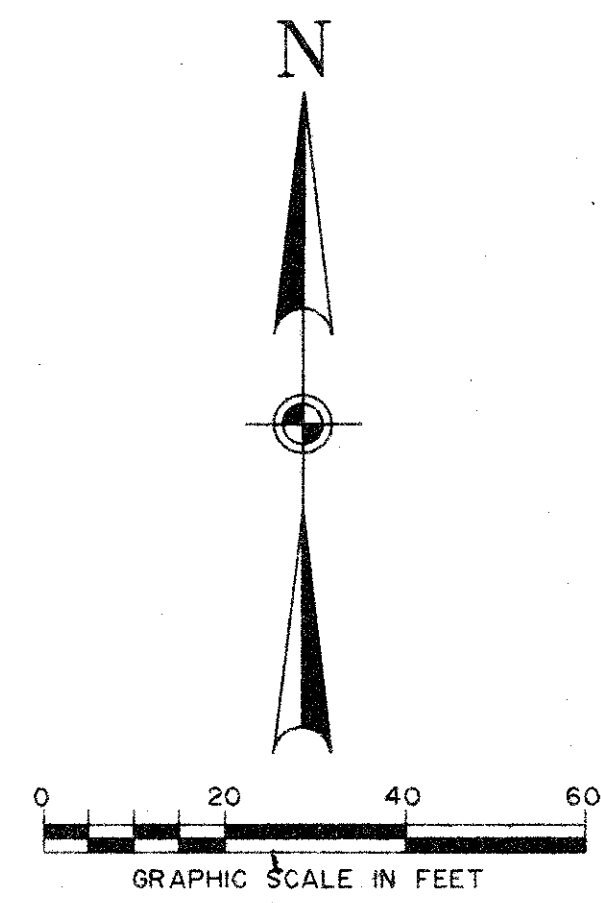


PROPOSED ONE STORY  
CONCRETE TILT-WALL  
BUILDING - 20,508.90 S.F.  
FF = 648.30

BENT TREE GARDENS APARTMENTS  
STABILIZED CONSTRUCTION ENTRANCE  
EXACT SIZE AND LOCATION TO BE  
DETERMINED BY CONTRACTOR

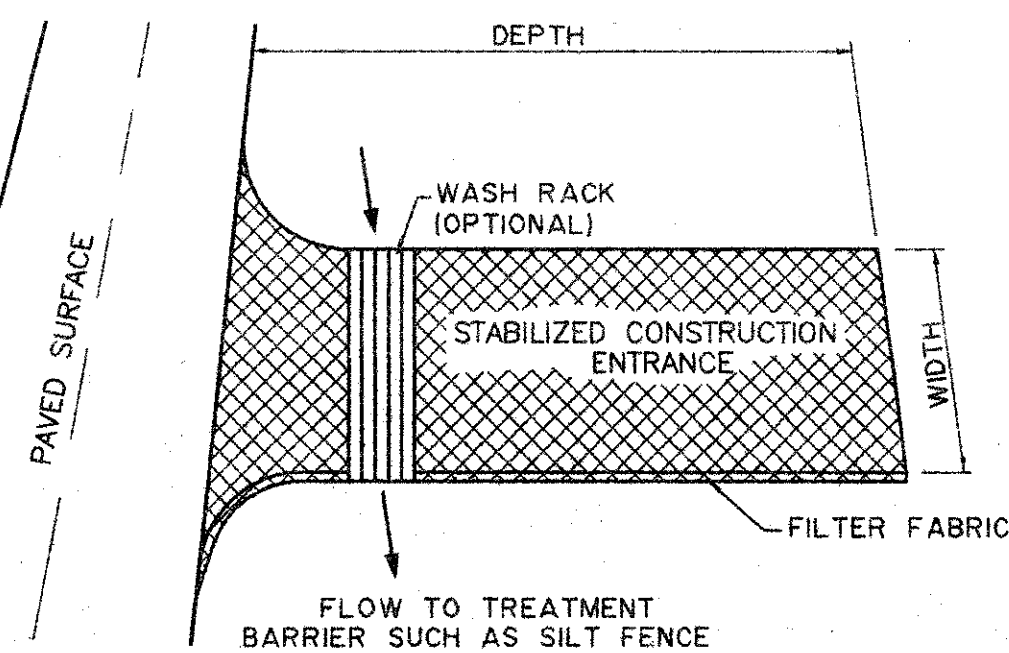


1. CONSTRUCTION ENTRANCE EXACT LOCATION TO BE DETERMINED BY THE CONTRACTOR.

**01 STABILIZED CONSTRUCTION ENTRANCE**  
N.T.S.

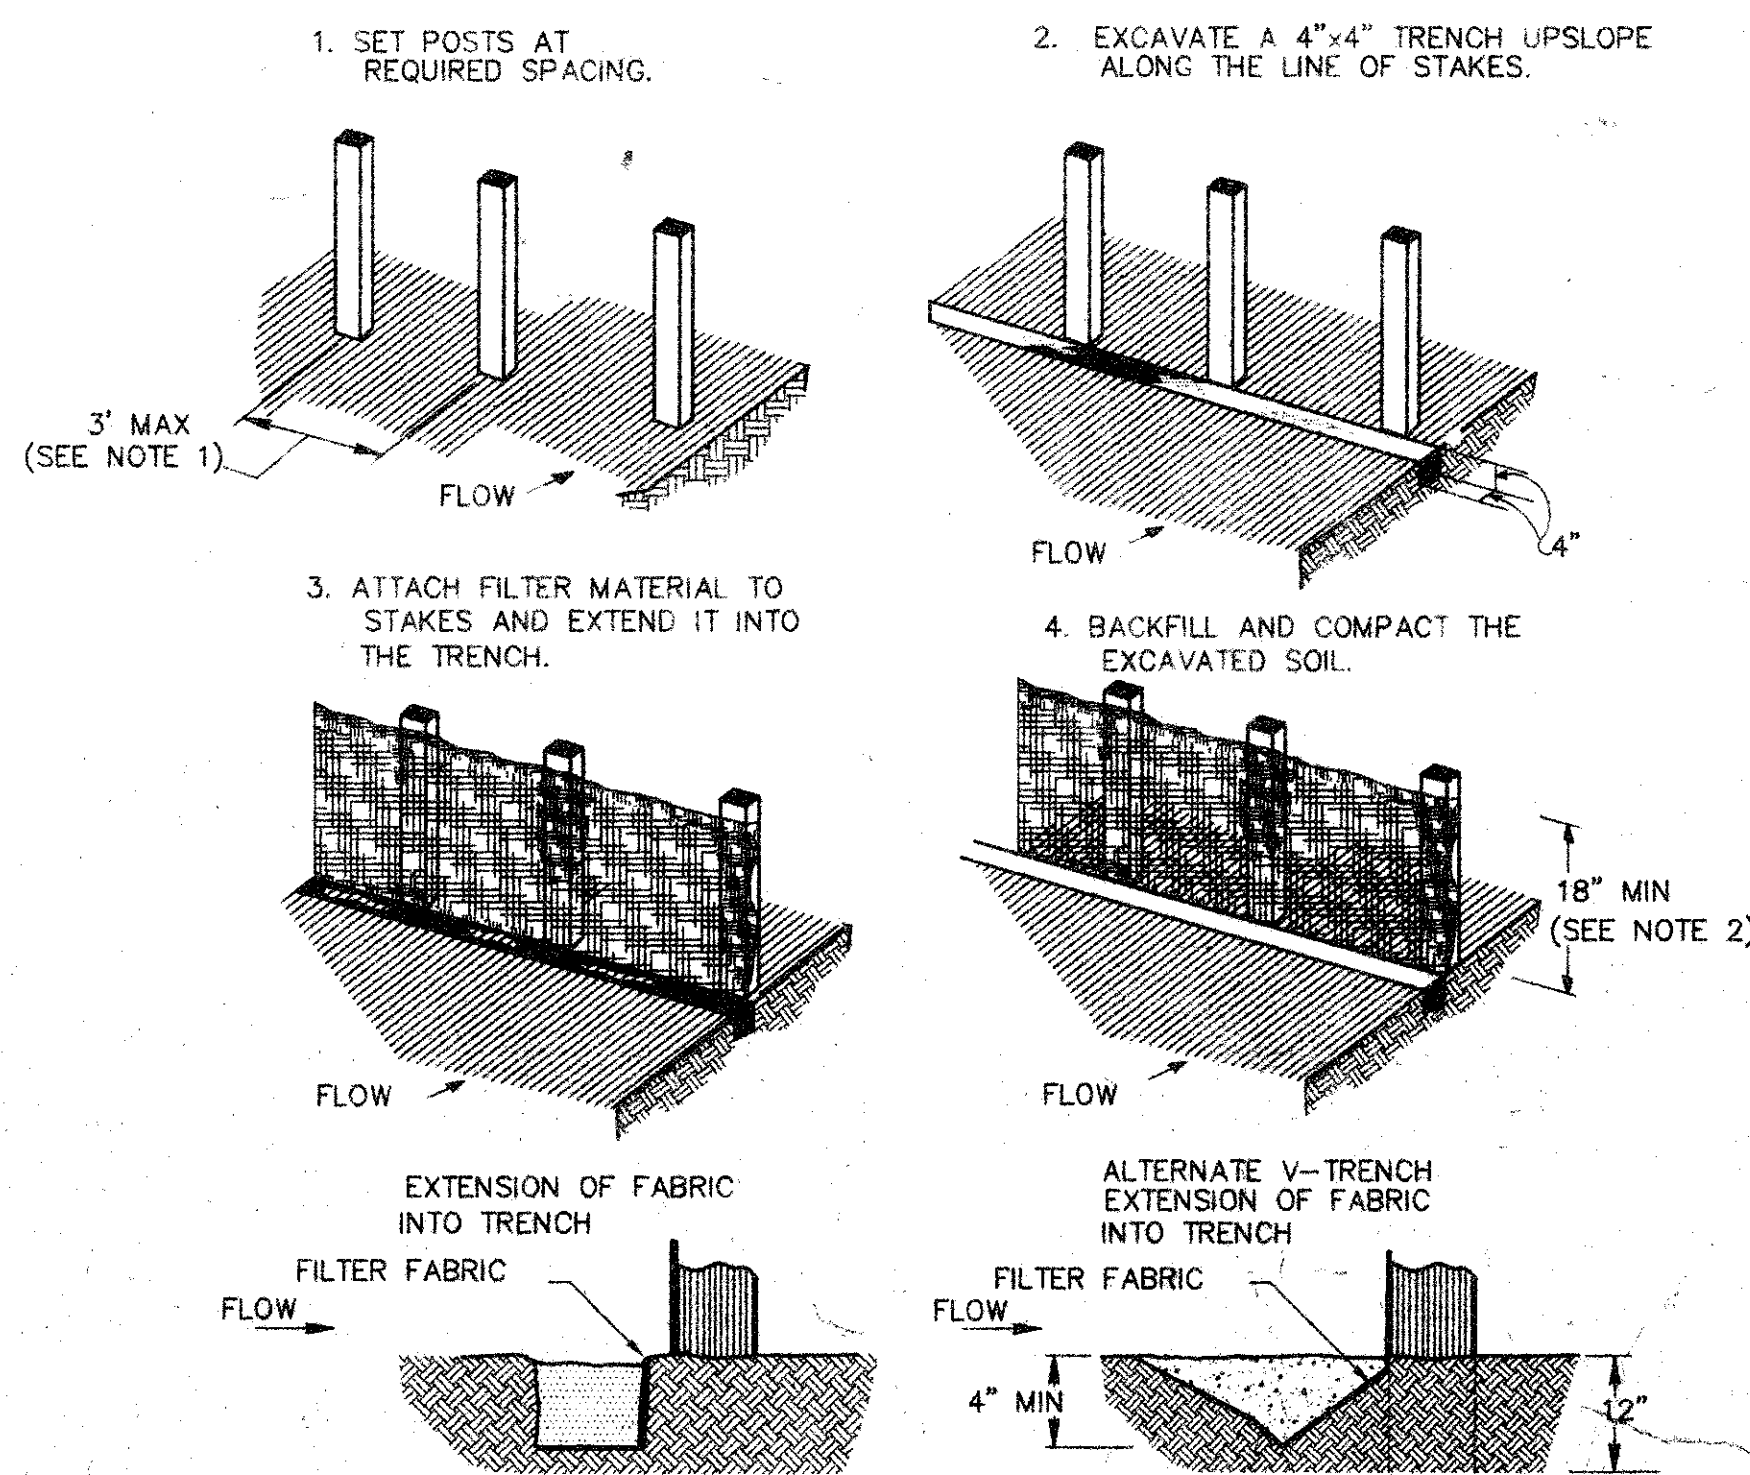

**02 SEDIMENT CONTROL FENCE**  
N.T.S.

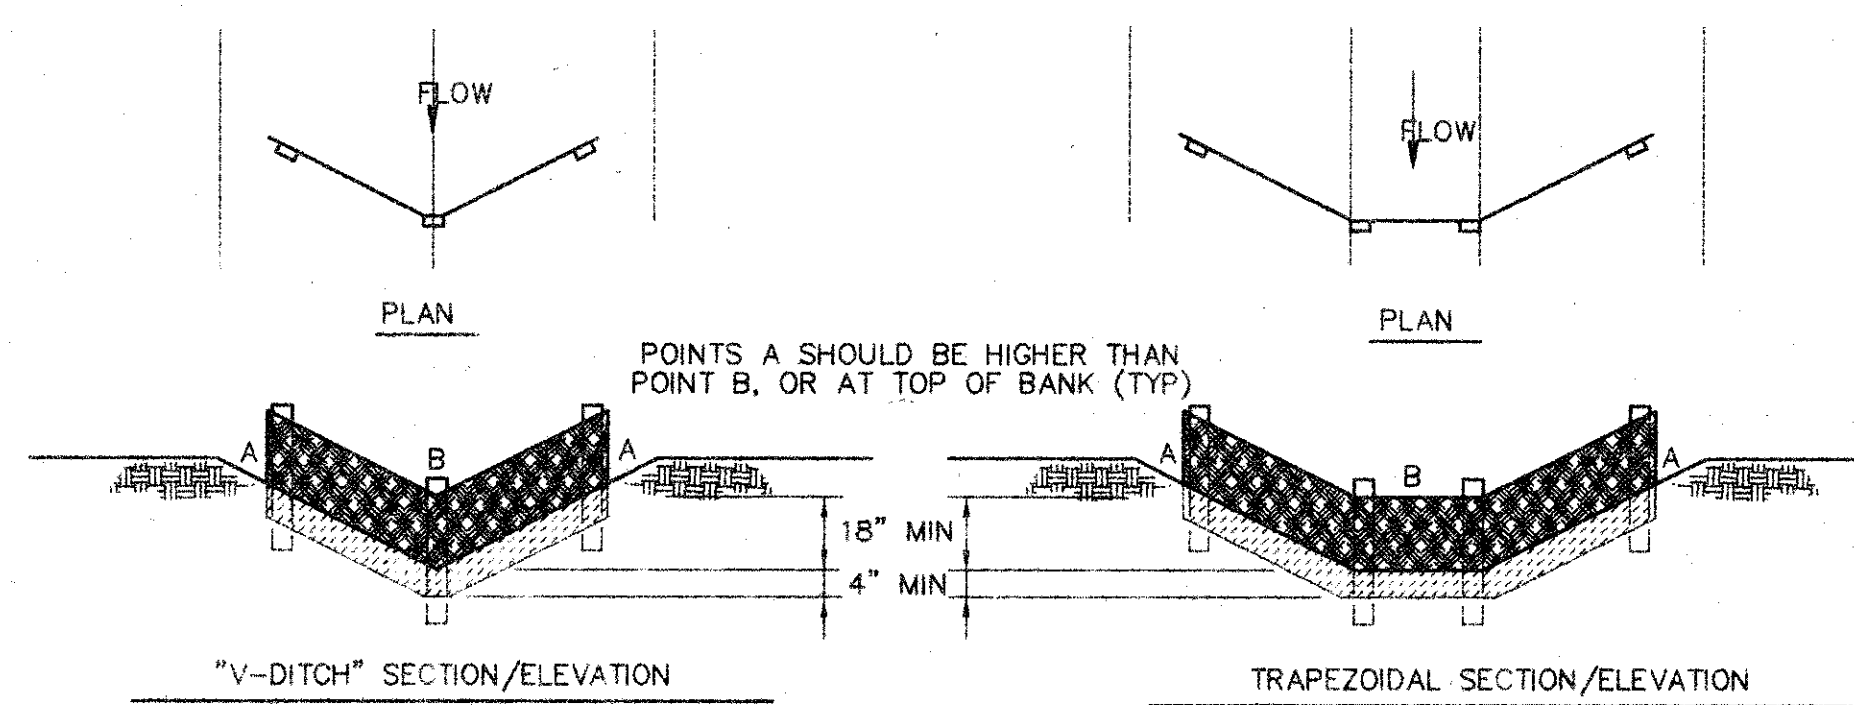


**CONSTRUCTION NOTES:**

1. 1 INCH THICK BY 2 INCH WOODEN STAKES TO BE SET AT MAX SPACING OF 3 FEET AND EMBEDDED A MIN OF 8 INCHES. IF PREASSEMBLED FENCE WITH SUPPORT NETTING IS USED, SPACING OF POST MAY BE INCREASED TO 8 FEET MAX.
2. ATTACH FILTER FABRIC TO WOODEN STAKES. FILTER FABRIC FENCE SHALL HAVE A MIN HEIGHT OF 18 INCHES AND MAX HEIGHT OF 36 INCHES ABOVE NATURAL GROUND.
3. WHEN TWO SECTIONS OF FILTER CLOTH ADJOIN EACH OTHER THEY SHALL BE OVERLAPPED 6 INCHES AT THE POSTS, AND FOLDED.


**AS - BUILT  
DRAWING**  
DATE: 8-23-01  
T.S. ORENDAIN ASSOC., INC.  
Architects • Planning • Interior Design  
16835 Addison Road, Suite 101  
Addison, Texas 75002 972-250-0119

**EROSION CONTROL LEGEND**

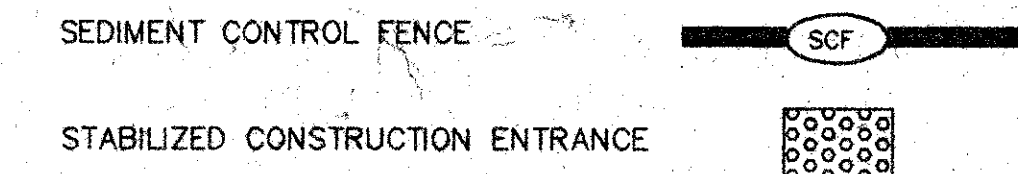

**AMO**  
16835 ADDISON ROAD  
SUITE 101  
ADDISON, TEXAS 75248  
TEL: 972-250-0119  
FAX: 972-250-3157

**OFFICE WAREHOUSE  
PHASE I**  
16835 ADDISON ROAD ADDISON, TEXAS

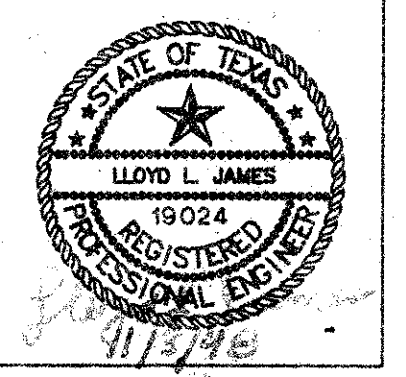

**to**  
T.S. Orendain Associates Inc.  
Architects • Planning • Interior Design

16835 Addison Road  
Suite 101  
Addison, Texas 75248  
(972) 250-0119

JOB: 8396 DATE: 10-26-98  
DRAWN: CHECKED:


Date	By	Issued For / Description
11-11-99	TDLR	100% ISSUED FOR CONSTRUCTION
2-22-00		

EROSION CONTROL PLAN




**AMO**  
 16835 ADDISON ROAD  
 SUITE 101  
 ADDISON, TX 75001  
 FAX: 972-250-3157

**ADDISON PARK CENTRE  
 OFFICE/TECH./FLEX.  
 PHASE 1**  
 16835 ADDISON ROAD ADDISON, TEXAS


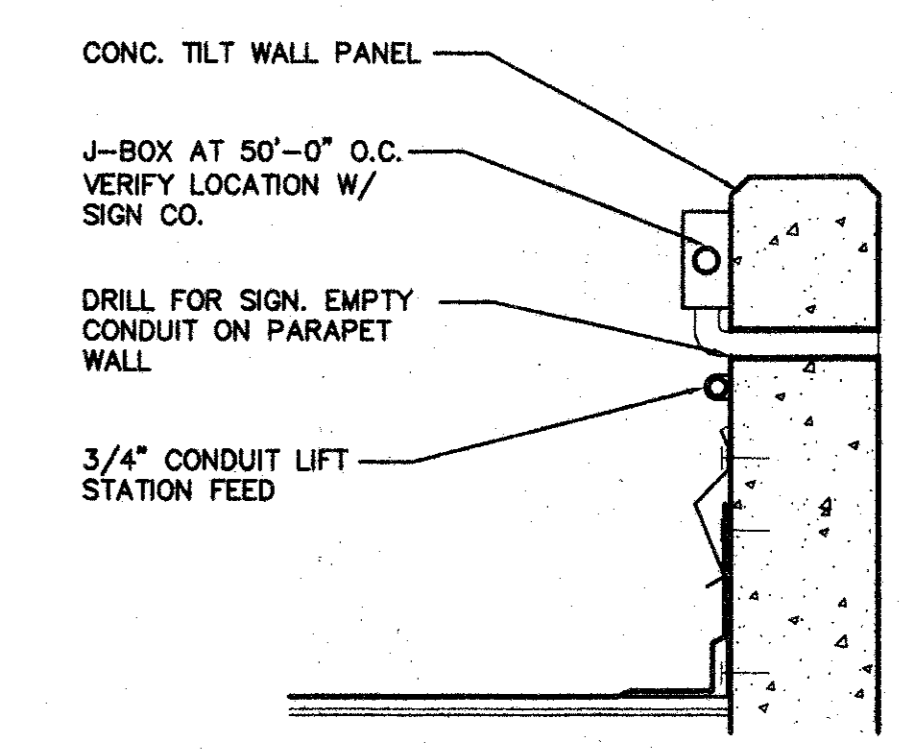


ELECT. DETAIL SCALE: 1 1/2"=1'-0" E102

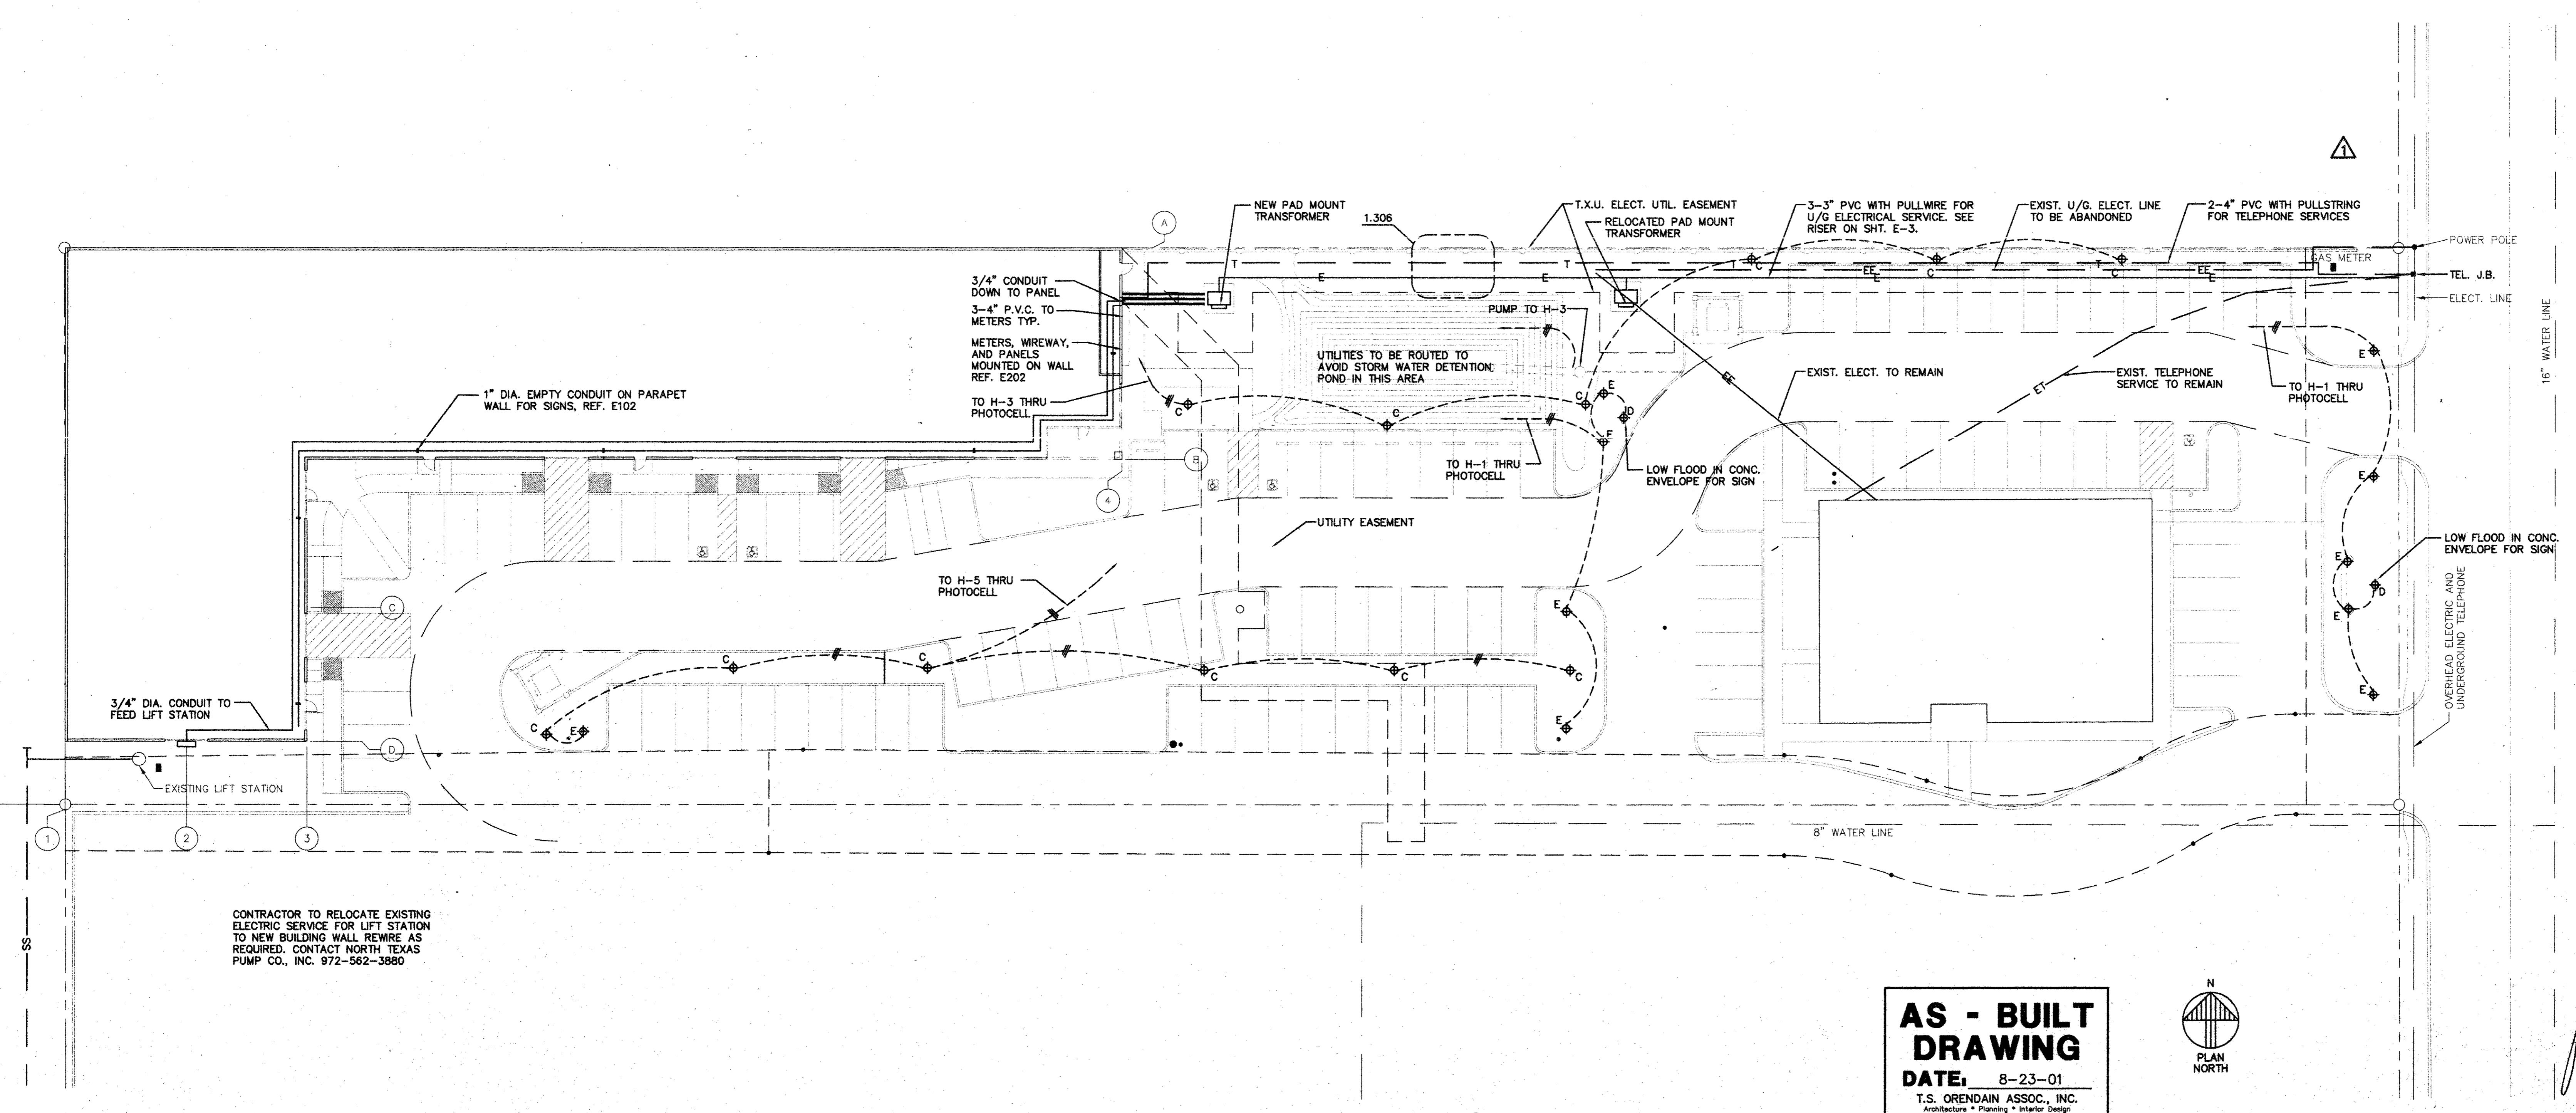


CONTRACTOR TO RELOCATE EXISTING ELECTRIC SERVICE FOR LIFT STATION TO NEW BUILDING WALL REMIRE AS REQUIRED. CONTACT NORTH TEXAS PUMP CO., INC. 972-562-3880

**AS - BUILT  
 DRAWING**  
 DATE: 8-23-01  
 T.S. ORENDAIN ASSOC., INC.  
 Architecture • Planning • Interior Design  
 16835 Addison Road, Suite 101  
 Addison, Texas 75001 972-250-0119

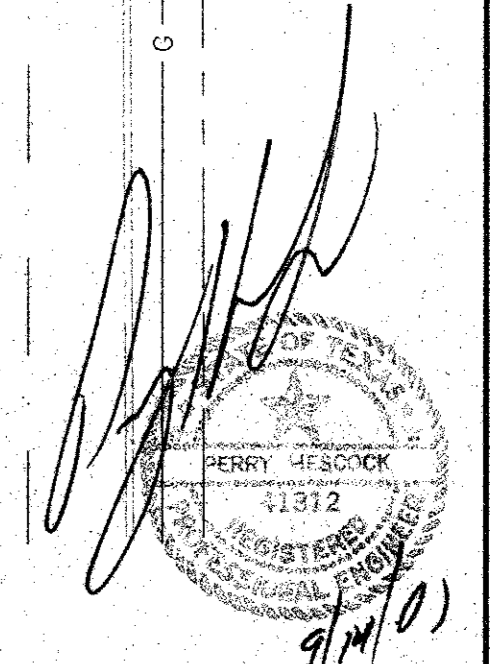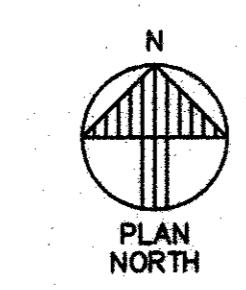

ELECTRICAL SITE PLAN SCALE: 1"=20'-0" E101

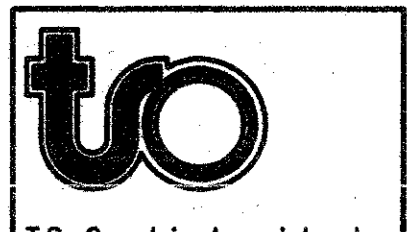

T.S. Orendain Associates Inc.  
 Architecture • Planning • Interior Design


16835 Addison Road  
 Suite 101  
 Addison, Texas 75001  
 (972) 250-0119

JOB: 6396 DATE: 2/25/2000  
 DRAWN: CHECKED:


Date	By	Issued For / Description
8-17-98		PERMIT ISSUE
11-1-99		T.O.L.R.
2-25-2000		100% ISSUED FOR CONSTRUCTION
6-9-2000		GENERAL REVISION

ELECTRICAL SITE PLAN




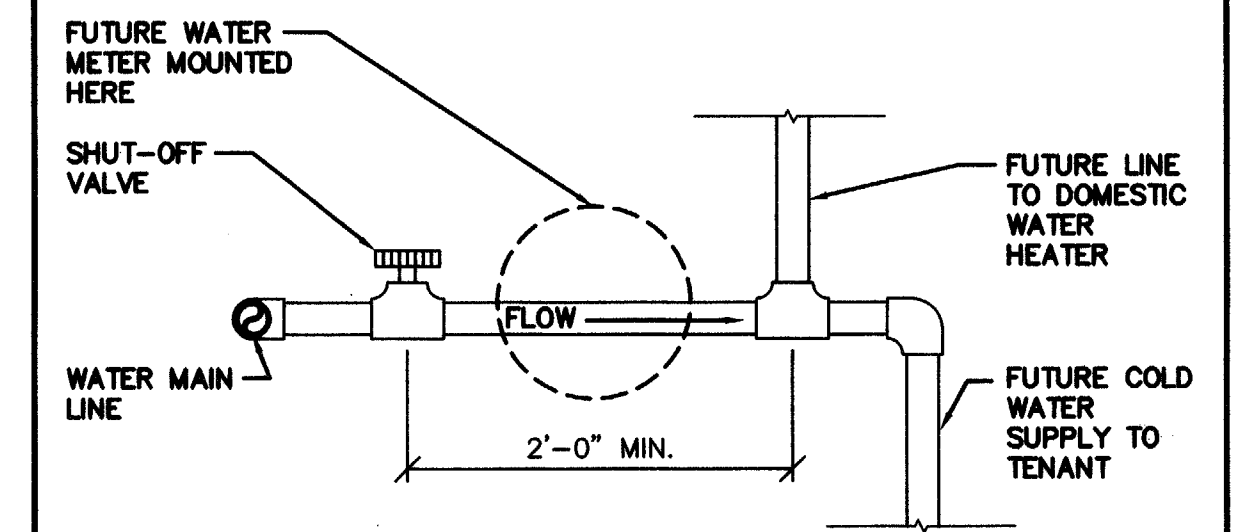

WTR. METER DETAIL SCALE: 1"=1'-0" P202

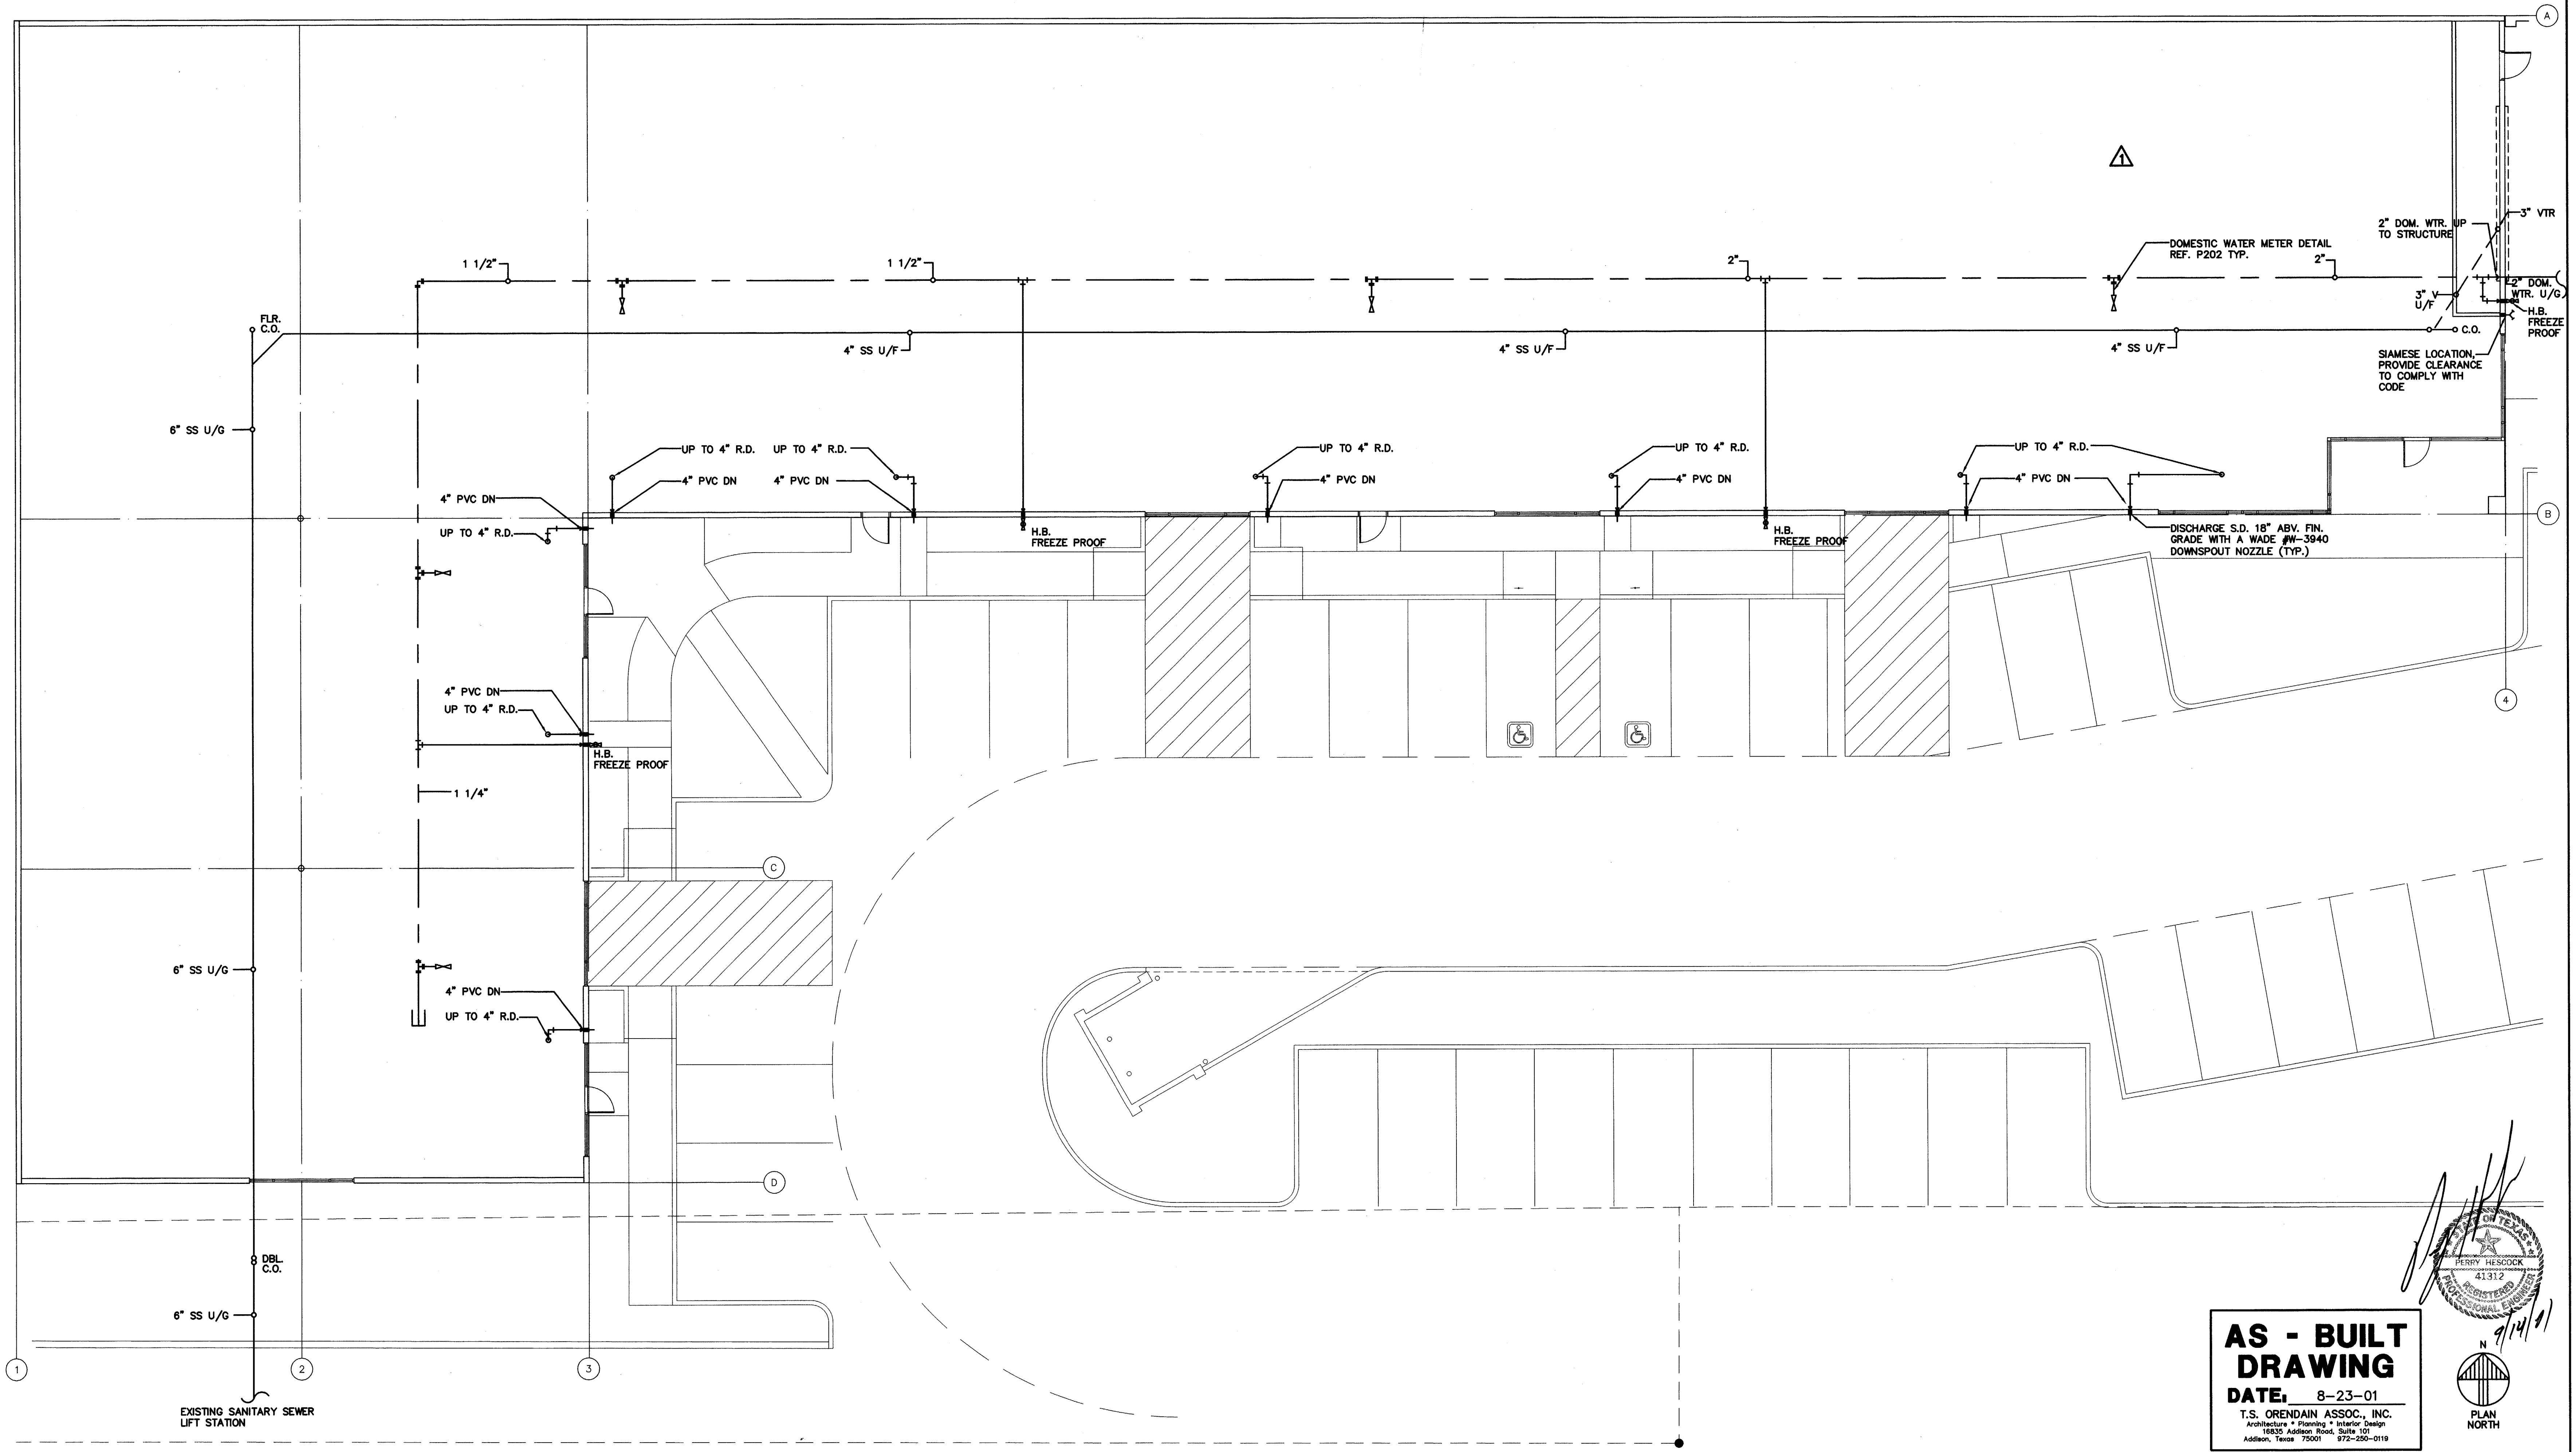

**AS - BUILT  
DRAWING**  
DATE: 8-23-01  
T.S. ORENDAIN ASSOC., INC.  
Architecture • Planning • Interior Design  
16835 Addison Road, Suite 101  
Addison, Texas 75001 972-250-0119

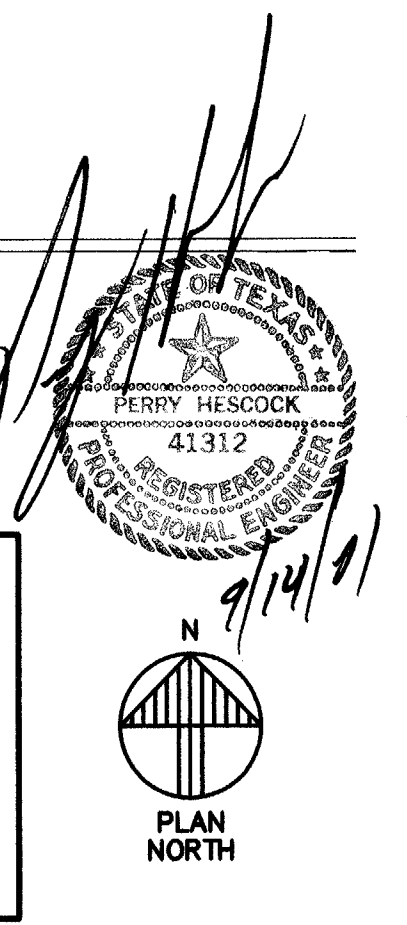

PLUMBING PLAN SCALE: 1/8"=1'-0" P201

**AMO**  
16835 ADDISON ROAD  
ADDISON, TX 75001  
TEL: 972-250-0119  
FAX: 972-250-3157

**ADDISON PARK CENTRE  
OFFICE/TECH./FLEX.  
PHASE 1**  
16835 ADDISON ROAD ADDISON, TEXAS

**to**  
T.S. Orendain Associates Inc.  
Architecture • Planning • Interior Design

16835 Addison Road  
Suite 101  
Addison, Texas 75001  
(972) 250-0119

JOB: 8396 DATE: 2/25/2000  
DRAWN: CHECKED:

Date	Issued For / Description	PERMIT ISSUE
8-17-98		T.D.L.R.
11-1-99		100% ISSUED FOR CONSTRUCTION
2-25-00		GENERAL REVISION
8-9-2000		

PLUMBING PLAN