


dietz engineering

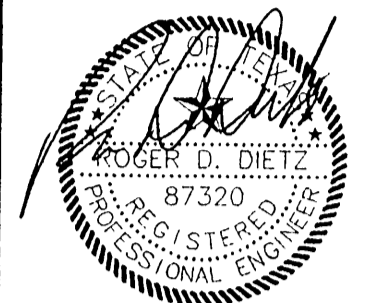

Signing Date: 02.28.01
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Drawn By: LL
 Checked By: RDD
 Revisions:

No.	Date	Description


TRINITY CHRISTIAN ACADEMY
 SIDEWALK / DRIVEWAY PAVING
 PLAN VIEW
 for the
 City of Addison, Texas

NORTH
 24"x36" Scale: 1" = 20'
 11"x17" Scale: 1" = 40'
 Vertical Scale: NA
 Project Number:
 Issue Date: 28 FEB 2001
 Sheet Title:
PAVING PLAN
 Sheet No.:
C1.07

LEGEND

+ETP600.0	EX. TOP OF PVMT.	⊗	WATER VALVE
+ETG600.0	EX. TOP OF GRND.	⊗	UTILITY BOX
+ETC600.0	EX. TOP OF CURB	⊗	WOOD BOLLARD
+600.0	FIN. FLR. SPOT ELEV.	⊗	GAS METER
TP600.0	TOP OF PAVEMENT	⊗	CURB INLET
TC600.0	TOP OF CONCRETE	⊗	GRATE INLET
TG600.0	TOP OF GROUND	⊗	FIRE HYDRANT
[600.0]	TOP OF CURB	⊗	WATER METER
-650-	PROP. GRADE LINE	⊗	STORM/SS MANHOLE
-650-	EX. GRADE LINE	⊗	TREE
FF	FINISHED FLOOR	⊗	LIGHT POLE
↑	GUY WIRE ANCHOR	⊗	SIGNAL POLE
⊗	POWER POLE	⊗	SIGNAL PULL BOX
P	STREET/CABLE SIGN	⊗	

NOTE:
 1. JOINTS SHALL BE INSTALLED AND SPACED PER DETAILS J1 AND J2 THIS SHEET OR AS SHOWN.

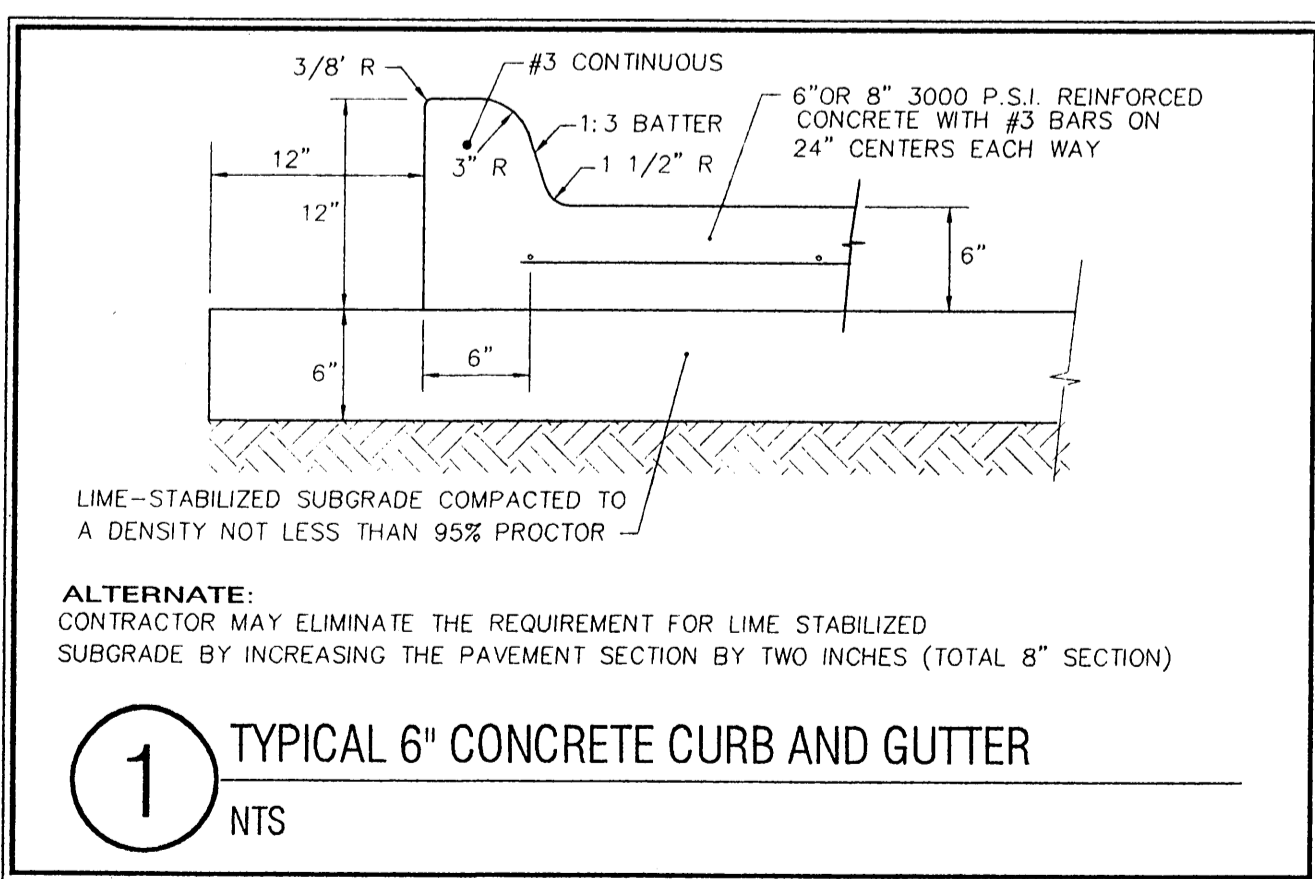

PAVING NOTES

- ANY WORKMANSHIP AND MATERIALS SHALL BE IN ACCORDANCE WITH CITY OF ARLINGTON STANDARD SPECIFICATIONS AND/OR SPECIFICATIONS ESTABLISHED BY THE PROJECT.
- ALL DIMENSIONS ARE TO BACK OF CURB UNLESS SPECIFIED OTHERWISE.
- USUAL PAVEMENT THICKNESS IS AS SHOWN. SUBGRADE DESIGN SHALL BE AS SHOWN AND SHALL EXTEND 12" MIN. BEHIND CURB.
- REINFORCED CONCRETE PAVEMENT:
 - CONCRETE STRENGTH SHALL BE AS SHOWN.
 - ALL CURBS SHALL BE INTEGRAL WITH PAVEMENT.
 - DETAIL AND ARRANGEMENT OF PAVEMENT JOINTS, ALL TYPES, SHALL BE AS NOTED.
- SUBGRADE: SUBGRADE UNDER ALL PAVEMENT SHALL BE 6" THICK AND SHALL BE COMPACTED TO A DENSITY NOT LESS THAN 95 PERCENT PROCTOR.

- 6" REINFORCED CONCRETE PAVEMENT INSTALLED PER THE NORTH CENTRAL TEXAS COUNCIL OF GOVERNMENTS REINFORCED CONCRETE PAVEMENT DETAILS.
- SAW CUT (FULL DEPTH) A TOTAL 12" FROM B/C INTO EXISTING CONCRETE PAVEMENT. DOWEL PROPOSED CONCRETE INTO EXISTING PER NORTH CENTRAL TEXAS COUNCIL OF GOVERNMENTS STANDARD DETAILS.
- INSTALL 6" CURB AND GUTTER PER DETAIL 1 THIS SHEET OR NORTH CENTRAL TEXAS COUNCIL OF GOVERNMENTS STANDARD DRAWING NUMBER 2120.
- INSTALL 4" REINFORCED CONCRETE SIDEWALK PER NORTH CENTRAL TEXAS COUNCIL OF GOVERNMENTS STANDARD DRAWING NUMBER 2170.
- INSTALL STANDARD BARRIER FREE CURB RAMP.