




ELECTRICAL ROOM - HVAC ROOF PLAN SCALE: 1/4" - 1'-0"

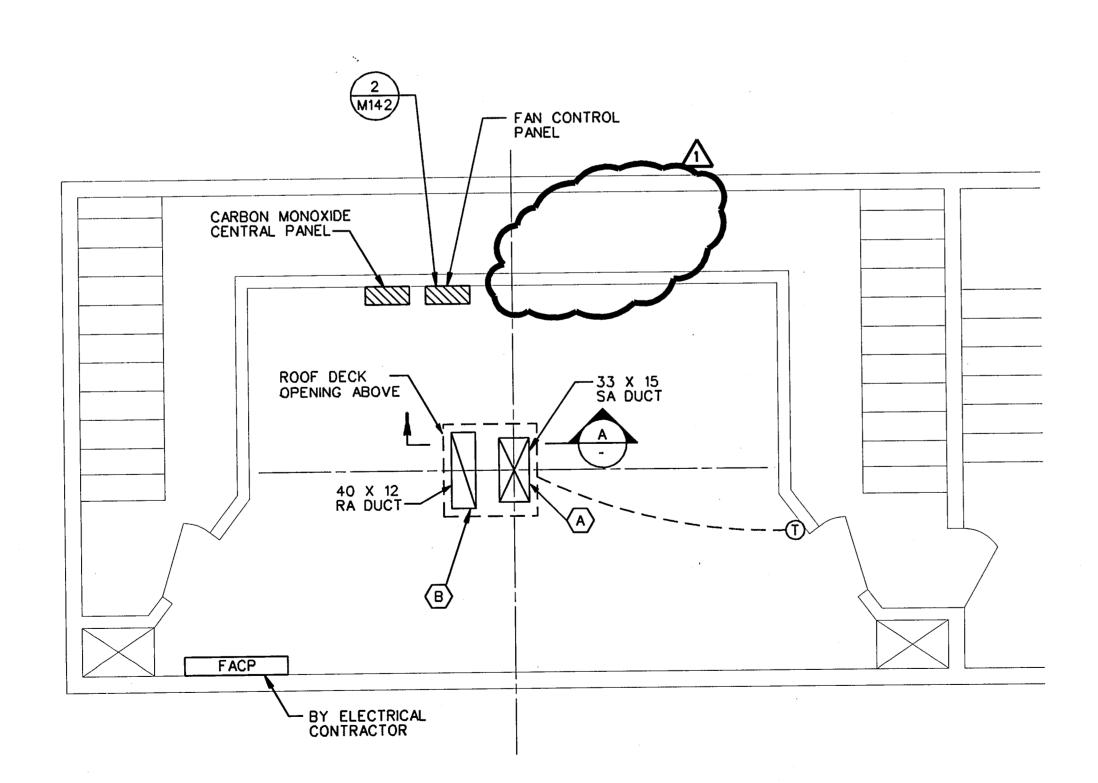


ELECTRICAL ROOM - HVAC FLOOR PLAN SCALE: 1/4" - 1'-0"

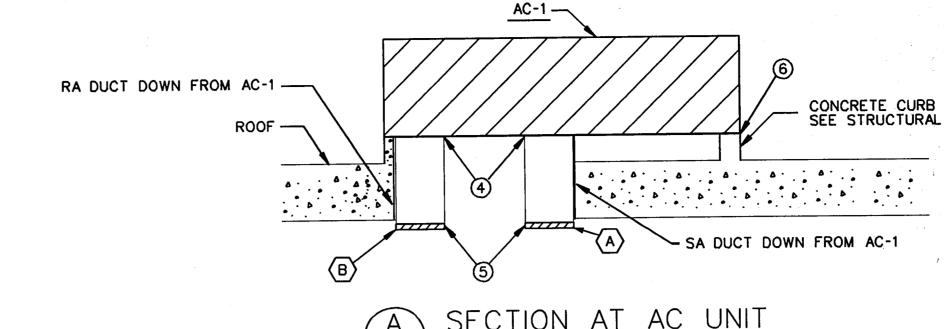


SECTION AT AC UNIT NO SCALE

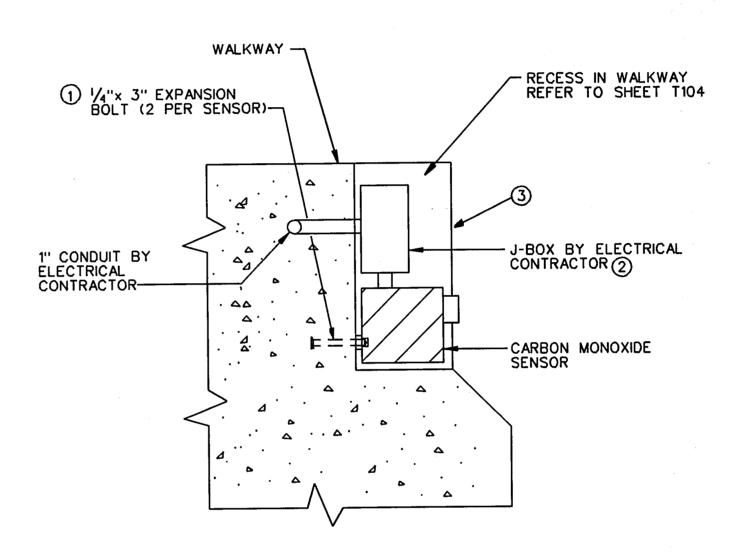

SECTION AT CO SENSOR NO SCALE

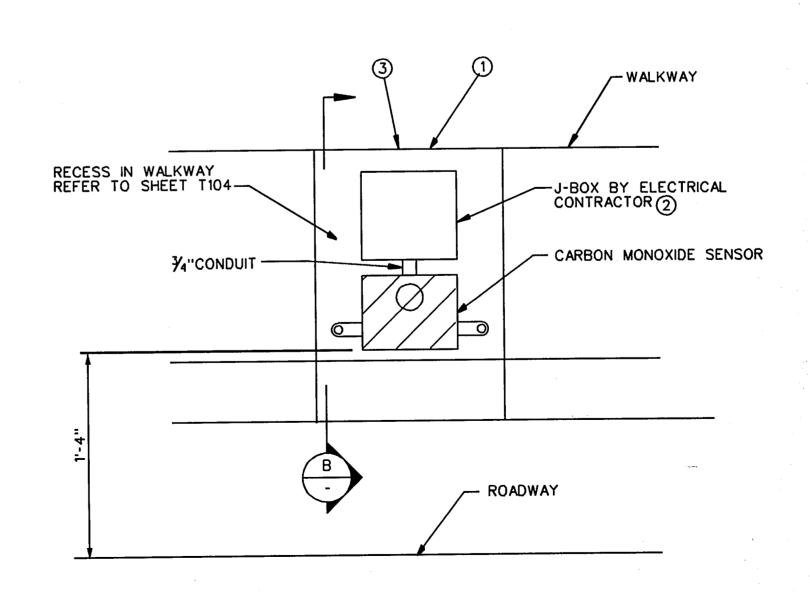


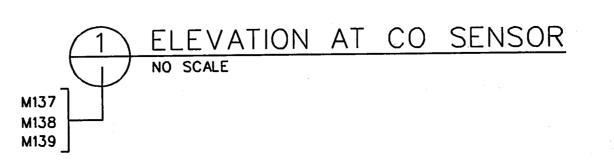

KEY NOTES:

- 1 FASTEN THE CARBON MONOXIDE SENSOR ACCORDING TO THE MANUFACTURERS RECOMMENDATIONS.
- (2) COORDINATE WITH THE ELECTRICAL CONTRACTOR. PULL CONTROL WIRING IN CONDUIT AND J-BOXES PROVIDED BY ELECTRICAL CONTRACTOR.
- THE RECESS IS SIZED FOR THE SENSOR SPECIED. IF AN ALTERNATE MANUFACTURED IS USED, COORDINATE SIZE OF RECESS WITH GENERAL CONTRACTOR <u>PRIOR</u> TO CONSTRUCTION OF WALKWAY. RECESS SHALL BE OF SUFFICIENT SIZE TO ALLOW REMOVAL AND REPLACEMENT OF SENSOR.
- PROVIDE AND INSTALL 1X1X3/8" ANGLE INSIDE THE CURB OPENING TO SUPPORT THE DUCT. LOCATE AND SEAL ACCORDING TO THE MANUFACTURER'S CURB DETAIL.
- PROVIDE AND INSTALL 1X1X3/8" ANGLE TO SPAN THE BOTTOM OF THE ROOF DECK OPENING FOR DUCT AND AIR DEVICE SUPPORT.

 MATCH THE SUPPORT PATTERN USED AT THE TOP OF THE DUCTS.
- 6 SEAL CURB ACCORDING TO MANUFACTURER'S RECOMMENDATIONS. PROVIDE SPACER ALONG TOP OF CURB IF NECESSARY TO MAINTAIN 1/4" GAP BETWEEN THE CURB AND CABINET PERIMETER FLANGE.

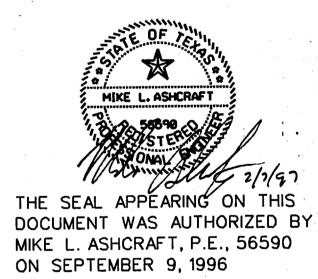

FINAL RECORD

DRAWING

Date: 12/25/99 MLA 2/7/97 GEN. SETS DATE BY REVISION TEXAS TURNPIKE AUTHORITY

ADDISON AIRPORT TUNNEL

TUNNEL VENTILATION SECTIONS & ELECTRIC ROOM AIR CONDITIONING

HDR Engineering, Inc. SECTION XIII DRAWN: WTD DATE: 12/05/96 DESIGNED: MLA DATE: 08/28/96

CHECKED: BL DATE: 08/28/96 SCALE: AS SHOWN

CONTRACT No. DNT-260 SHEET M141 OF 166