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TXDOT STANDARDS

Pedestrian Handrail Details PRD-13

TOWN OF ADDISON STANDARD DETAILS Contractor will obtain a set of the Town of Addison Standard Details available on the Town's Website.

> MAYOR TODD MEIER

MAYOR PRO TEM BLAKE W. CLEMENS

DEPUTY MAYOR PRO TEM .. JANELLE MOORE

CITY COUNCIL

BRUCE ARFSTEN

MARY CARPENTER

CHRIS DeFRANCISCO

DAVID HEAPE

CITY MANAGER LEA DUNN

COUNTY OFFICIALS

COUNTY JUDGE CLAY LEWIS JENKINS

COMMISSIONER DISTRICT NO. 1 THERESA M. DANIEL

COMMISSIONER DISTRICT NO. 2 MIKE CANTRELL

COMMISSIONER DISTRICT NO. 3 JOHN WILEY PRICE

COMMISSIONER DISTRICT NO. 4 DR. ELBA GARCIA

COUNTY OF DALLAS, TEXAS DEPARTMENT OF PUBLIC WORKS

MCIP PROJECT NO. 10304_2

ADDISON PEDESTRIAN CONNECTION PHASE 1:

FROM MORMAN LANE TO ARAPAHO ROAD


TOWN OF ADDISON

TEXAS





LOCATION MAP:

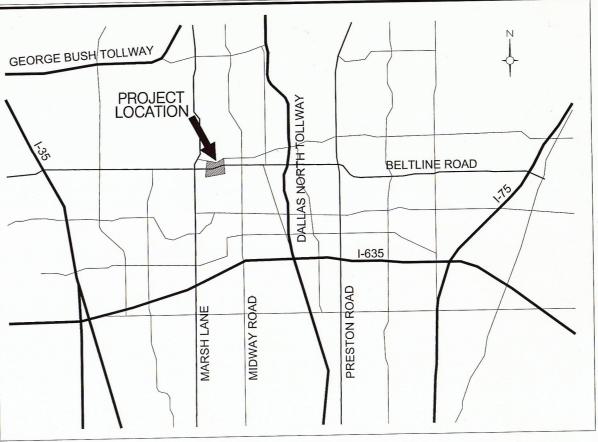

	_
APPROVAL	(

TOWN OF ADDISON

PROJECT LOCATION

CITY MANAGER

Lea Dunn

COUNTY OF DALLAS

DIRECTOR OF PUBLIC WORKS Alberta L. Blair, P.E.

DESIGN TEAM

LANDSCAPE ARCHITECT: 1807 ROSS AVENUE SUITE 333 DALLAS, TX 75201 (214)871-0568

CIVIL ENGINEER: GRANTHAM & ASSOCIATES, INC. 6570 NAAMAN FOREST BLVD. SUITE 200 L.B. #2 GARLAND, TX 75044 (972)864-2333

GENERAL NOTES:

- 1. WRITTEN DIMENSIONS PREVAIL OVER SCALED DIMENSIONS. NOTIFY LANDSCAPE ARCHITECT OF ANY DISCREPANCIES.

 2. THE CONTRACTOR IS RESPONSIBLE FOR VERIFYING ALL UNDERGROUND UTILITIES, PIPES, STRUINES, AND LINE RUNS
 IN THE FIELD PRIOR TO CONSTRUCTION. ANY DAMAGE TO NEW AND EXISTING UTILITIES THAT ARE TO BE REPAIRED
 IMMEDIATELY AT NO ADDITIONAL EXPENSE TO THE OWNER. MESA ASSUMES NO RESPONSIBILITY FOR ANY UTILITIES NOT
 SHOWN ON PLANS.

 ALL PROPOSED AND FINISHED GRADES ARE BASED ON INFORMATION PROVIDED BY THE SURVEY AND/OR CIVIL ENGINEER.
 ANY DISCREPANCIES IN ACTUAL FIELD MEASUREMENTS ARE TO BE REPORTED TO THE LANDSCAPE ARCHITECT
 IMMEDIATELY.
 PRIOR TO COMMENCEMENT OF HARDSCAPE CONSTRUCTION.
- IMMEDIATELY

 PRIOR TO COMMENCEMENT OF HARDSCAPE CONSTRUCTION, ALL PIERS, FOOTINGS, AND WALLS ARE TO BE SURVEYED,
 LAID OUT, AND STAKED IN THE FIELD FOR REVIEW BY LANDSCAPE ARCHITECT. CONTRACTOR SHALL ASSUME ALL
 RESPONSIBILITY FOR ANY DEMOLITION, ADJUSTMENTS, OR RECONSTRUCTION OF HARDSCAPE CONSTRUCTION
 RESULTING FROM UNAUTHORIZED CONSTRUCTION.
 CONTRACTOR IS RESPONSIBLE TO PROVIDE AND INSTALL ALL ITEMS FER DRAWINGS AND SPECIFICATIONS, ANY
 QUANTITIES PROVIDED BY MESA ARE PROVIDED FOR CONVENIENCE ONLY. CONTRACTORS ARE TO BID PER THEIR OWN
 PERIFIED QUANTITIES AND PER THE INTENT OF THE DRAWINGS. NOTIFY LANDSCAPE ARCHITECT OF ANY MAJOR
 DISCREPANCIES.

 SITE EASSEMENTS, BILLI DING SFTRACKS, BUILDING LOCATIONS, STREETS, PARKING LOTS AND UTILITIES HAVE BEEN
- DISCREPANCIES.

 6. SITE EASEMENTS, BUILDING SETBACKS, BUILDING LOCATIONS, STREETS, PARKING LOTS AND UTILITIES HAVE BEEN SUPPLIED TO MESA BY THE PROJECT CIVIL ENGINEER. REFER TO CIVIL ENGINEERS DRAWINGS FOR ADDITIONAL INFORMATION.

CONCRETE NOTES:

PLANTING NOTES: GRASS ESTABLISHMENT

- 1. LANDSCAPE CONTRACTOR SHALL BE RESPONSIBLE FOR VERIFYING THE LOCATION OF ALL UNDERGROUND UTILITIES, PIPES, STRUCTURES, AND LINE RUNS IN THE FIELD PRIOR TO THE INSTALLATION OF ANY PLANT MATERIAL.

 2. IT IS THE RESPONSIBILITY OF THE CONTRACTOR TO ADVISE THE LANDSCAPE ARCHITECT OF ANY CONDITION FOUND ON THE STRUMENT WHICH PROHIBITS INSTALLATION AS SHOWN ON THE DRAWNOS.

 3. LANDSCAPE CONTRACTOR IS RESPONSIBLE FOR ALL COORDINATION WITH OTHER CONTRACTORS ON SITE AS REQUIRED TO ACCOMPLISH ALL PLANTING OPERATIONS.

 4. ALL PLANT MATERIAL SHALL BE MAINTAINED IN A HEALTHY AND GROWING CONDITION AND MUST BE REPLACED WITH PLANT MATERIAL OF SAME VARIETY AND SIZE IF DAMAGED, DESTROYDED, DEAD AND/OR REMOVED.

 5. LANDSCAPE CONTRACTOR SHALL BE RESPONSIBLE FOR FINE GRADING AND REMOVAL OF DEBRIS AND UNWANTED VIGE TATION PRIOR TO PLANTING IN ALL AREAS.

 6. FINAL FINASHED GRADING SHALL BE REVIEWED BY THE LANDSCAPE ARCHITECT. CONTRACTOR IS RESPONSIBLE FOR ANY ADDITIONAL FRABLE NATIVE BLACK CLAY TOPSOIL REQUIRED TO CREATE A SMOOTH CONDITION SUITABLE FOR PLANTING.
- PLANTING.
 ALL QUANTITIES LISTED IN THE DRAWINGS ARE FOR INFORMATION ONLY. IT IS THE CONTRACTORS RESPONSIBILITY TO VERIFY ALL QUANTITIES AND TO PROVIDE ALL MATERIALS NECESSARY FOR FULL COVERAGE IN ALL PLANTING AREAS AS SPECIFIED ON THE DRAWINGS.

IRRIGATION NOTES

- 1. CONTRACTOR SHALL INVESTIGATE ALL EXISTING IRRIGATION COMPONENTS/ FLAG ALL HEADS, VALVE BOXES, AND OTHER IRRIGATION EQUIPMENT.
 2. CONTRACTOR SHALL REROUTE EXISTING IRRIGATION SYSTEM TO FIT NEW TRAIL AND RELATED WORK/ MODIFY EXISTING SYSTEM TO PROVIDE IRRIGATION COVERAGE WITHIN AREAS THAT CURRENTLY HAVE AN IRRIGATION SYSTEM.
 3. WITHIN ALL NON-IRRIGATED AREAS, CONTRACTOR SHALL PROVIDE TEMPORARY IRRIGATION BY TRUCK AND/OR HAND WATERING TO ESTABLISH NEW TURF (SOD OR SEED) AREAS.
 4. ALL IRRIGATION SHALL CONFORM TO TOWN OF ADDISON IRRIGATION SPECIFICATION DETAILS DATED 05.99.2014.

GRADING NOTES

- WRITTEN DIMENSIONS AND GRADES PREVAIL OVER SCALED DIMENSIONS. NOTIFY LANDSCAPE ARCHITECT OF ANY
- WHAT LEN DIMENSIONS AND GRADES PREVAIL OVER SCALED DIMENSIONS. HOTH TO ADDRESS ENTITIES, PIEVES SOCIETY OF THE METHOD OF THE STRUCTURES AND LINE RUNS.

 CONTRACTOR SHALL BE RESPONSIBLE FOR MAKING HIMSELF FAMILIAR WITH ALL UNDERGROUND UTILITIES, PIPPES, STRUCTURES AND LINE RUNS.
- STRUCTURES AND LINE RUNS.

 STRUCTURES AND LINE RUNS.

 STRUCTURES AND LINE RUNS.

 MESA DESIGN GROUP ASSUMES NO RESPONSIBILITY FOR ANY EXCAVATION OR GRADING SHOWN ON SURVEY'S OR CIVIL ENGINEER'S PLANS. ALL PROPOSED AND FINISHED GRADES ARE BASED ON INFORMATION PROVIDED BY THE OWNERS SURVEY AND/OR CIVIL ENGINEER. ANY DISCREPANCIES IN FIELD MESA/DEMENTS ARE TO BE REPORTED TO THE LANDSCAPE ARCHITECT AND/OR CIVIL ENGINEER IMMEDIATELY.

 CONTRACTOR IS RESPONSIBLE FOR ALL FINAL QUANTITIES PER DRAWINGS AND SPECIFICATIONS. ANY QUANTITIES PROVIDED BY MESA DESIGN GROUP ARE PROVIDED FOR CONVENIENCE ONLY AND SHALL NOT BE CONSIDERED ASSOLUTE. LANDSCAPE ARCHITECT SHOULD BE NOTHED OF ANY GRADING DISCREPANCIES. CONTRACTORS ARE TO BID THEIR OWN VERIFIED QUANTITIES.

 CONTRACTOR TO ENSURE THAT ALL GRADES COMPLY WITH ADA AND TAS STDS. LONGITUDINAL SLOPES MAX 4.9% AND CROSS SLOPES MAX 1.9%. NOTIFY LANDSCAPE ARCHITECT OF ANY DISCREPANCIES.

MATERIAL LEGEND:

CONCRETE PRODUCTS

C-1 STANDARD CONCRETE PAVING

MANUFACTURER: LOCAL PRODUCT: STANDARD GRAY CONCRETE; 3000 PSI; LIGHT BROOM FINISH

BASE BID

C-2 STAINED CONCRETE PAVING

SUPPLIER: SCOFIELD LITHOCHROME CHEMSTAIN. COLOR TO BE SELECTED AFTER MOCK-UP SAMPLES. COLOR SUGGESTED: CS-14 "DARK WALNUT." APPLY PER MANUFACTURER'S SPECIFICATIONS. LOCAL SCOFIELD REP. JIM ORELLA 972.893.9730.

C-3 STAINED ACCENT BAND CONCRETE PAVING

SUPPLIER: SCOFIELD LITHOCHROME CHEMSTAIN. COLOR TO BE SELECTED AFTER MOCK-UP SAMPLES. COLOR SUGGESTED: CS-15 "ANTIQUE AMBER." APPLY PER MANUFACTURER'S SPECIFICATIONS. LOCAL SCOFIELD REP. JIM ORELLA 972.839.3730.

ADD ALTERNATE

C-4 INTEGRAL COLORED CONCRETE PAVING


MANUFACTURER: LOCAL
PRODUCT: INTEGRAL COLORED 8" THICK CONCRETE: SCOFIELD INTEGRAL
COLOR TO BE SELECTED AFTER MOCK-UP SAMPLES. FOLLOWED BY
SCOFILED LITHOCHROME COLORWAX. COLOR SUGGESTED: SG877-4
"ROAST CHESTNUT". APPLY PER MANUFACTURER'S SPECIFICATIONS.
LOCAL SCOFIELD REP. JIM OFELLA 972.833-770.
REFERENCE TOWN OF ADDISON STANDARD DETAILS FOR CONSTRUCTION.

C-5 INTEGRAL COLORED ACCENT BAND CONCRETE PAVING

MANUFACTURER: LOCAL PRODUCT: INTEGRAL COLOR 8" THICK CONCRETE; SCOPIELD INTEGRAL COLOR TO BE SELECTED AFTER MOCK-UP SAMPLES, FOLLOWED BY SCOPILED LITHOCHROME COLORWAX, COLOR SUGGESTED, SCA47-2" SCHOONER BEIGE: APPLY PER MANUFACTURER'S SPECIFICATIONS, LOCAL SCOPIELD REP. JIM ORELL 8 72.339.3730.
REFERENCE TOWN OF ADDISON STANDARD DETAILS FOR CONSTRUCTION.


CERAMIC PRODUCTS

R-1 ROAD REFLECTOR
MANUFACTURER: LOCAL
PRODUCT: YELLOW CERAMIC 4" ROUND ROAD REFLECTOR

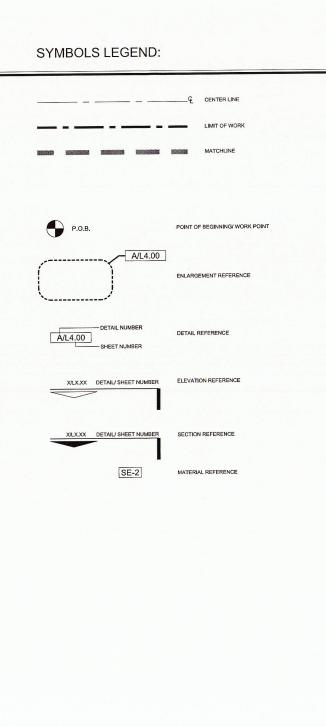

NOTE

SHADED AREA FOR TRAIL AND APPROXIMATELY 10' EITHER SIDE OF TRAIL
REPRESENTS THE GENERAL LIMITS OF WORK, REFER TO ALL GRADING SHEETS FOR ACCURATE LIMITS OF DISTURBANCE AND CORRESPONDING LIMITS OF WORK.

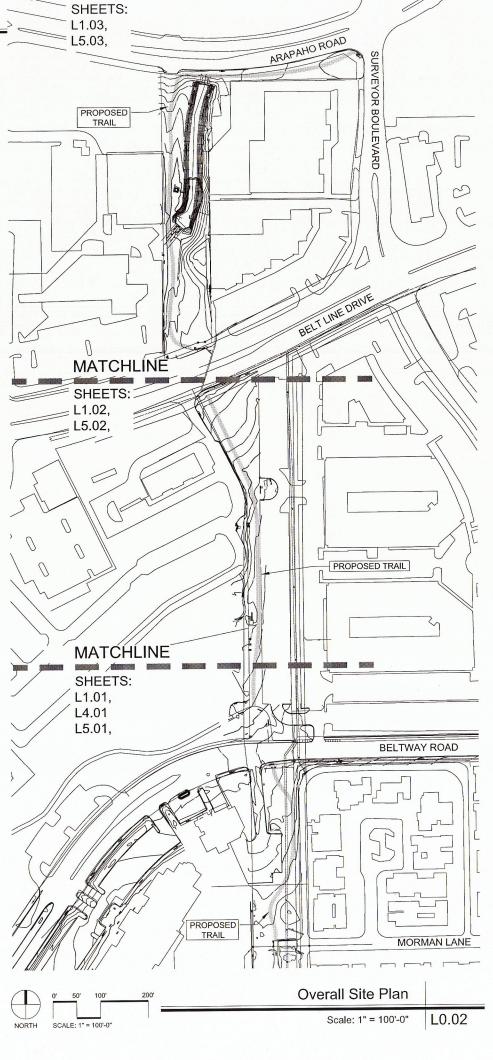

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KE Y MAP PROJECT

Project Name

Addison Pedestrian Connection

Addison, TX. Project No: 14002

Issue Title

Bid Documents

Issue Date: 06.04.2014




Issue / Addenda / Revisions

Date	Description
02.14.2014	90% Review
06.04.2014	100% Review
06.25.2014	100% Review- Town Comments

Drawing Title

Addison Pedestrian Connection: Phase 1 General Notes, Materials, Legend and Overall Site Plan Sheet No.

L0.02

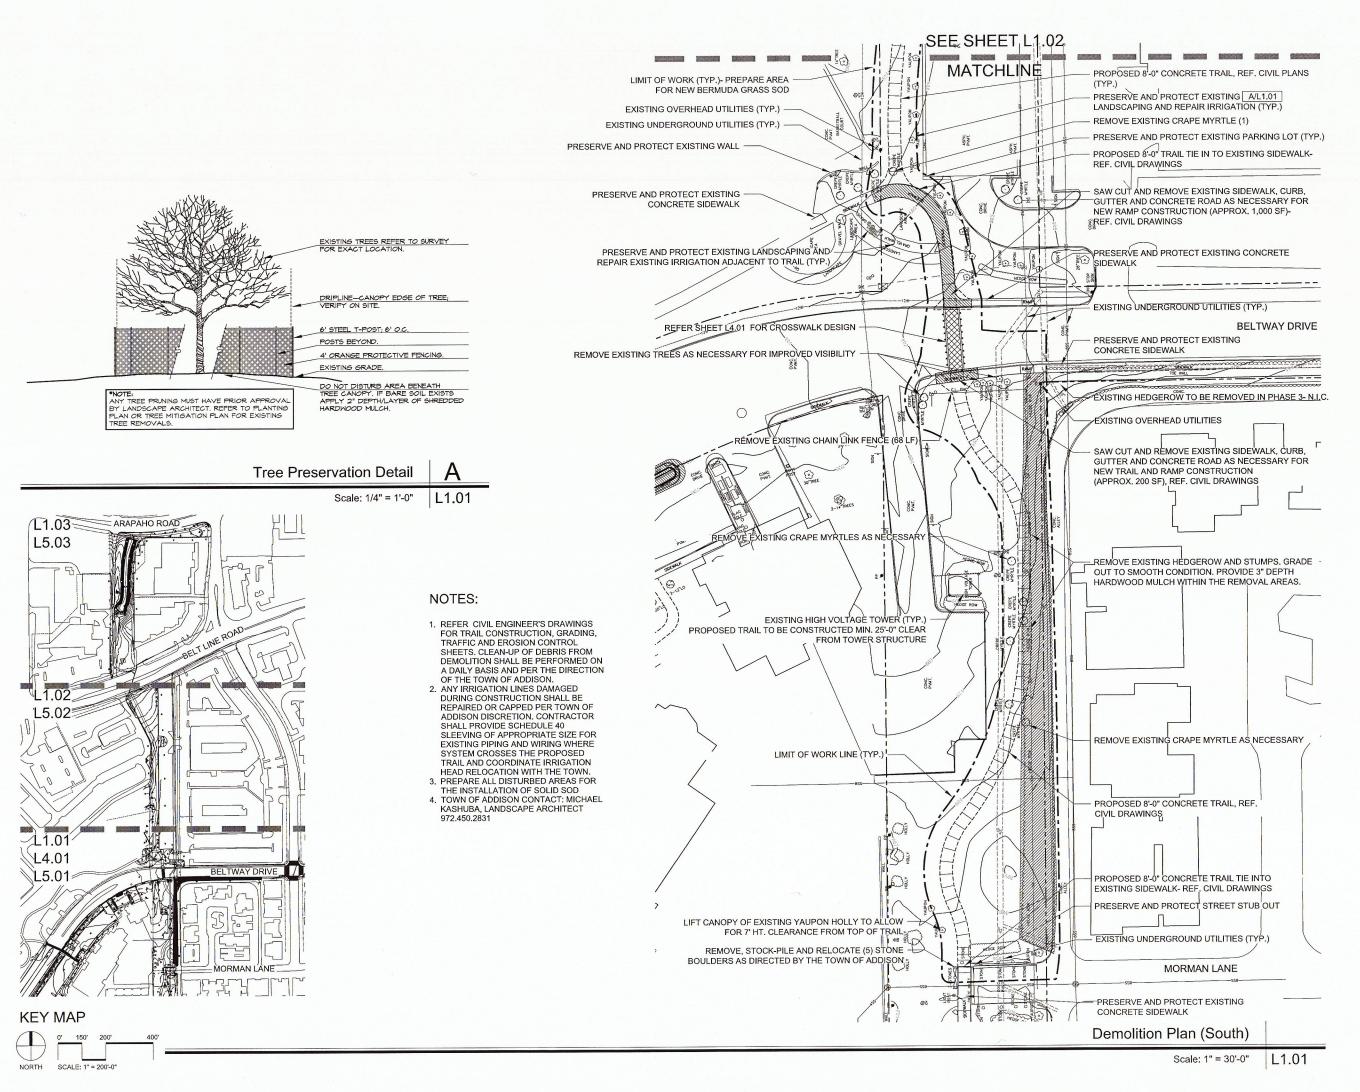

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KE Y MAP



Project Name


Addison Pedestrian Connection

Addison, TX. Project No: 14002

Issue Title

Bid Documents

Issue Date: 06.04.2014

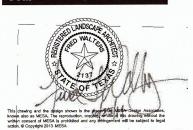


Issue / Addenda / Revision

Date	Description
02.14.2014	90% Review
06.04.2014	100% Review
06.25.2014	100% Review- Town Comments
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Drawing Title

Addison Pedestrian Connection: Phase 1 **Demolition Plan** (South)

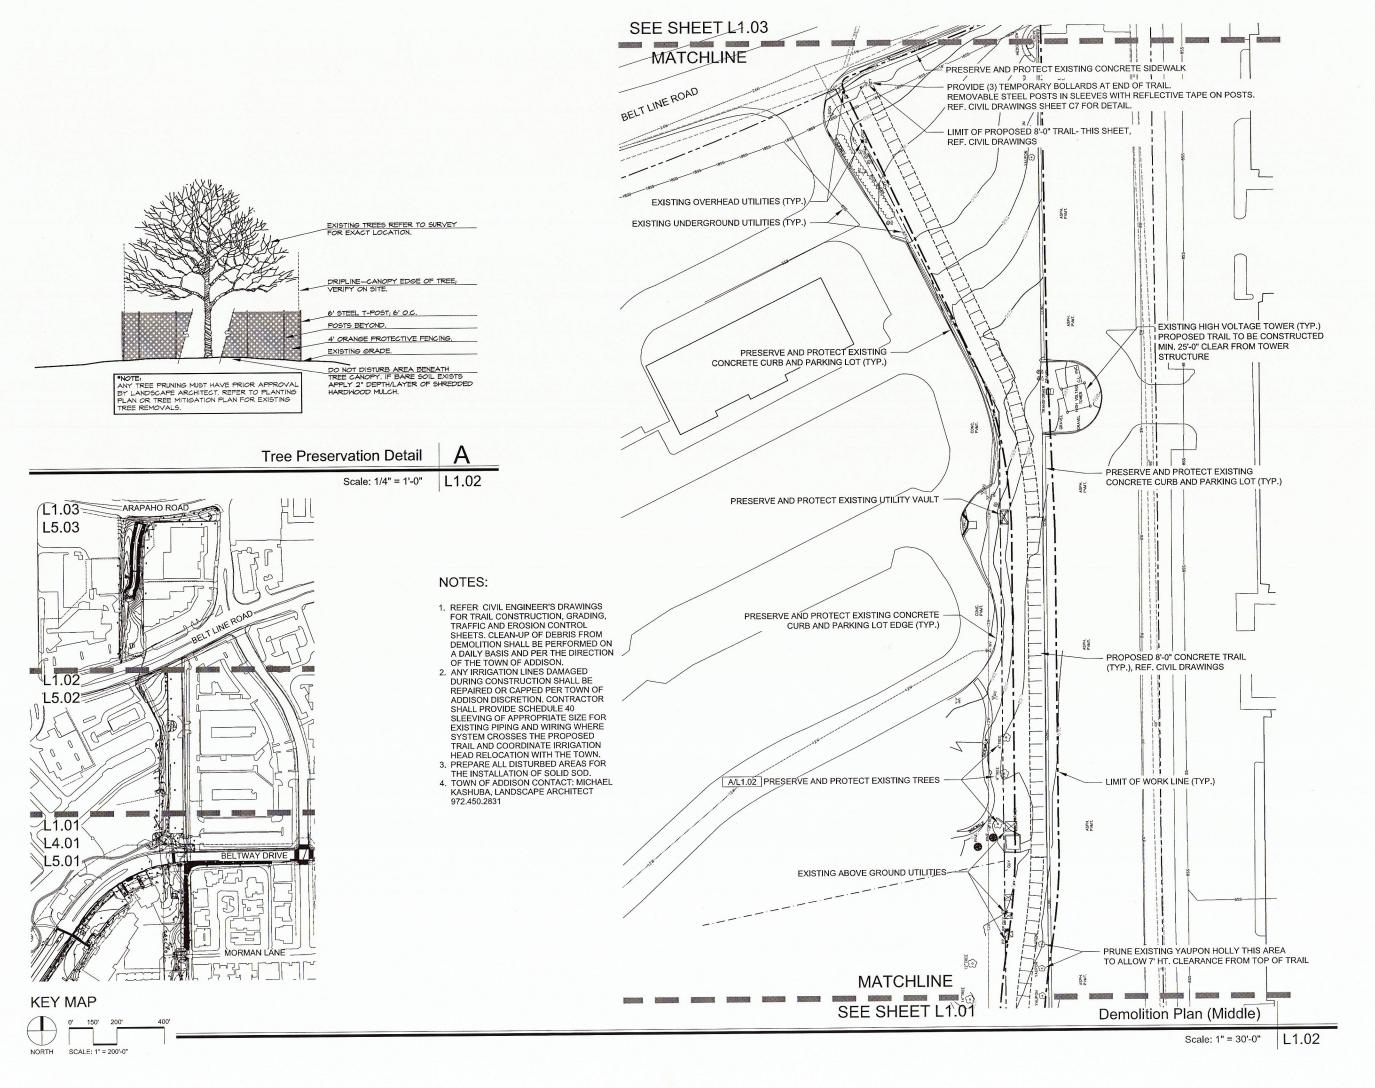

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Project Name


Addison Pedestrian Connection

Addison, TX. Project No: 14002

Issue Title

Bid Documents

Issue Date: 06.04.2014

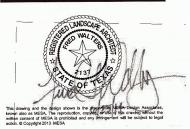


Issue / Addenda / Revisions

Date	Description
02.14.2014	90% Review
06.04.2014	100% Review
06.25.2014	100% Review- Town Comments

Drawing Title

Addison Pedestrian Connection: Phase 1 **Demolition Plan** (Middle)

Sheet No.

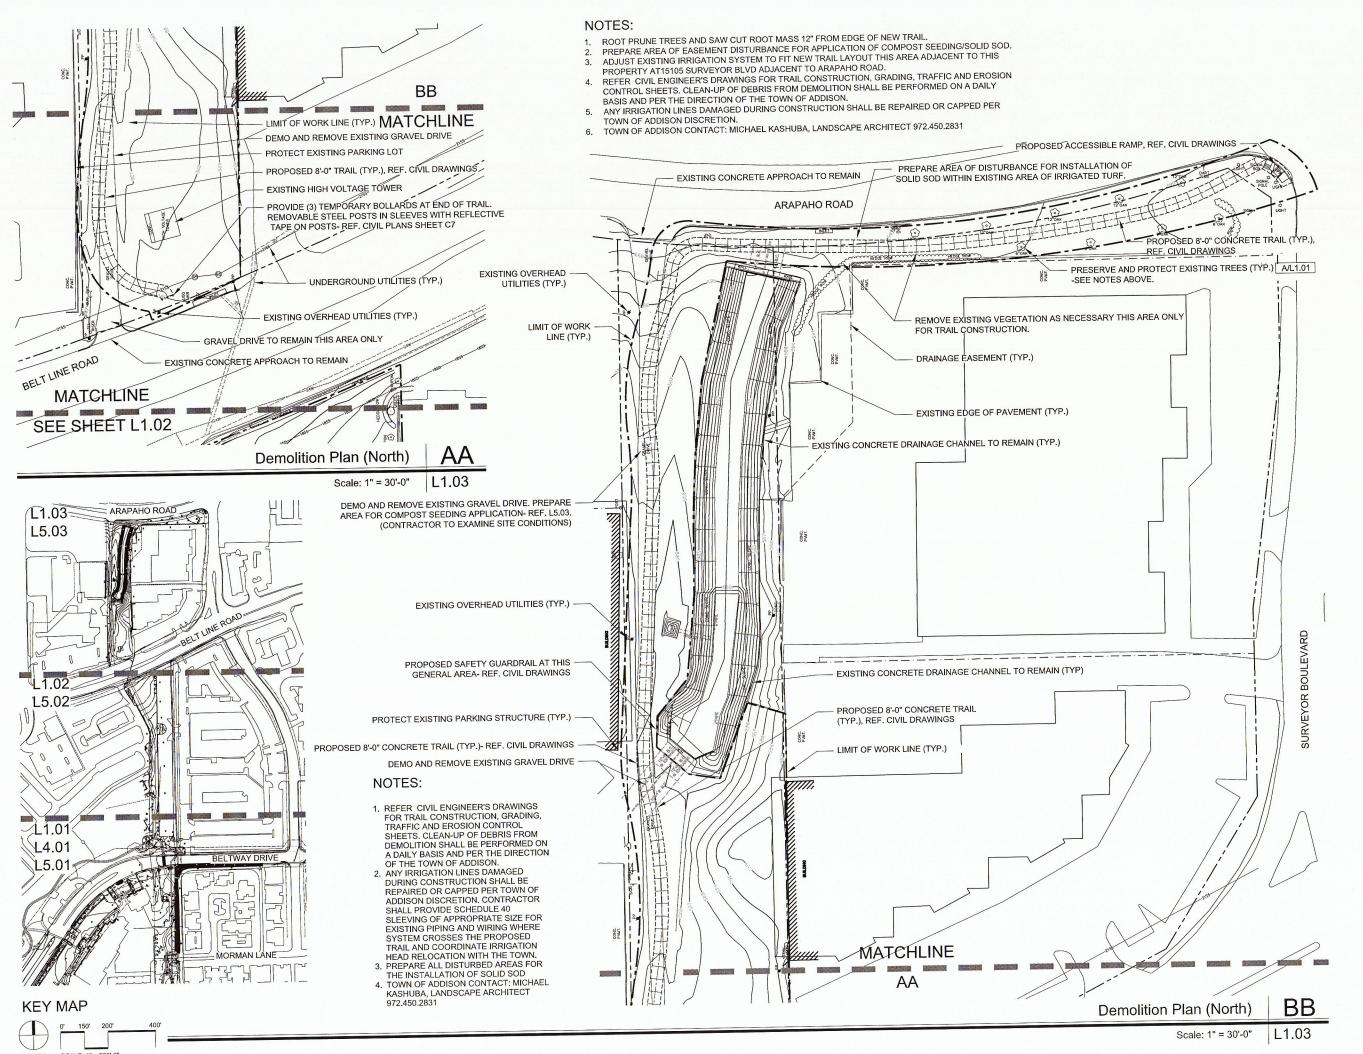

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Project Name

Addison Pedestrian Connection

Addison, TX. Project No: 14002

Issue Title

Bid Documents

Issue Date: 06.04.2014



Issue / Addenda / Revisions

Date		Description
02.14.	2014	90% Review
06.04.	2014	100% Review
06.25.	2014	100% Review- Town Comments
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Drawing Title

Addison Pedestrian Connection: Phase 1 **Demolition Plan** (North)

Sheet No.

L1.03

NOTES: PEDESTRIAN CROSSWALK BASE BID SHALL INCLUDE THE FOLLOWING:

- 1. POWER WASH AND CLEAN APPROX. 400 SF EXISTING CONCRETE ACCORDING TO MANUFACTURER'S RECOMMENDATIONS FOR STAIN APPLICATION
- 2. SAW CUT CONCRETE AS NOTED ON PLAN ENLARGEMENT THIS SHEET
 3. APPLY CHEMICAL STAIN (2 COLOR) AS DESCRIBED ON PLAN ENLARGEMENT THIS SHEET


ADD ALTERNATE:

L1.03

L5.03

ARAPAHO ROAD

- 1. SAW CUT, REMOVE AND DISPOSE OF EXISTING CONCRETE PER CIVIL ENGINEER'S TRAFFIC SAFETY PLAN AND SPECIFICATIONS
 2. PLACE AND FINISH INTEGRAL COLORED CONCRETE AS DESCRIBED ON PLAN ENLARGEMENT THIS SHEET PER TOWN OF ADDISON STANDARD DETAILS FOR CONSTRUCTION.
 3. APPLY COLOR WAX CURING COMPOUND PER MANUFACTURER'S SPECIFICATIONS

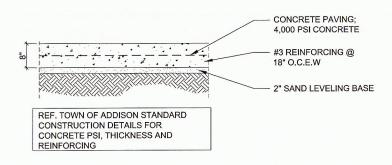

ADD ALTERNATE- INTERGRAL COLOR CONCRETE

NOTES:

SEE CIVIL ENGINEER'S PLANS FOR BOLLARDS, PEDESTRIAN TRAIL SIGNS, STOP BARS, RUMBLE STRIPS AND PEDESTRIAN/VEHICULAR SIGNAGE.

CONCRETE PRODUCTS

C-1 STANDARD CONCRETE PAVING

MANUFACTURER: LOCAL PRODUCT: STANDARD GRAY CONCRETE; 3000 PSI; LIGHT BROOM FINISH

BASE BID

C-2 STAINED CONCRETE PAVING

C-3 STAINED ACCENT BAND CONCRETE PAVING

SUPPLIER: SCOFIELD LITHOCHROME CHEMSTAIN. COLOR TO BE SELECTED AFTER MOCK-UP SAMPLES. COLOR SUGGESTED: CS-15 "ANTIQUE AMBER". APPLY FOR MANUFACTURER'S SPECIFICATIONS. LOCAL SCOFIELD REP. JIM ORELLA 972.839.3730.

ADD ALTERNATE

C-4 INTEGRAL COLORED CONCRETE PAVING


MANUFACTURER: LOCAL PRODUCT: INTEGRAL COLORED 8" THICK CONCRETE; SCOFIELD INTEGRAL COLORT OB SELECTED AFTER MOCK-UP SAMPLES, FOLLOWED BY SCOFILED LITHOCHROME COLORIVAX. COLOR SUGGESTED: SGG77-4" TROAST CHESTNUT". APPLY PER MANUFACTURER'S SPECIFICATIONS. LOCAL SCOFIELD REP. JIM ORELLA 972.283.3730.

C-5 INTEGRAL COLORED ACCENT BAND CONCRETE PAVING

MANUFACTURER: LOCAL PRODUCT: INTEGRAL COLOR 8" THICK CONCRETE; SCOFIELD INTEGRAL COLOR 10 OR SELECTED AFTER MOCK-UP SAMPLES, FOLLOWED BY SCOFILED LITH-IOCHROME COLORWAX, COLOR SUGGESTED: SC447-2 "SCHOONER BEIGE", APPLY PER MANUFACTURER'S SPECIFICATIONS, LOCAL SCOFIELD REP. JIM ORELLA 972.839.3730.

CERAMIC PRODUCTS


R-1 ROAD REFLECTOR
MANUFACTURER: LOCAL
PRODUCT: YELLOW CERAMIC 4" ROUND

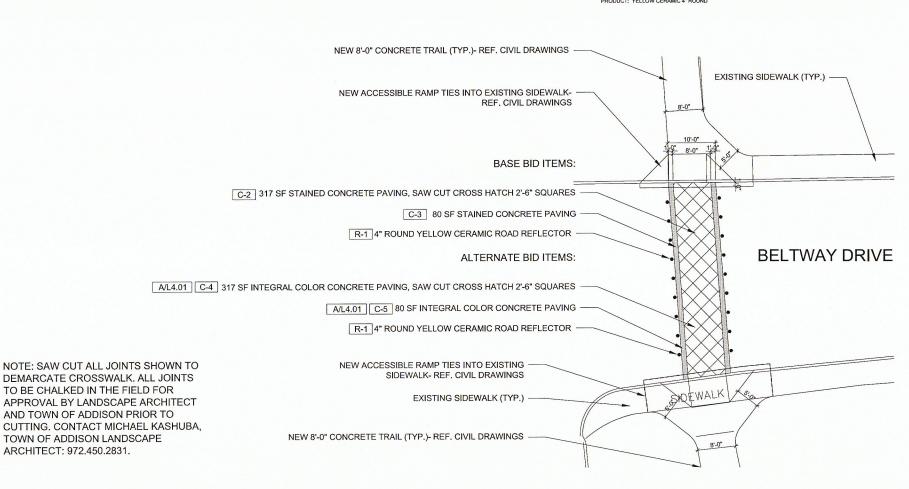

/L1.01

L4.01

L5.01

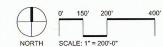

Crosswalk Sawing and Staining Detail

Scale: 1" = 10'-0" L4.01

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KE Y MAP

Project Name

Addison Pedestrian Connection

Addison, TX. Project No: 14002

Issue Title

Bid Documents

Issue Date: 06.04.2014



Issue / Addenda / Revisions

Date	Description
02.14.2014	90% Review
06.04.2014	100% Review
06.25.2014	100% Review- Town Comment
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Drawing Title

Addison Pedestrian Connection: Phase 1 Crosswalk Sawing and Staining Detail

Sheet No.

L4.01




SOLID SOD

BERMUDA GRASS SOD OR APPROVED EQUAL

L1.03= ARAPAHO ROAD L5.03 £1.01 L4.01 L5.01

NOTE:

CONTRACTOR IS RESPONSIBLE FOR ALL AREAS DISTURBED DURING CONSTRUCTION, WHETHER DEPICTED IN PLANS OR NOT. SEEDING/SODDING AND WATERING SHALL BE INCLUDED IN BID TO ENSURE STABILIZATION OF GROUND PLANE RESULTING FROM CONSTRUCTION. ANY IRRIGATION LINES DAMAGED DURING CONSTRUCTION SHALL BE REPAIRED OR CAPPED PER TOWN OF ADDISON DISCRETION. CONTRACTOR SHALL PROVIDE SCHEDULE 40 SLEEVING OF APPROPRIATE SIZE FOR EXISTING PIPING AND WIRING WHERE SYSTEM CROSSES THE PROPOSED TRAIL AND COORDINATE IRRIGATION HEAD RELOCATION WITH THE TOWN.

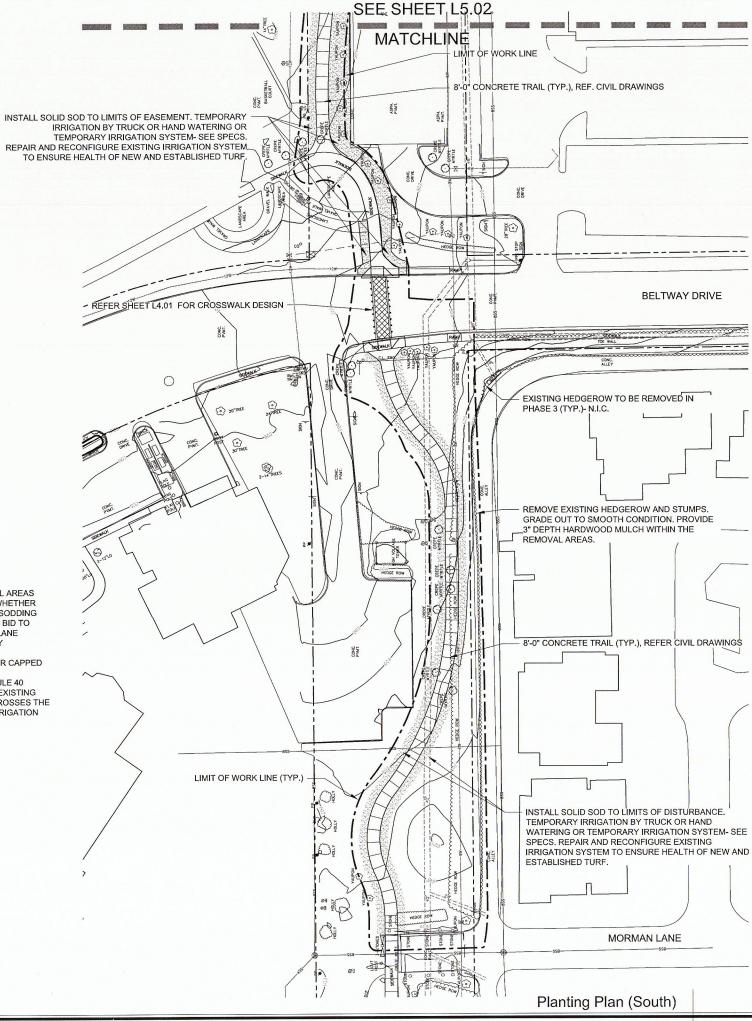

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KE Y MAP



Project Name

Addison Pedestrian Connection

Addison, TX. Project No: 14002

Issue Title

Bid Documents

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Date	Description
02.14.2014	90% Review
06.04.2014	100% Review
06.25.2014	100% Review- Town Comments

Drawing Title


Addison Pedestrian Connection: Phase 1 Planting Plan (South)

Sheet No.

L5.01


LANDSCAPE LEGEND SOLID SOD

BERMUDA GRASS SOD OR APPROVED EQUAL

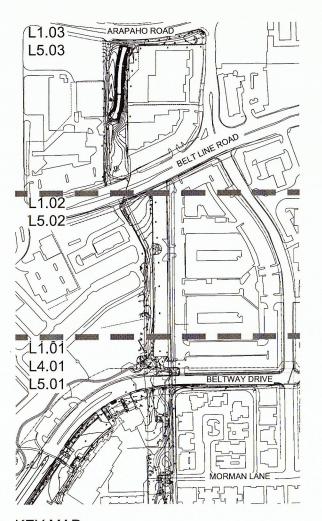

NOTE:

CONTRACTOR IS RESPONSIBLE FOR ALL AREAS DISTURBED DURING CONSTRUCTION, WHETHER DEPICTED IN PLANS OR NOT. SEEDING/SODDING AND WATERING SHALL BE INCLUDED IN BID TO ENSURE STABILIZATION OF GROUND PLANE RESULTING FROM CONSTRUCTION. ANY IRRIGATION LINES DAMAGED DURING CONSTRUCTION SHALL BE REPAIRED OR CAPPED PER TOWN OF ADDISON DISCRETION.
CONTRACTOR SHALL PROVIDE SCHEDULE 40 SLEEVING OF APPROPRIATE SIZE FOR EXISTING PIPING AND WIRING WHERE SYSTEM CROSSES THE PROPOSED TRAIL AND COORDINATE IRRIGATION HEAD RELOCATION WITH THE TOWN.

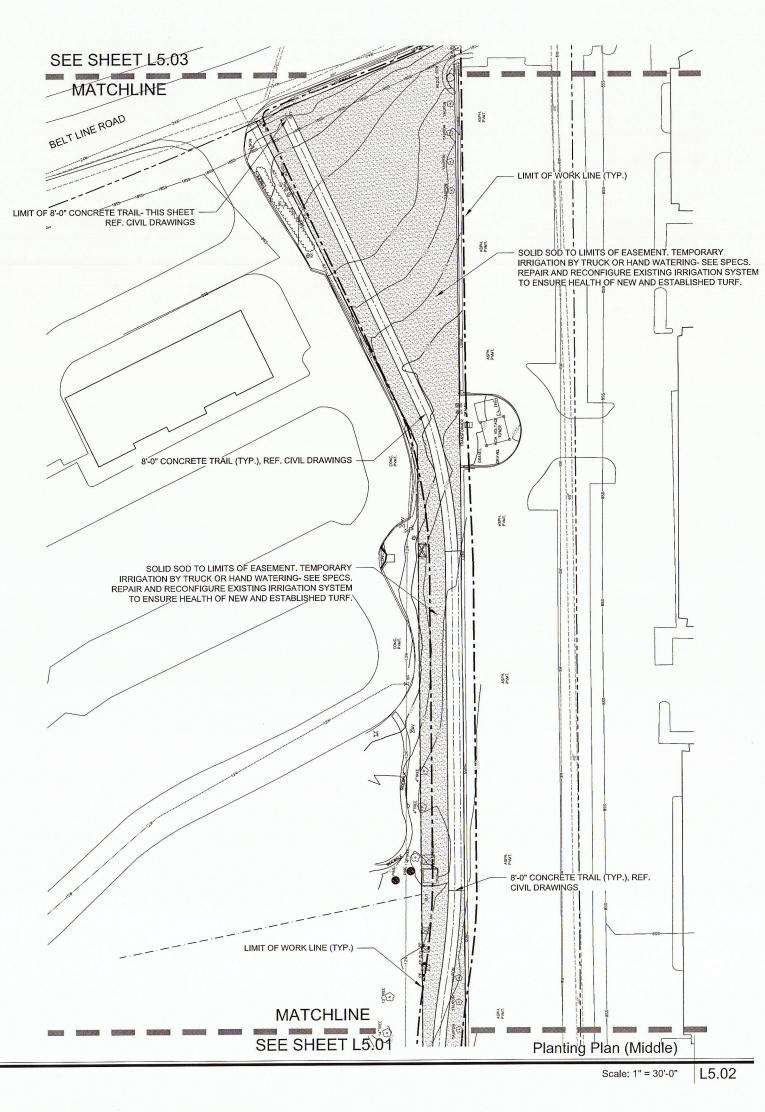

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MESA 214.871.1507 fax mesadesigngroup.com

KE Y MAP



Project Name

Addison Pedestrian Connection

Addison, TX. Project No: 14002

Issue Title

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Issue Date: 06.04.2014



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Date	Description
02.14.2014	90% Review
06.04.2014	100% Review
06.25.2014	100% Review- Town Comments


Drawing Title

Addison Pedestrian Connection: Phase 1 Planting Plan (Middle)

Sheet No.

L5.02



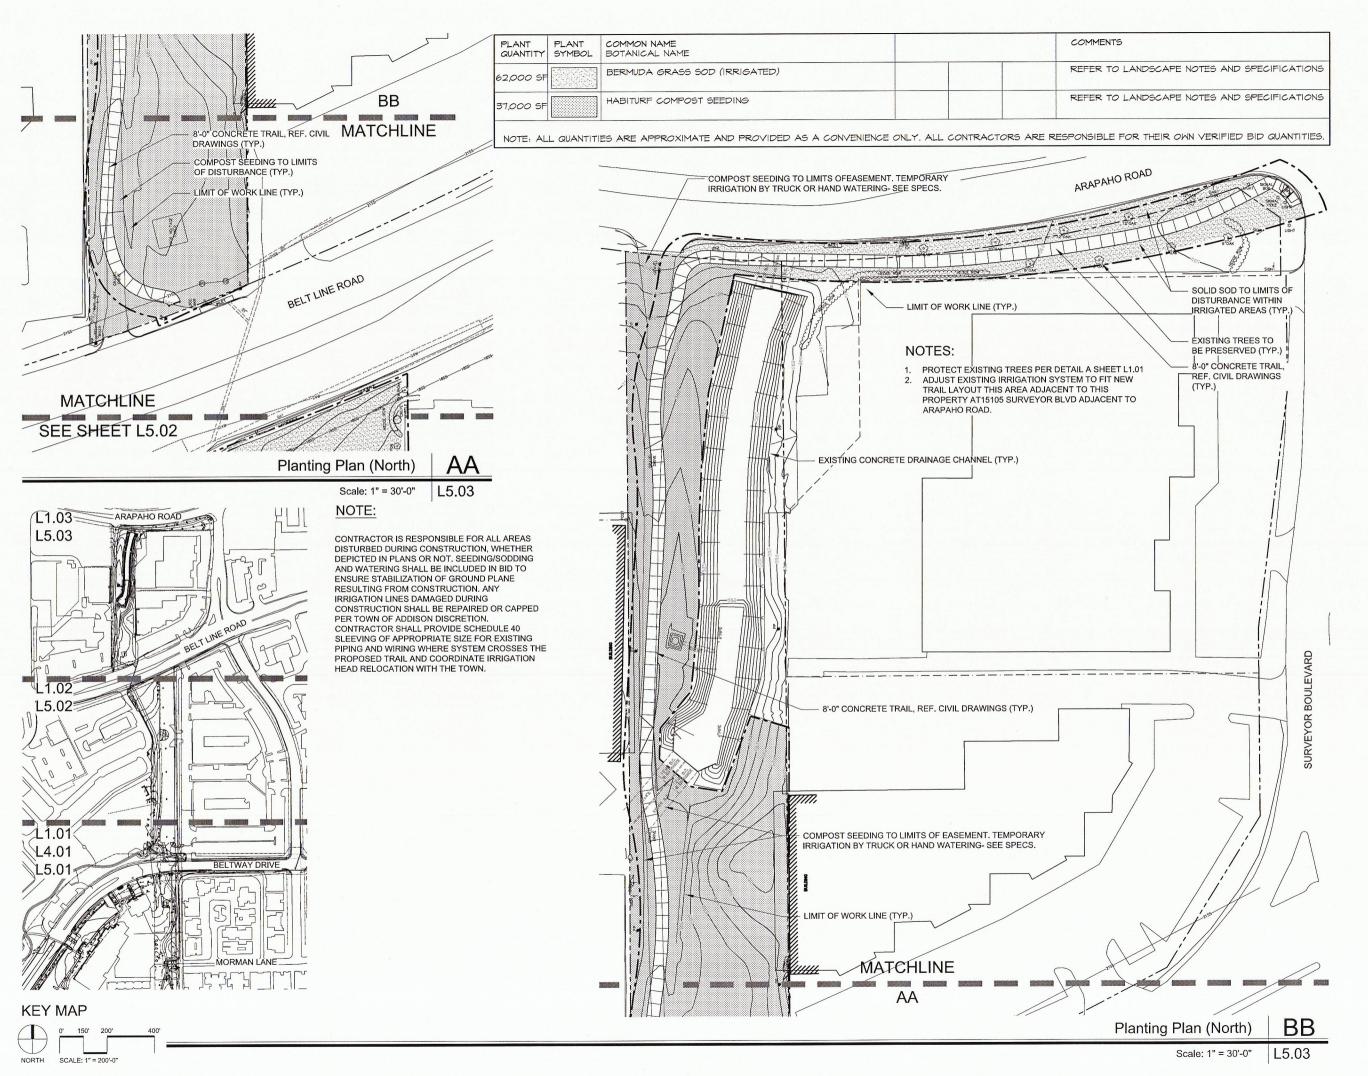

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Project Name

Addison Pedestrian Connection


Addison, TX. Project No: 14002

Issue Title

Bid Documents

Issue Date: 06.04.2014

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Issue / Addenda / Revisions

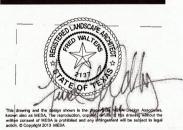Date	Description
02.14.2014	90% Review
06.04.2014	100% Review
06.25.2014	100% Review- Town Comments
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Drawing Title

Addison Pedestrian Connection: Phase 1 Planting Plan (North)

Sheet N

L5.03

GENERAL NOTES

- ALL CONSTRUCTION SHALL BE IN STRICT ACCORDANCE WITH THE CONSTRUCTION STANDARDS OF THE TOWN OF ADDISON AND GOVERNED BY THE NORTH CENTRAL TEXAS COUNCIL OF GOVERNMENT'S (NCTCOG) STANDARD SPECIFICATIONS FOR PUBLIC WORKS CONSTRUCTION, 3RD EDITION.
- IN CASE OF CONFLICT OR CONTRADICTIONS BETWEEN THE CONSTRUCTION STANDARDS OF THE TOWN OF ADDISON AND THE NCTCOG SPECIFICATIONS, THE CONSTRUCTION STANDARDS OF THE TOWN OF ADDISON PRESIDE.
- IT IS THE CONTRACTOR'S RESPONSIBILITY TO MAKE ARRANGEMENTS WITH THE OWNERS OF UNDERGROUND FACILITIES PRIOR TO WORKING IN THE AREA TO CONFIRM THEIR LOCATION. THE CONTRACTOR SHALL PRESERVE AND PROTECT ALL UNDERGROUND FACILITIES.
- WHERE EXISTING UTILITIES OR SERVICE LINES ARE CUT, BROKEN OR DAMAGED, THE CONTRACTOR SHALL REPLACE OR REPAIR THE UTILITIES OR SERVICE LINES WITH THE SAME TYPE OF ORIGINAL MATERIAL AND CONSTRUCTION, OR BETTER, UNLESS OTHERWISE SHOWN OR NOTED ON THE PLANS, AT HIS OWN COST AND EXPENSE. THE CONTRACTOR SHALL IMMEDIATELY NOTIFY THE TOWN AT ONCE OF ANY CONFLICTS IN GRADES AND ALIGNMENT.
- FOR FRANCHISE UTILITY LOCATOR SERVICES, CALL TEXAS 811
- THE CONTRACTOR SHALL RESTORE ALL AREAS DISTURBED BY CONSTRUCTION TO ORIGINAL CONDITION OR BETTER. RESTORED AREAS INCLUDE, BUT ARE NOT LIMITED TO TRENCH BACKFILL, SIDE SLOPES, FENCES, CULVERT PIPES, DRAINAGE DITCHES, IRRIGATION, SODDING OR SEEDING, DRIVEWAYS, PRIVATE YARDS AND ROADWAYS.
- THE CONTRACTOR SHALL TAKE ALL NECESSARY PRECAUTIONS TO PROTECT EXISTING FACILITIES FROM DAMAGE. ANY DAMAGE
 TO EXISTING FACILITIES RESULTING FROM CONSTRUCTION WORK SHALL BE REPAIRED AT THE CONTRACTOR'S EXPENSE.
- ALL EXCESS EXCAVATED MATERIAL AND STRIPPINGS SHALL BECOME THE PROPERTY OF THE CONTRACTOR AND SHALL BE DISPOSED OF IN A PROPER MANNER OFF THE PROJECT SITE.

SAFETY

ALL CONTRACTORS AND DEVELOPERS, WITH THEIR EMPLOYEES AND AGENTS, SHALL COMPLY WITH ALL APPLICABLE FEDERAL, STATE AND LOCAL SAFETY LAWS AND REGULATIONS INCLUDING BUT NOT LIMITED TO THE OCCUPATIONAL SAFETY AND HEALTH ACT OF 1970, ORDINANCES, RULES, REGULATIONS AND ORDERS OR ANY PUBLIC AUTHORITY HAVING JURISDICTION FOR THE SAFETY OF PERSONS OR PROPERTY TO PROTECT THEM FROM DAMAGE, INJURY OR LOSS. THE CONTRACTOR SHALL PROVIDE, ERECT AND MAINTAIN, AS REQUIRED BY EXISTING CONDITIONS AND PROGRESS OF THE WORK, ALL REASONABLE SAFEGUARDS FOR SAFETY AND PROTECTION, INCLUDING PROVIDING AND MAINTAINING SIGNS IN ACCORDANCE WITH THE MOST CURRENT BARRICADE AND CONSTRUCTION STANDARDS FROM THE TEXAS MANUAL OF UNIFORM CONTROL DEVICES (AND OTHER SUCH BARRICADES AND SIGNS AS DEEMED NECESSARY BY THE TOWN ENGINEER), PROMULGATED SAFETY REGULATIONS AND NOTIFYING OWNERS AND USERS OF ADJACENT UTILITIES. SAFETY PRECAUDINGS SHALL INCLUDE BUT NOT BE LIMITED TO COMPLIANCE WITH ALL FEDERAL, STATE AND LOCAL STANDARDS, LAWS, ORDINANCES AND STANDARDS FOR DESIGN AND IMPLEMENTATION OF TRENCH SAFETY, CONFINED SPACE, TRAFFIC CONTROL, AND UTILITY NOTIFICATION.

PAVING - GENERAL NOTES

- - A. CONCRETE STRENGTH SHALL BE AS SHOWN IN ITEM 3 (NCTCOG LATEST EDITION).
 - B. ALL CURBS SHALL BE INTEGRAL WITH PAVEMENT AND SHALL BE OF THE SAME STRENGTH AS CONCRETE PAVEMENT.
 - C. DETAIL AND ARRANGEMENT OF PAVEMENT JOINTS, ALL TYPES, SHALL BE AS SHOWN ON THE TOWN STANDARD CONSTRUCTION DETAILS UNLESS OTHERWISE NOTED.
 - D. BAR LAPS SHALL BE THIRTY DIAMETERS.
 - E. REINFORCING STEEL SHALL BE AS SHOWN ON THE TOWN STANDARD CONSTRUCTION DETAILS UNLESS OTHERWISE NOTED.
- 2. REBAR SHALL BE SUPPORTED BY BAR CHAIRS OR OTHER DEVICES APPROVED BY TOWN ENGINEER.
- 3. PAVEMENT THICKNESS AND STRENGTHS SHALL BE AS FOLLOWS:

STREET - 8" CLASS "P1" OR "P2. SIDEWALK AND BFR's-6"-CLASS "A"

- 4. CONCRETE MIX DESIGN SHALL BE AS DEFINED BY NCTCOG 303.3.
- 5. ONCE A CURB ABUTTING A THOROUGHFARE HAS BEEN SAWCUT AND REMOVED, THE CONTRACTOR MUST REPLACE THE CONCRETE WITH A NEW POUR (i.e. DRIVEWAY) WITHIN 14 CALENDAR DAYS. LIQUIDATED DAMAGES WILL BE ASSESSED AT \$500 PER DAY FOR EACH CALENDAR DAY IN EXCESS OF 14 CALENDAR
- 6. ALL SIDEWALKS AND ACCESSIBLE ROUTES SHALL HAVE A MAXIMUM LONGITUDINAL SLOPE OF 5% AND A MAXIMUM CROSS SLOPE OF 2%
- SPACING AND CONSTRUCTION OF JOINTS SHALL CONFORM TO TOWN OF ADDISON CONCRETE SIDEWALK EXPANSION JOINT DETAIL UNLESS OTHERWISE NOTED.
- 8. ALL SIDEWALK REINFORCEMENT SHALL BE #3 STEEL 24" O.C. (TRANSVERSE) 18" O.C. (LONGITUDINAL).
- 9. 1-INCH CUSHION SAND REQUIRED ON SUBGRADE COMPACTED WITHIN 95% STANDARD PROCTOR
- 10. POURS SHALL REQUIRE A PRE-POUR INSPECTION FOR FORMWORK, REINFORCEMENT AND GEOMETRY. VISUAL INSPECTIONS MAY BE MADE AFTER THE POUR TO ADDRESS TOOLED JOINTS, FINISH, SUBGRADE INTEGRITY, ETC.
- 11. ENSURE THAT FLATWORK DOES NOT OBSCURE ABOVE-GROUND APPURTENANCES (I.E. VALVES, MH
- 12. EXPOSED AGGREGATE CONCRETE IS NOT ACCEPTABLE FOR SIDEWALK WITHIN PUBLIC RIGHT-OF-WAY.
- 13. FOR CURB DETAIL SEE CURB AND GUTTER & ASPHALT PAVING CROSS SECTION

SURVEY LEGEND:

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0	СО	IMB)	MAILBOX	#	PP	0	CREPE MYRTLE	
T	TELEPHONE MH	(58)	SIGNAL BOX	\$	LAMP POST	0	LUGO TOFF	
E	ELECTRIC MH	TEL	TELEPHONE RISER	\bowtie	WATER VALVE	(3)	MISC. TREE	
83	SANITARY SEWER MH	© ICV	IRRIGATION CONTROL VALVE	⊗.	WATER METER	*	PINE TREE	
0	STORM DRAIN MH	⊗ GM	GAS METER	(2)	OAK TREE	*	HACKBERRY TREE	
©	GAS MH	独	FIRE HYDRANT		PECAN TREE	ST.	ACU TOEF	
	STREET SIGN	ØĐ	MISC. MH		FECAN INCL	卷	ASH TREE	
							CEDAR TREE	

GENERAL NOTES FOR PEDESTRIAN FACILITIES

- 1. ALL SLOPES ARE MAXIMUM ALLOWABLE. THE LEAST POSSIBLE SLOPE THAT WILL STILL DRAIN PROPERLY SHOULD BE USED. ADJUST CURB RAMP LENGTH OR GRADE OF APPROACH SIDEWALKS AS DIRECTED
- 2. LANDINGS SHALL BE 5'X5' MINIMUM WITH A MAXIMUM 2% SLOPE IN ANY DIRECTION.
- MANEUVERING SPACE AT THE BOTTOM OF CURB RAMPS SHALL BE A MINIMUM OF 4'X4'
 WHOLLY CONTAINED WITHIN THE CROSSWALK AND WHOLLY OUTSIDE THE PARALLEL
 VEHICULAR TRAVEL PATH.
- 4. MAXIMUM ALLOWABLE CROSS SLOPE ON SIDEWALK AND CURB RAMP SURFACES IS 2%
- CURB RAMPS WITH RETURNED CURBS MAY BE USED ONLY WHERE PEDESTRIANS WOULD NOT NORMALLY WALK ACROSS THE RAMP, BITHER BECAUSE THE ADJACENT SURFACE IS PLANTING OR OTHER NON-WALKING SURFACE OR BECAUSE THE SIDE APPROACH IS SUBSTANTIALLY OBSTRUCTED. OTHERWISE, PROVIDE FLARED SIDES.
- ADDITIONAL INFORMATION ON CURB RAMP LOCATION, DESIGN, LIGHT REFLECTIVE VALUE AND TEXTURE MAY BE FOUND IN THE CURRENT EDITION OF THE TEXAS ACCESSIBILITY STANDARDS (TAS) AND 16 TAC §68.102.
- 7. CURB RAMPS SHALL BE ALIGNED WITH THEORETICAL CROSSWALKS, OR AS DIRECTED
- 8. HANDRAILS ARE NOT REQUIRED ON CURB RAMPS. PROVIDE CURB RAMPS WHEREVER ON ACCESSIBLE ROUTE CROSSES (PENETRATES) A CURB.
- 9. FLARE SLOPE SHALL NOT EXCEED 10% MEASURED ALONG CURB LINE.
- 10. BARRIER FREE RAMPS SHALL BE CONSTRUCTED IN ACCORDANCE WITH THE CURRENT EDITION OF THE TEXAS ACCESSIBILITY STANDARDS (TAS).
- 11. ALL BARRIER FREE RAMPS MUST PASS AN INDEPENDENT INSPECTION. A LETTER OF COMPLIANCE ACCEPTANCE IS REQUIRED PRIOR TO FINAL ACCEPTANCE BY THE TOWN OF
- 12. STREETS ON STEEP GRADE WILL REQUIRE LONGER TRANSITION ON UPGRADE SIDE.
- 13. MAXIMUM SLOPE ON RAMP PORTION SHALL NOT EXCEED 1" PER FOOT AT ANY LOCATION. VERTICAL DISTANCE BETWEEN STREET AND RAMP SHALL NOT EXCEED $\frac{1}{2}$ ".

GENERAL NOTES FOR DETECTABLE WARNINGS

- 1. CURB RAMPS MUST CONTAIN A DETECTABLE WARNING SURFACE THAT CONSIST OF RAISED TRUNCATED DOMES COMPLYING WITH SECTION 4.29 OF THE TEXAS ACCESSIBILITY STANDARDS (TAS). THE SURFACE MUST CONTRAST VISUALLY WITH THE ADJOINING SURFACES, INCLUDING SIDE FLARES. FURNISH DARK RED COLORED DETECTABLE WARNING SURFACE ADJACENT TO UNCOLORED CONCRETE AND CREAM COLORED DETECTABLE WARNING SURFACE ADJACENT TO DARK RED COLORED BRICK PAVERS.
- 2. DETECTABLE WARNING SURFACES MUST BE SLIP RESISTANT AND NOT ALLOW WATER TO ACCUMULATE.
- ALIGN TRUNCATED DOMES IN THE DIRECTION OF PEDESTRIAN TRAVEL WHEN ENTERING THE STREET.
- 4. DETECTABLE WARNING SURFACES SHALL BE A MINIMUM OF 24" IN DEPTH IN THE DIRECTION OF PEDESTRIAN TRAVEL, AND EXTEND THE FULL WIDTH OF THE CURB RAMP OR LANDING WHERE THE PEDESTRIAN ACCESS ROUTE ENTERS THE STREET.
- 5. DETECTABLE WARNING SURFACES SHALL BE LOCATED SO THAT THE EDGE NEAREST THE CURB LINE IS A MINIMUM OF 6" AND A MAXIMUM OF 8" FROM THE EXTENSION OF THE FACE OF CURB AND SHALL BE AN INTEGRAL PART OF THE WALKING SURFACE. DETECTABLE WARNING SURFACES MAY BE CURVED ALONG THE CORNER RADIUS.

GENERAL NOTES FOR DETECTABLE WARNING PAVER UNITS

- DETECTABLE WARNING PAVER UNITS SHALL MEET OR EXCEED ALL REQUIREMENTS OF ASTM C-936, C-33, AND BE LAID IN A TWO BY TWO UNIT BASKET WEAVE PATTERN OR AS DIRECTED.
- LAY FULL-SIZE UNITS FIRST FOLLOWED BY CLOSURE UNITS CONSISTING OF AT LEAST 25
 PERCENT OF A FULL UNIT. CUT DETECTABLE WARNING PAVER UNITS USING A POWER SAW.

EROSION CONTROL PLAN NOTES

- ALL OPERATORS AND/OR CONTRACTORS SHALL CONFORM TO THE TERMS AND CONDITIONS OF THE TEXAS COMMISSION ON ENVIRONMENTAL QUALITY (TCEQ), TPDES GENERAL PERMIT NO. TXR 150000 ISSUED AND DATED MARCH 5, 2003.
- 2. THE NOTICE OF INTENT (NOI), AS REQUIRED BY THE GENERAL PERMIT, MUST BE PROPERLY PREPARED AND DISPLAYED ON SITE AT ALL TIMES BY EACH OPERATOR.
- ALL RELEASES OF THE REPORTABLE QUANTITIES OF HAZARDOUS SUBSTANCES SHALL BE REPORTED IMMEDIATELY TO THE FACILITY OPERATOR, EPA AND TCEQ.
- 4. QUALIFIED OPERATOR PERSONNEL MUST INSPECT THE SITE AT LEAST ONCE EVERY 14 DAYS AND WITHIN 24 HOURS OF A STORM EVENT OF 0.5 INCHES OR GREATER. AS AN ALTERNATIVE, AN INSPECTION CAN BE CONDUCTED ONCE EVERY SEVEN (7) CALENDAR DAYS ON A DEFINED DAY. A DECISION ON WHICH METHOD TO USE MUST BE DECIDED BEFORE WORK BEGINS AND MUST BE FOLLOWED THROUGHOUT
- *5. MODIFICATIONS TO THE STORM WATER POLLUTION PREVENTION PLAN SHALL BE IMPLEMENTED AND BE IN-PLACE WITHIN A SEVEN CALENDAR DAY PERIOD.
- 6. IF ANY CONTRACTOR SEES A VIOLATION BY AN OPERATOR OR ANOTHER CONTRACTOR, THAT OPERATOR OR CONTRACTOR IN VIOLATION SHALL BE NOTIFIED AS WELL AS THE FACILITY OPERATOR.
- 7. EROSION CONTROL SHALL BE INSTALLED PRIOR TO GRADING.
- 8. ACCUMULATED SILT DEPOSITS SHALL BE REMOVED FROM SILT FENCES AND HAY BALE DIKES WHEN SILT DEPTH REACHES THREE INCHES OR 25%.
- 9. THE CONTRACTOR SHALL ADD OR DELETE EROSION PROTECTION AT THE REQUEST AND DIRECTION OF THE OPERATOR OR TOWN. $\begin{tabular}{lllll} \hline \end{tabular} } \begin{tabular}{lllll} \end{tabular}$
- 10. AFTER INSTALLATION OF PAVEMENT, FINAL LOT BENCHING AND GENERAL CLEANUP, THE CONTRACTOR SHALL ESTABLISH GRASS GROUNDCOVER IN ALL STREET PARKWAYS, LOT AND ALL OTHER DISTURBED AREAS. SODDING SHALL BE DONE AS SPECIFIED BY SECTION 202.5 AND SEEDING AS SPECIFIED BY SECTION 202.6 OF THE OCTOBER 2004 OR LATEST EDITION OF NCTCOG STANDARD

EROSION CONTROL PLAN NOTES CONT'D


- 11. IT SHALL BE THE CONTRACTOR'S RESPONSIBILITY TO CONTROL AND LIMIT SILT AND SEDIMENT LEAVING THE SITE. SPECIFICALLY, THE CONTRACTOR SHALL PROTECT ALL PUBLIC STREETS, ALLEYS, STREAMS AND STORM DRAINAGE SYSTEMS FROM EROSION DEPOSITS.
- 12. CONSTRUCTION WASTE DISPOSAL CONTAINERS SHALL BE PROVIDED ON THE SITE FOR DISPOSAL OF ALL NON-HAZARDOUS CONSTRUCTION WASTE MATERIALS. THE CONTAINERS SHALL BE HAULED TO LANDFILL BY THE CONTRACTOR.
- ALL HAZARDOUS MATERIALS SHALL BE HANDLED AND DISPOSED OF BY THE CONTRACTOR IN ACCORDANCE WITH FEDERAL, STATE AND LOCAL REGULATIONS.


SILT FENCE NOTES

- 1. POSTS WHICH SUPPORT THE SILT FENCE SHALL BE INSTALLED ON A SLIGHT ANGLE TOWARD THE ANTICIPATED RUNOFF SOURCE. THE POST MUST BE EMBEDDED A MINIMUM OF 18 INCHES.
- THE TOE OF THE SILT FENCE SHALL BE TRENCHED IN WITH A SPADE OR MECHANICAL TRENCHER, SO THAT THE DOWNSLOPE FACE OF THE TRENCH IS FLAT AND PERPENDICULAR TO THE LINE OF FLOW. WHERE FENCE CANNOT BE TRENCHED IN (E.G. PAVEMENT): WEIGHT FABRIC FLAP WITH WASHED CRAVE! ON THE IMPHILL SIDE TO PREVENT FLOW UNDER FENCE.
- 3. THE TRENCH MUST BE A MINIMUM OF 6 INCHES DEEP AND 6 INCHES WIDE TO ALLOW FOR THE SILT FENCE FABRIC TO BE LAID IN THE GROUND AND BACKFILLED WITH COMPACTED MATERIAL.
- SILT FENCE SHALL BE SECURELY FASTENED TO EACH SUPPORT POST OR TO WOVEN WIRE, WHICH IS IN TURN ATTACHED TO THE SUPPORT POST. THERE SHALL BE A 6 INCH DOUBLE OVERLAP, SECURELY FASTENED WHERE ENDS OF FABRIC MEET.
- 5. INSPECTION SHALL BE MADE EVERY TWO WEEKS OR AFTER EACH RAINFALL. REPAIR OR REPLACEMENT SHALL BE PROMPTLY AS NEEDED.
- 6. SILT FENCE SHALL BE REMOVED WHEN THE SITE IS COMPLETELY STABILIZED SO AS NOT TO BLOCK OR IMPEDE STORM FLOW OR DRAINAGE.
- ACCUMULATED SILT SHALL BE REMOVED WHEN IT REACHES A DEPTH OF 3 INCHES. THE SILT SHALL BE DISPOSED OF AT AN APPROVED SITE AND IN SUCH A MANNER AS TO NOT CONTRIBUTE TO ADDITIONAL SILTATION.

CIVIL QUANTITIES


ITEM NO.	DESCRIPTION	UNIT	TOTAL
C-1	Barricading and Traffic Control	LS	1
C-2	Erosion Control & SWPPP Preparation	LS	1
C-3	Saw cut, Remove & Dispose Concrete Curb & Gutter	LF	78
C-4	Saw cut, Remove & Dispose Concrete Sidewalk	SY	116
C-5	Unclassified Excavation	LS	1
C-6	Construct 6" Class "A" Reinforced Concrete Trail	SY	1,993
C-7	Construct Barrier Free Ramp	SY	35
C-8	Furnish and Install Traffic Sign	EA	6
C-9	Furnish and Install Yield Line Markings	LF	41
C-10	Relocate Traffic Signal Box, Conduit and Wire	EA	1
C-11	Furnish and Install TxDOT Type C Pedestrian Rail Painted Black	LF	148
C-12	Furnish and Install Removable Bollard	EA	12
C-13	Furnish and Install Project Sign	EA	2

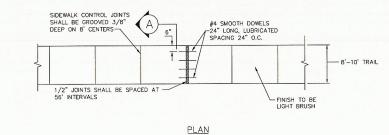


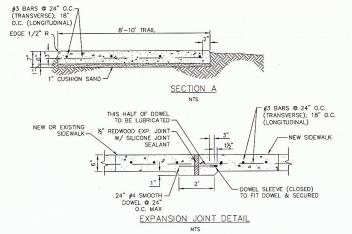



TYPICAL SECTION & DETAILS


Associates, Surveying 2000 Grantham Civil Engineering THIS DOCUMENT REPRESENT WORK-IN-PROGRESS AND NOT TO BE USED FOR CR
P. CHRISTOPHER ROBINSON
TEXAS P.E. NO. 101252 IASE 1 ROAD ZO AN CONNECTION PH. LANE TO ARAPAHO NOTES SIQ 4 0 PEDESTRIAN MORMAN LAN 0 -JUNE 2014 DB NO: 1197-14 SHEET C1 OF **C7**

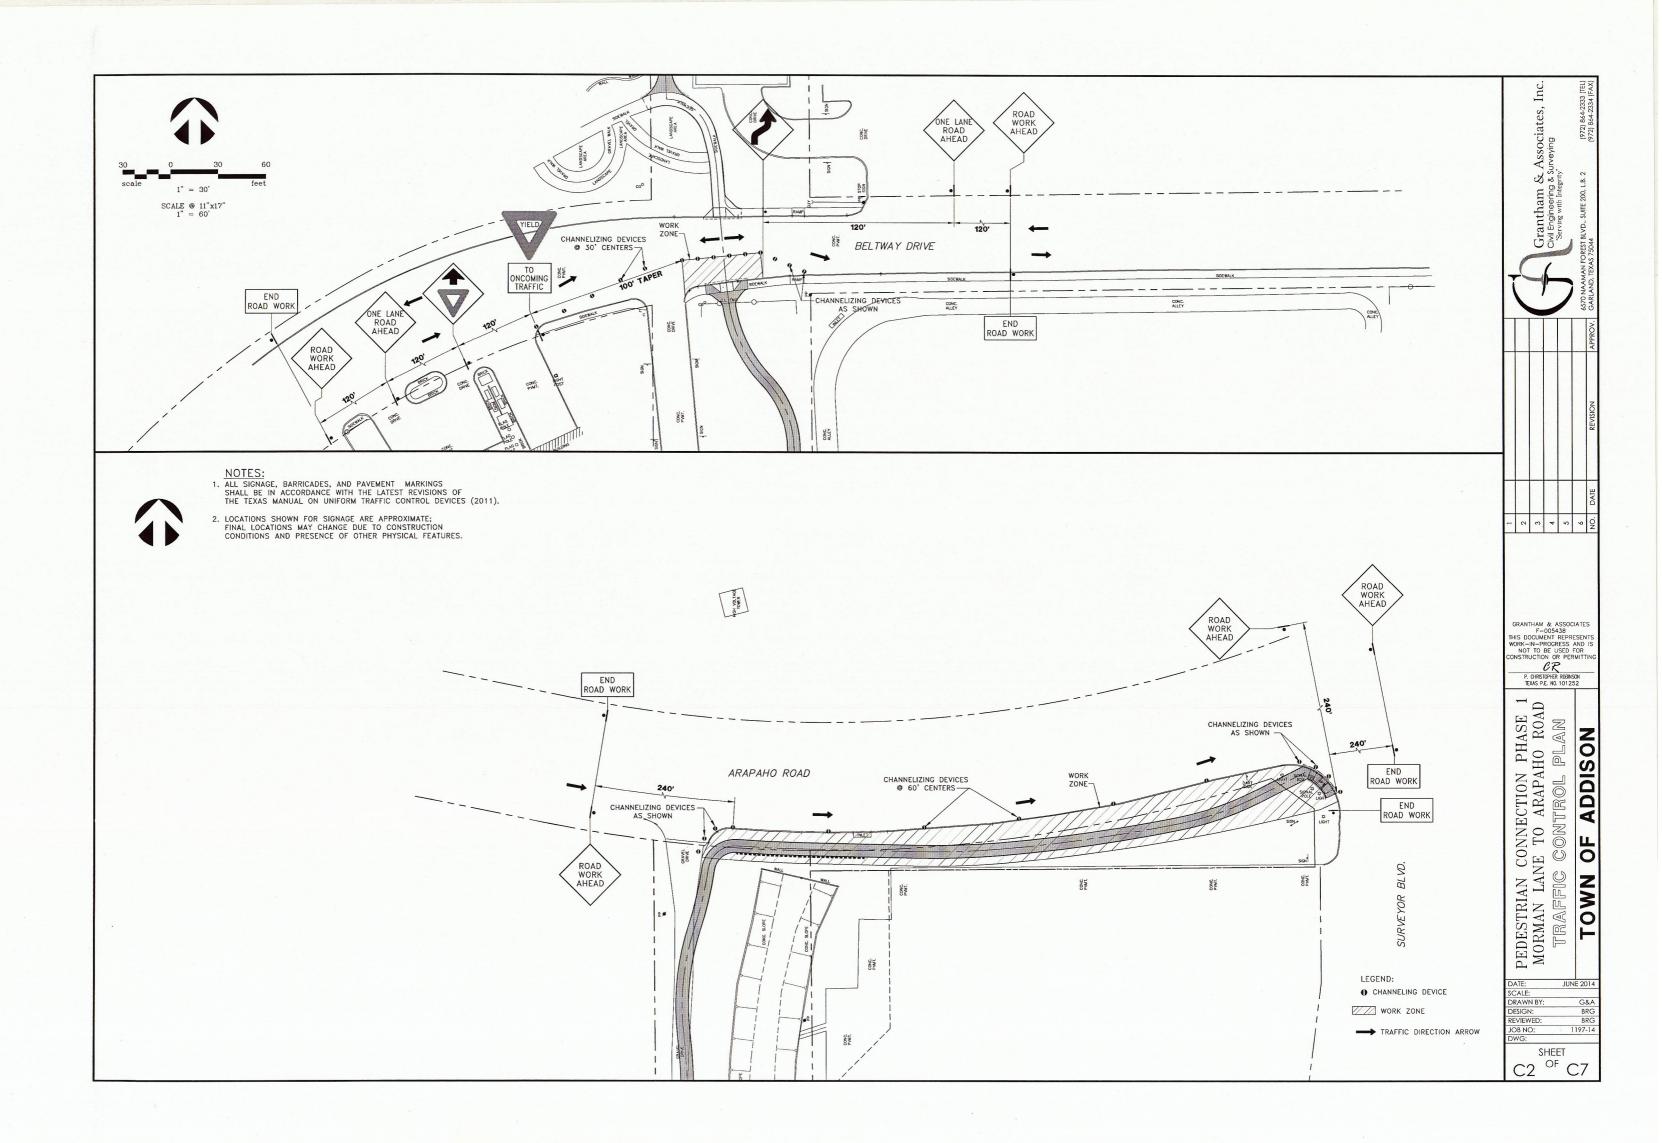


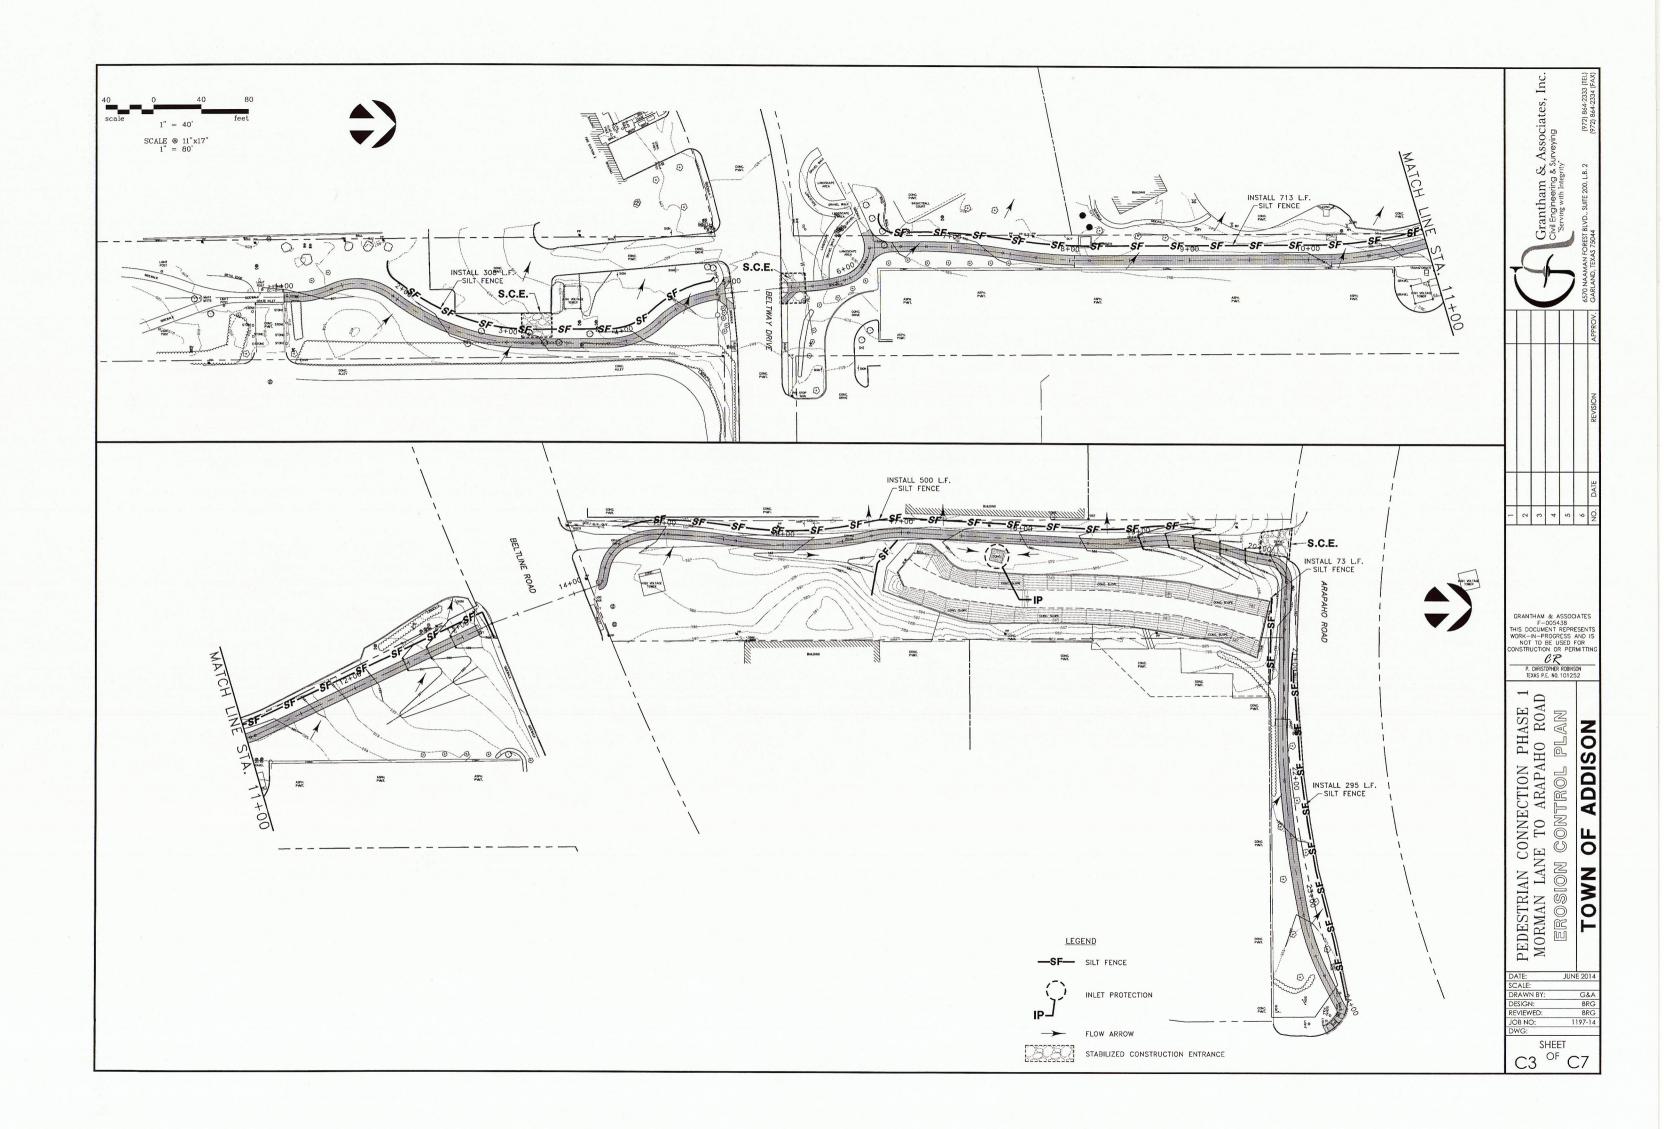


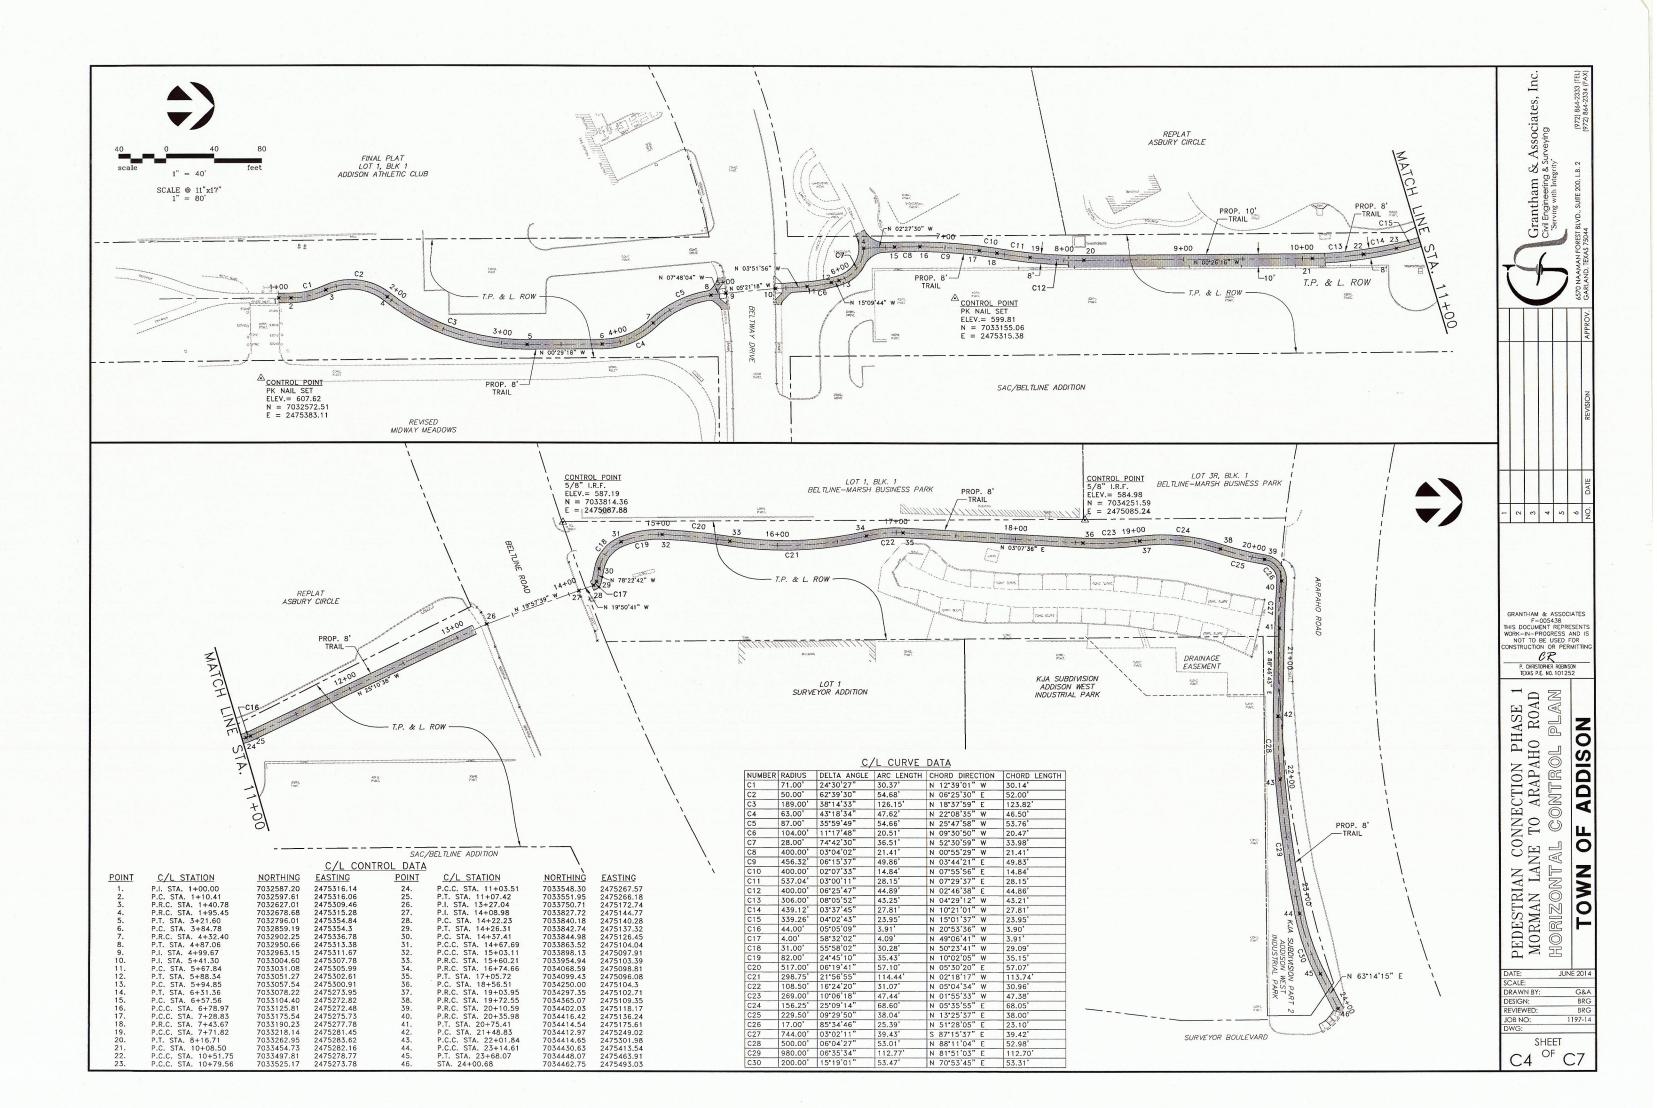


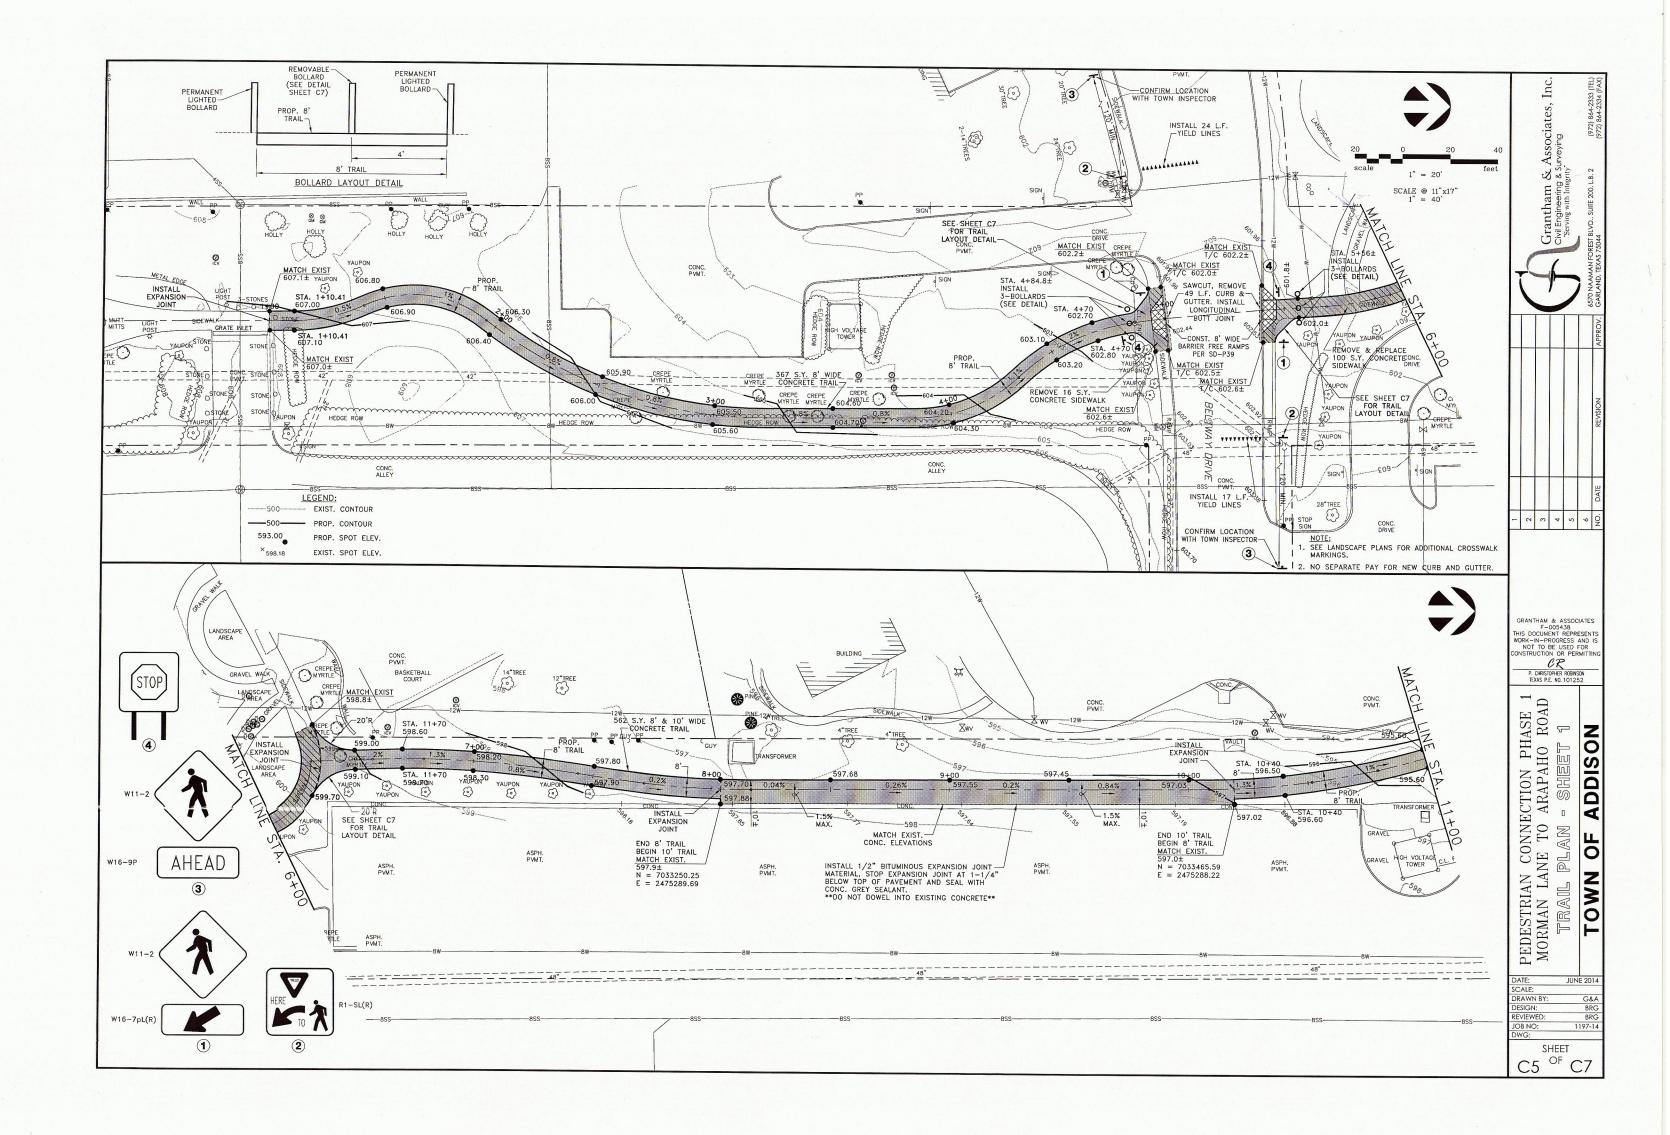

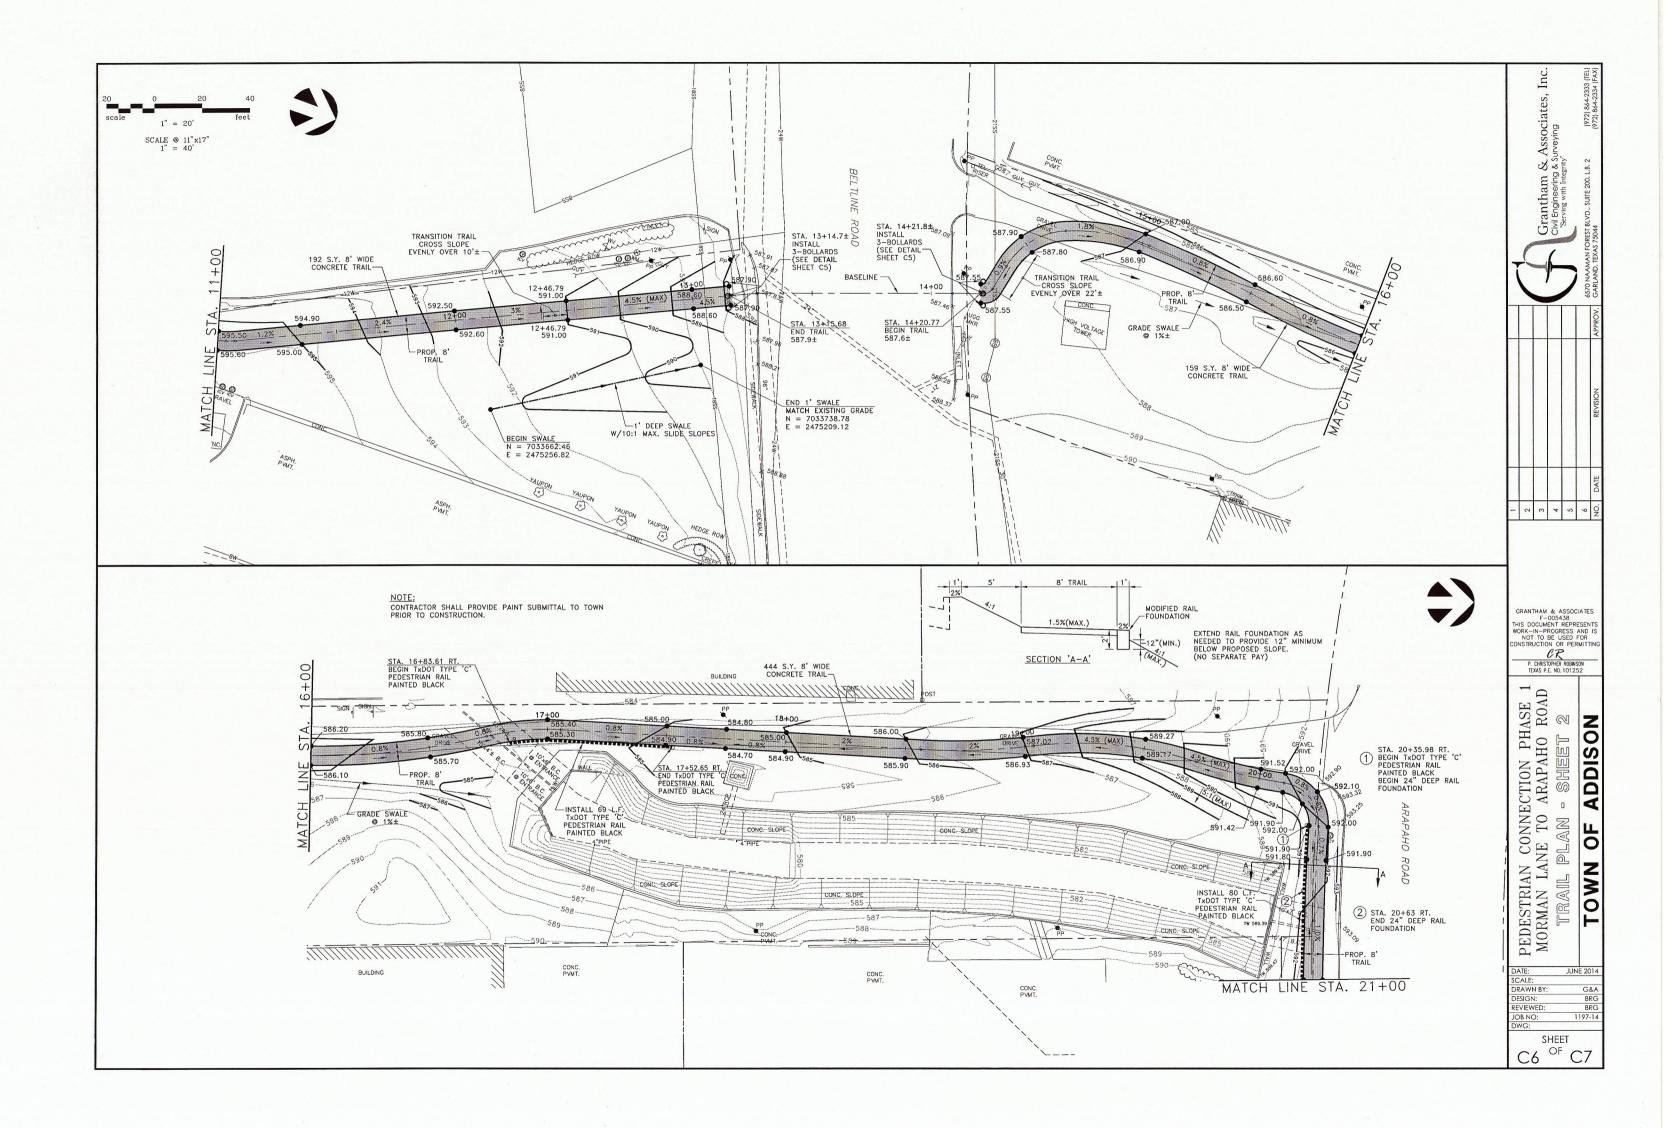

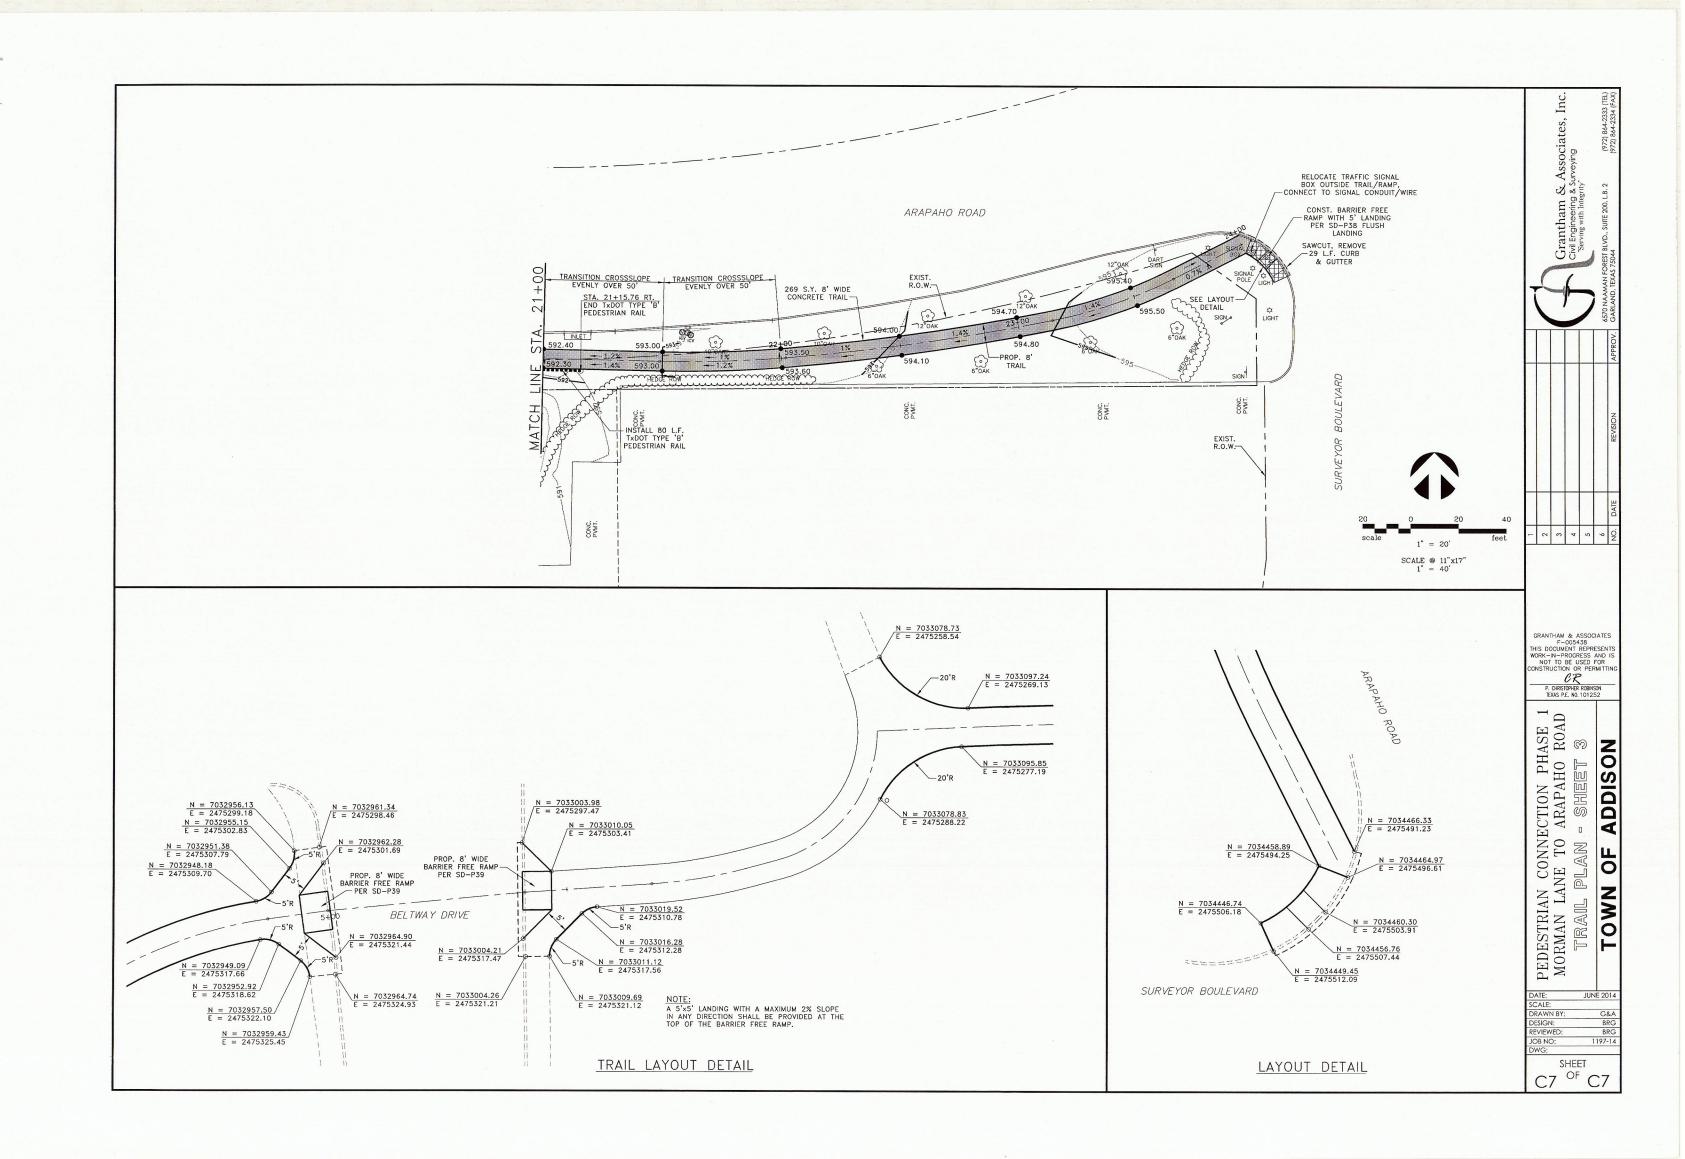


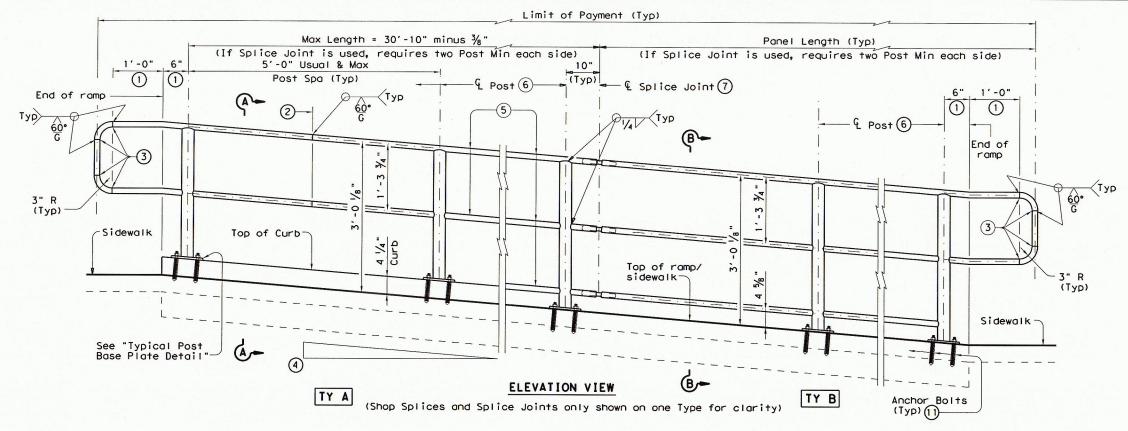

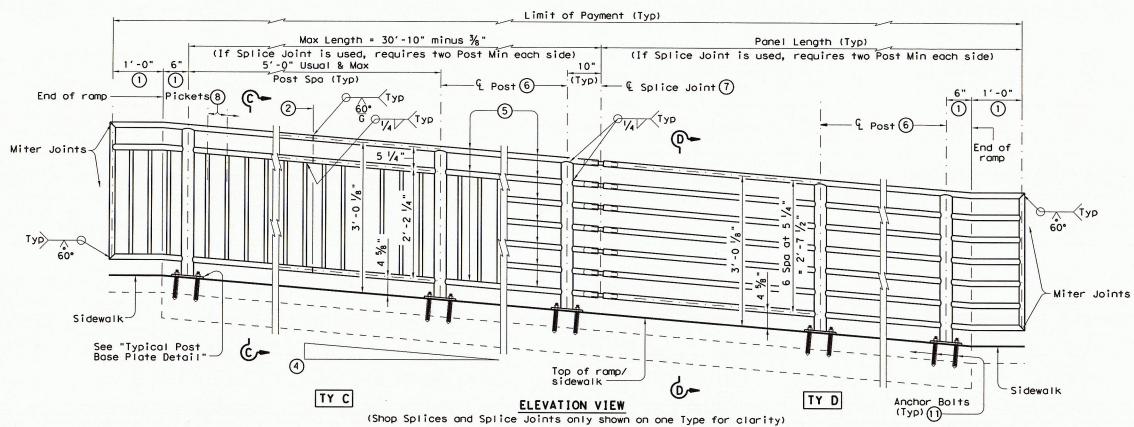

- 1) Parallel to ground.
- 2 One shop splice per panel is permitted with minimum 85 percent penetration. The weld may be square groove or single vee groove. Grind smooth.
- 3 Shop splice is permitted with minimum 85 percent penetration. The weld may be square groove or single vee groove. Grind smooth.
- 4 See Romp Details located elsewhere in plans for romp slope and dimensions. Maximum romp slope will not exceed 8.3 percent. Level landing required for each 30" rise if grade exceeds 5 percent.
- (5) 1 ½" Dia. Standard Pipe (1.900" O.D., 0.145" wall thickness). Parallel to ramp / sidewalk. Provide holes as needed in 1 ½" Dia. pipe for galvanizing drainage and venting.
- 6 2 $\frac{1}{2}$ " Dia. Standard Pipe (2.875" O.D., 0.203" wall thickness). See "Post Mount Detail" for crimping and trimming post to fit Dia. of top rail. Provide holes as needed in post for galvanizing drainage and venting. Plumb all posts.
- (7) See "Handrail Fabrication Details" for Splice Joints.
- (8) € % " Dia. Round Bar equal spacing at 4 ½ " Max. Plumb all pickets.
- When needed for accessibility (grade > 5 percent) or as needed for pedestrian safety.
- (1) Not to be used on bridges.
- (1) See "General Notes" for anchor bolt information.


RECOMMENDED USAGE 9 0			
Dropoff Height/ Condition	Recommended Rail Options		
<30" dropoff	TY A, TY B, TY C, or TY D		
≥ 30" dropoff, or along Bike Path	TY E or TY F		

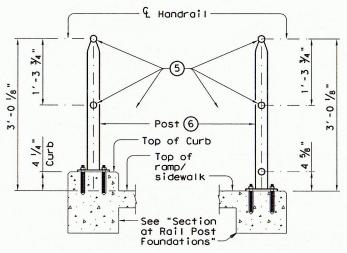

SECTION A-A
(Showing Handrail TY A)

SECTION B-B

(Showing Handrail TY B)

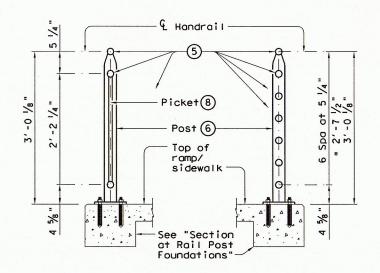

SECTION C-C
(Showing Handrail TY C)

SECTION D-D (Showing Handrail TY D)

SHEET 1 OF 3

Texas Department of Transportation


PEDESTRIAN HANDRAIL

PRD-13

DETAILS

FILE: prd13.dgn	DN: TxDOT		ck: AM	DW: JTR	CK: CGL	
© TxDOT Decmeber 2006	CONT	SECT	JOB		HIGHWAY	
REVISIONS REVISED MAY, 2013 (VP)						
	DIST	COUNTY		Y	SHEET NO.	

ATE: ILE:

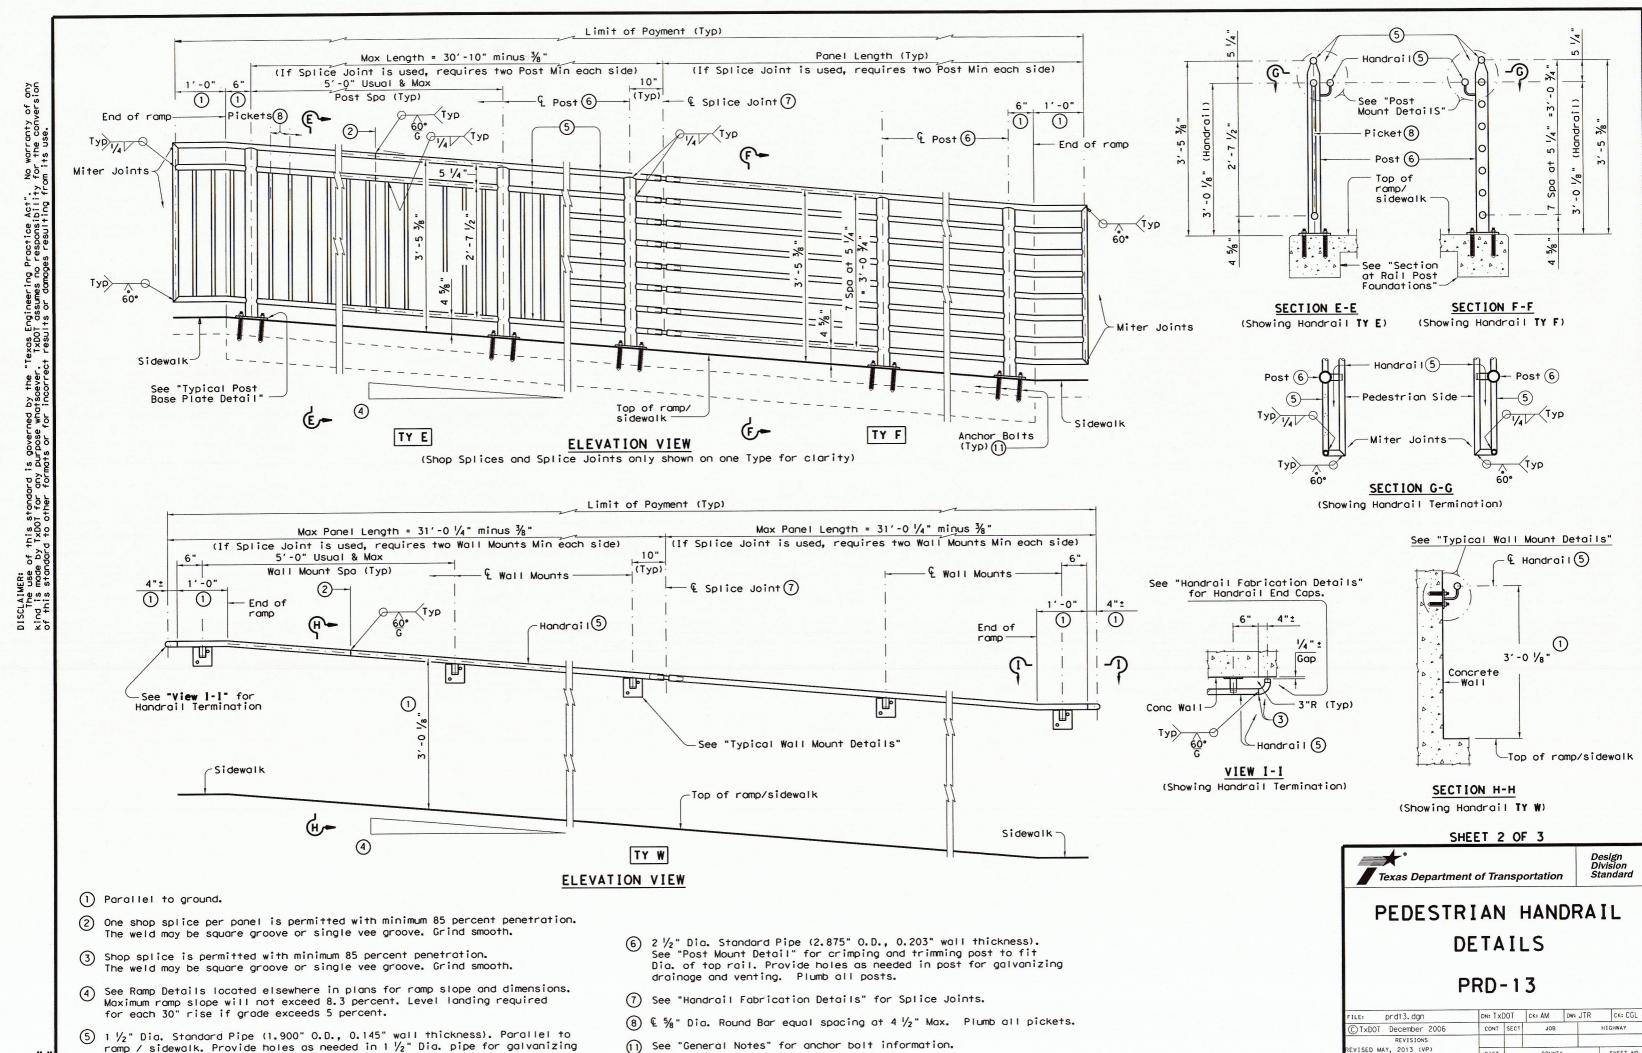

EVISED MAY, 2013 (VP)

DIST

SHEET NO.

drainage and venting.

