


**Project Name**  
**Addison Pedestrian Connection**  
Addison, TX.  
Project No: 14002

**Issue Title**  
**Bid Documents**

Issue Date: 06.04.2014

**Seal**

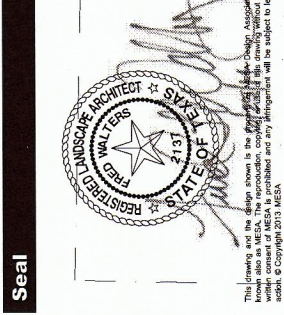


**Issue / Addenda / Revisions**

Date	Description
02.14.2014	90% Review
06.04.2014	100% Review
06.25.2014	100% Review - Town Comments

**Drawing Title**

**Addison Pedestrian Connection: Phase 1 Demolition Plan (South)**  
**Sheet No.**

**L1.01**

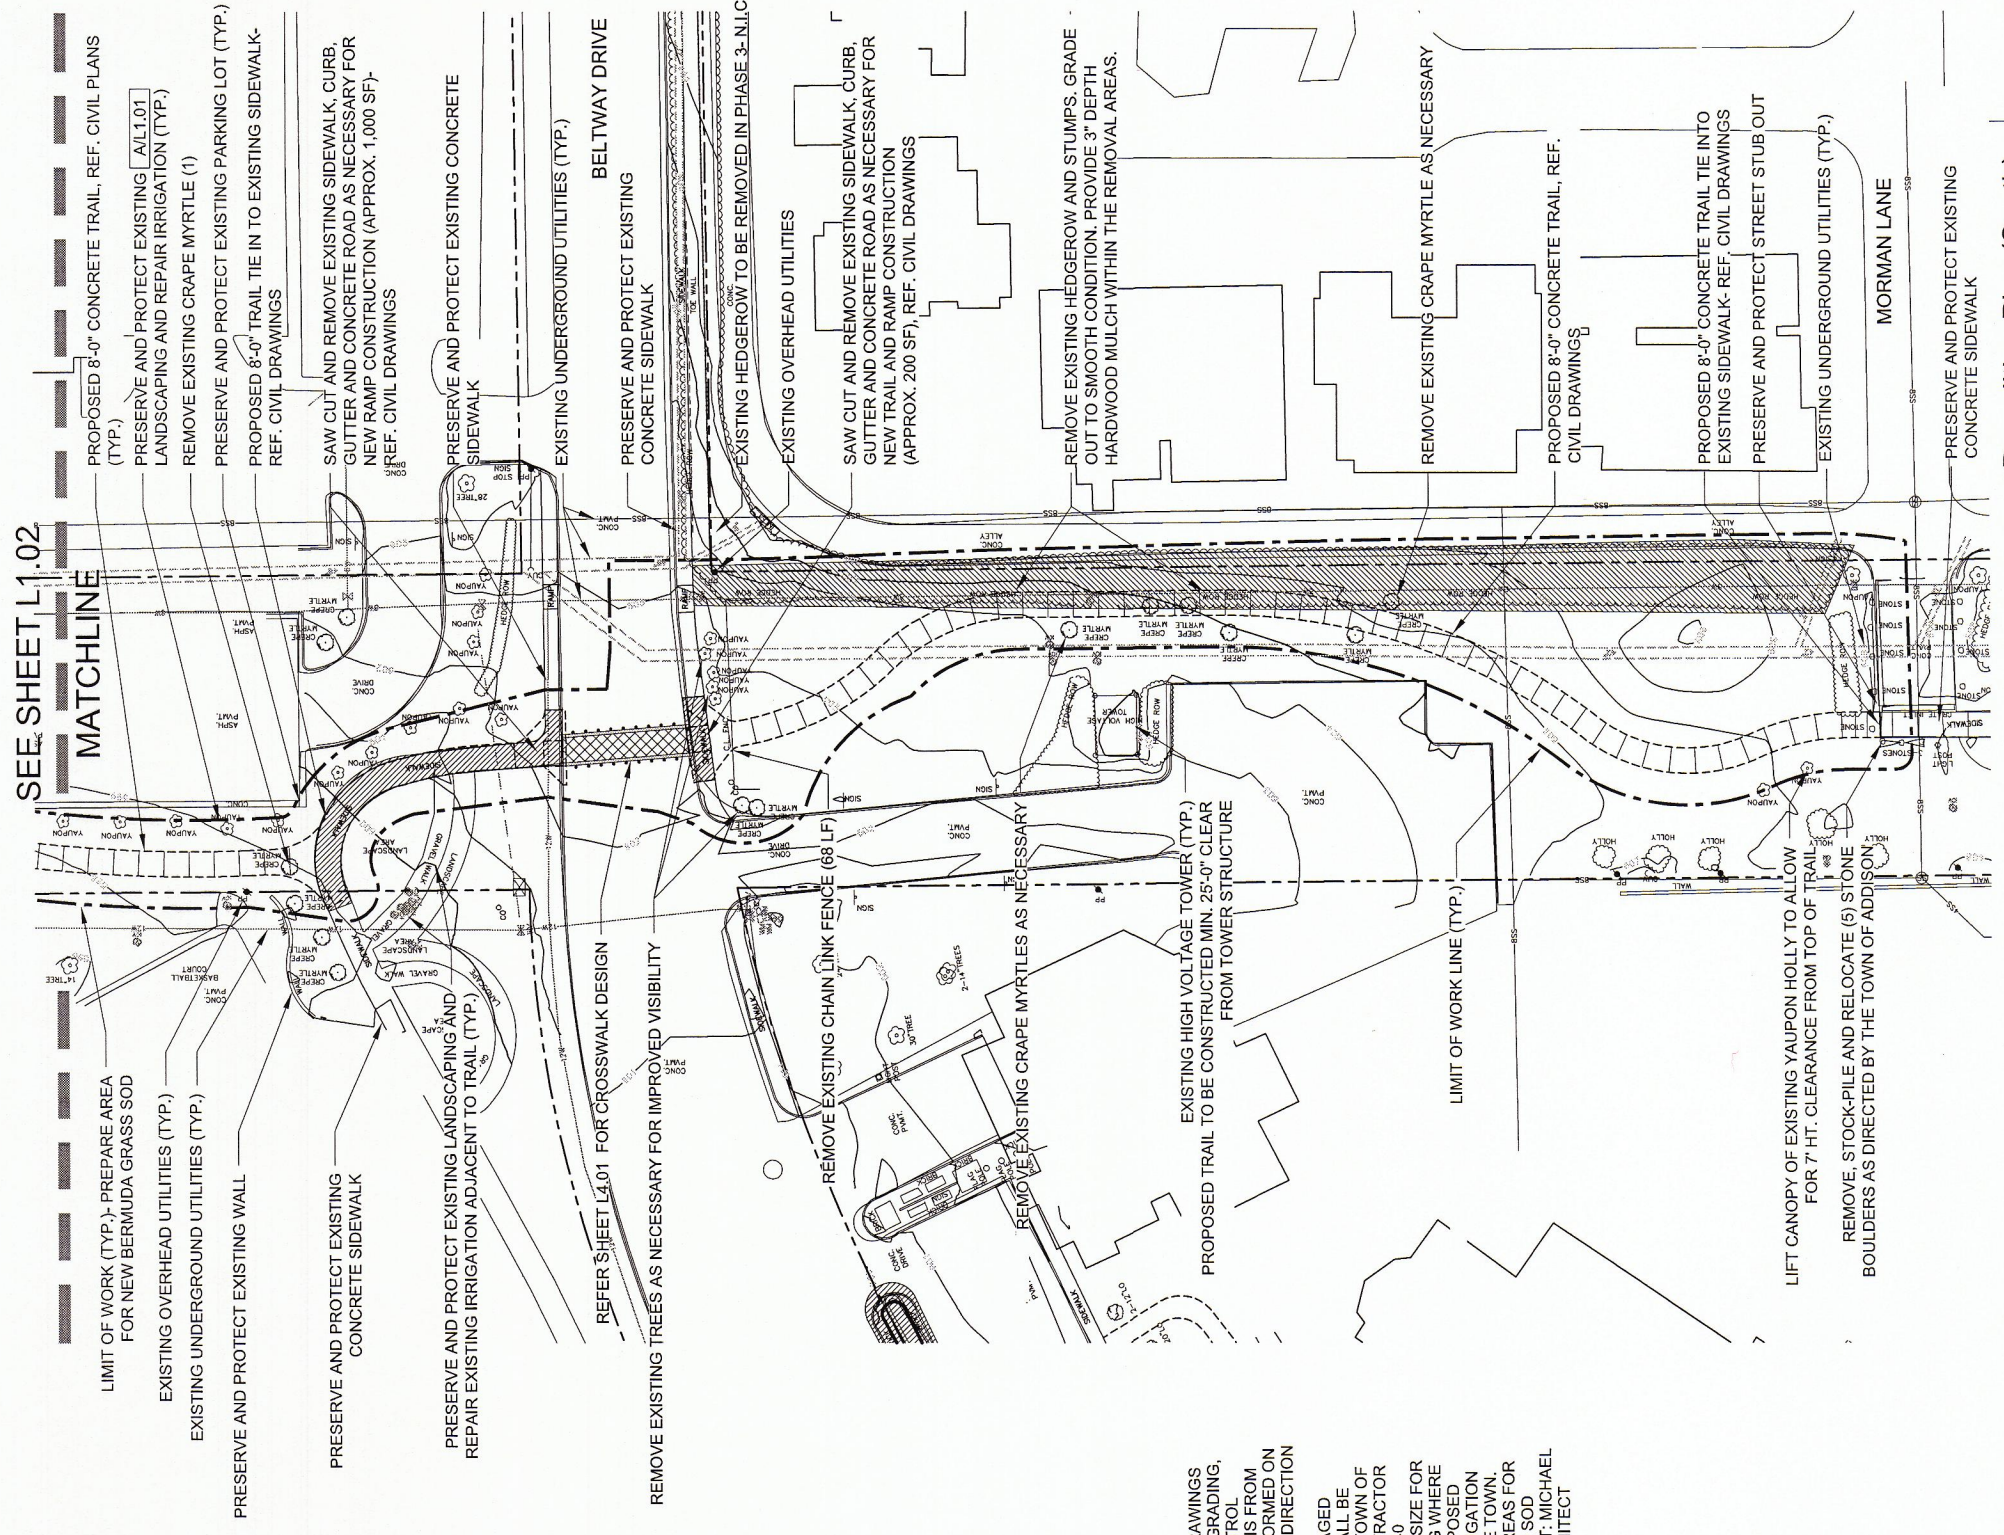

**SEE SHEET L1.02 MATCHLINE**

LIMIT OF WORK (TYP.)- PREPARE AREA FOR NEW BERMUDA GRASS SOD

EXISTING OVERHEAD UTILITIES (TYP.)

EXISTING UNDERGROUND UTILITIES (TYP.)

PRESERVE AND PROTECT EXISTING WALL

PRESERVE AND PROTECT EXISTING CONCRETE SIDEWALK

PRESERVE AND PROTECT EXISTING LANDSCAPING AND REPAIR EXISTING IRRIGATION ADJACENT TO TRAIL (TYP.)


EXISTING UNDERGROUND UTILITIES (TYP.)

EXISTING OVERHEAD UTILITIES (TYP.)

PREPARE AREA FOR NEW BERMUDA GRASS SOD

EXISTING UNDERGROUND UTILITIES (TYP.)


PRESERVE AND PROTECT EXISTING WALL

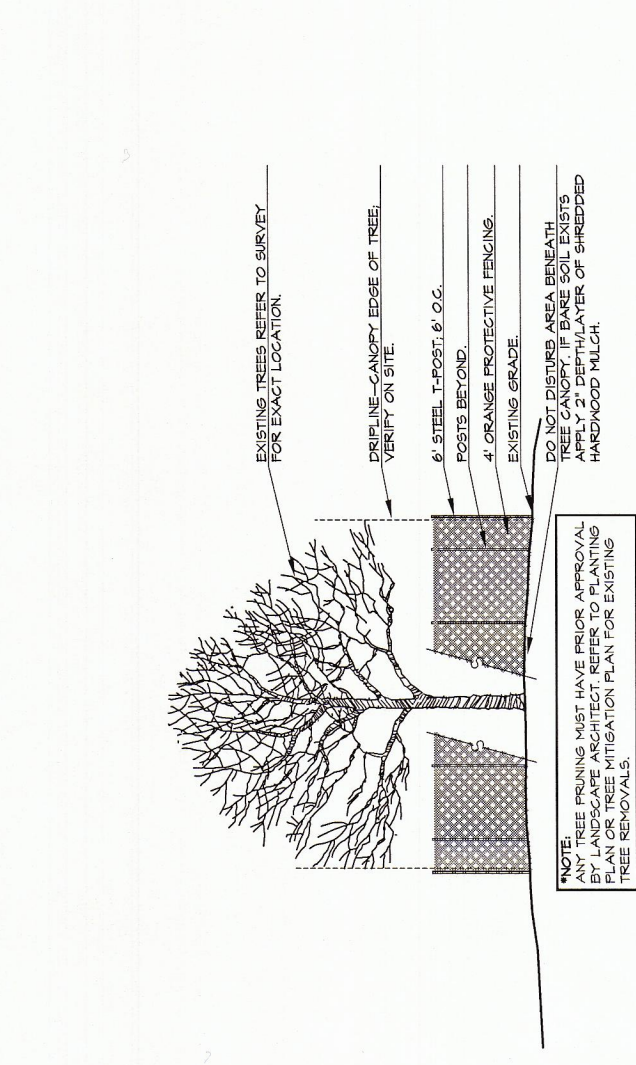

**Tree Preservation Detail A**  
Scale: 1/4" = 1'-0"

**L1.01**

Scale: 1/4" = 1'-0"

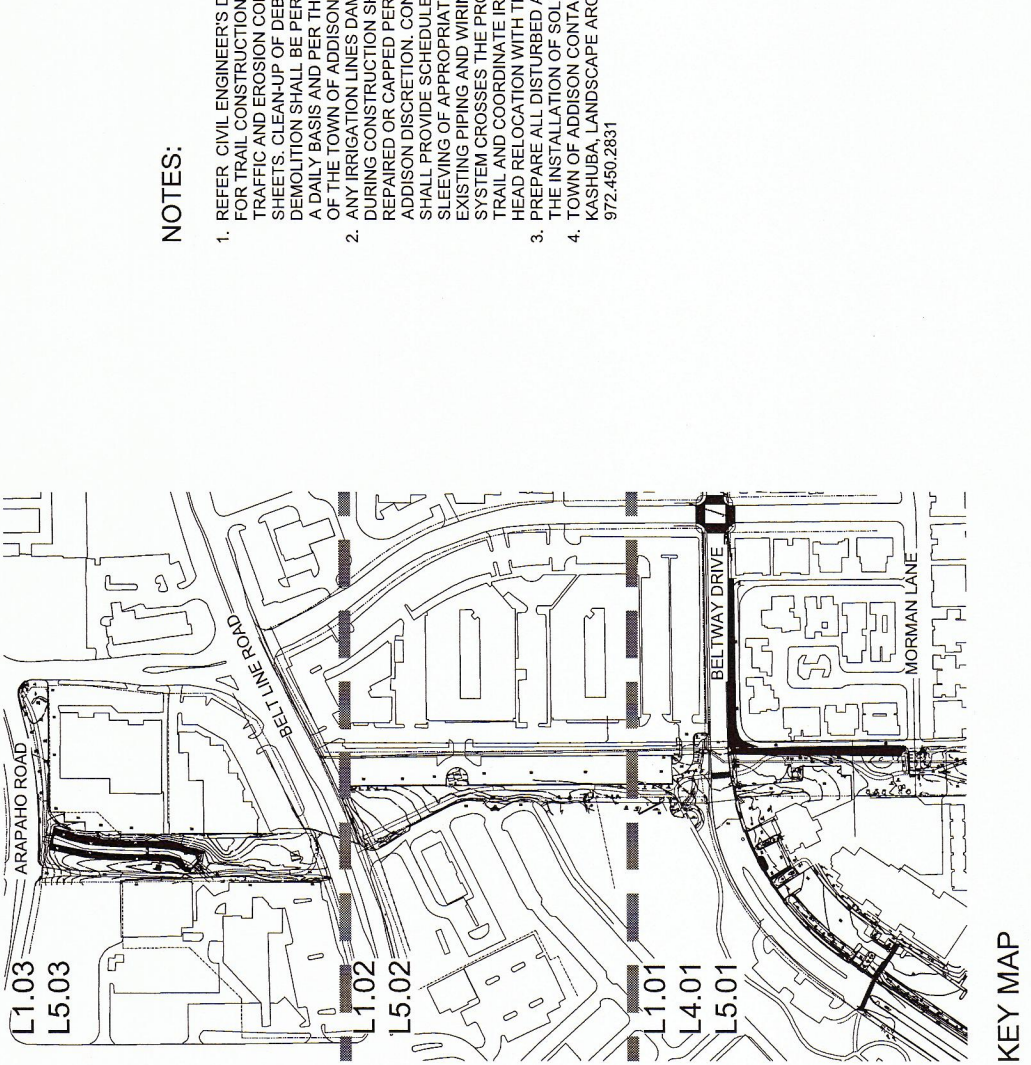

**KEY MAP**

0' 150' 200' 400'  
NORTH  
SCALE: 1" = 200'-0"

Scale: 1" = 30'-0"

**L1.01**

- NOTES:**
- REFER CIVIL ENGINEER'S DRAWINGS FOR TRAIL CONSTRUCTION, GRADING, TRAFFIC AND EROSION CONTROL SHEETS. CLEAN-UP OF DEBRIS FROM DEMOLITION SHALL BE PERFORMED ON A DAILY BASIS AND PER THE DIRECTION OF THE TOWN OF ADDISON.
  - ANY IRRIGATION LINES DAMAGED DURING CONSTRUCTION SHALL BE REPAIRED OR CAPPED PER TOWN OF ADDISON DISCRETION. CONTRACTOR SHALL PROVIDE SCHEDULE 40 SLEEVING OF APPROPRIATE SIZE FOR EXISTING PIPING AND WIRING WHERE SYSTEM CROSSES THE PROPOSED TRAIL AND COORDINATE IRRIGATION HEAD RELOCATION WITH THE TOWN. PREPARE ALL DISTURBED AREAS FOR THE INSTALLATION OF SOLID SOD.
  - TOWN OF ADDISON CONTACT: MICHAEL KASHUBA, LANDSCAPE ARCHITECT 972-450-2831
  - TOWN OF ADDISON CONTACT: MICHAEL KASHUBA, LANDSCAPE ARCHITECT 972-450-2831