010578


HARDSCAPE, LANDSCAPE, AND IRRIGATION CONSTRUCTION DOCUMENTS FOR

BROOKHAVEN CLUB DRIVE PARK

TOWN OF ADDISON, TEXAS

APRIL 2003

LOCATION MAP

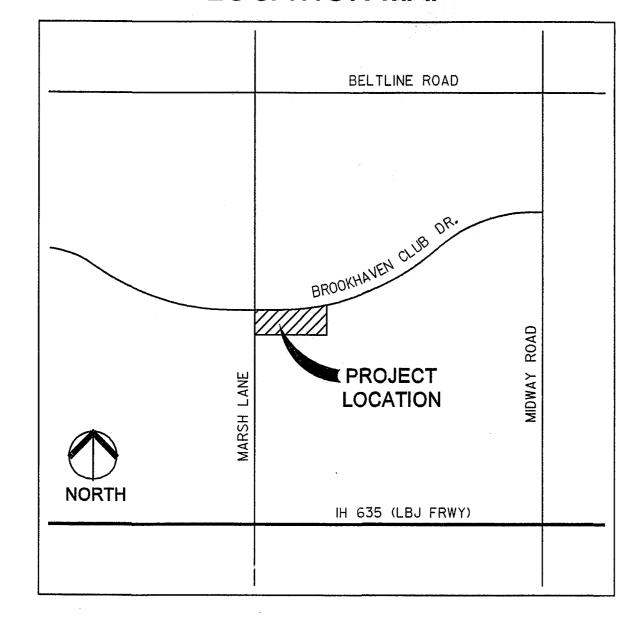

SHEET INDEX

TITLE SHEET

D-1 - DEMOLITION PLAN

LA-1 - LAYOUT PLAN

LP-1 - LANDSCAPE PLAN

E-1 - LIGHTING PLAN AND DETAILS

IR-1 - IRRIGATION PLAN

DT-1 - SITE DETAILS


DT-2 - PLANTING DETAILS


DT-3 - IRRIGATION DETAILS




Frye Associates 2874 Ridgedale Dr. Lewisville, Texas 75067

WATER SMART IRRIGATION, Inc.
P.O. BOX 560518
The Colony, Texas 75058

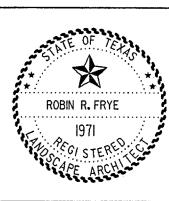

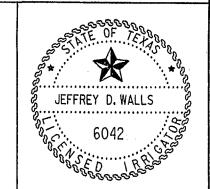

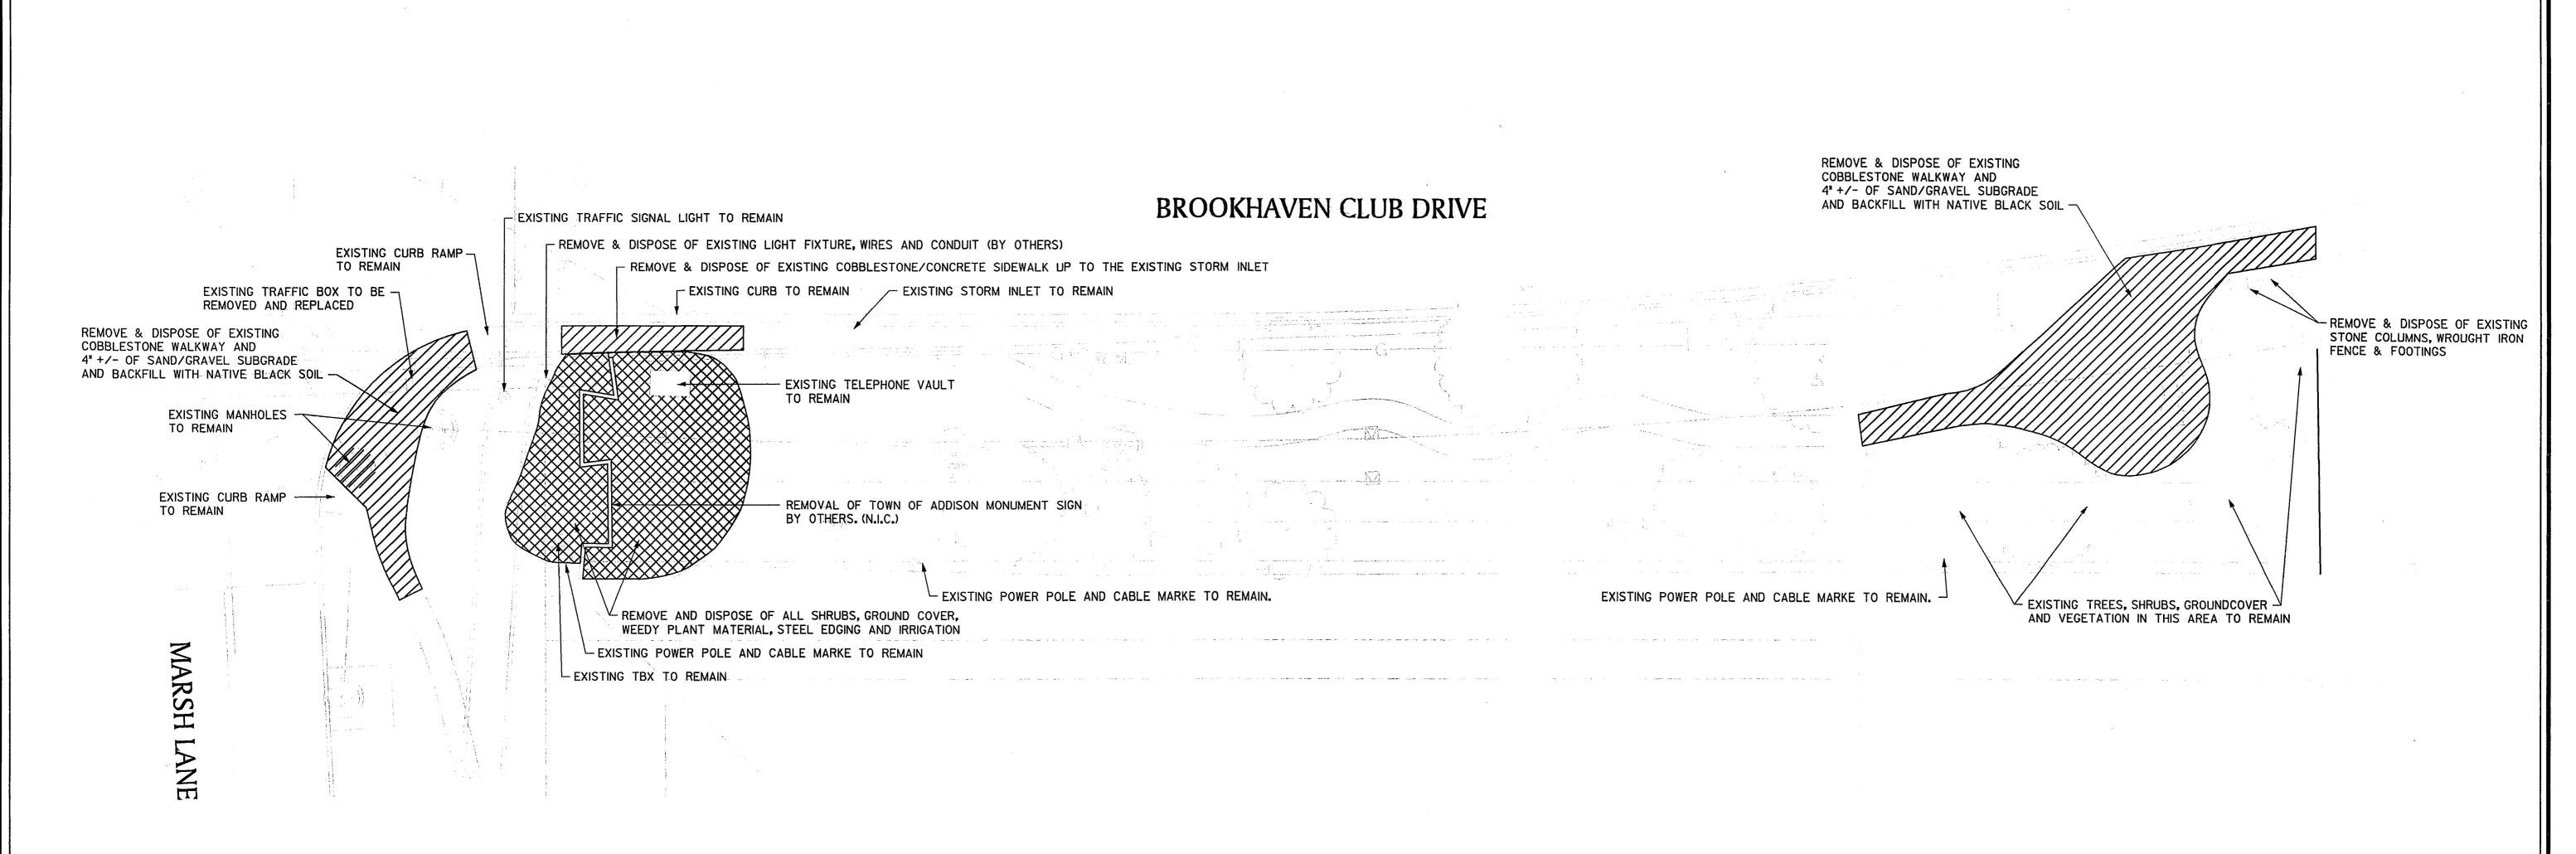

GENERAL NOTES:

1. THE CONTRACTOR IS RESPONSIBLE FOR LOCATION & VERIFICATION OF ALL OVERHEAD AND UNDERGROUND UTILITIES,


3. MATERIALS AND WORKMANSHIP SHALL CONFORM TO THE TOWN OF ADDISON STANDARDS & SPECIFICATIONS AND TO, THE STANDARD SPECIFICATIONS FOR PUBLIC WORKS CONSTRUCTION FOR NORTH CENTRAL TEXAS, LATEST EDITION.

2. THE CONTRACTOR SHALL OBTAIN AND PAY FOR ALL PERMITS REQUIRED FOR CONSTRUCTION OF THIS PROJECT.

AND TO PROTECT ALL PUBLIC & PRIVATE UTILITIES DURING CONSTRUCTION OF THIS PROJECT.

Frye Associates 2874 Ridgedale Dr. Lewisville, Texas 75067

WATER SMART IRRIGATION, In P.O. BOX 560518 The Colony, Texas 75050

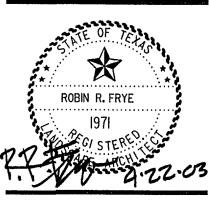

F&A JOB NUMBER: 0228

DATE ISSUED: Apr. 22, 2003


NORTH

GRAPHIC SCALE IN FEET

REVISIONS:

SHEET NUMBER:

DEMOLITION PLAN

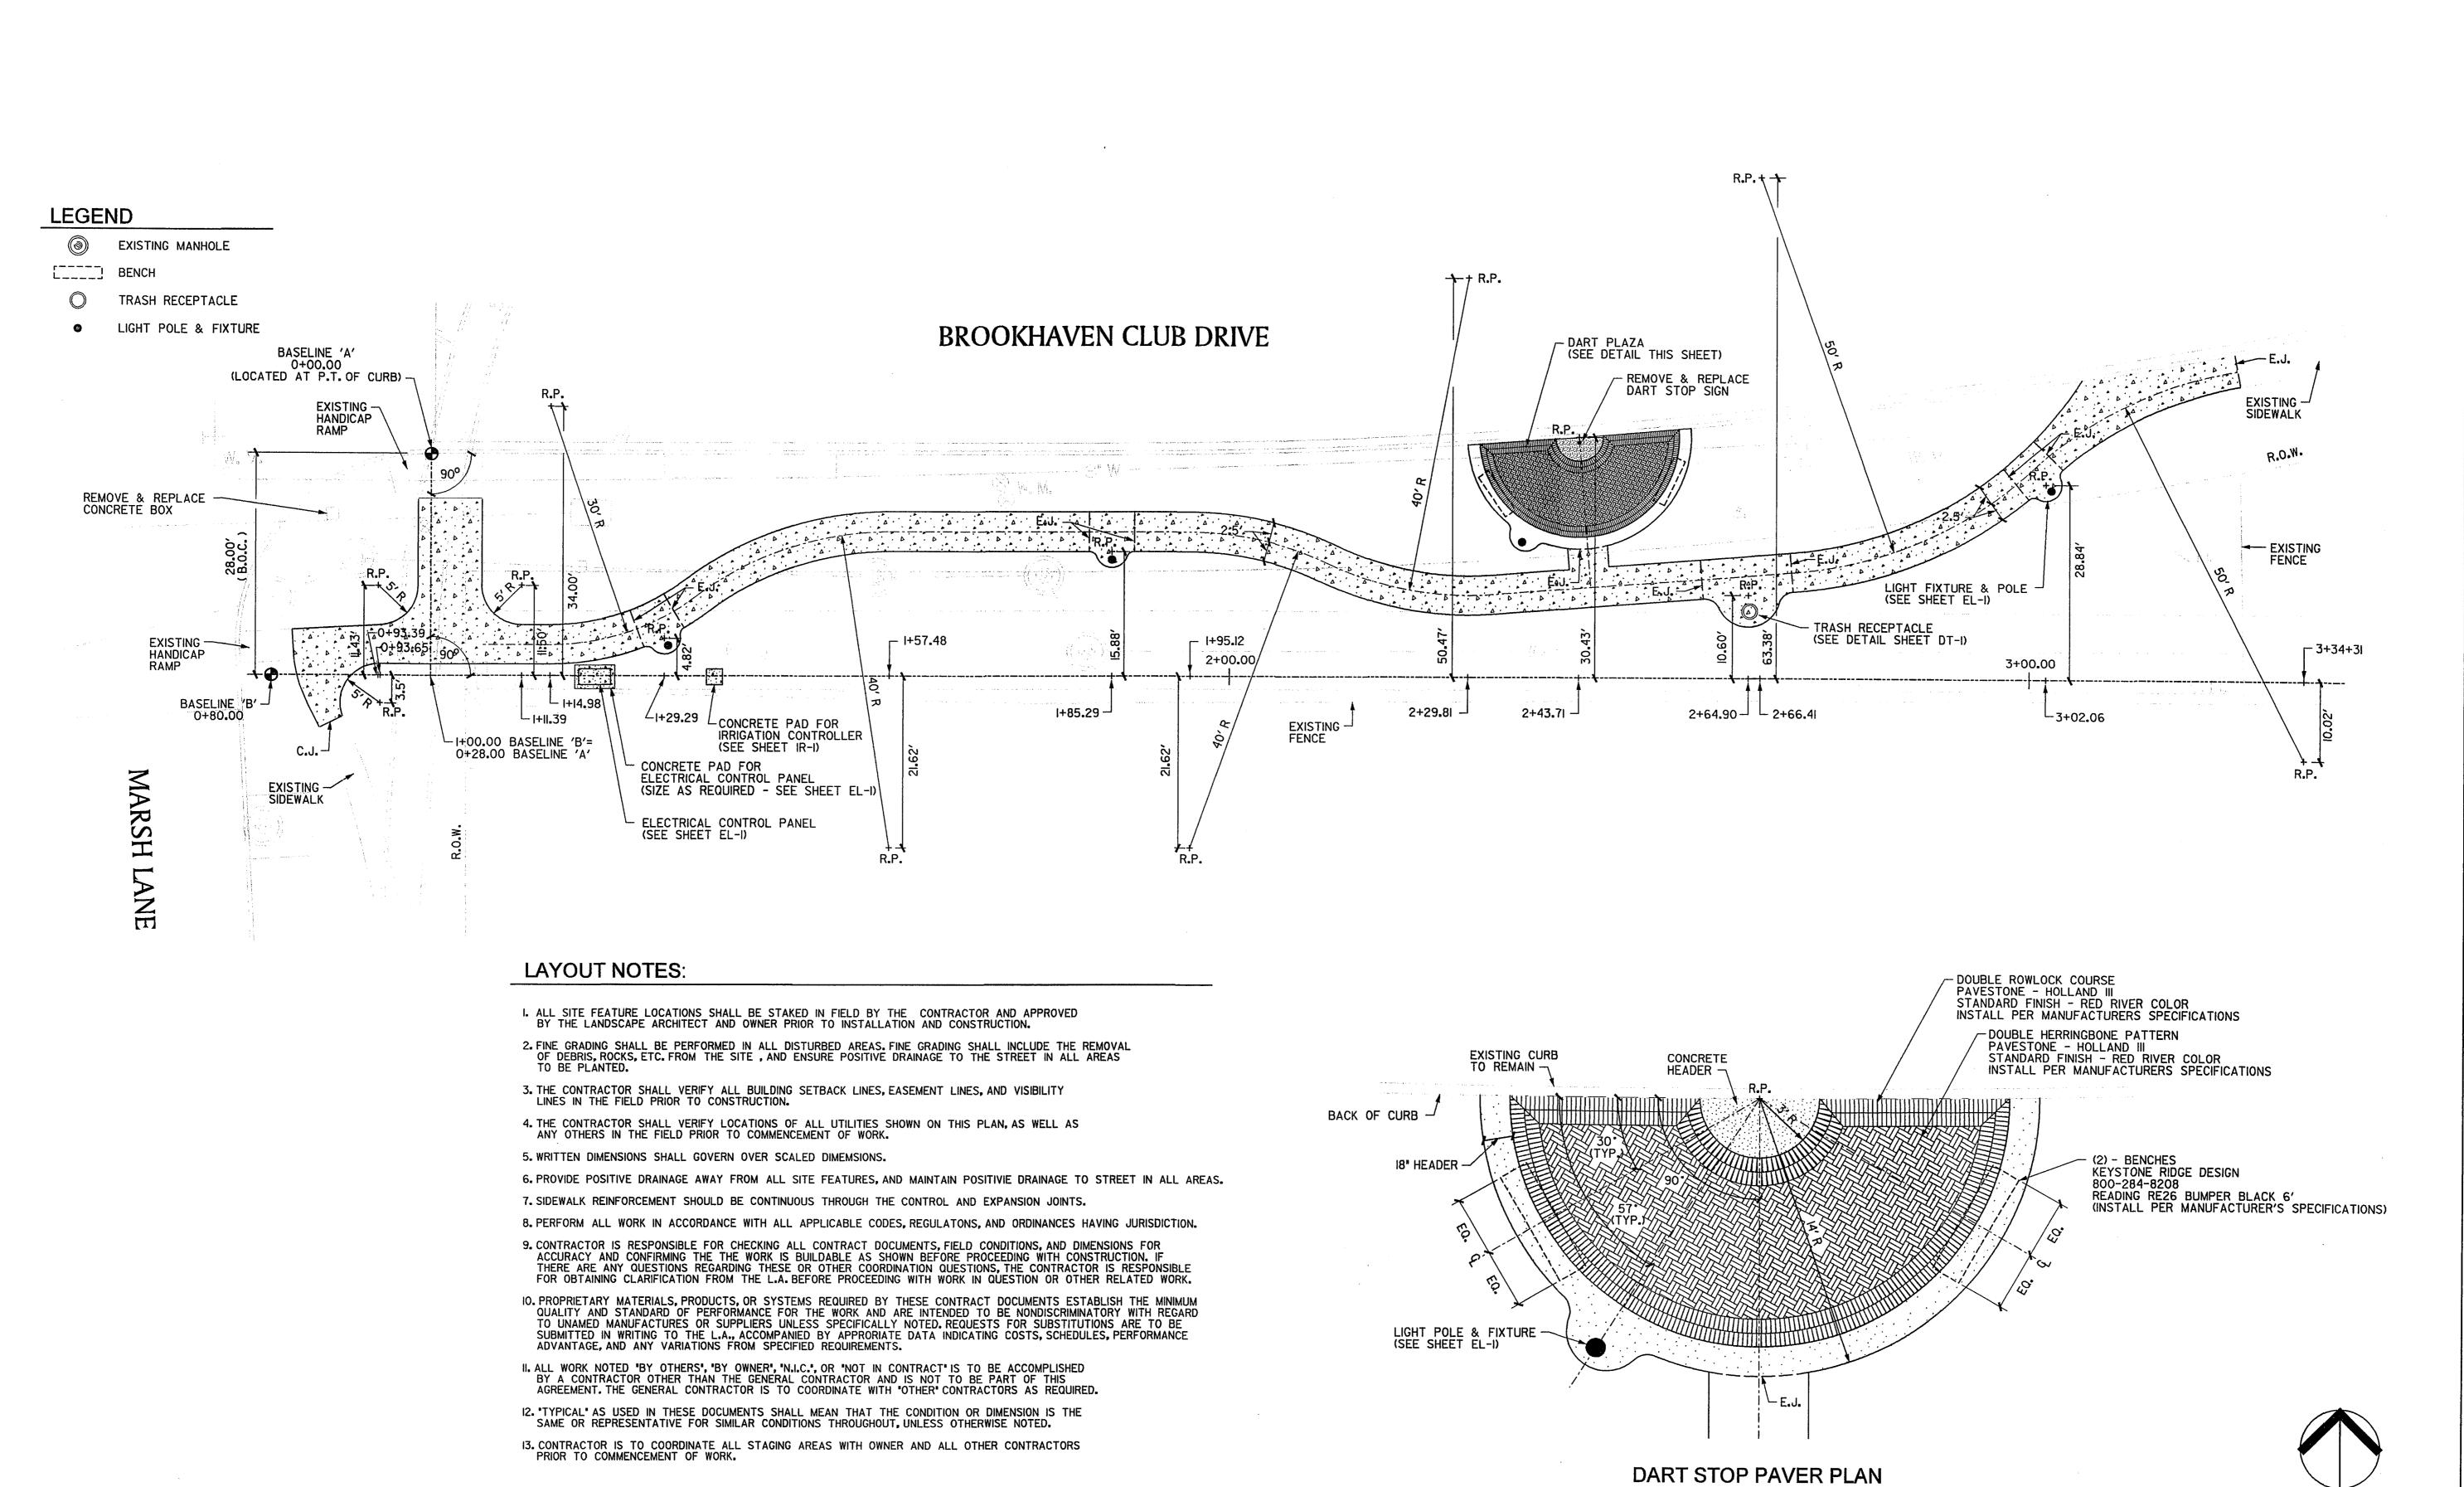

Frye Associates 2874 Ridgedale Dr. Lewisville, Texas 75067

WATER SMART IRRIGATION, P.O. BOX 560518 The Colony, Texas 75058

ROBIN R. FRYE

F&A JOB NUMBER: 0228 DATE ISSUED:


Apr. 22, 2003 **REVISIONS:**

NORTH

GRAPHIC SCALE IN FEET

SHEET NUMBER:

SCALE: 1/4" = 1'-0"

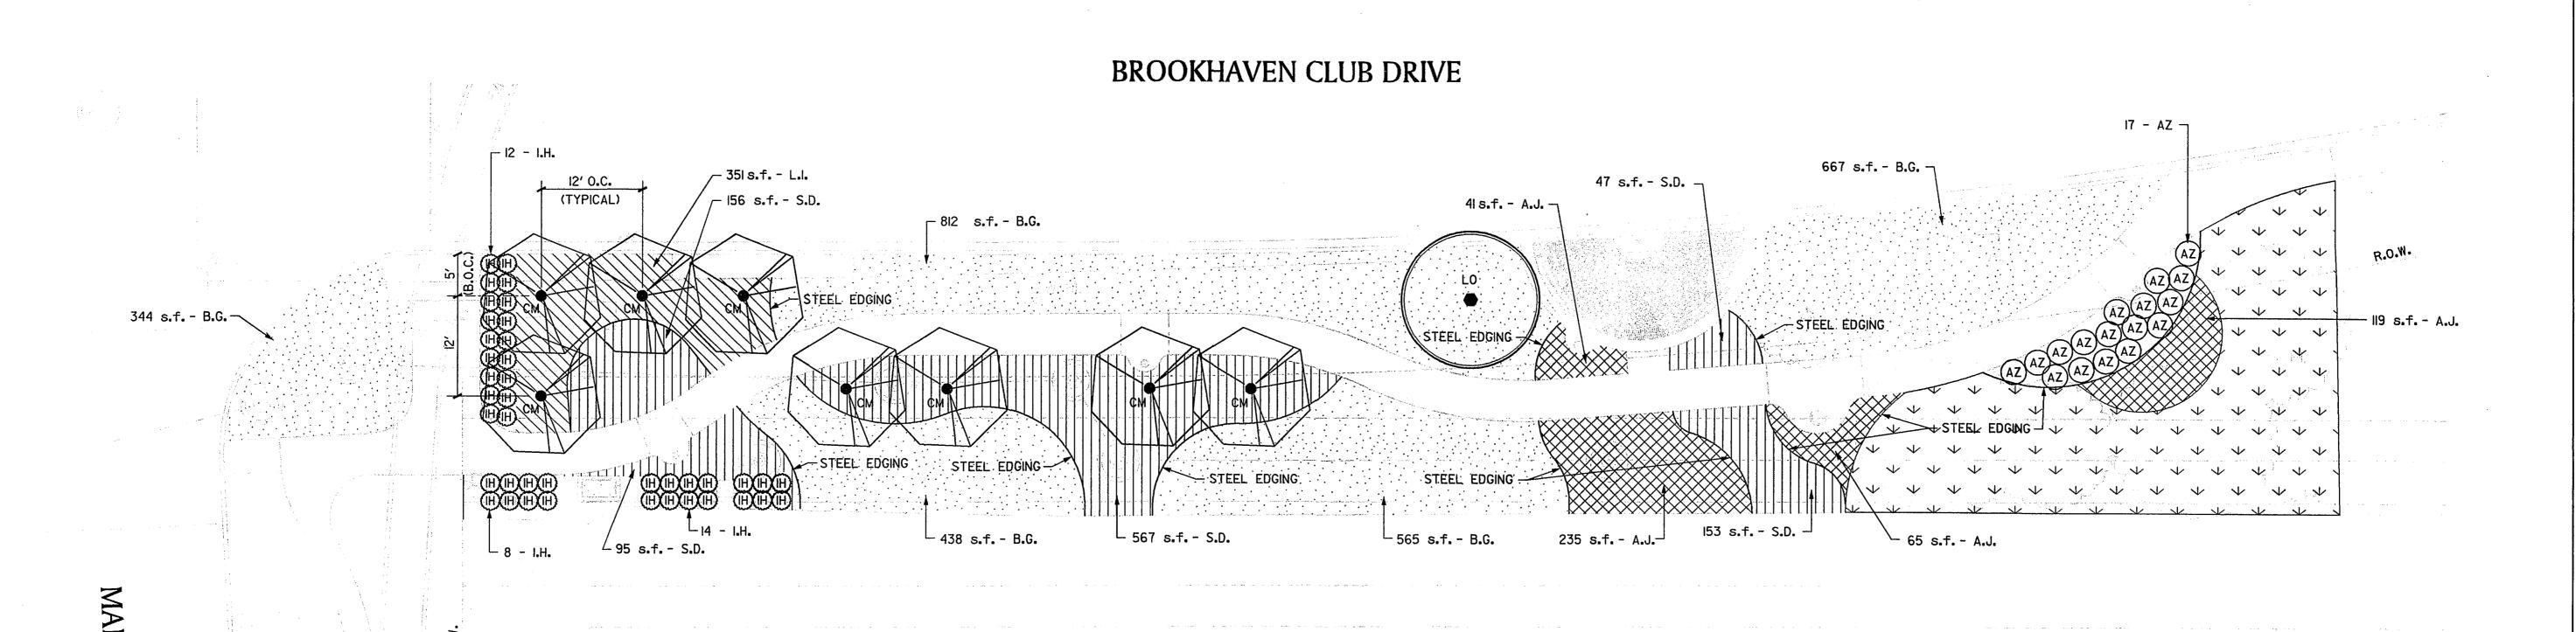

PLANTING NOTES:


- I. CONTRACTOR SHALL NOT PARK ANY VEHICLE, STORE ANY MATERIALS, OR CREATE ANY TEMPORARY ACCESS ROADS UNDER THE DRIP-LINE OF ANY EXISTING TREE(S) ON SITE WHICH ARE NOT TO BE REMOVED.
- 2. ALL TREES DESIGNATED BY THE ENGINEERS TREE SURVEY AS 'NOT TO BE REMOVED' SHALL BE PROTECTED IN ACCORDANCE TO THE TOWN OF ADDISON DEVELOPEMENT CODE REGULATIONS.
- 3. ALL TREES TO BE PLANTED SHALL BE PLANTED IN ACCORDANCE TO THE DETAIL(S), SEE SHEET DT-2, AND THE TOWN OF ADDISON DEVELOPEMENT CODE REGULATIONS.
- 4. THE CONTRACTOR SHALL VERIFY ALL LOCATIONS OF ALL UTILITIES SHOWN ON THIS PLAN, AS WELL AS ANY OTHERS IN THE FIELD PRIOR TO COMMENCEMENT OF WORK.
- 6. ALL PLANT MATERIAL LOCATIONS SHALL BE STAKED IN THE FIELD BY THE CONTRACTOR, AND APPROVED BY THE L.A. PRIOR TO INSTALLATION.
- 7. BED PREP FOR <u>AZALEAS ONLY</u> IS AS FOLLOWS:
- EXCAVATE AND REMOVE EXISITNG SOIL TO A DEPTH OF 4".

5. WRITTEN DIMENSIONS SHALL GOVERN OVER SCALED DIMENSIONS.

- BACKFILL WITH A MIXTURE OF 50% COMPOST, 50% SHREDDED HARDWOOD BARK, TEXAS GREEN SAND @ I-2 Ibs/cubic yd AND GRANULATED SULFUR @ IIb/cubic yd PLACE IN THE BED AREA TO A DEPTH OF 16%. BE SURE TO THOROUGHLY SATURATE THIS MIXTURE IN A TUB OR WHEELBARROW PRIOR TO PLACING IT IN THE BED.
- MOUND THE BEDS SO THAT THE FINISHED GRADE IS ABOUT 12" ABOVE THE ADJACENT GRADE.
- TEAR OR CUT POT-BOUND ROOTS BEFORE PLANTING.

DI ANT	LEGEND
PLAN I	LEGEND


QTY.	SYMBOL	DESCRIPTION
		EXISTING TREES (TO REMAIN)
t to the second	(-E	LIVE OAK
8	COM COM	CRAPE MYRTLE
17	(AZ)	AZALEA
34	\oplus	INDIAN HAWTHORNE
460 S.F.		ASIAN JASMINE
2826 S.F.		BERMUDA GRASS SOD
351 S . F.		LIRIOPE (BIG BLUE)
1018 S.F.		LIRIOPE (SILVER DRAGON)
	* * *	EXISTING VEGETATION

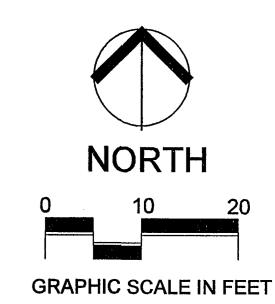

LANDSCAPE PLAN

Frye Associates 2874 Ridgedale Dr. Lewisville, Texas 75067

WATER SMART IRRIGATION,

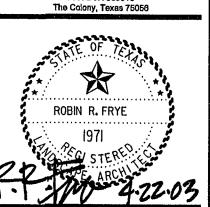


F&A JOB NUMBER:

DATE ISSUED:

Apr. 22, 2003 **REVISIONS:**


SHEET NUMBER:

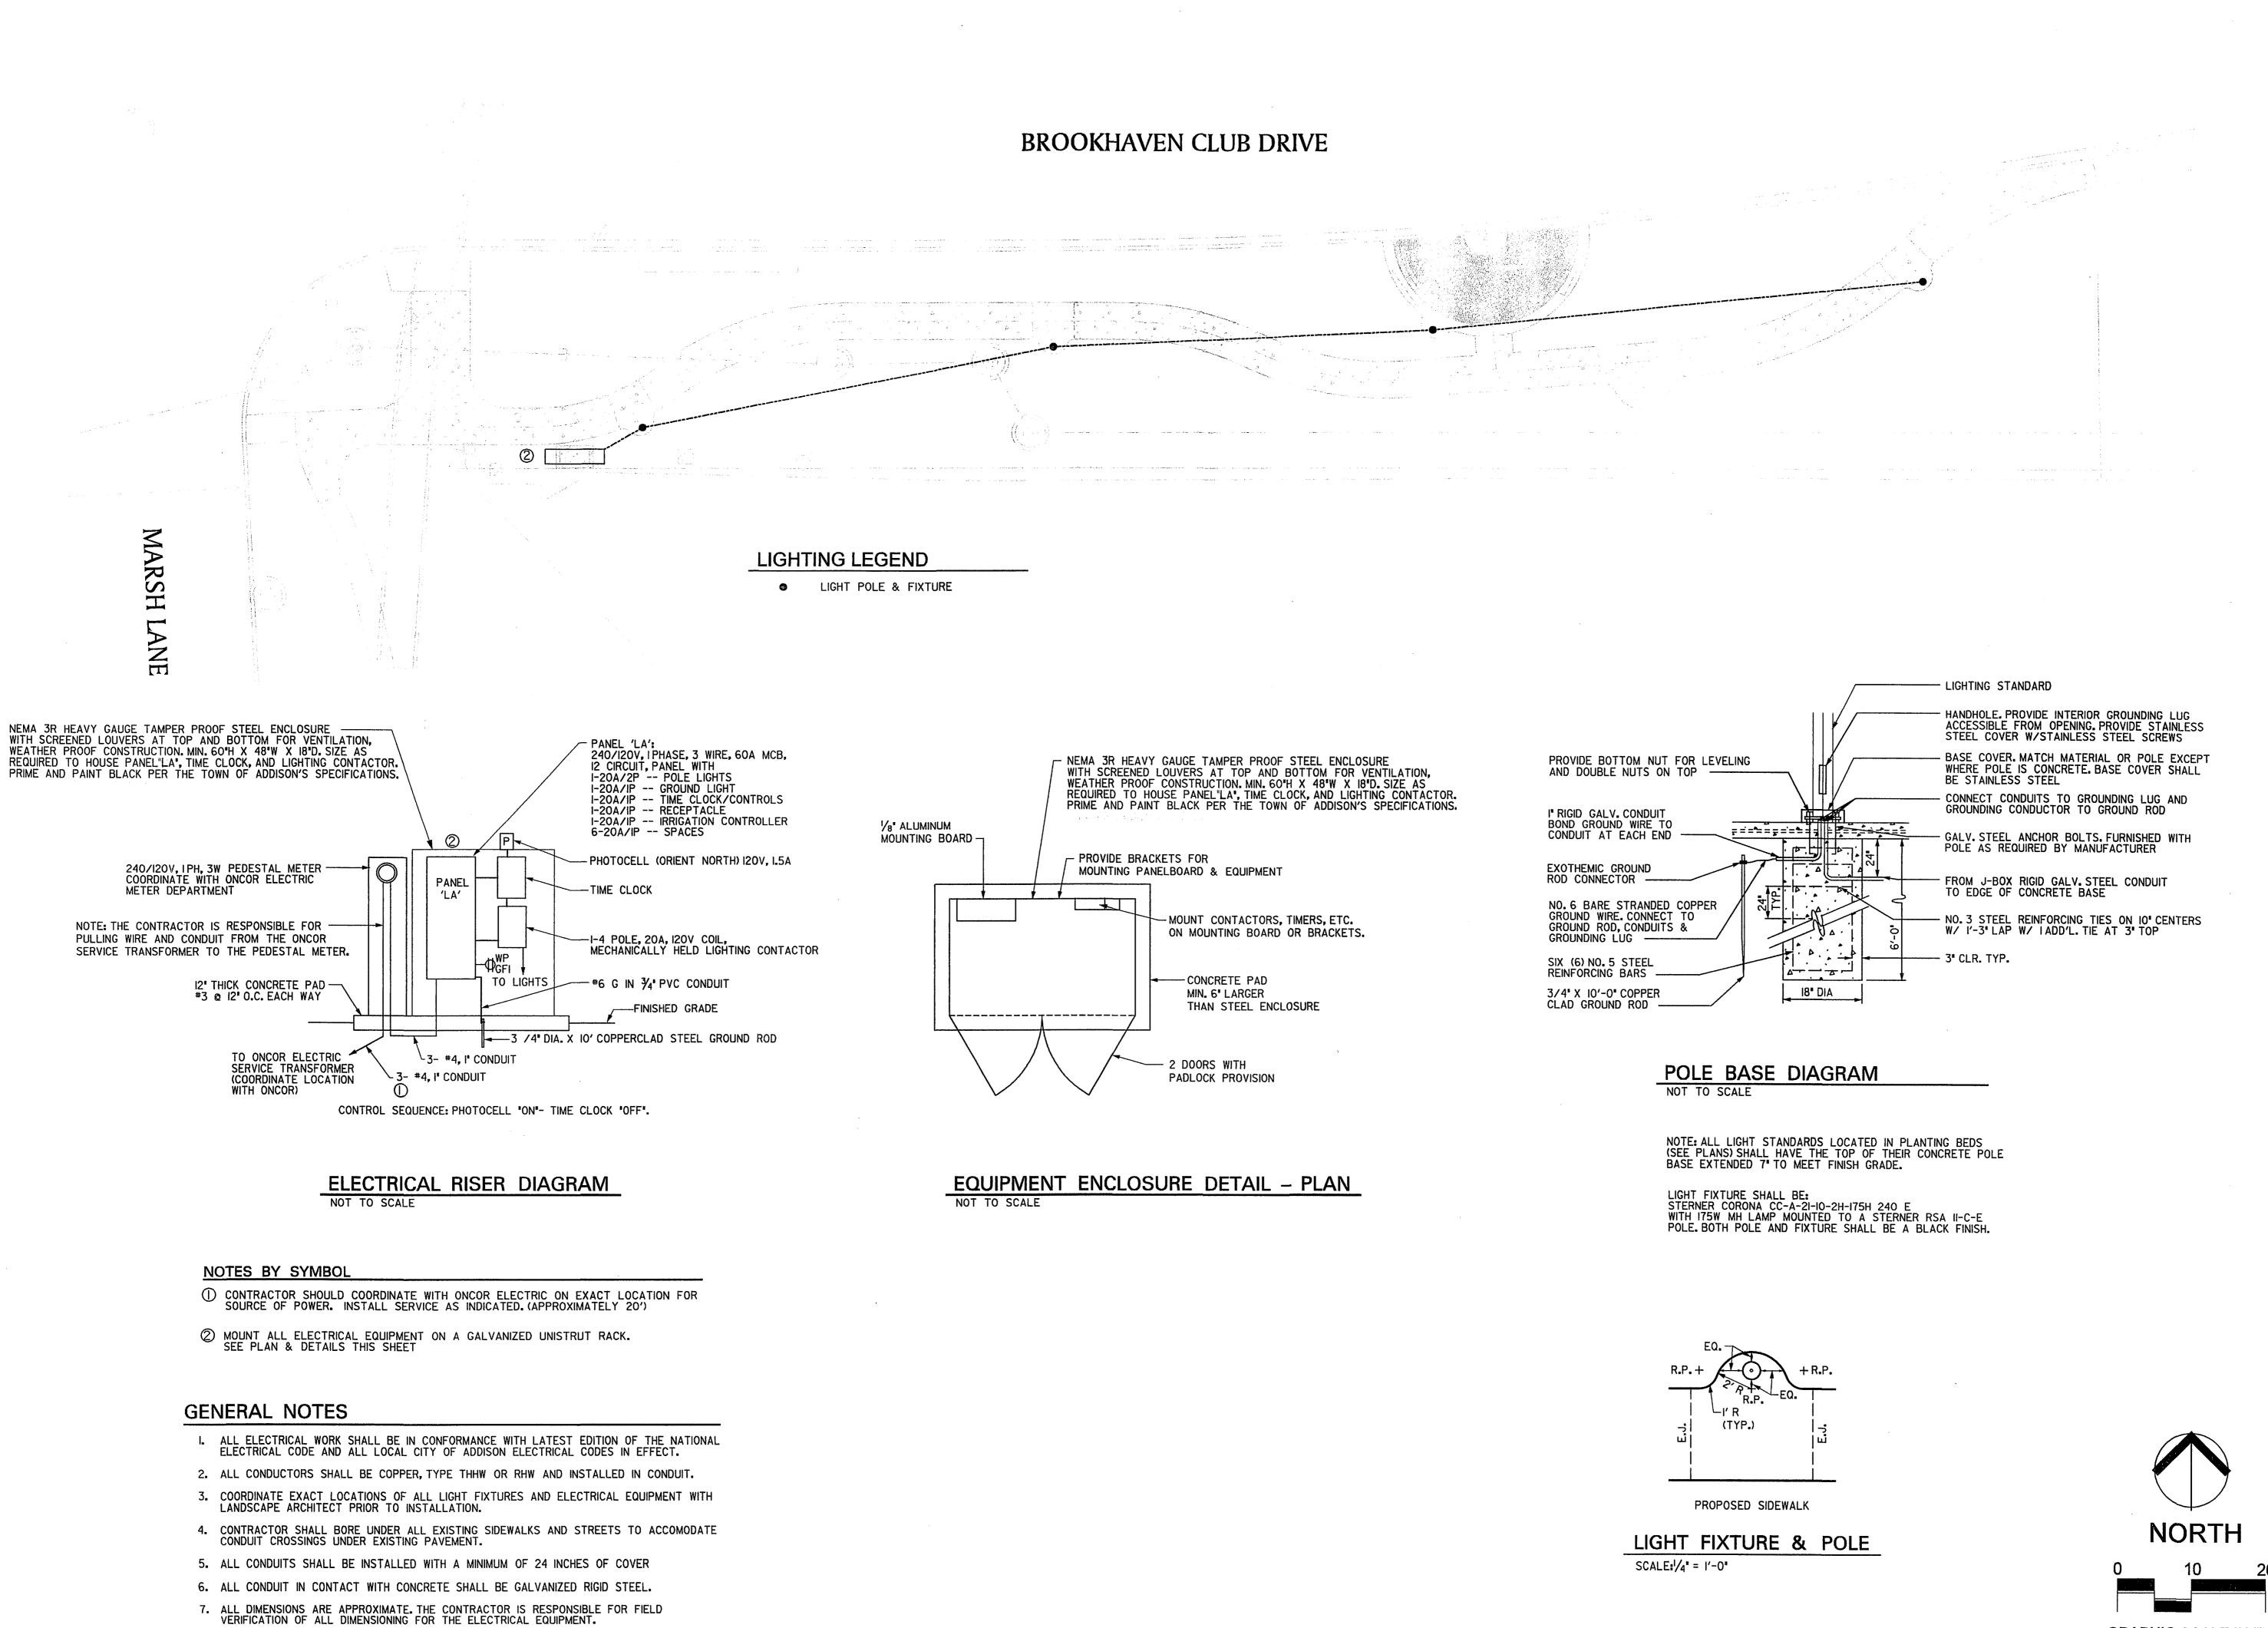

↑↑↑ΠΛΤΓ↑↑↑ \$DGN\$SPECIFICATION

Frye Associates 2874 Ridgedale Dr. Lewisville, Texas 75067

WATER SMART IRRIGATION. P.O. BOX 580518 The Colony, Texas 75056

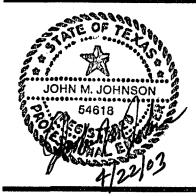

F&A JOB NUMBER:


DATE ISSUED: Apr. 22, 2003 **REVISIONS:**

GRAPHIC SCALE IN FEET

LIGHTING PLAN & DETAILS

SHEET NUMBER:

E-'

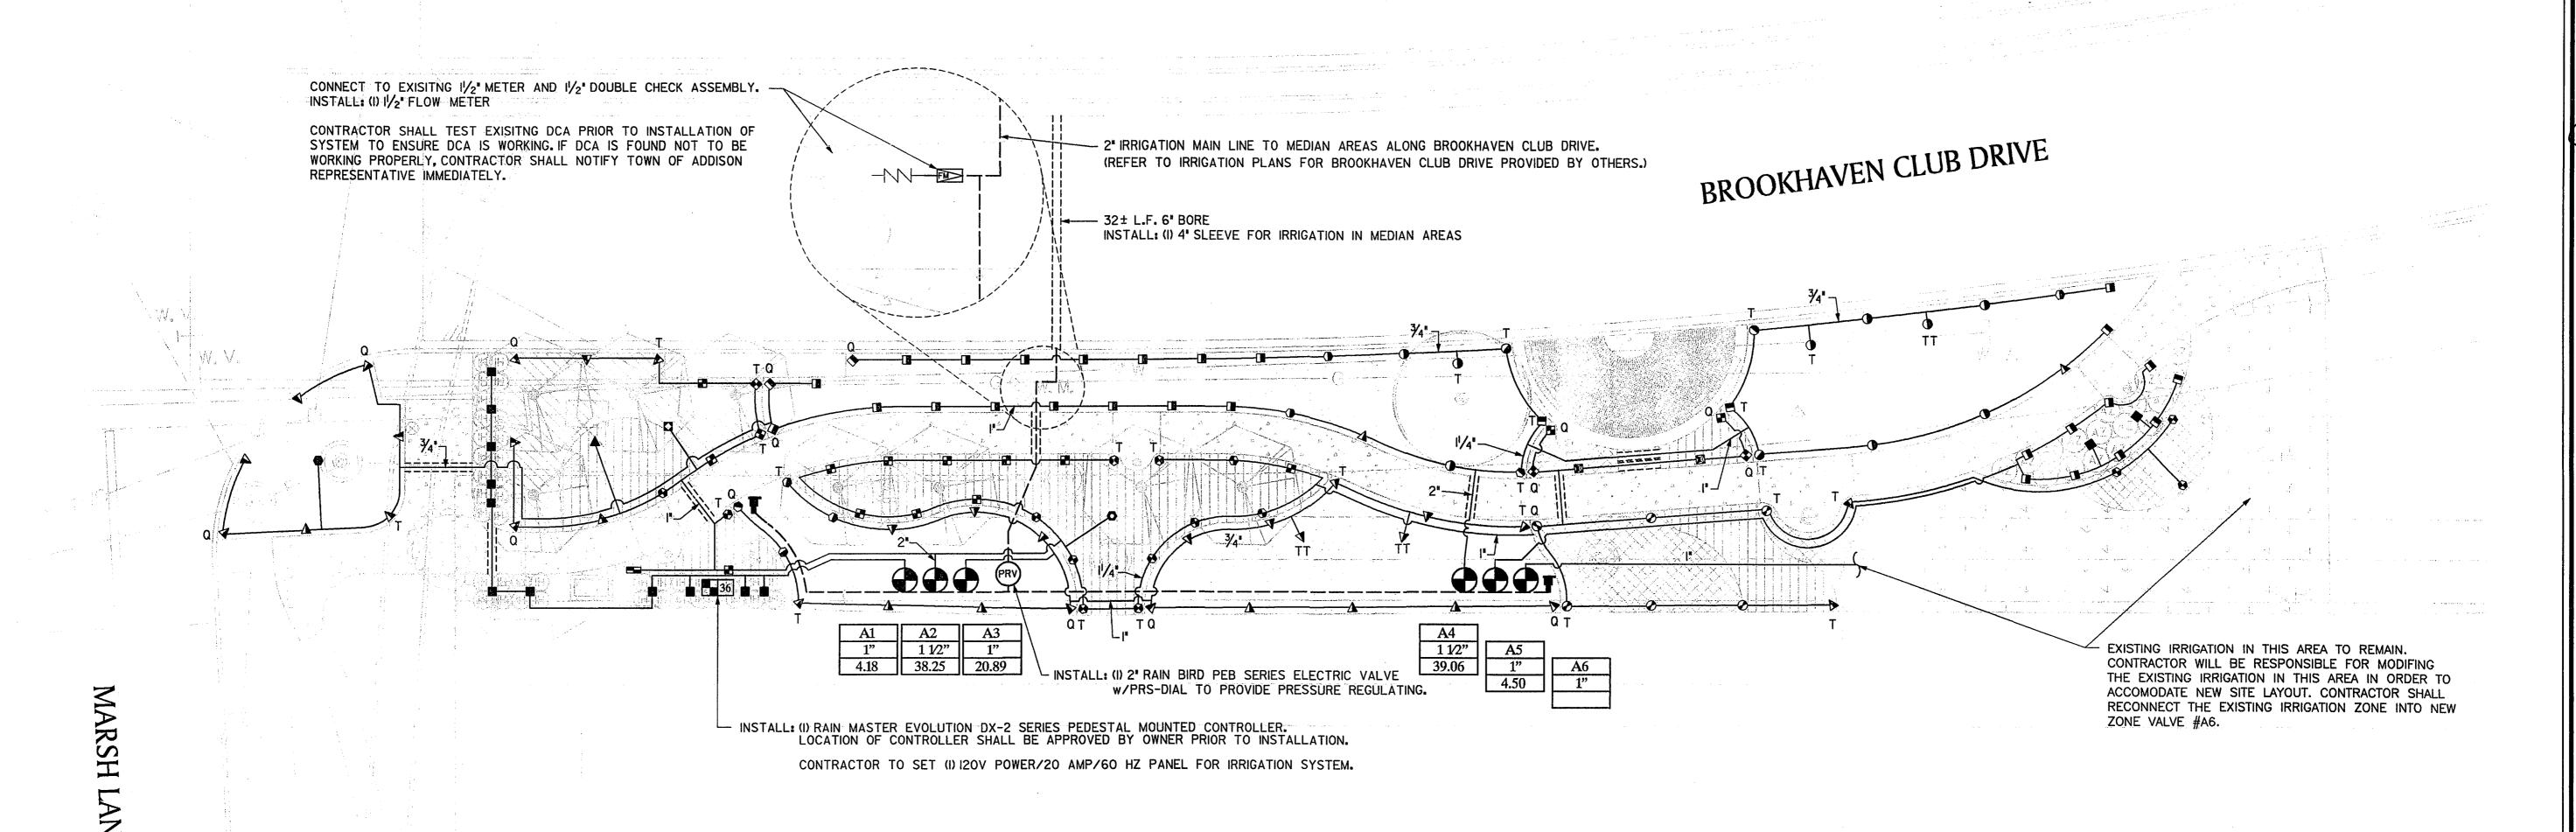

PIPING NOTES:

- TORO 570Z MPR PLUS 15'R 4" POP UP SPRAY HEAD PART CIRCLE @ 30 psi

 TORO 570Z MPR PLUS 15'R 12" POP UP SPRAY HEAD PART CIRCLE @ 30 psi

 F (360°) 3.60 GPM, TQ (270°) 2.60 GPM, TT (240°) 2.20 GPM, * (180°) 1.65 GPM,

 T (120°) 1.10 GPM, Q (90°) .85 GPM
- TORO 570Z MPR PLUS 12'R 4" POP UP SPRAY HEAD PART CIRCLE @ 30 psi
 TORO 570Z MPR PLUS 12'R 12" POP UP SPRAY HEAD FULL CIRCLE @ 30 psi
- TORO 5702 MPR PLUS 12' R 12" POP UP SPRAY HEAD PART CIRCLE @ 30 psi F (360°) - 2.19 GPM, TQ (270°) - 1.55 GPM, TT (240°) - 1.45 GPM, * (180°) - 1.09 GPM, T (120°) - .72 GPM, Q (90°) .50 GPM
- TORO 570Z MPR PLUS IO'R 4º POP UP SPRAY HEAD FULL CIRCLE @ 30 psi
 TORO 570Z MPR PLUS IO'R 4º POP UP SPRAY HEAD PART CIRCLE @ 30 psi
- TORO 570Z MPR PLUS 10'R 12" POP UP SPRAY HEAD FULL CIRCLE @ 30 psi

 TORO 570Z MPR PLUS 10'R 12" POP UP SPRAY HEAD PART CIRCLE @ 30 psi

 F (360°) 1.49 GPM, TQ (270°) 1.04 GPM, TT (240°) .97 GPM, * (180°) .71 GPM,

 T (120°) .52 GPM, Q (90°) .40 GPM
- TORO 570Z MPR PLUS 8'R 4" POP UP SPRAY HEAD FULL CIRCLE @ 30 psi
 TORO 570Z MPR PLUS 8'R 4" POP UP SPRAY HEAD PART CIRCLE @ 30 psi
 TORO 570Z MPR PLUS 8'R 12" POP UP SPRAY HEAD FULL CIRCLE @ 30 psi
- TORO 5702 MPR PLUS 8'R 12" POP UP SPRAY HEAD FULL CIRCLE @ 30 psi

 TORO 570Z MPR PLUS 8'R 12" POP UP SPRAY HEAD PART CIRCLE @ 30 psi

 F (360°) 1.00 GPM, TQ (270°) .76 GPM, TT (240°) .70 GPM, * (180°) .50 GPM,

 T (120°) .30 GPM, Q (90°) .24 GPM
- TORO 570Z MPR PLUS 4 POP UP SPECIAL PATTERN SPRAY HEAD @ 30 psi 4S-SST - 1.47 GPM
- * ALL SPRAY HEADS NOT OTHERWISE DESIGNATED SHALL BE 180° THROW.
- FLOW METER
- (PRV) MASTER VALVE W/PRESSURE REGULATOR
- WEATHERMATIC 11000 FCR SERIES ELECTRIC VALVE
- IRRIGATION WATER MAIN (NUMBER DENOTES PIPE SIZE) 2" UNLESS OTHERWISE NOTED.

 IRRIGATION WATER LATERAL (NUMBER DENOTES PIPE SIZE)
 - SLEEVE (SLEEVE SHALL BE 2 SIZES LARGER THAN PIPE CARRIED)
- Al l¹/2" 40

VALVE SIZE
GPM

RAINMASTER DX-2 SERIES PEDESTAL MOUNTED CONTROLLER W/NUMBER OF STATIONS REQUIRED

WEST AG VO75 QUICK COUPLER

VALVE NUMBER

IRRIGATION NOTES:

Irrigation Plan Is Schematic. All Piping Heads, Valves, Etc. Shall Be Located As Shown On The Details. Report Any Discrepancies Between Actual And Proposed Site Conditions To The Representative For The Town Of Addison. Do Not Proceed With Work Until Said Discrepancies Are Resolved.

Verify That The Work Of Other Contractors/Trades Is Sufficiently Complete To Allow Commencement Of Irrigation Installation Prior To Beginning Work.
Contractors Shall Coordinate Installation Of All Irrigation Sleeves Under Pavement With Other Contractors.

Coordinate Irrigation Installation With The Work Of Other Contractors/Trades And Protect The Work Of Other Contractor/Trades. Irrigation Contractor Is Responsible For All Damages Resulting From His Actions.

The Irrigation Contractor ShallProvide The Owner With Two Copies Of The Parts List And Manufacture's Catalog Showing Performance, Quality And Function Of Each Item Of Equipment In The System. In Addition, The Irrigation Contractor ShallProvide The Owner Written Instructions For Operation And Maintenance Of The System.

Prior To The Acceptance Of Irrigation System By Owner, A Person Qualified To Represent The Irrigation Contractor Shall Be Present At The Final Inspection To Demonstrate The System And Prove Its Performance Prior To The Inspection. All Work Shall Have Been Completed, TESTED, Adjusted And Placed In Operation.

All Work And Equipment To Be Guaranteed For One Year From Date Of Acceptance By Town of Addison. A Copy Of The Guarantee Shall Be Included In The Operation/Maintenance Instructions.

Irrigation System Installation To Be Performed In Accordance With All Pertinent Codes And Ordinances.

No PVC Piping Shall Be Located Under Tree Rootballs.

The Contractor Shall Verify Location Of All Underground Utilities Prior To Installation. If Any Underground Or Above Ground Construction Is Located As To Significantly Hinder Installation Or Function Of The Irrigation System, The Owner Shall Be Notified Immediately.

Main Line Piping And Lateral Piping May Be Placed In Same Trench When Possible. Main Line Piping Shall Be Installed In Bottom Of Trench With Laterals On Top.

Sleeves Shall Be Installed Wherever Pipes Run Under Pavement.


The Contractor is Responsible For Running Power To All Controllers.

The Contractor Is Responsible In Coordinating With The Town of Addison
The Installation Of The Southwestern Bell Phone Line Needed For Linking
The New Irrigation System Into To The Existing Central Irrigation Control System.

PIPING NOTES:

- 1. MINIMUM PIPE SIZE FOR SPRAY SECTIONS SHALL BE 1/2".
- 2. MINIMUM PIPE SIZE FOR ROTOR SECTIONS SHALL BE 3/4".
- 3. THE MINIMUM AMOUNT OF PIPE LABELING IS INDICATED.
 THE PIPE SIZES ARE LABELED WHERE THEY INCREASE IN
 PIPE SIZE MOVING FROM DOWNSTREAM TO UPSTREAM ALONG
 THE SECTION. WHERE PIPE IS NOT LABELED DOWNSTREAM
 IT SHALL BE OF THE MINIMUM SIZE.


Irrigation Contractor Is Responsible For Obtaining A Copy Of The Town Of Addison's Irrigation Specifications, And Adhering To The Specifications During Installation Of The Irrigation System..

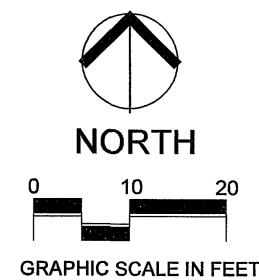

IRRIGATION PLAN

Frye Associates
2874 Ridgedale Dr.
Lewisville, Texas 75067

WATER SMART IRRIGATION, In P.O. BOX 560518 The Colony, Texas 75058

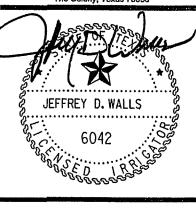

& Landscape Developme

own of Addison Parks Recreation & Lar O. O. Box 9010


BROOKIAV

F&A JOB NUMBER


DATE ISSUED: Apr. 22, 2003 REVISIONS:

SHEET NUMBER:


IR-1

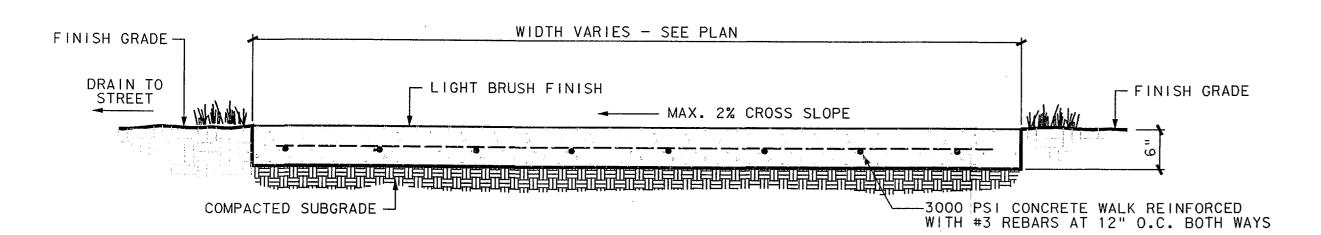

WALK DETAIL N.T.S.

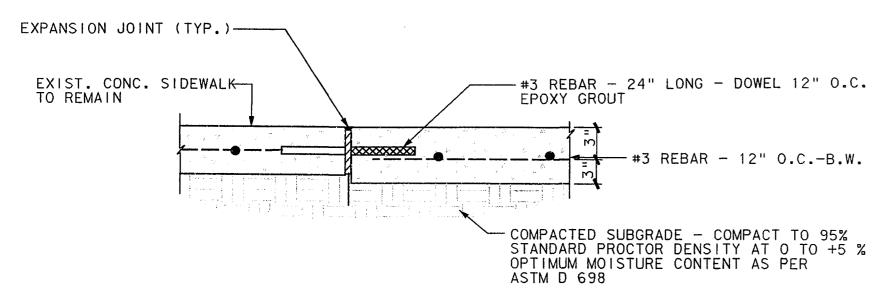


PROPOSED SIDEWALK TO EXISTING SIDEWALK CONNECTION

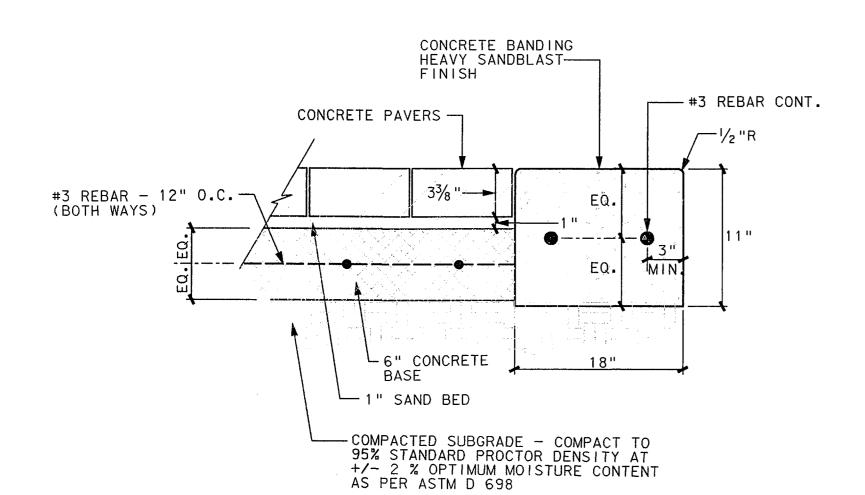

DART PLAZA CONCRETE PAVERS & 18" CONCRETE BAND


 $1\frac{1}{2}$ " = 1'-0"

|" = |'-O"

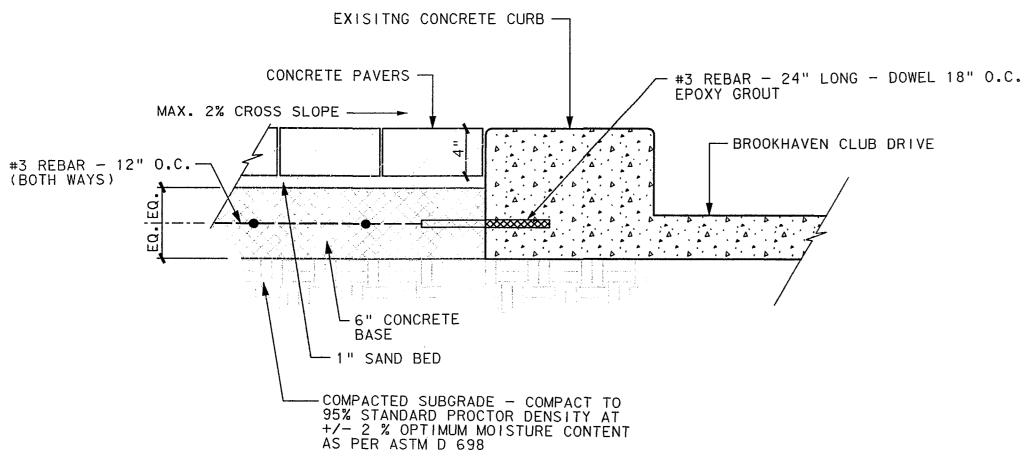


CONCRETE PAVERS & EXISTING CONCRETE CURB AT DART PLAZA


 $1\frac{1}{2}$ " = 1'-0"

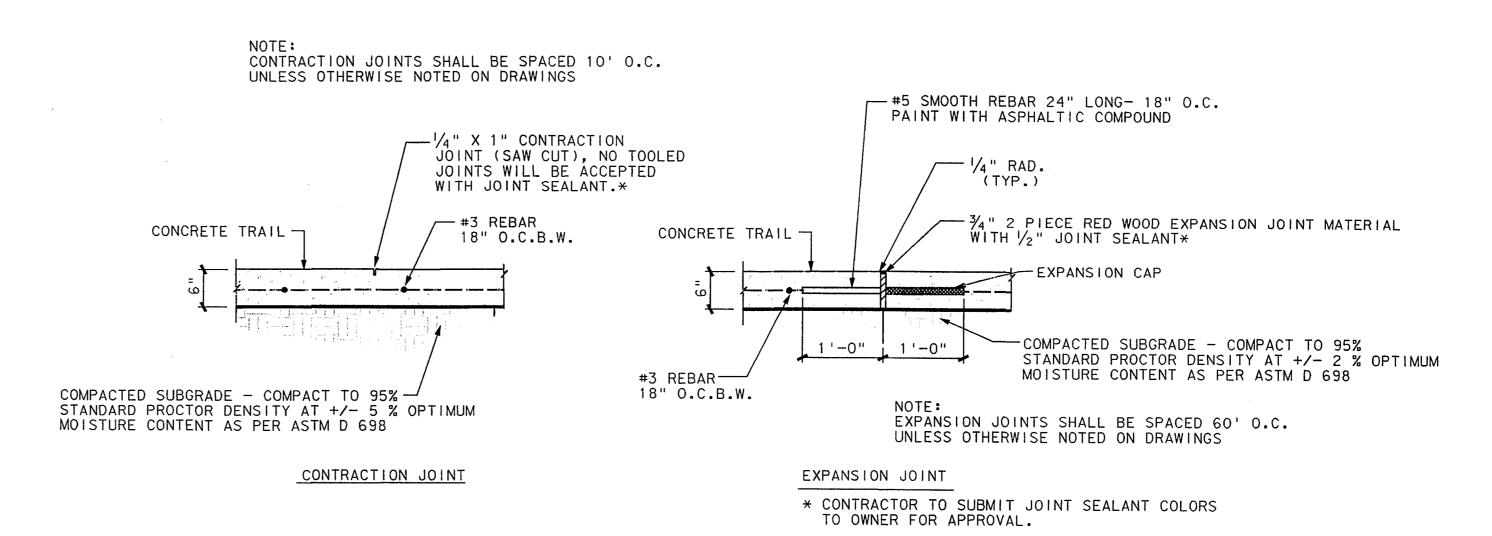

CONTRACTION & EXPANSION JOINTS

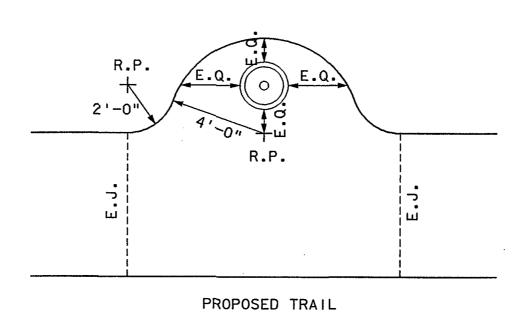

TRASH RECEPTACLE - PLAN

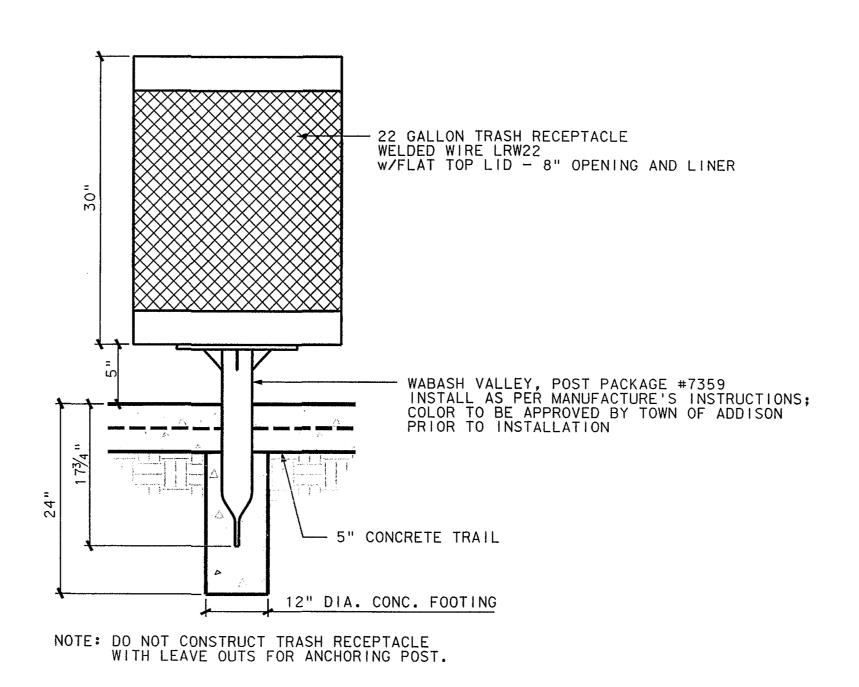

1'' = 1' - 0''

TRASH RECEPTACLE 1" = 1'-0"

SITE DETAILS

Frye Associates 2874 Ridgedale Dr. Lewisville, Texas 75067

WATER SMART IRRIGATION, P.O. BOX 580518 The Colony, Texas 75058


ROBIN R. FRYE

F&A JOB NUMBER: 0228 DATE ISSUED:


Apr. 22, 2003 **REVISIONS:**

SHEET NUMBER:


GROUND COVER PLANTING DETAIL

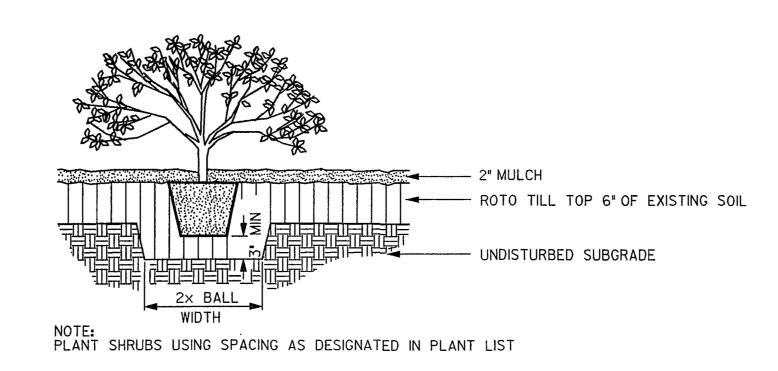


SHRUB PLANTING DETAIL

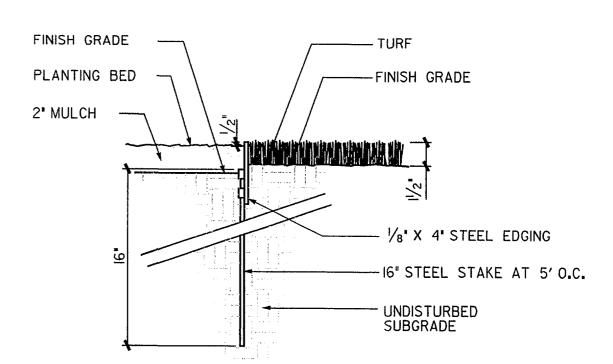

STEEL EDGING

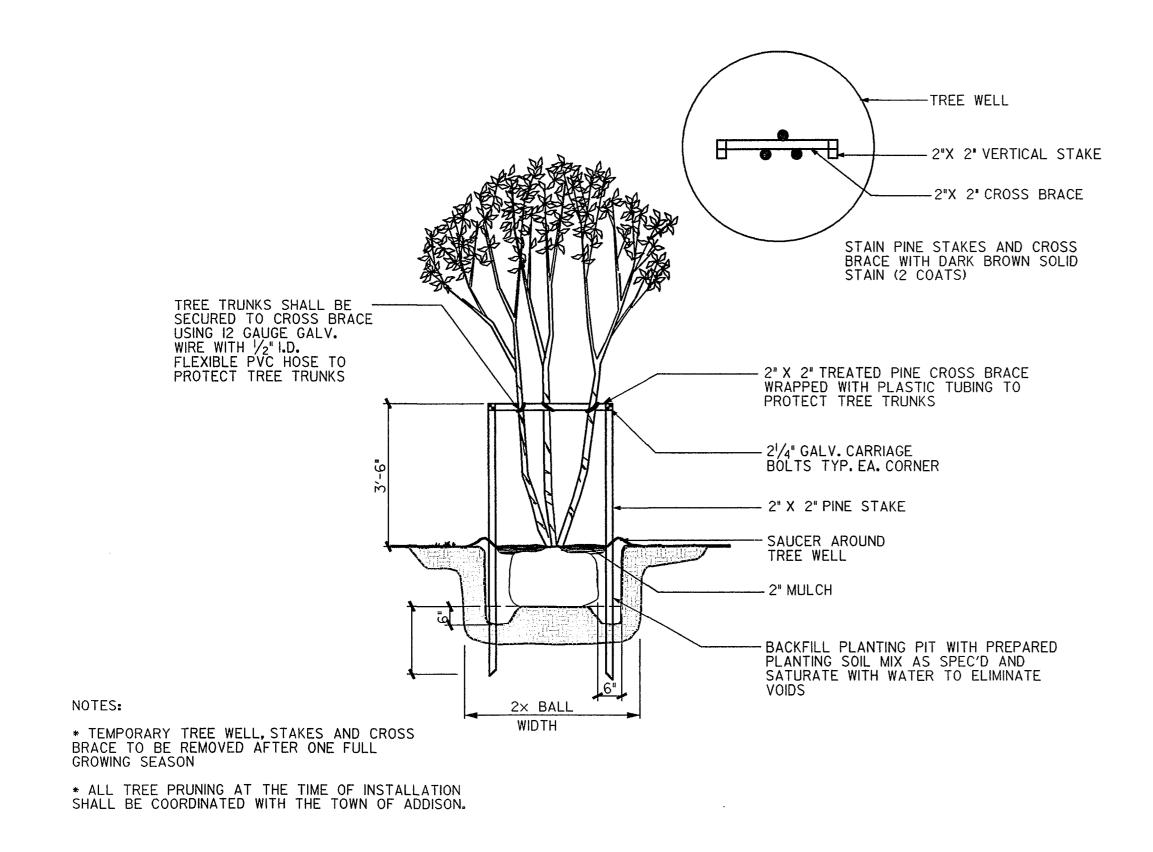

MULTI-TRUNK TREE PLANTING & STAKING DETAIL

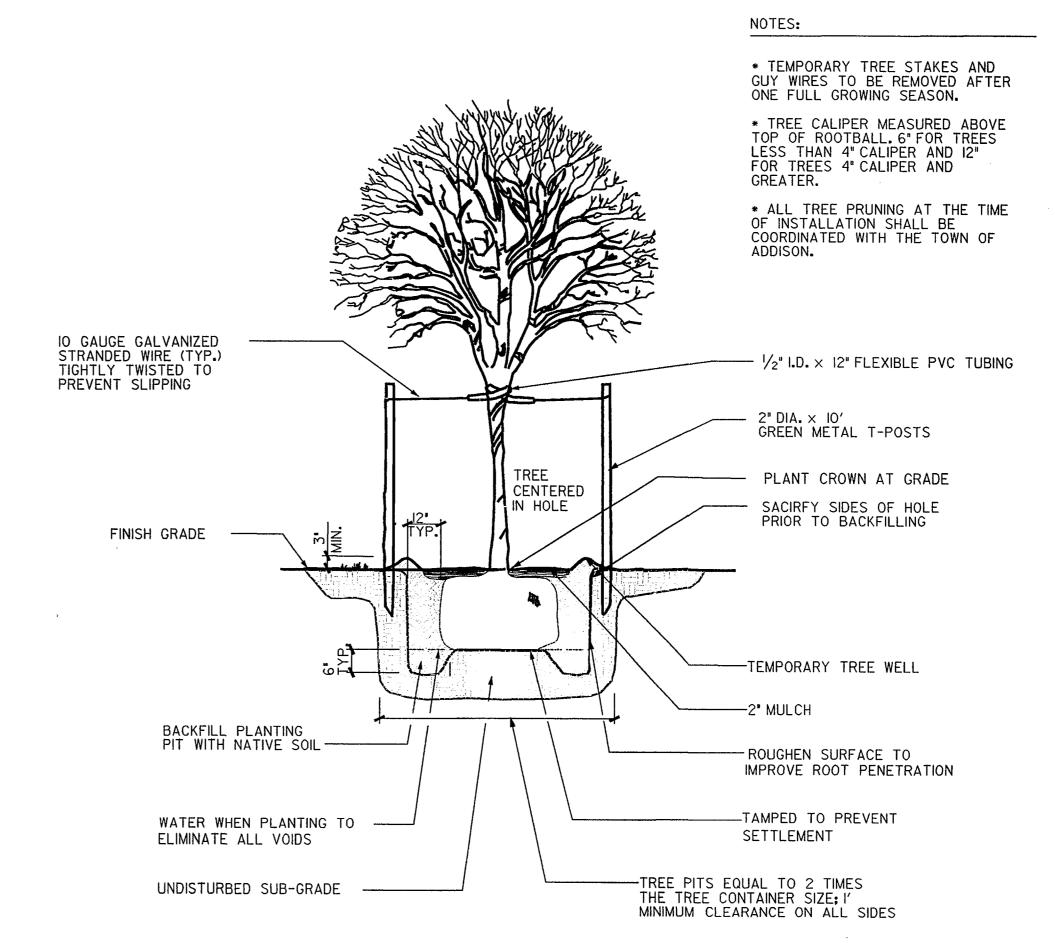

TREE PLANTING & STAKING DETAIL

PLANTING DETAILS

Frye Associates
2874 Ridgedale Dr.
Lewisville, Texas 75067

WATER SMART IRRIGATION,

ROBIN R. FRYE

1971

ARCHARGA ARCHARCHARGA ARCHARGA ARCHARGA ARCHARGA ARCHARCHARCA A

ndscape Development

Town of Addison Parks Recreation & Lan P.O. Box 9010


BROC

F&A JOB NUMBER:

DATE ISSUED:
Apr. 22, 2003
REVISIONS:


SHEET NUMBER:

\$\$\$DATE\$\$\$ \$DGN\$SPECIFICATION

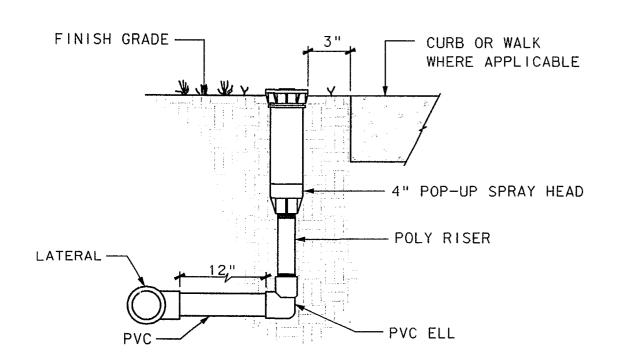


TURF POP-UP SPRAY HEAD DETAIL

NOT TO SCALE

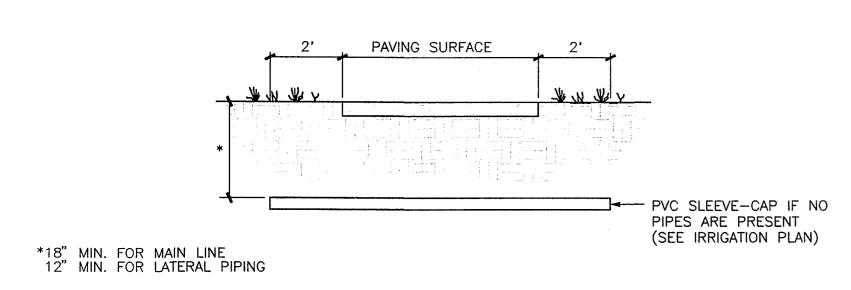


SLEEVE DETAIL

NOT TO SCALE

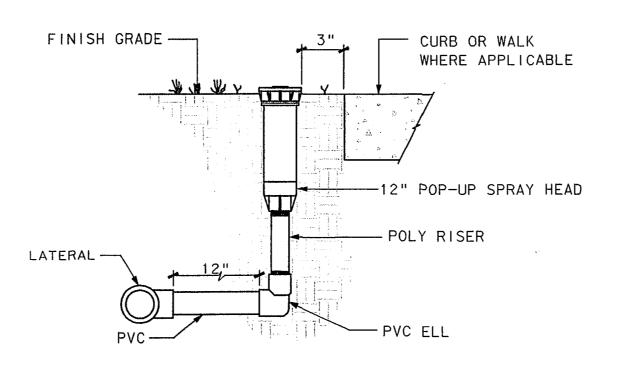


HIGH POP-UP SPRAY HEAD DETAIL

NOT TO SCALE

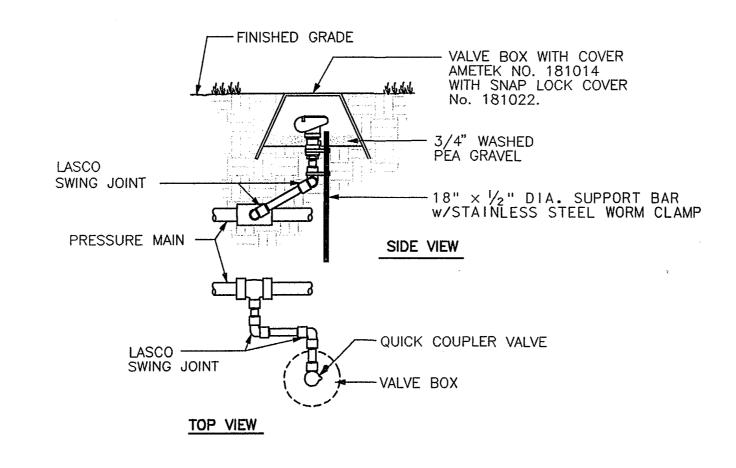


QUICK COUPLING VALVE DETAIL

NOT TO SCALE

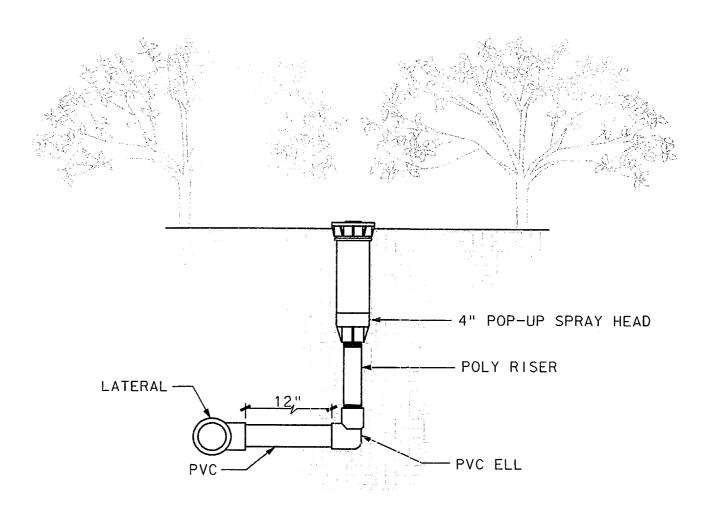

SHRUB POP-UP SPRAY HEAD DETAIL

NOT TO SCALE

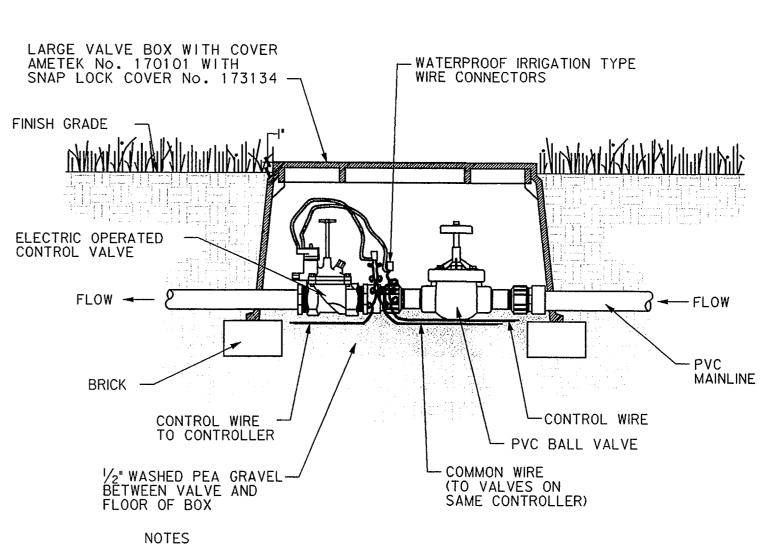

- I. ALL WIRE TO BE INSTALLED PER LOCAL CODE.

 2. TAPE AND BUNDLE WIRE EVERY TEN FEET.

 3. PROVIDE EXPANSION COILS AT EACH WIRE CONNECTION IN VALVE BOX. (WRAP AROUND I/ 2' PIPE 15 TIMES.

 4. COMPACT SOIL AROUND VALVE BOX TO SAME DENSITY AS UNDISTURBED ADJACENT SOIL.

 5. ORIENT RECTANGULAR VALVE BOXES SO THT THE EDGES ARE PARALLEL TO ADJACENT WALKS, CURBS, ETC.

SOLENOID VALVE DETAIL

NOT TO SCALE

2874 Ridgedale Dr. Lewisville, Texas 75067 WATER SMART IRRIGATION, P.O. BOX 560518 The Colony, Texas 75056 JEFFREY D. WALLS

Frye Associates

BROOKH

F&A JOB NUMBER: 0228

DATE ISSUED: Apr. 22, 2003 **REVISIONS:**

SHEET NUMBER:


DT-3

IRRIGATION DETAILS

BROOKHAVEN CLUB DR. **TEXAS** ADDISON,

IRRI*TECH CORPORATION

DESIGN DEPARTMENT 12650 SCHROEDER RD. DALLAS, TEXAS 75243 TEL: (972) 231-5151 FAX: (972) 231-5172

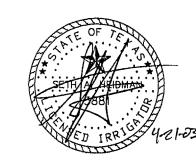

Revisions

1"=30'-0" 04/21/03

Sheet Title


IRRIGATION PLAN

Sheet No.

Page <u>1</u> of <u>5</u>

IRRI*TECH CORPORATION

DESIGN DEPARTMENT 12650 SCHROEDER RD. DALLAS, TEXAS 75243 TEL: (972) 231-5151 FAX: (972) 231-5172

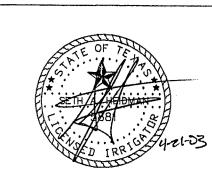


Revisions


Drawn	sah
Appr.	sah
Scale	1"=30'-0"
Date	04/21/03
Project	No.: 02066

Sheet Title

IRRIGATION PLAN

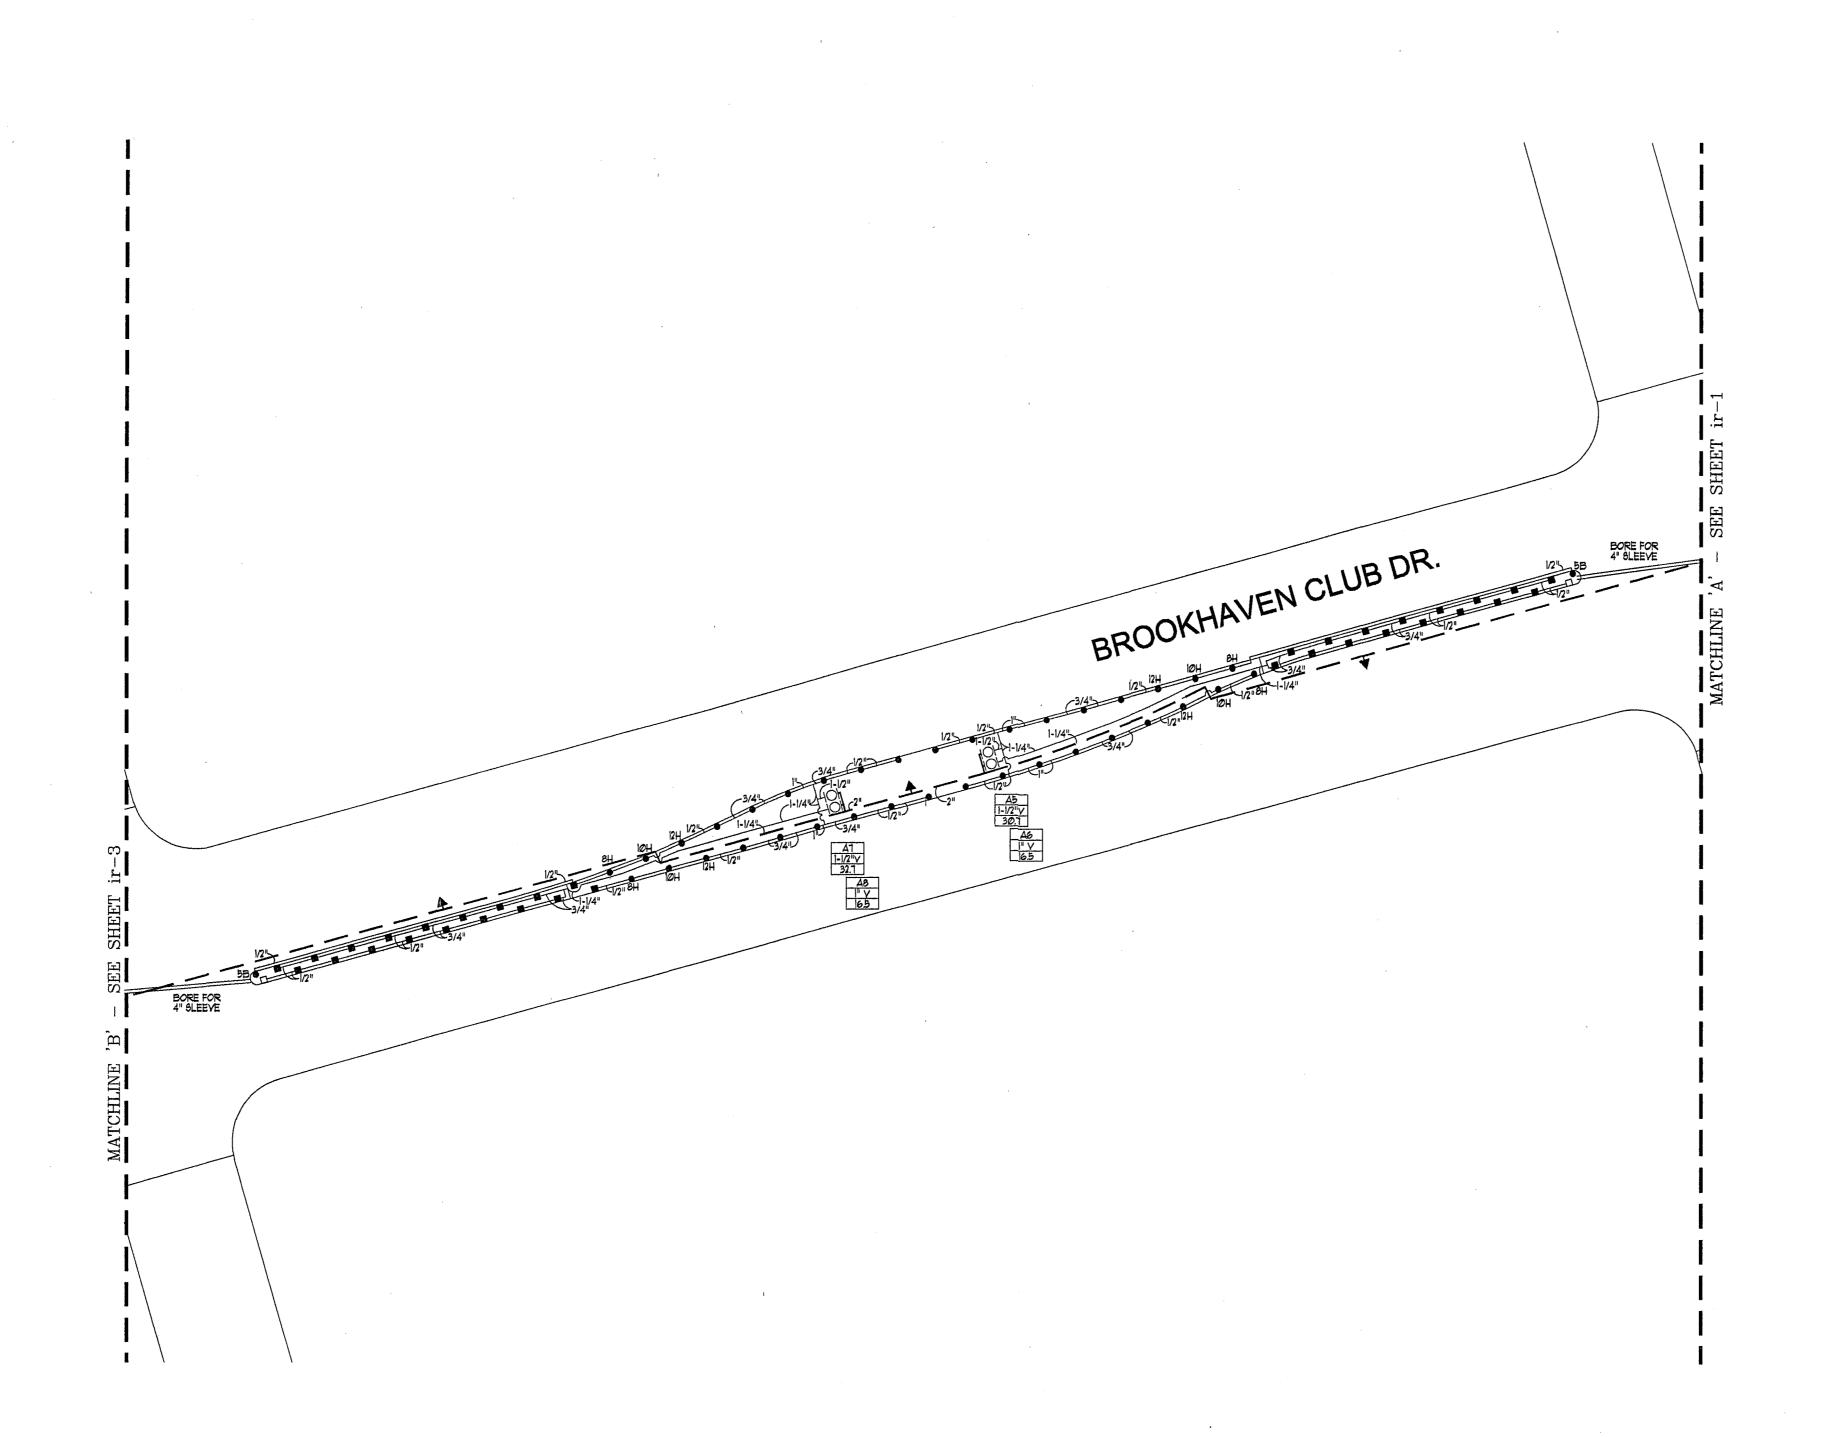



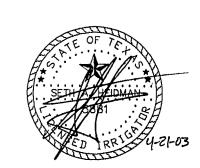

 Drawn
 sah

 Appr.:
 sah


 Scale:
 1"=30'-0"

 Date:
 04/21/03

 Project No.:
 02066

Sheet Title


IRRIGATION PLAN

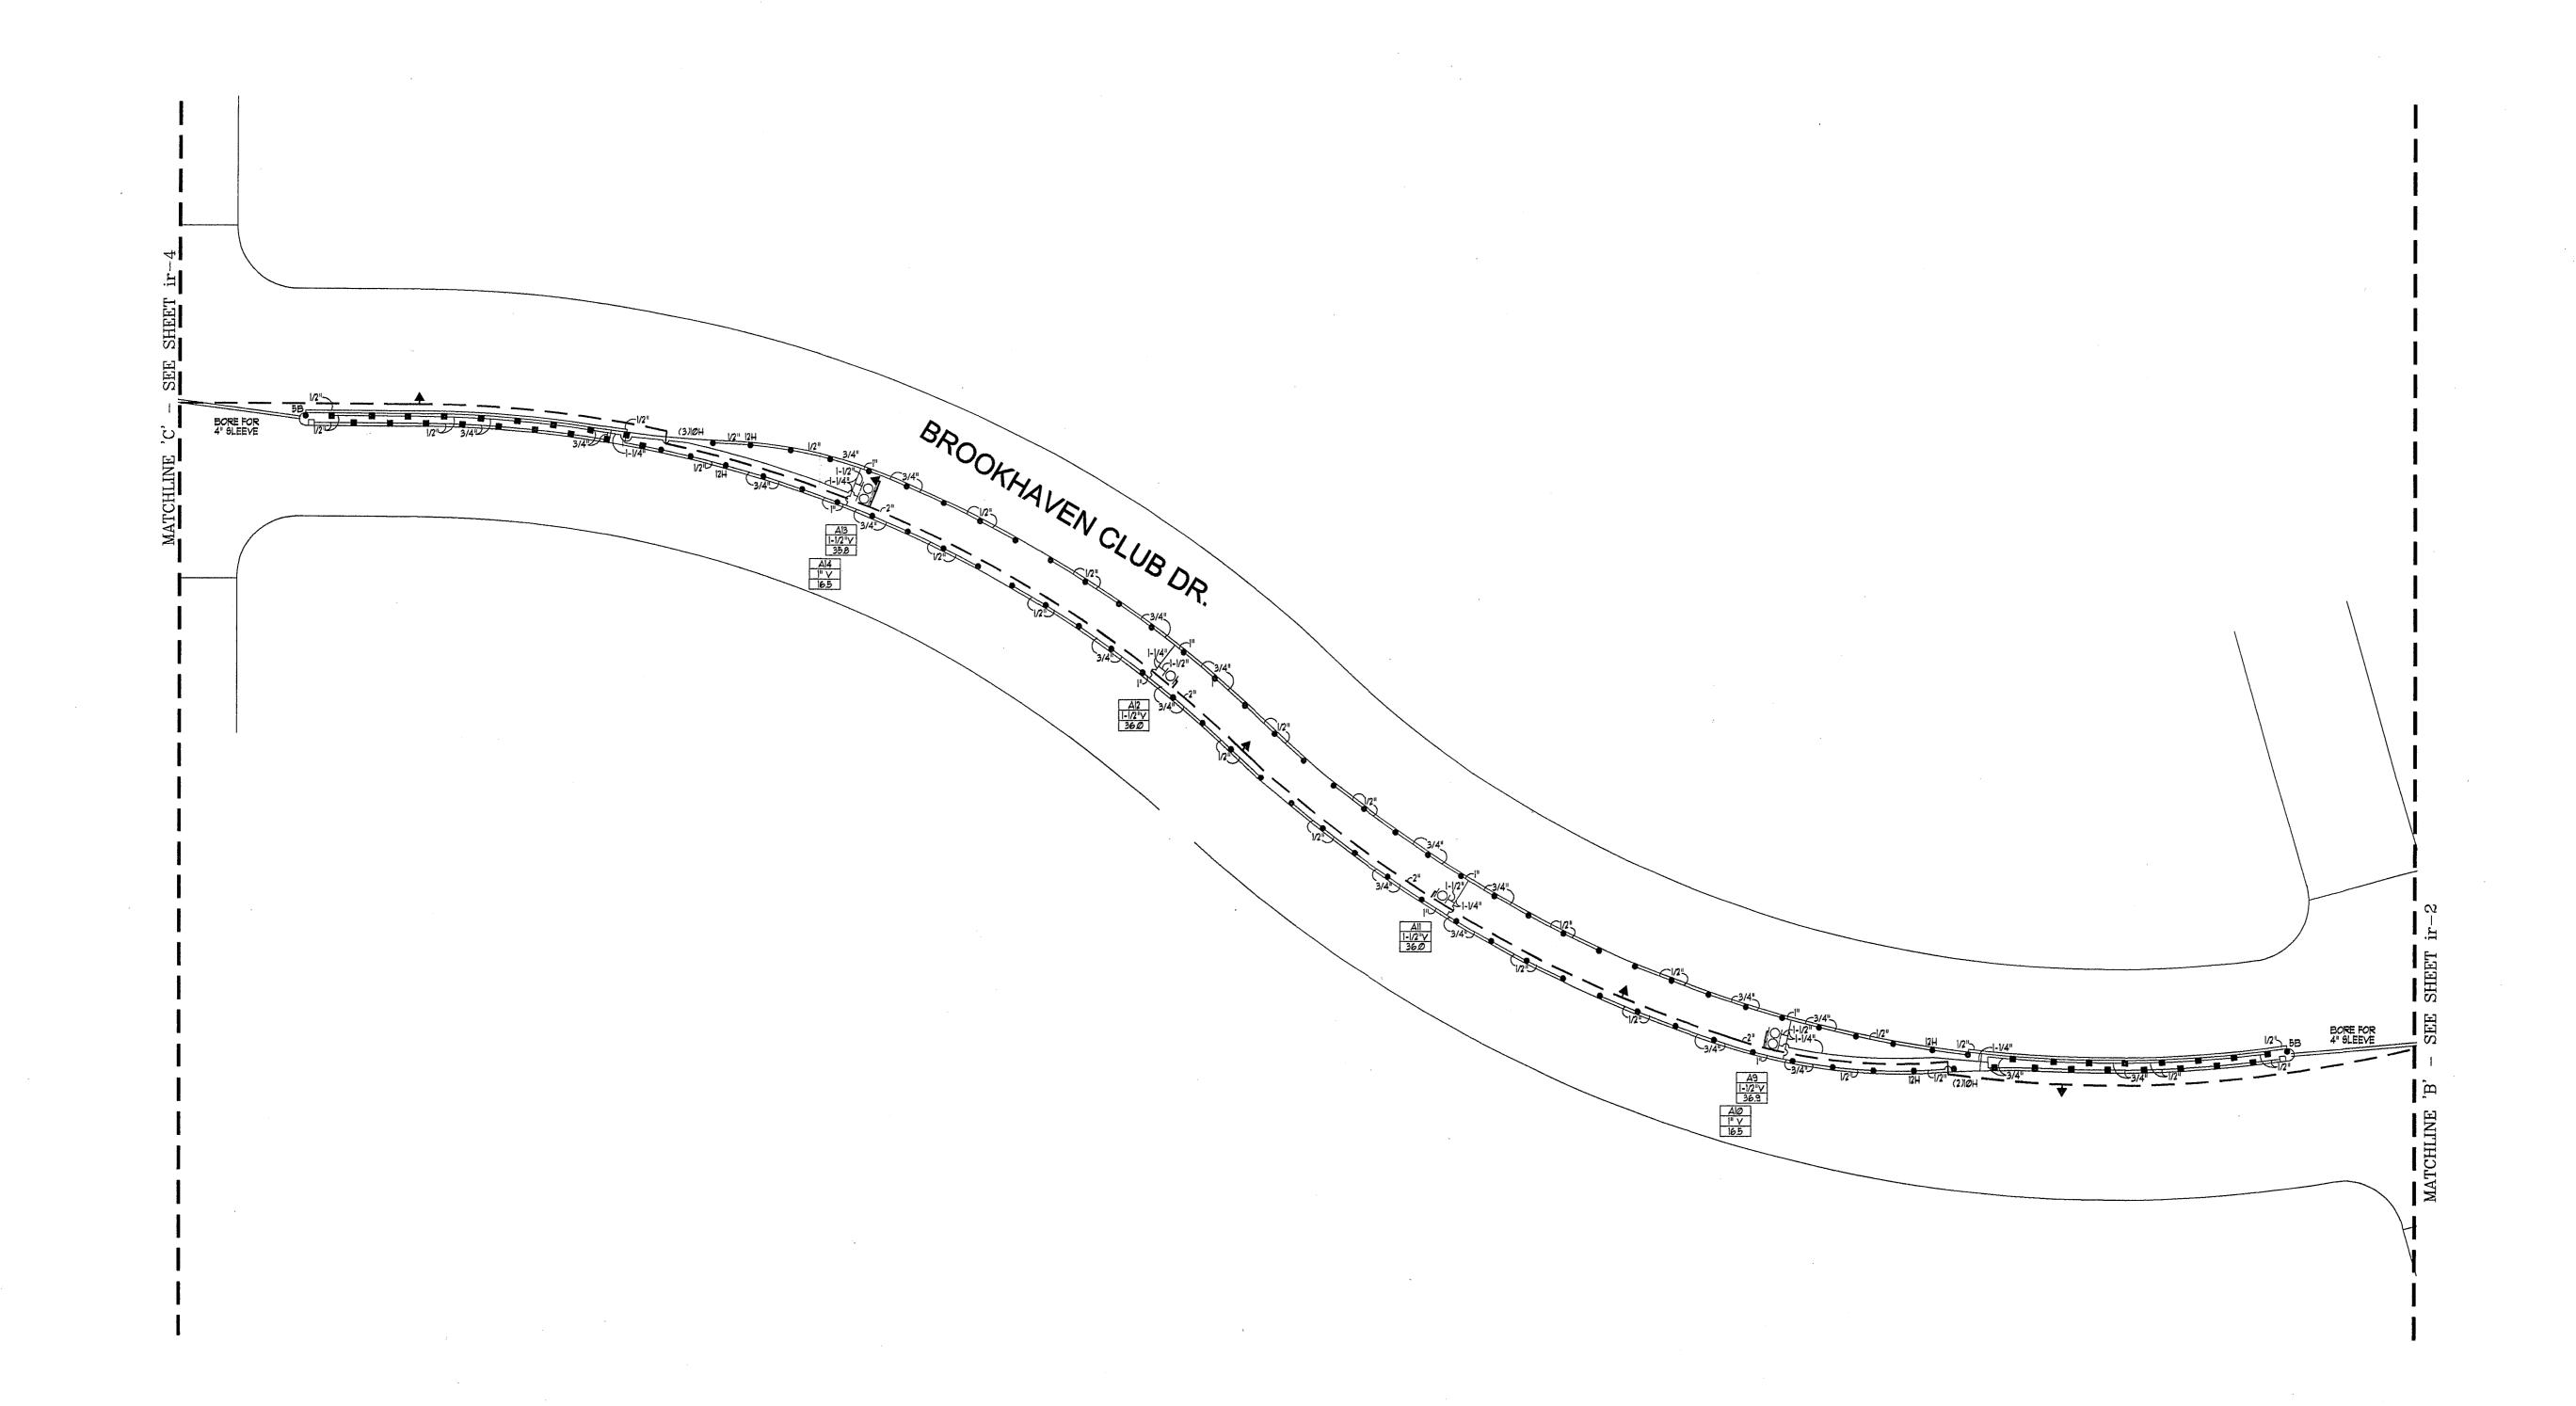

BROOKHAVEN CLUB DR. ADDISON, TEXAS

itc IRRI*TECH CORPORATION

DESIGN DEPARTMENT 12650 SCHROEDER RD. DALLAS, TEXAS 75243 TEL: (972) 231-5151 FAX: (972) 231-5172

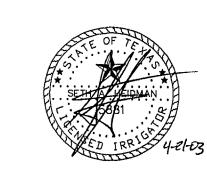

Revisions

No. Date Items

 Drawn
 sah

 Appr.:
 sah

 Scale:
 1"=30'-0"

 Date:
 04/21/03

 Project No.:
 02066

Sheet Title

IRRIGATION PLAN

BROOKHAVEN CLUB DR.


ALL 24 VOLT LEAD VALVE WIRING SHALL BE A MINIMUM OF UF-14 GA. SINGLE CONDUCTOR, ALL COMMON WIRING SHALL BE A MINIMUM OF UF-12 GA. SINGLE CONDUCTOR. REFER TO MANUFACTURER'S RECOMMENDATIONS PROPER WIRE SIZE, WIRE SPLICES SHALL BE PERMANENT AND WATERPROOF. 2. COORDINATE INSTALLATION OF IRRIGATION SYSTEM WITH LANDSCAPE CONTRACTOR TO ENSURE ALL PLANT MATERIAL WILL BE WATERED IN ACCORDANCE WITH THE INTENT OF THE PLANS AND SPECIFICATIONS. 3. LATERAL PIPING SHALL HAVE A MINIMUM OF 12" OF COVER. MAINLINE AND PIPING UNDER PAYING SHALL HAVE A MAXIMUM OF 16" OF COVER. 4. PIPING AND VALVES IN PAVING SHOWN FOR CLARITY, INSTALL IN ADJACENT PLANTING BED OR LAWN AREA. 5. CONNECT LAWN SPRAY HEADS TO LATERAL PIPING WITH 1/2" FLEXIBLE PVC AND 1/2" SCH. 40 PVC FITTINGS AS REQUIRED, PER DETAIL SHOWN. USE WELD-ON # 195 SOLVENT AND #P-68 PRIMER ON THESE CONNECTIONS. 6. INSTALL QUICK COUPLING VALVES ON TEN (10") INCH ARMOR (AMETEK) VALVE BOX PER DETAIL SHOWN. CONNECT QUICK COUPLING VALVES TO MAINLINE PIPE WITH LASCO "UNITIZED", O-RING SWING JOINTS PER DETAIL SHOWN, #T722-312. SUPPLY OWNER WITH THREE (3) COUPLER KEYS WITH SWIVEL HOSE BIBE, #33DK AND MØ RESPECTIVELY. 1. INSTALL REMOTE CONTROL VALVES IN TEN (10") INCH ARMOR (AMETEK) VALVE BOXES PER DETAIL SHOWN. 8. PERFORM ELECTRICAL WORK IN ACCORDANCE WITH LOCAL BUILDING CODE, POWER (120V) SHALL BE LOCATED IN A JUNCTION BOX WITHIN FIVE (5') FEET OF CONTROLLER LOCATION BY OTHER TRADES. 9. ROUTE COMMON WIRE FROM CONTROLLER TO REMOTE SENSORS IN SERIES PRIOR TO CONNECTING TO REMOTE CONTROL VALVES. 10. TEN DAYS PRIOR TO START OF CONSTRUCTION, VERIFY STATIC PRESSURE. IF STATIC PRESSURE IS LESS THAN 18.0 PSI, DO NOT START WORK UNTIL NOTIFIED TO PROCEED BY OWNER. DESIGN PRESSURE IS 58.0 PSI. 11. PLANS ARE DIAGRAMMATIC AND FIELD ADJUSTMENTS MAY BE NECESSARY. PRIOR TO TRENCHING, HEAD LAYOUT WITH FLAGS NEEDS TO BE DONE AND LOCATIONS APPROVED BY TOWN'S REP. 12. L.I.C. TO PROVIDE ALL NECESSARY HARDWARE AND LABOR NECESSARY FOR THE INSTALLATION OF THE IRRIGATION CONTROLELR AND REMOTE CONTROL VALVES. REFER TO MATT SWOR WITH LONGHORN FOR FOR QUESTIONS RELATING TO SPECIFIED EQUIPMENT. 13. SLEEVES AND BORES SHALL BE SCH. 40 PVC, REFER TO PLANS FOR SIZE. 14. TOWN OF ADDISON SPECIFICATIONS SUPERCEDE ANY ALL OTHERS NOTES AND DETAILS. IRRIGATION LEGEND: MANUFACTURER MODEL NO, SYMBOL DESCRIPTION LAWN SPRAY HEAD 570% SERIES W/ 15F, 15H, OR 15Q UNLESS NOTED OTHERWISE LAWN CENTER TORO 570Z SERIES W/ 9-SST NOZZLE STRIP HEAD LAWN END TORO 570Z SERIES W/ 9-SST NOZZLE STRIP HEAD WEST AG QUICK COUPLING VALVE REMOTE CONTROL WEATHER MATIC #10000 SERIES, REFER TO PLAN FOR SIZE VALVE CONTROLLER RAINMASTER EVOLUTION SERIES W/ MINI-CLIK RAIN AND TEMPERATURE SENSOR MAINLINE PIPING REFER TO SPEC. 9CH. 40 PVC LATERAL PIPING REFER TO SPEC. 5CH. 40 PVC NEW BACKFLOW *OOT SERIES PREVENTER WATER METER WEATHER MATIC *11000 SERIES, LINE SIZE MASTER VALVE STATION NUMBER VALVE SIZE GPM (APPROX.) BROOKHAVEN CLUB DR. MAINLINE, LATERAL, & WIRING -MOUNTING BRACKET -NEMA 3R ENCLOSURE -1/2" PVC CONDUIT TO CONTROLLER -1/2" PVC CONDUIT - CAPILLARY

9 **BROOKHAVEN**

S

IRRI*TECH **CORPORATION**

DESIGN DEPARTMEN 12650 SCHROEDER RD. DALLAS, TEXAS 75243 TEL: (972) 231-5151 FAX: (972) 231-5172

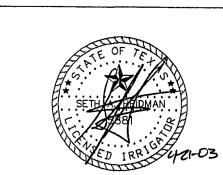


Revisions No. Date

sah 1"=30'-0" 04/21/03 Project <u>No. 02</u>066

Sheet Title

PLAN

Sheet No. ir-5Page 5 of 5

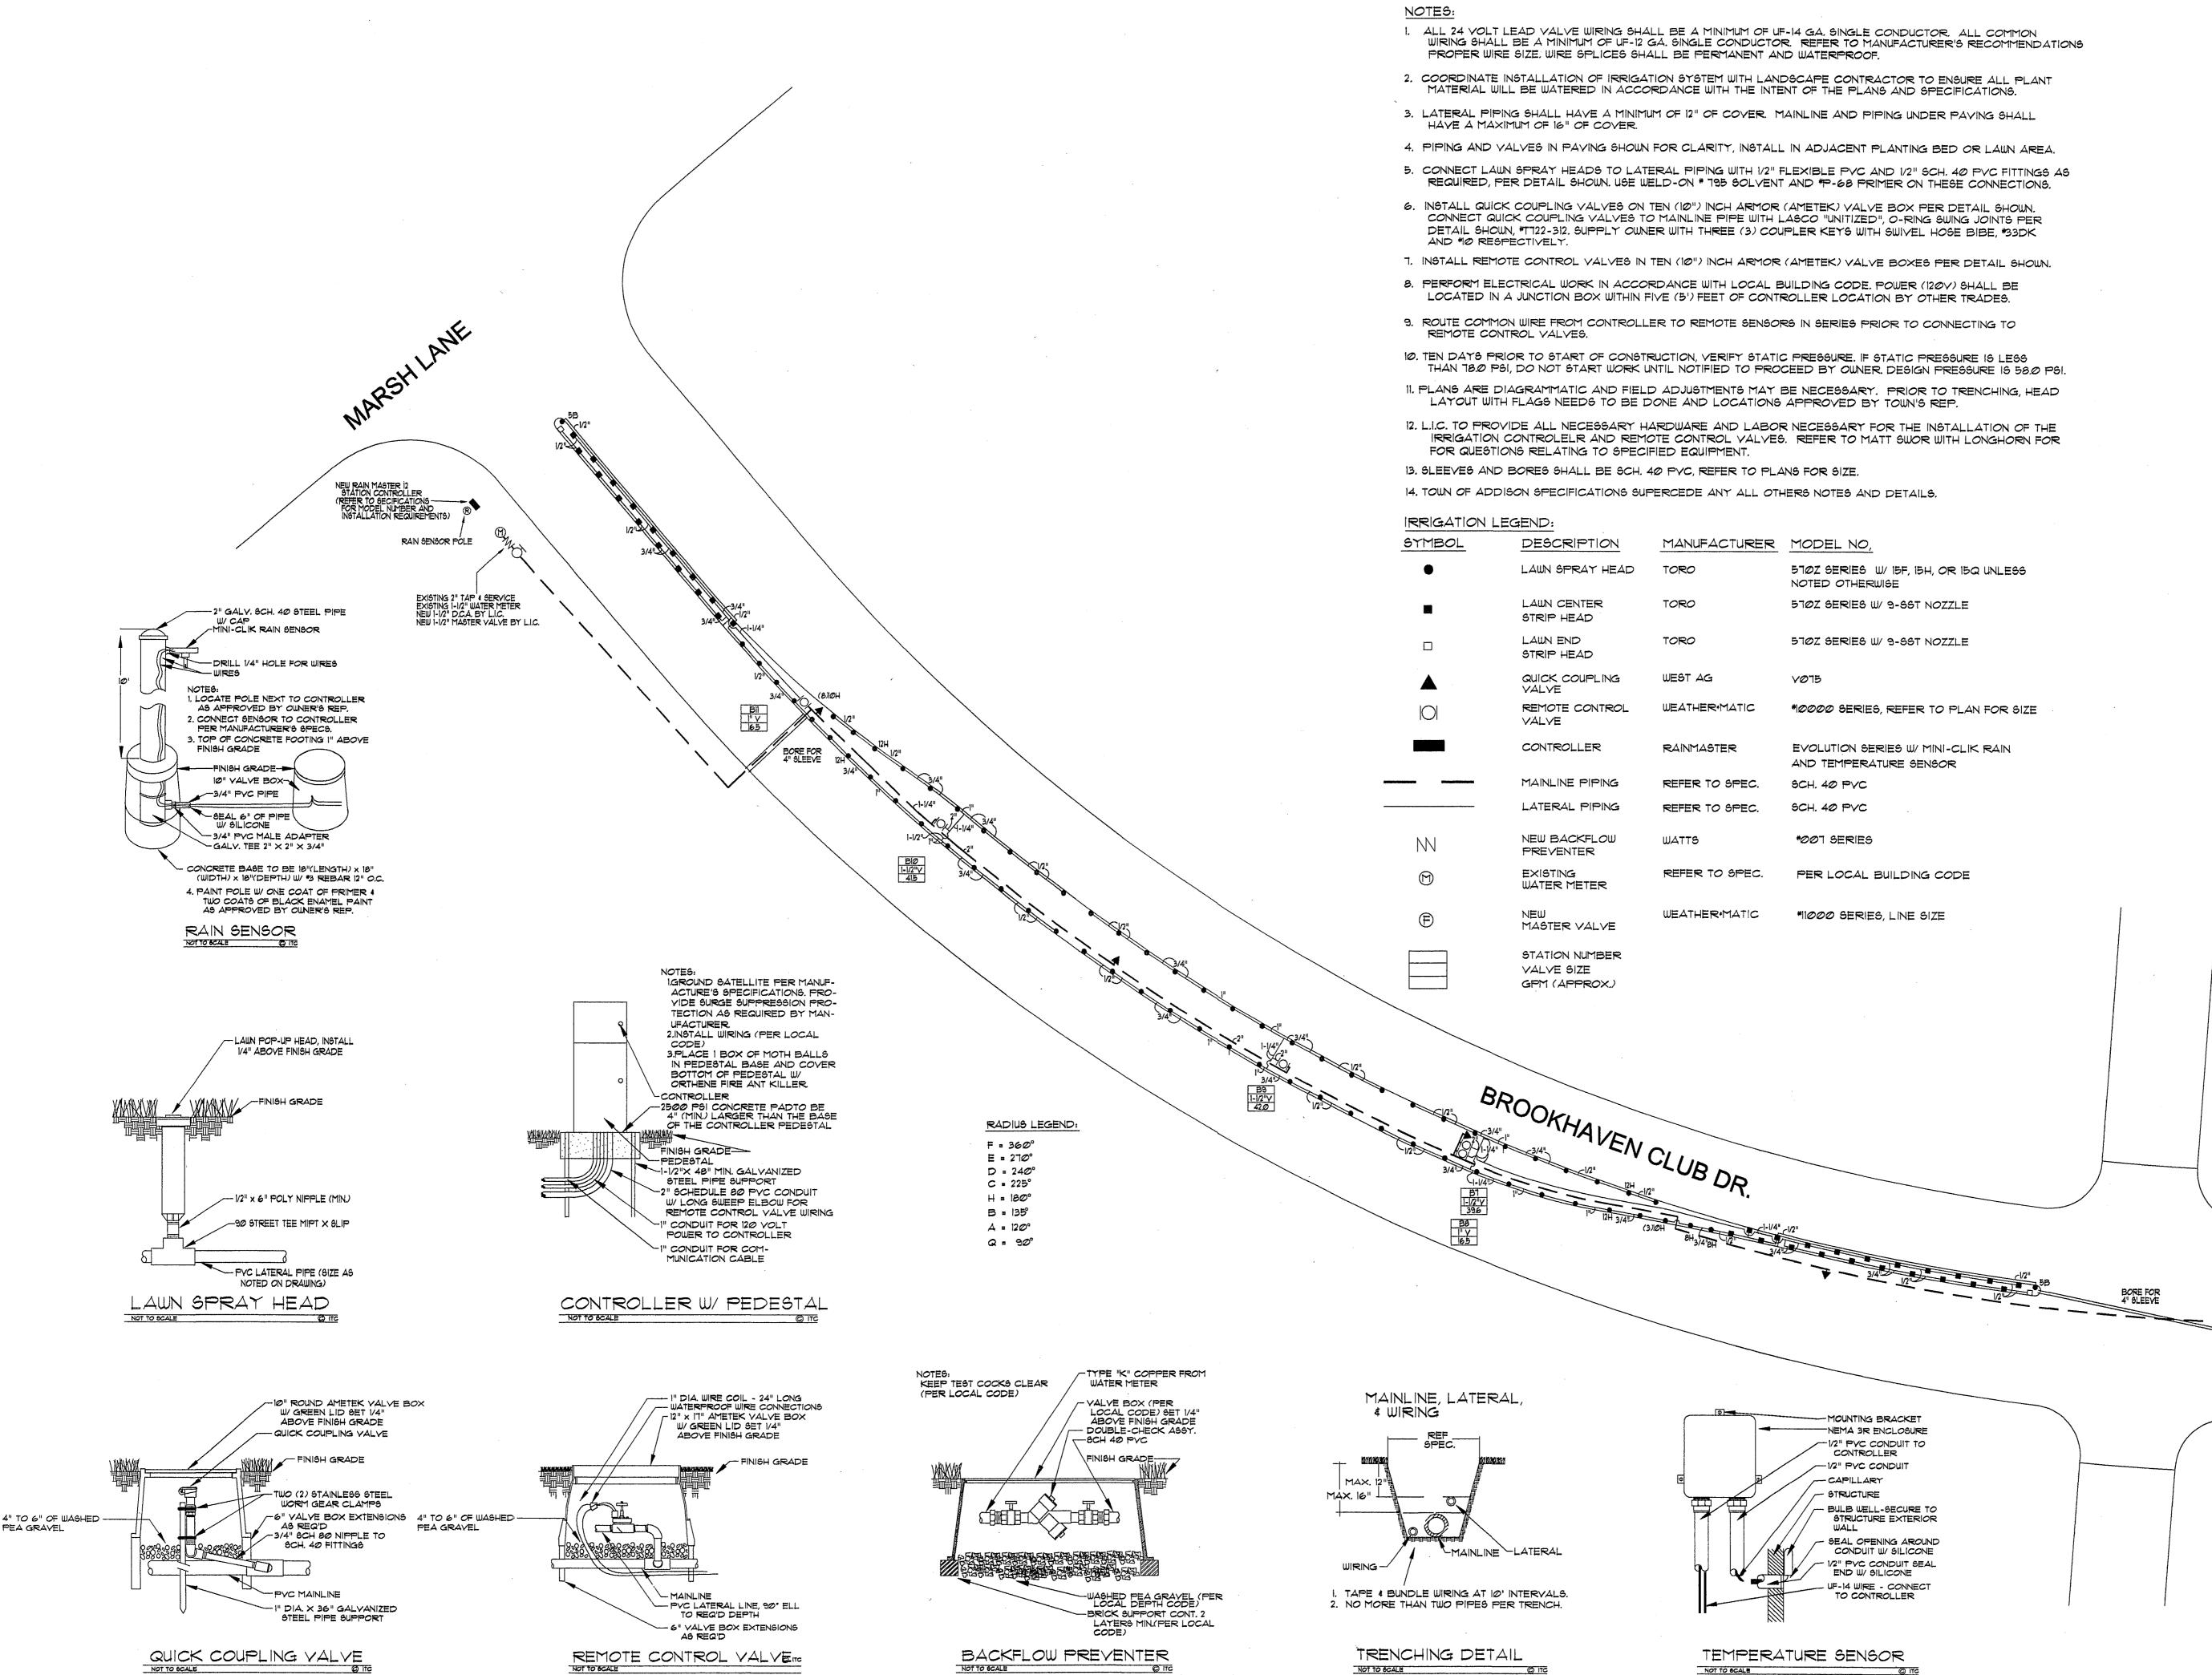

PEA GRAVEL