



- NOTES: 1. FOR STRUCTURAL NOTES & DETAILS, SEE SHEET 34 OF 44.  
 2. WALL REINFORCING STEEL NOT SHOWN FOR CLARITY!  
 3. ALL OPENINGS TO HAVE EXTRA REINF. STEEL AS SHOWN IN DETAIL 3 ON SHEET 34 OF 44.  
 4. STEEL REINF. LAP LENGTHS AS SHOWN IN DETAIL 1 ON SHEET 34 OF 44.  
 5. ALL HOOKS SHOWN TO BE STANDARD A.C.I. HOOKS  
 6. 1" EXPANSION JOINT ACROSS ROOF SLAB & VERTICAL WALLS AT LOCATIONS SHOWN ON PLANS.  
 7. OPENINGS ARE NOT SHOWN FOR CLARITY SEE SHEET 26 OF 44 FOR ROOF CURB PENETRATION LOCATIONS.

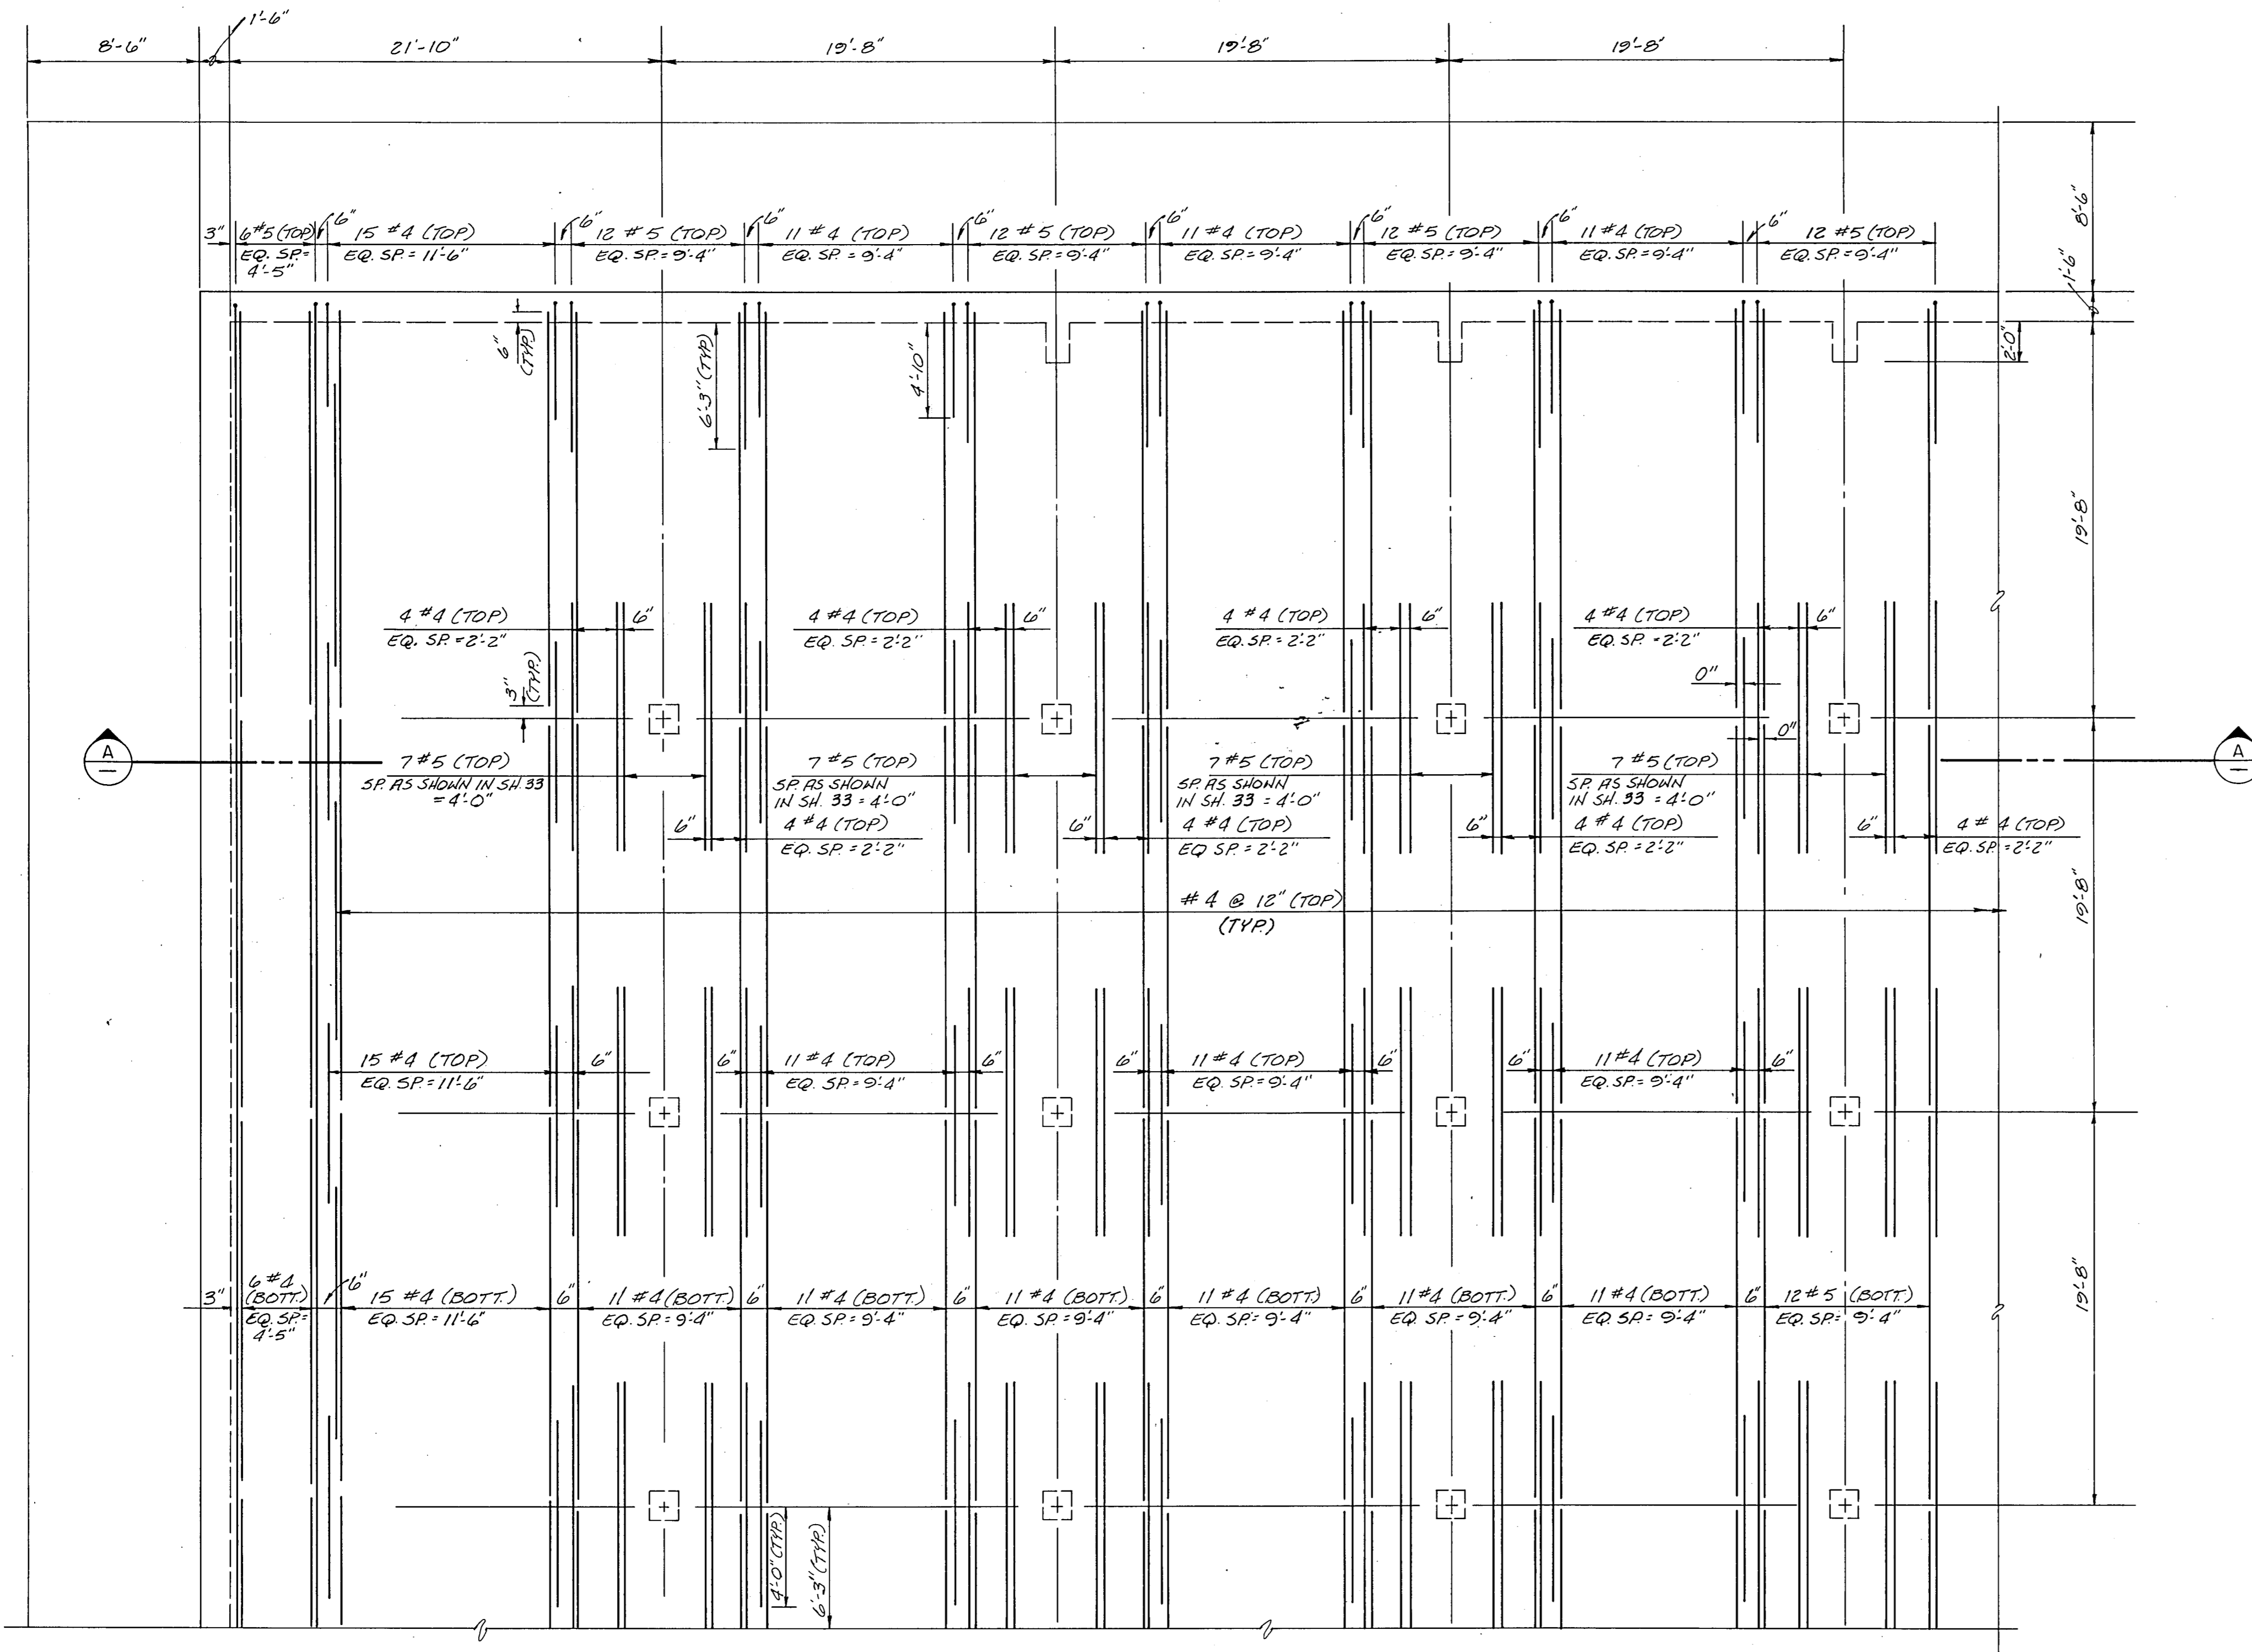


**ROOF PLAN**  
**NORTHWEST CORNER**  
 SCALE: 3/16" = 1'-0"

⊙ EAST/WEST REINFORCING STEEL NOT SHOWN FOR CLARITY REINFORCEMENT STEEL SIZE AND SPACING IS SIMILAR TO THAT SHOWN IN THE NORTH/SOUTH DIRECTION.

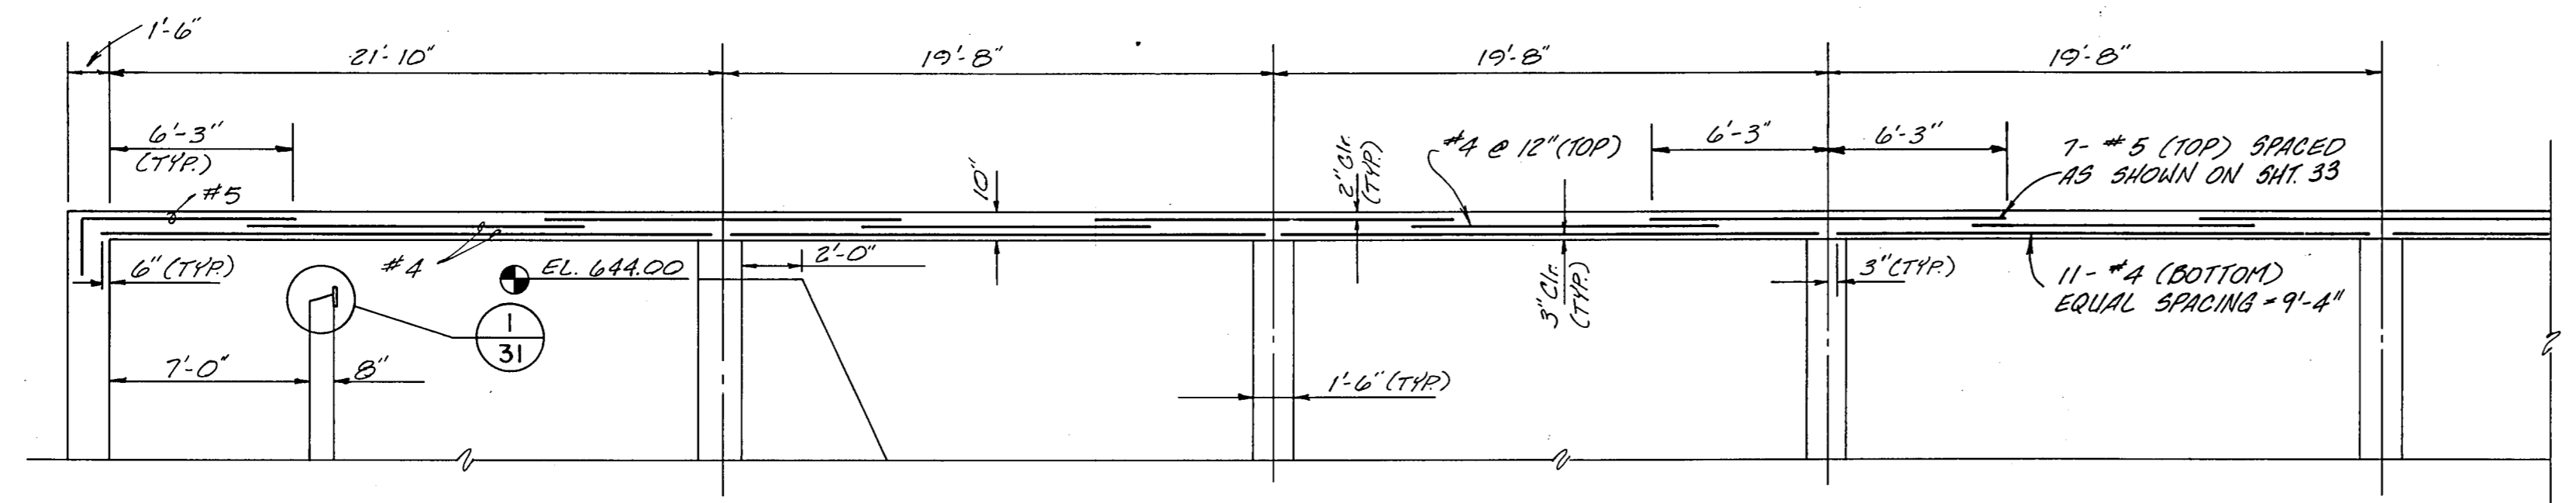

**SECTION**  
 SCALE: 3/16" = 1'-0"

⊙ NORTH/SOUTH REINFORCEMENT STEEL NOT SHOWN FOR CLARITY. SEE PLAN VIEW FOR SPACING REQUIREMENTS.

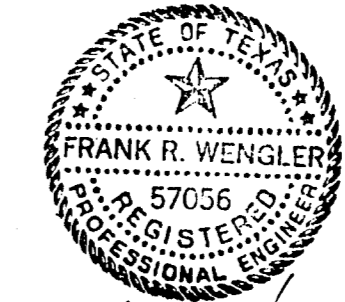

FLW  
 4/8/89

NO.	DATE	REVISION	APPROVED
BELTWOOD RESERVOIR EXPANSION RESERVOIR ROOF DETAILS			
DALLAS WATER UTILITIES CITY OF DALLAS, TEXAS TurnerCollie & Braden Inc.			
DESIGN	F.R.W.	CONTRACT NO.	89-79
DRAWN	C.A.	FILE NO.	630 Q 700 F
TRACED			
CHECKED	5/89		
DATE			
			SHEET NO. 32 OF 44