#### DRAINAGE PRODUCTS/SPECIALTIES

UNLESS OTHERWISE INDICATED NUMBERS ARE JAY R. SMITH. EQUAL PRODUCTS: ZURN, JOSAM, WADE AND WATTS.

CO-EXPOSED CLEANOUT - UNFINISHED AREAS JAY R. SMITH FIG. 4420 CAST BRONZE COUNTERSUNK PLUG WITH SLOT TO RECEIVE 1/2" THICK STEEL BAR STOCK.

WCO-WALL CLEANOUT - FINISHED AREAS

JAY R. SMITH FIG. 4436 C.I. FERRULE FOR NO HUB OR SERVICE WEIGHT PIPE, NICKEL BRONZE ROUND FRAME AND COVER WITH SECURING SCREWS.

JAY R. SMITH FIG. 4220 C.I. CLEANOUT WITH GASKET SEAL THREADED PLUG FOR EASY REMOVAL, ADJUSTABLE ROUND CAST IRON TOP WITH SECURING SCREW, SPEEDI-SET OUTLET CONNECTION.

JAY R. SMITH FIG. 4151 C.I. CLEANOUT WITH GASKET SEAL THREADED PLUG FOR EASY REMOVAL, ADJUSTABLE ROUND NICKEL BRONZE TOP RECESSED FOR TILE WITH SECURING SCREW, SPEEDI-SET OUTLET CONNECTION.

FCO-CARPETED FLOORS

JAY R. SMITH FIG. 4020-Y C.I. CLEANOUT WITH GASKET SEAL THREADED PLUG, ADJUSTABLE ROUND NICKEL BRONZE TOP COMPLETE WITH STAINLESS STEEL CARPET MARKER WITH SECURING SCREW, SPEEDI-SET OUTLET CONNECTION.

FD "DD" - DECK DRAIN

JAY R. SMITH FIG. 1412-HP,C.I. FLOOR DRAIN WITH 13" SQUARE HEEL PROOF GRATE, D.I. UNDERGRATE WITH NICKEL BRONZE STRAINER.

FD "G" - FLOOR DRAINS-GENERAL/RESTROOMS

JAY R. SMITH FIG. 2005-B6 SERIES C.I. FLOOR DRAIN WITH 6" DIAMETER SQUARE NICKEL BRONZE STRAINER, SPEEDI-SET OUTLET CONNECTION AND TRAP PRIMER CONNECTION.

FD "M" -FLOOR DRAINS-GENERAL PURPOSE/MECHANICAL ROOM JAY R. SMITH FIG. 3715 SERIES CAST IRON 12" DIAMETER DRAIN WITH SEDIMENT BUCKET,

CAST IRON GRATE WITH INTEGRAL 4" FUNNEL, SPEEDI-SET OUTLET CONNECTION. FD "PD" - PARKING DECK DRAIN

JAY R. SMITH FIG. 2142-M,C.I. FLOOR DRAIN WITH 11 1/2" DUCTILE IRON GRATE SEDIMENT

FD "TD" - TRENCH DRAINS AT PARKING DECK, ZURN FLOW-THRU SYSTEM. Z-812 SERIES, 12" WIDE, 4" OUTLETS, Z-812-HPD

LAVATORY-WALL HUNG SUPPORT

DUCTILE IRON HEEL PROOF GRATE

JAY R. SMITH #700 FOR MASONRY WALLS AND #700-M31 FOR METAL STUD WALLS.

ELECTRIC WATER COOLER CARRIER-WALL HUNG

JAY R. SMITH FIG. 830 SUPPORT WITH UPRIGHTS OF HIGH STRENGTH STEEL WITH WELDED BASES BOLTED TO FLOOR. FOR STEEL STUD WALLS, USE M31 RECTANGULAR UPRIGHTS.

TP-"A"-AUTOMATIC TRAP PRIMER PPP PRIME-RITE SERIES AUTOMATIC TRAP PRIMER WITH MULTIPLE OUTLET DISTRIBUTION UNITS AS REQUIRED.

JAY R. SMITH FIG. 2698 WATER SAVER TRAP PRIMER WITH 1-1/4" INLET AND OUTLET, 17

GAUGE SATIN CHROME-PLATED P-TRAP.

JAY R. SMITH 5000 SERIES ALL STAINLESS STEEL "HYDROTROLS". INSTALL IN AN UPRIGHT POSITION AT ALL FLUSH VALVES, WASHING MACHINE SUPPLIES, DISHWASHERS, PRV STATIONS, AND OTHER QUICK CLOSING VALVES, SOLENOIDS AND PLUMBING FIXTURES. LOCATE AND SIZE AS INDICATED ON DRAWINGS. WHERE NOT SHOWN ON DRAWINGS, LOCATE AND SIZE IN ACCORDANCE WITH PDI STANDARD WH-201.

WOODFORD #24P WITH LOOSE TEE KEY AND VACUUM BREAKER HOSE BIBB, CHROME PLATED FOR USE IN PUBLIC AREAS.

NFWH-WALL HYDRANT-EXPOSED

JAY R. SMITH FIG. 5509-QT NON FREEZE 3/4" CAST BRONZE HYDRANT WITH RECESSED STAINLESS STEEL BOX AND FRAME INTEGRAL VACUUM BREAKER, NICKEL BRONZE FACE, AND SIZED IN ACCORDANCE WITH WALL THICKNESS.

WASHING MACHINE UTILITY CONNECTION

GUY GRAY MODEL B200 16 GAUGE UTILITY CONNECTION WITH 1/2" ANGLE VALVES

ICE MAKER SUPPLY

DOWNSPOUT NOZZLE:

GUY GRAY MODEL BIM875 16 GAUGE SUPPLY WITH 1/2" INLET, AND 1/4" OUTLET ANGLE VALVE

JAY R. SMITH FIG. 1770, WALL MOUNTED CAST BRONZE BODY AND FLANGE, NICKEL BRONZE FINISH

SYMBOL	ABBREVIATION	DESCRIPTION
	A/C	ABOVE CEILING
	AD	AREA DRAIN
	A/F	ABOVE FLOOR
	AFF	ABOVE FINISHED FLOOR
	AFG	ABOVE FINISHED GRADE
	AP	ACCESS PANEL
⊗		BALANCING VALVE
	B/C	BELOW COUNTER
	B/F	BELOW FLOOR
	B/G	BELOW GRADE
—— CA ——	CA	COMPRESSED AIR
—	CD	CONDENSATE DRAIN
	CV	CHECK VALVE
<u> </u>	CO	CLEANOUT
	CW	COLD WATER PIPING
cwv	CWV	COMBINATION WASTE & VENT
C	DN	PIPING TURNING DOWN
(O)	ERD	EMERGENCY ROOF DRAIN
ERL	ERL	EMERGENCY RAIN LEADER
LIVE	FAV	FRESH AIR VENT (SAFE WASTE SYSTEM)
<u> </u>	FCO	FLOOR CLEANOUT
   C	FD	FLOOR DRAIN
	FS	FLOOR SINK
——G——	G	GAS PIPING — LOW PRESSURE
GW	GW	GREASE WASTE PIPING
——⋈——	GV	GATE/BALL VALVE
	HB/NFHB	HOSE BIBB/NON-FREEZE HOSE BIBB
1	HC	HANDICAPPED
<u> </u>	HD	HUB DRAIN
	HW	HOT WATER PIPING
	HWR	HOT WATER RETURN PIPING
——HZ——	HZ	HIGH ZONE (BOOSTED) COLD WATER
LZ	LZ	LOW ZONE COLD WATER (STREET PRESSURE)
MG	MG	GAS PIPING — MEDIUM PRESSURE
	0/H	OVER HEAD
PD	PD	PUMPED DISCHARGE
∞ <del></del>		P-TRAP
	PRV	PRESSURE REDUCING VALVE
<u></u>	RD	ROOF DRAIN
-MVM-	RPBP	REDUCED PRESSURE BACKFLOW PREVENTOR
—-S—	S,W	SOIL, WASTE PIPING (ABOVE GROUND)
	S,W	SOIL, WASTE PIPING (BELOW GROUND)
——————————————————————————————————————	SA	SHOCK ABSORBER (WATER HAMMER ARRESTOR)
ST	ST	STORM DRAINAGE PIPING
J1 —	TP	TRAP PRIMER
	IF	UNION
→——	UP	PIPING TURNING UP
	V	VENT PIPING
	VTR	VENT THRU ROOF
	1 VIIV	I VENT THING NOOF

WH/NFWH

YCO

WALL HYDRANT/NON-FREEZE WALL HYDRANT

YARD CLEANOUT

## PLUMBING NOTES

- REFER TO ARCHITECTURAL DRAWINGS FOR EXACT LOCATIONS AND ELEVATIONS OF ALL PLUMBING FIXTURES.
- ALL PLUMBING WORK SHALL BE INSTALLED IN ACCORDANCE WITH THE 2006 INTERNATIONAL PLUMBING CODE WITH ADDISION, TEXAS AMENDMENTS AND ALL APPLICABLE LOCAL CODES AND ORDINANCES.
- ALL PIPING ABOVE GRADE SHALL BE PROPERLY SUPPORTED FROM THE BUILDING STRUCTURE AND SHALL NOT REST ON CEILING TILES OR BE SUPPORTED FROM CEILING TILES.
- WATER PIPING ROUTED ABOVE CEILING AND IN EXTERIOR WALLS SHALL BE ROUTED ON HEATED SIDE (UNDERSIDE) OF CEILING INSULATION AND HEATED SIDE (INSIDE) OF WALL INSULATION.
- SANITARY AND DRAINAGE PIPING 2" AND SMALLER SHALL BE SLOPED AT 1/4" PER FOOT
- MINIMUM, PIPING 3" AND LARGER SHALL BE SLOPED AT 1/8" PER FOOT MINIMUM.
- TOPS OF ALL FLOOR DRAINS AND CLEANOUTS SHALL BE SET FLUSH WITH FINISHED FLOOR. TRAP PRIMERS ARE TO BE PROVIDED ON ALL FLOOR DRAINS AND HUB DRAINS WHICH DO NOT RECEIVE A CONTINUOUS DISCHARGE. TP "L" LAVATORY WASTE TRAP PRIMERS ARE TO BE PROVIDED ON DRAINS IN PUBLIC RESTROOMS, GUEST ROOMS, AND OTHER AREAS WITH DRAINS ADJACENT TO LAVATORIES TP "A" AUTOMATIC TRAP PRIMERS ARE TO BE PROVIDED IN ALL OTHER REQUIRED LOCATIONS.
- PLUMBING AND FIRE PROTECTION PIPING IS NOT TO BE INSTALLED IN ELECTRICAL ROOMS, CLOSETS, TELEPHONE ROOMS, OR ELEVATOR EQUIPMENT ROOMS EXCEPT PIPING SERVING THAT SPECIFIC ROOM.
- LOCATE ALL SECTIONAL OR MAIN CONTROL VALVES WITHIN 1'-0" FROM ACCESS PANELS, CEILING TILES, OR OTHER POINT OF ACCESS.
- 10. ALL COLD WATER, HOT WATER AND DRAIN PIPING AT HANDICAPPED FIXTURES SHALL BE INSULATED WITH HANDI-LAV GUARD MODELS 102 AND 105 INSULATION KITS.
- PROVIDE SHOCK ABSORBERS SIZED PER PDI SPECIFICATIONS ON ALL DOMESTIC WATER LINES SERVING FLUSH VALVE FIXTURES, WASHING MACHINES SUPPLIES, PRV STATIONS AND OTHER INSTALLATIONS WITH QUICK CLOSING VALVES.
- PROVIDE A BASE CLEANOUT AT THE LOWEST LEVEL OF ALL SANITARY AND WASTE STACKS. BASE CLEANOUTS ON SOVENT STACKS SHALL BE LOCATED CONCEALED BEHIND THE
- 13. ALL SHOWER HEAD ARMS AND VALVES SHALL BE PROVIDED WITH ADDITIONAL BLOCKING AS REQUIRED AND RIGIDLY SECURED TO ADJACENT STRUCTURE.
- 14. ALL SHOWER HEADS SHALL BE INSTALLED WITH THE CENTER POINT OF THE SHOWER HEAD FACE LOCATED 6'-3" MINIMUM ABOVE THE TUB/SHOWER FINISHED SURFACE.
- PROVIDE REDUCED PRESSURE BACKFLOW PREVENTORS AT ALL DOMESTIC WATER CONNECTIONS TO MECHANICAL EQUIPMENT, POOL AND IRRIGATION CONNECTIONS, KITCHEN, LAUNDRY, AND VENDING EQUIPMENT CONNECTIONS AS REQUIRED BY LOCAL CODE AND AUTHORITIES.
- PROVIDE MANUFACTURED EXPANSION DEVICE OR FABRICATED EXPANSION LOOP ON ALL PIPING SYSTEMS CROSSING BUILDING EXPANSION JOINTS.
- 17. CONTRACTOR SHALL COORDINATE ELECTRICAL CHARACTERISTICS AND REQUIREMENTS OF ALL PLUMBING EQUIPMENT WITH THE ELECTRICAL DRAWINGS AND THE ELECTRICAL CONTRACTOR, AND SHALL FURNISH EQUIPMENT WIRED FOR THE VOLTAGES SHOWN THEREIN.
- 18. ALL PLUMBING EQUIPMENT, PIPING, INSULATION, ETC. INSTALLED IN HVAC PLENUM SPACES SHALL MEET CODE REQUIREMENTS FOR SMOKE AND COMBUSTIBILITY.
- 19. ALL PLUMBING EQUIPMENT AND SYSTEMS SHALL BE GUARANTEED FOR A MINIMUM PERIOD OF ONE YEAR AFTER FINAL ACCEPTANCE.
- 20. ALL PIPE PENETRATIONS OF FIRE AND/OR SMOKE RATED ASSEMBLIES SHALL BE FIRE STOPPED AS REQUIRED TO RESTORE ASSEMBLY TO ORIGINAL INTEGRITY. FIRE BARRIER PRODUCTS SHALL BE AS MANUFACTURED BY 3M COMPANY, CP25 CAULK, CS195 COMPOSITE PANEL, FS195 WRAP/SRINK, OR PSS 7900 SERIES SYSTEMS AS RECOMMENDED BY MANUFACTURER FOR PARTICULAR APPLICATIONS, OR EQUIVALENT SYSTEM AS APPROVED BY LOCAL CODE OFFICIALS.
- 21. ALL VENT THRU ROOF PENETRATIONS SHALL BE ROUTED TO TERMINATE AT THE LEAST VISIBLE LOCATION FROM THE ENTRY VIEW.
- 22. ALL SANITARY VENTS THRU ROOF SHALL BE LOCATED A MINIMUM OF 10'-0" FROM ANY OUTSIDE AIR INTAKE.

			garangaran					
		WAT	ER HE	ATER S	SCHEDULE			***
CVALDOL	MANUTACTURED\	STORAGE	CDU		ELECTRICAL CRITERIA	GAS CRITERIA		NOTES
SYMBOL	MANUFACTURER\ MODEL NO.	STORAGE CAPACITY GALLONS	GPH REC. @ 90°F RISE	OUTLET TEMPERATURE	KW INPUT	BTU INPUT	FLUE SIZE	NOTES
EWH-1	STATE ES6 50 DOLS	50	21	120°F	6.0	N/A	N/A	1–5
EWH-1T	STATE ES6 52 DORT	50	21	120°F	6.0	N/A	N/A	1–5
EWH-2	STATE ES6 50 DOLS	50	27	120°F	6.0	N/A	N/A	1–5
EWH-2T	STATE ES6 52 DOLS	50	27	120°F	6.0	N/A	N/A	1–5
EWH-3	EEMAX EX48		32°F RISE @ 1.0 GPM	104°F	4.8	N/A	N/A	1–5

- 1. PROVIDE EXPANSION TANK SIZED PER THE WATER HEATER MANUFACTURER'S RECOMMENDATION OR EXPANSION VALVE AS ALLOWED BY
- LOCAL OFFICIALS. T&P RELIEF VALVE.
- PROVIDE HEAT TRAP FITTINGS ON HOT AND COLD WATER CONNECTIONS AND BALL VALVE ON COLD WATER SUPPLY TO HEATER.
- ALL UNITS SHALL MEET 2003 INTERNATIONAL ENERGY CONSERVATION CODE REQUIREMENTS. THE WATER HEATER MANUFACTURER SHALL PROVIDE HEATERS WITH INTEGRAL HEAT TRAPS ON THE COLD AND HOT WATER CONNECTIONS.
- ROUTE DRAIN PAN AND T&P RELIEF TO DRAIN/EXTERIOR, SEE WATER HEATER DETAIL. APPROVED ALTERNATES: A.O. SMITH, RHEEM, LOCHINVAR

				PU	MP	SC	HEDULI	£
SYMBOL	SERVICE\ LOCATION	TYPE	FLOW (GPM)	HEAD (FEET)	RPM	HP	NOTES	MANUFACTURER MODEL
	ELEVATOR SUMP PUMP	SUBMERSIBLE	50	43'	3450	1/2		MYERS MODEL ME50S SUBMERSIBLE PUMP WITH UNION, CHECK AND GATE VALVE ON DISCHARGE, MFS-20 MECHANICAL FLOAT SWITCH. (APPROX. 3'-0" SQUARE x 3'-0" DEEP SUMP PIT)

#### FIRE PROTECTION NOTES

- ALL SPRINKLERS IN SPACES VISIBLE TO PUBLIC VIEW SHALL BE LOCATED SYMMETRICALLY IN RELATION TO CEILING DESIGN ELEMENTS, LIGHTING FIXTURES, SPEAKERS, DIFFUSERS, ETC. ALL CEILING COMPONENTS ARE TO BE INDICATED ON THE SUBMITTAL DRAWINGS AS NOTED PREVIOUSLY TO INSURE COORDINATION WITH ALL CEILING ELEMENTS AND DEVICES. PIPING TO SPRINKLERS IN THESE AREAS IS TO BE PROVIDED WITH RETURN BENDS IF REQUIRED TO ALLOW FOR EXACT PLACEMENT.
- SPRINKLER HEADS INSTALLED IN LAY IN ACOUSTICAL TILE CEILINGS SHALL BE CENTERED IN THE CEILING TILES OR INSTALLED ON QUARTER POINTS OF THE FOUR FOOT DIMENSIONS OF 2' X 4' TILES.
- ALL FIRE PROTECTION WORK SHALL COMPLY WITH ALL APPLICABLE SECTIONS OF NFPA STANDARDS AND SHALL MEET THE APPROVAL OF THE OWNERS INSURANCE UNDERWRITER, AND LOCAL AUTHORITIES HAVING JURISDICTION.
- SHOP DRAWINGS SHALL BE SUBMITTED TO AND APPROVED BY THE ARCHITECT PRIOR TO ORDERING, PURCHASING, OR FABRICATION ANY FIRE PROTECTION EQUIPMENT. SHOP DRAWINGS SHALL INCLUDE: SPRINKLER DRAWINGS AND CALCULATIONS BEARING THE SEAL OF A REGISTERED PROFESSIONAL ENGINEER OR EQUIVALENT CONTRACTORS FIRE SPRINKLER CERTIFICATE SEAL AND APPROVAL STAMP OF LOCAL CODE AUTHORITY; SPRINKLER PIPING: SPRINKLER HEADS; HOSE RACKS, HYDRANTS AND VALVES; PUMPS, CONTROLLERS AND ACCESSORIES; TANKS AND ACCESSORIES. SHOP DRAWINGS SHALL BE SUBMITTED TO AND APPROVED BY THE OWNERS INSURANCE UNDERWRITER PRIOR TO BEING SUBMITTED TO THE ARCHITECT.
- CONTRACTOR SHALL COORDINATE THE ELECTRICAL CHARACTERISTICS AND REQUIREMENTS OF ALL FIRE PROTECTION EQUIPMENT WITH THE ELECTRICAL DRAWINGS AND SHALL FURNISH EQUIPMENT WIRED FOR THE VOLTAGES SHOWN THEREIN.
- 5. ALL FIRE PROTECTION EQUIPMENT AND SYSTEMS SHALL BE GUARANTEED FOR A PERIOD OF ONE YEAR AFTER FINAL ACCEPTANCE.
- ALL PIPING ABOVE GRADE SHALL BE SUPPORTED BY THE BUILDING STRUCTURE AND SHALL NOT REST ON CEILING TILES OR CEILING STRUCTURE. PIPING HUNG FROM JOISTS SHALL BE HUNG FROM THE TOP CHORDS OF THE JOISTS.
- ALL SPRINKLER SYSTEMS SHALL BE DESIGNED TO THE AVAILABLE CITY WATER SUPPLY. CONTRACTOR SHALL HAVE CURRENT FLOW TEST PERFORMED PRIOR TO DESIGN.
- ALL SPRINKLER SYSTEM RISERS SHALL INCLUDE AN ALARM CHECK VALVE, WATER MOTOR GONG, FLOW SWITCH, ETC.
- 10. HYDRAULIC CALCULATIONS SHALL INCLUDE AN ALLOWANCE FOR INSIDE AND OUTSIDE
- HOSE STREAMS. FIRE PROTECTION SUBCONTRACTOR SHALL FURNISH AND INSTALL 2A RATED 10 LB. FIRE EXTINGUISHERS FOR EVERY 3000 SQ. FT. OF FLOOR AREA. EXTINGUISHERS SHALL BE

LOCATED TO MINIMIZE TRAVEL DISTANCE TO 75 FEET.

SWITCHGEAR, PANELS, TRANSFORMERS, ETC.


INDICATED ON ARCHITECTURAL DRAWINGS.

- 12. ALL MAJOR VALVES SHALL HAVE U.L. LISTED SUPERVISORY SWITCHES COMPATIBLE WITH THE OWNERS CENTRAL ALARM SYSTEM. WIRING OF THE SWITCHES SHALL BE BY OTHERS.
- 13. GROOVED (VICTAULIC) COUPLINGS SHALL NOT BE USED OVER OR NEAR ELECTRICAL
- 14. ALL SPRINKLER PIPING SHALL BE ROUTED TO MAINTAIN MINIMUM CLEAR HEIGHTS
- 15. ALL DRY PIPE SPRINKLER SYSTEMS (ATTICS AND GARAGES) SHALL BE COMPLETE WITH OS&Y GATE VALVES AND DRY PIPE VALVES, AIR COMPRESSORS, WATER MOTOR GONGS, ACCESSORIES AND PRESSURE SWITCHES COMPATIBLE WITH THE OWNERS CENTRAL ALARM SYSTEM. WIRING OF THE SWITCHES WILL BE BY OTHERS.
- 16. ALL PIPING ON THE SYSTEM SIDES OF DRY PIPE OR PREACTION VALVES SHALL BE GALVANIZED CLASS 150 AND 300 MALLEABLE IRON THREADED FITTINGS, ANSI B16.1.

	PLUMBING	FIXTURE &	CONNECTI	ON S	CHEDU	LE	
FIXTURE #	DESCRIPTION	FIXTURE MFG.		WASTE	HOT WATER SUPPLY	COLD WATER SUPPLY	NOTES
WC-1	WATER CLOSET-PRIVATE	REFER TO INTERIORS PACKAGE		3"		1/2"	3, 4
WC-1H	WATER CLOSET-PRIVATE-HC	REFER TO INTERIORS PACKAGE		3"		1/2"	3, 4, 6
WC-2	WATER CLOSET-PUBLIC	REFER TO INTERIORS PACKAGE		3"		1/2"	3, 4
WC-2H	WATER CLOSET-PUBLIC-HC	REFER TO INTERIORS PACKAGE		3"		1/2"	3, 4, 6
L-1	COUNTERTOP LAVATORY	REFER TO INTERIORS PACKAGE		1 1/4"	1/2"	1/2"	2, 3, 4
L-1	COUNTERTOP LAVATORY-HC	REFER TO INTERIORS PACKAGE		1 1/4"	1/2"	1/2"	2, 3, 4
L-2	COUNTERTOP LAVATORY—HC PUBLIC	REFER TO INTERIORS PACKAGE		1 1/4"	1/2"	1/2"	2, 3, 4
UR-1	URINAL-HC	REFER TO INTERIORS PACKAGE		2"		3/4"	
BT-1	GARDEN TUB/SHOWER	REFER TO INTERIORS PACKAGE		1 1/2"	1/2"	1/2"	1,8
BT-2H	STANDARD TUB/SHOWER - HC	REFER TO INTERIORS PACKAGE		1 1/2"	1/2"	1/2"	1,8
SH-1	SHOWER	REFER TO INTERIORS PACKAGE					8
SH-2	SHOWER	REFER TO INTERIORS PACKAGE					8
KS−1	KITCHEN SINK W/DISPOSAL	REFER TO INTERIORS  PAGKAGE	~~~~	1 1/2"	1/2"	1/2"	3, 4, 5,
S-1	LEASING SINK	REFER TO INTERIORS PACKAGE		1 1/2"	1/2"	1/2"	3, 4, 5,
5-2^	CLUBHOOSE\SIMK\\\	REFER TO UNITERIORS PACKAGE	~~~~~	11/2"	1/2"	1/2	3,4,5,
EWC-1	BI-LEVEL ELEC. WATER COOLER-HC	REFER TO INTERIORS PACKAGE		1 1/4"		1/2"	2, 3, 4
WM-1	WASHER BOX	REFER TO INTERIORS PACKAGE					
IM-1	ICE MAKER SUPPLY	REFER TO INTERIORS PACKAGE	and the second s	2"	1/2"	1/2"	
MS-1	MAINTENANCE SINK	REFER TO INTERIORS PACKAGE		1 1/2"	1/2"	1/2"	3,4,5

- . PROVIDE OATEY MODEL 46100 TUB DRAIN. 2. PROVIDE  $1-1/4" \times 1-1/2"$  PVC TRAP WITH UNION.
- 3. PROVIDE OATÉY 3/8" CLADFLEX RISERS. 4. PROVIDE BRASS CRAFT CHROME PLATED 1/2" x 3/8" COMPRESSION STOPS.
- 5. PROVIDE 1-1/2" x 1-1/2" PVC TRAP WITH UNION.
- B. FLUSH LEVER'SHALL BE LOCATED ON THE APPROACH SIDE OF THE TANK AT ACCESSIBLE INSTALLATIONS. 7. PROVIDE 3-1/2" DRAIN ASSEMBLY WITH STAINLESS BASKET STRAINER AND WASTE PIPING FOR CONNECTION AT DISPOSAL.
- 8. PROVIDE 1/2" COPPER RISER FROM SHOWER/TUB VALVE TO SHOWER HEAD.

lordan & Skala Engineers Dallas, IX 75244-5138 Texas Firm Registration #F-499 Project Number - 113-0355 Checked By: RC Drawn By: CV

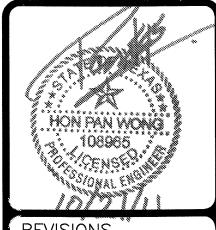

REVISIONS

1\ 9-2-2011 REVISIONS /2\ 9-13-2011 ANSI/FHA COMMENT <sup>′</sup>3∖ 9−23−2011

10-17-2011 CONSTRUCTION

architects


4144 N. Central Expy. Suite 855 Dallas, TX 75204 214.520.8878 bgoarchitects.com


DATE 08 - 05 - 100

PROJECT

SHEET NUMBER

P-0.1

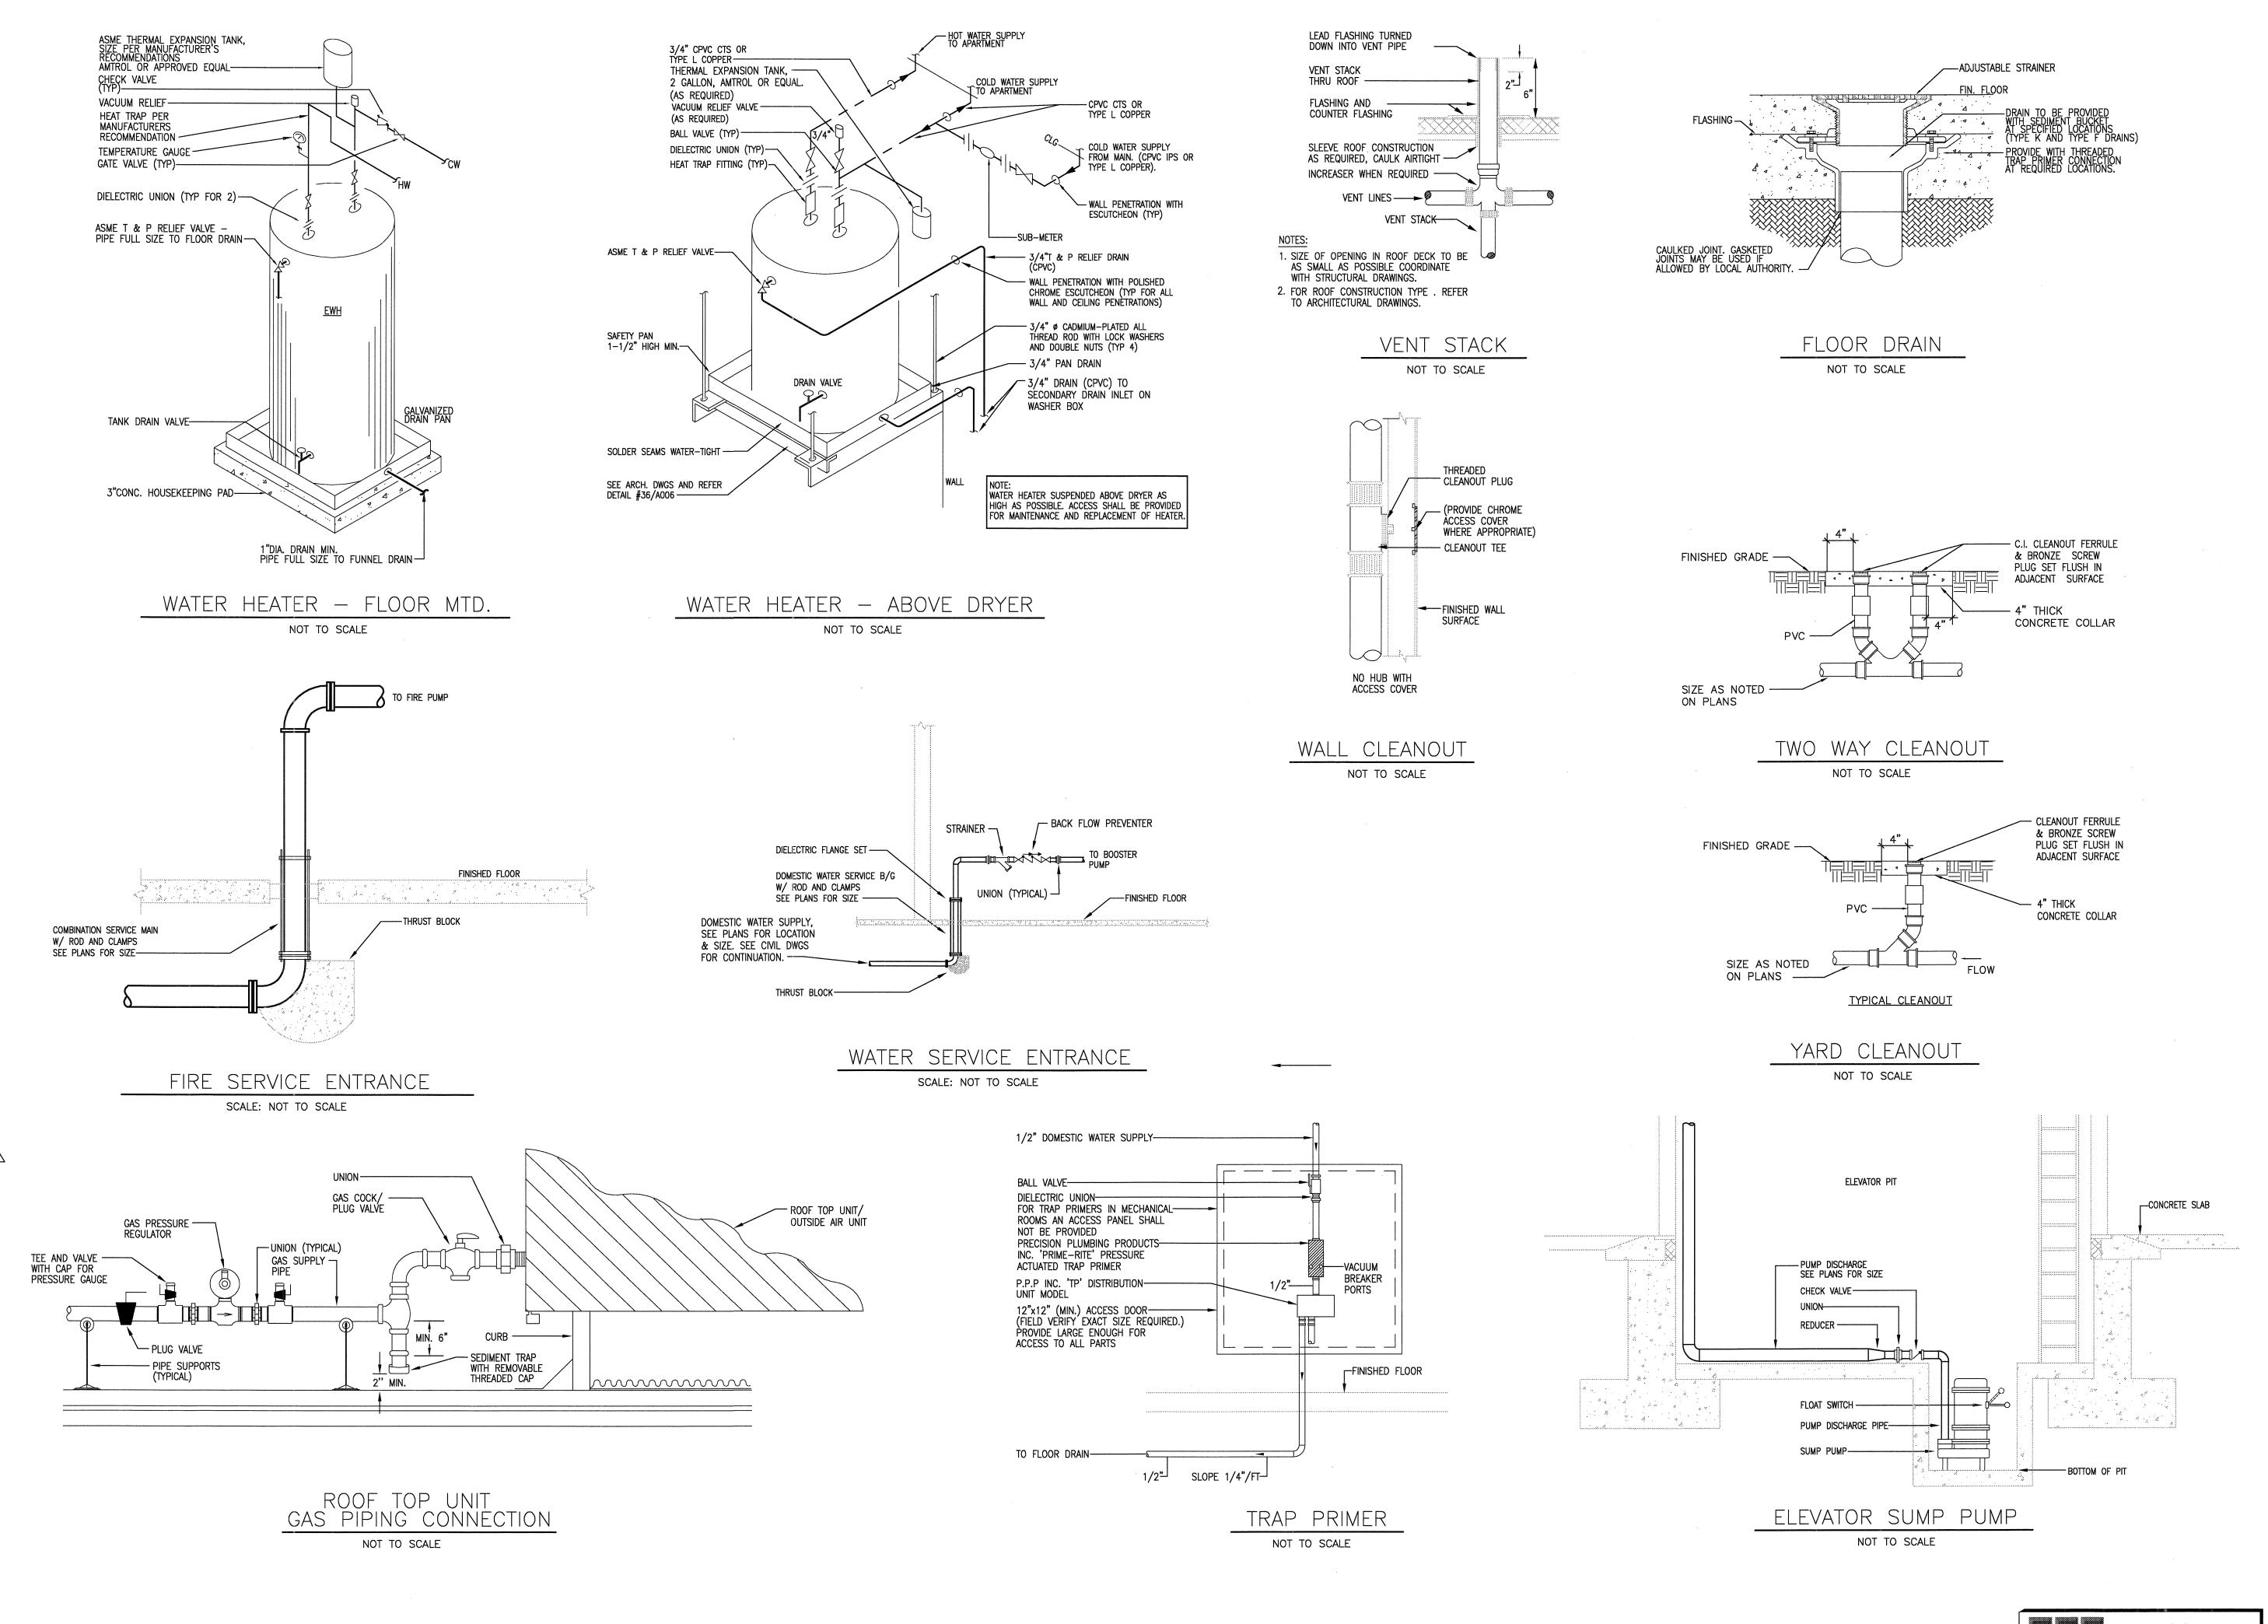

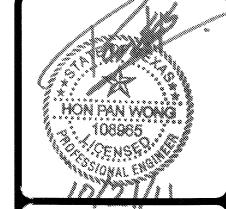

REVISIÕNS

1 9-2-2011 DESIGN REVISIONS

/2\ 9-13-2011 ANSI/FHA COMMENTS 1/3\ 9-23-2011 DESIGN 10-17-2011 CONSTRUCTIO

ADDI လ

BGO architects 4144 N. Central Expy. Suite 855 Dallas, TX 75204 214.520.8878


bgoarchitects.com DATE 08 - 05 - 1


PROJECT

SHEET NUMBER

P-0.2

Jordan & Skala Engineers V: (469) 385-1616 E: (469) 385-1615 Texas Firm Registration #F-499 Checked By: RC Drawn By: CV

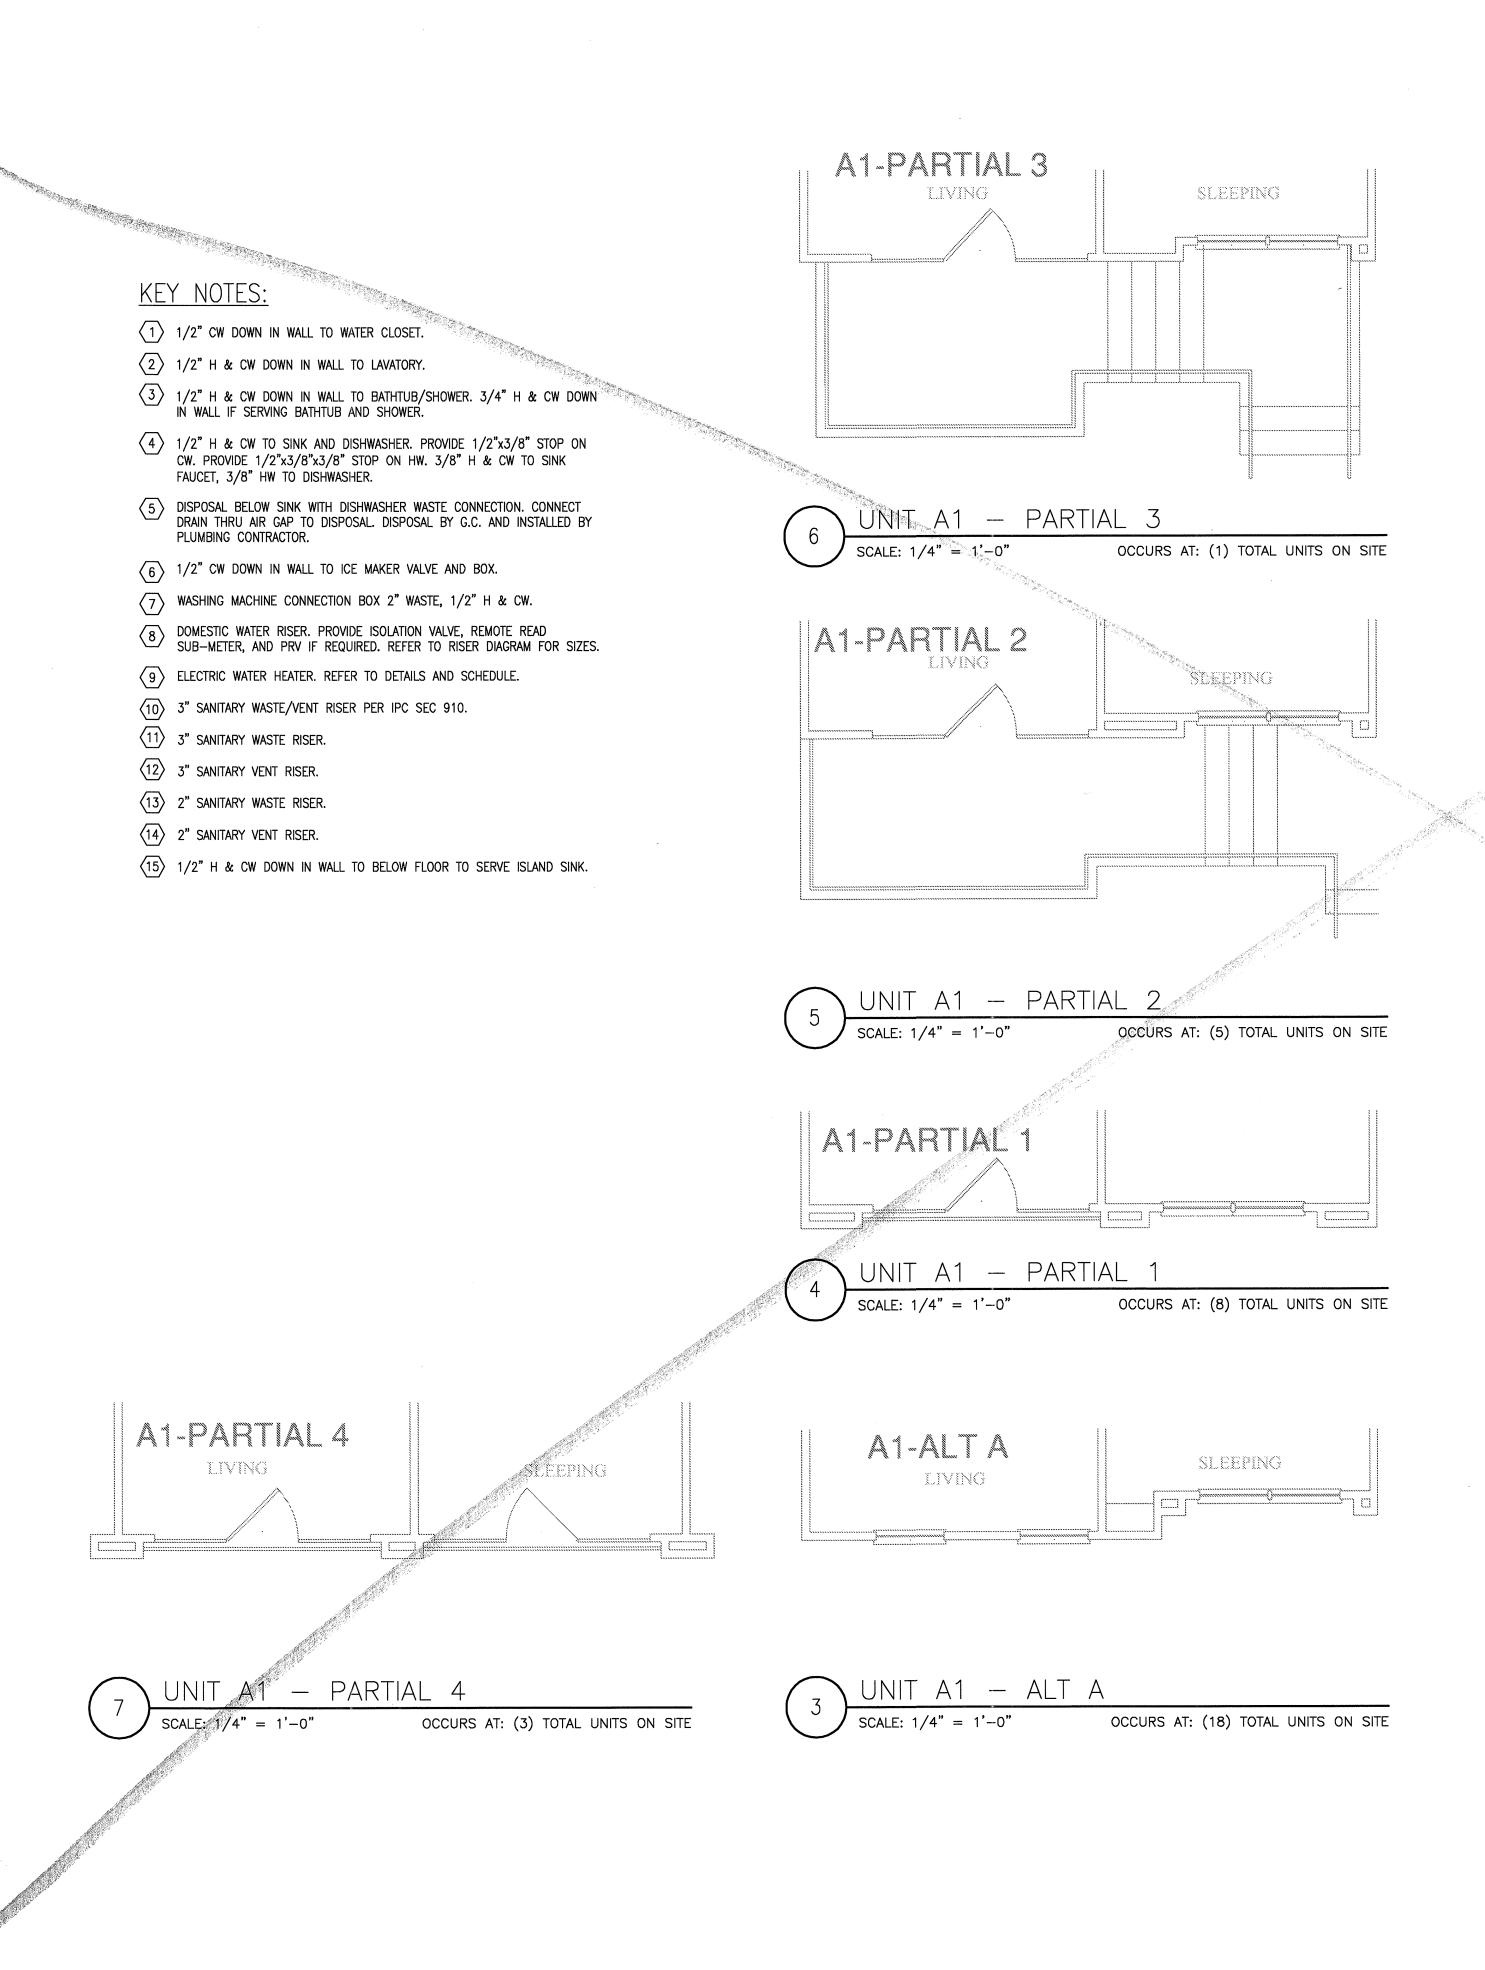

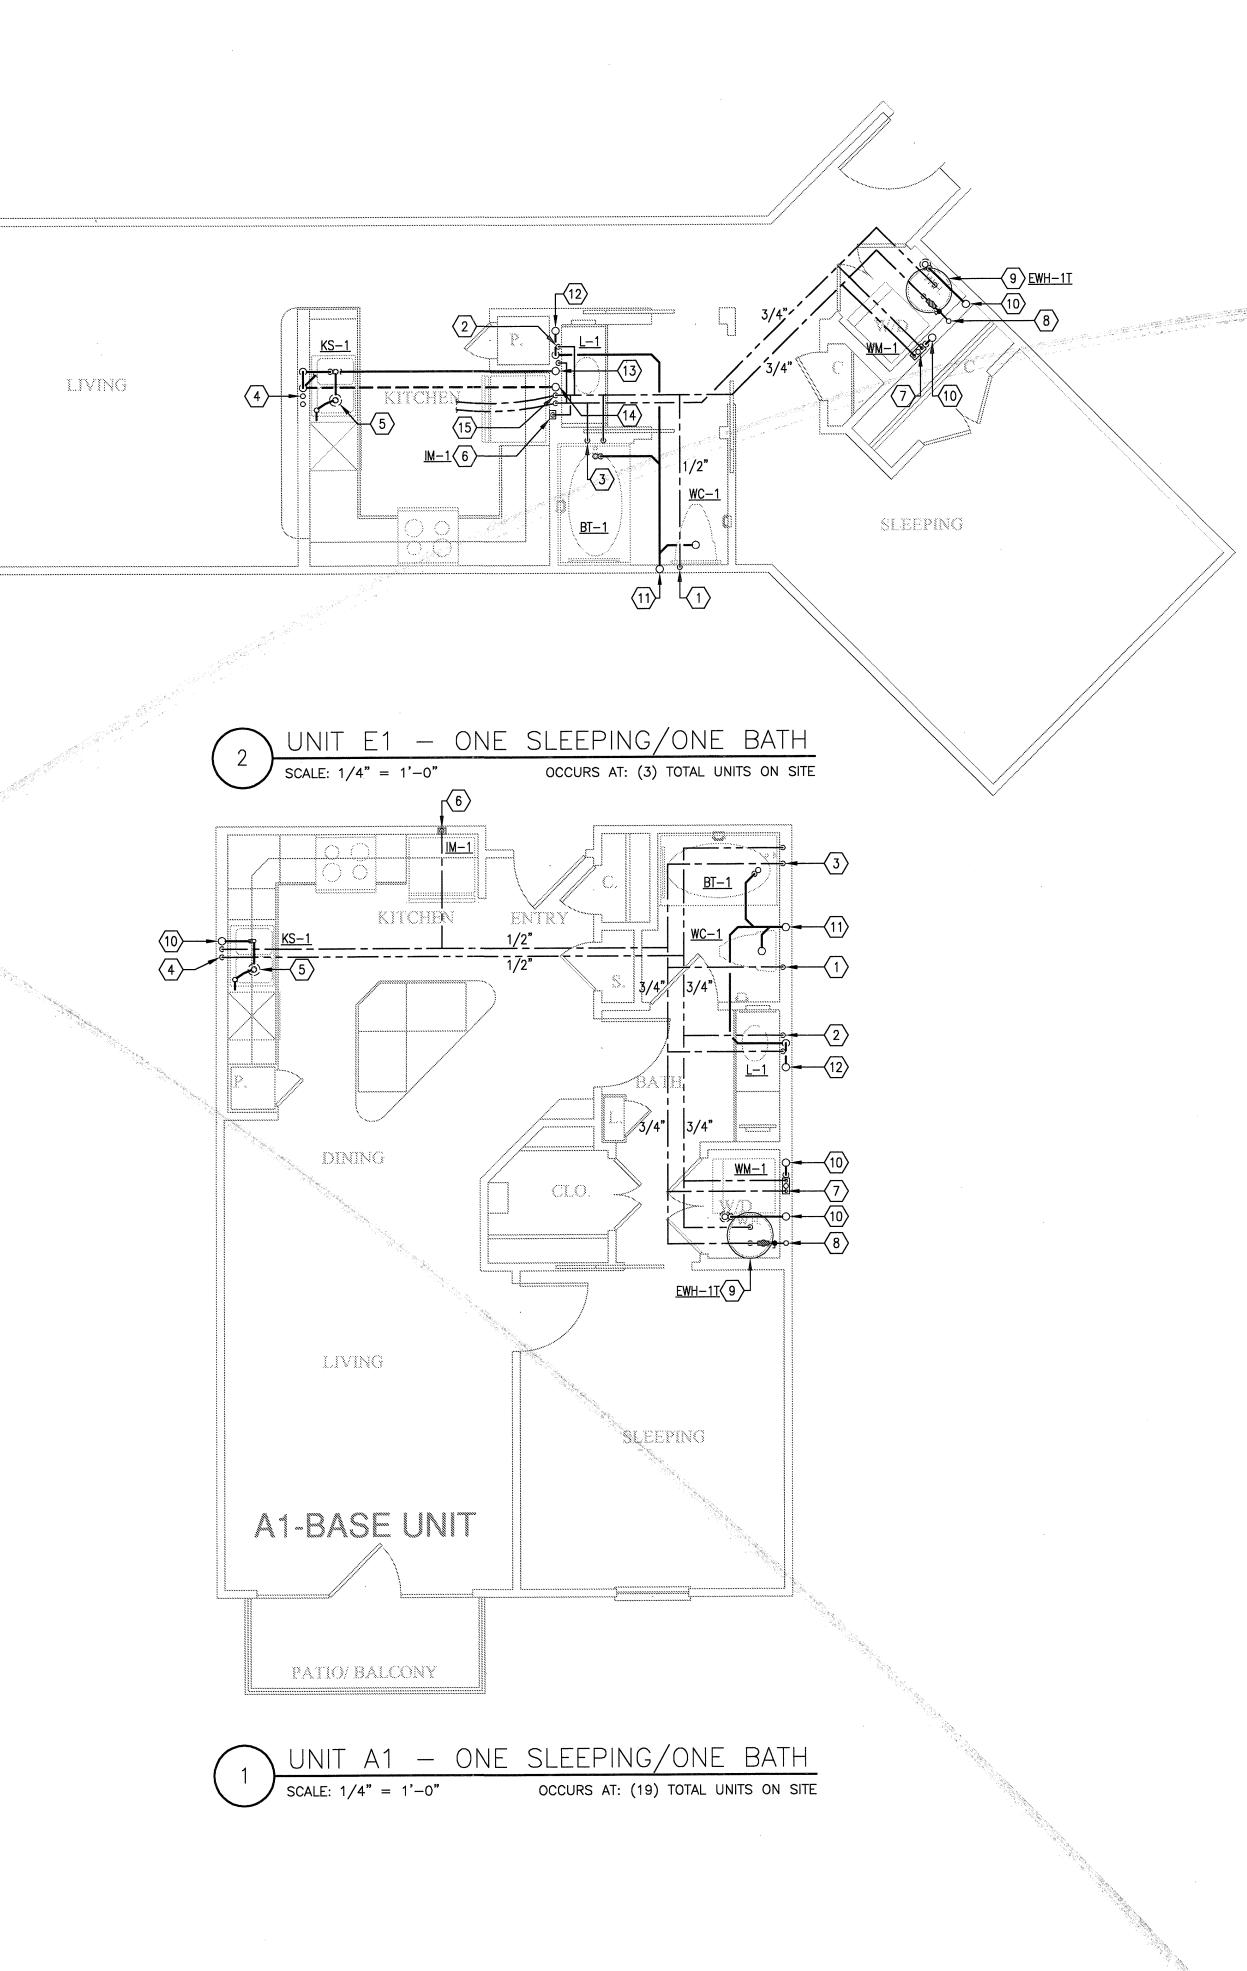

REVISIÔNS

9-2-2011 DESIGN REVISIONS 2 9-13-2011 ANSI/FHA COMMENTS  $\sqrt{3}$  9-23-2011 DESIGN REVISIONS 10-17-2011 CONSTRUCTION ISSUE

BGO architects

4144 N. Central Expy. Suite 855 Dallas, TX 75204 214.520.8878 bgoarchitects.com

08-05-1

PROJECT

11129

P-2.1


SHEET NUMBER

Jordan & Skala Engin<mark>e</mark>ers 14240 Midway Road, Suite 350 Dallas, 3X 75244-5138 A (469) 385-1616 E: (469) 385-1615 Texas Firm Registration # F-499


Checked By: RC

# **KEY NOTES:**


- 1/2" CW DOWN IN WALL TO WATER CLOSET.
- 2 1/2" H & CW DOWN IN WALL TO LAVATORY.
- 3 1/2" H & CW DOWN IN WALL TO BATHTUB/SHOWER. 3/4" H & CW DOWN IN WALL IF SERVING BATHTUB AND SHOWER.
- 4 1/2" H & CW TO SINK AND DISHWASHER. PROVIDE 1/2"x3/8" STOP ON CW. PROVIDE 1/2"x3/8"x3/8" STOP ON HW. 3/8" H & CW TO SINK FAUCET, 3/8" HW TO DISHWASHER.
- DISPOSAL BELOW SINK WITH DISHWASHER WASTE CONNECTION. CONNECT DRAIN THRU AIR GAP TO DISPOSAL. DISPOSAL BY G.C. AND INSTALLED BY PLUMBING CONTRACTOR.
- 6 1/2" CW DOWN IN WALL TO ICE MAKER VALVE AND BOX.
- $\overline{7}$  WASHING MACHINE CONNECTION BOX 2" WASTE, 1/2" H & CW.
- DOMESTIC WATER RISER. PROVIDE ISOLATION VALVE, REMOTE READ SUB-METER, AND PRV IF REQUIRED. REFER TO RISER DIAGRAM FOR SIZES.
- 9 ELECTRIC WATER HEATER. REFER TO DETAILS AND SCHEDULE.
- $\langle 10 \rangle$  3" SANITARY WASTE/VENT RISER PER IPC SEC 910.
- (11) 3" SANITARY WASTE RISER.
- (12) 3" SANITARY VENT RISER.
- (13) 2" SANITARY WASTE RISER.
- $\overline{\langle 14 \rangle}$  2" SANITARY VENT RISER.
- (15) 1/2" H & CW DOWN IN WALL TO BELOW FLOOR TO SERVE ISLAND SINK.

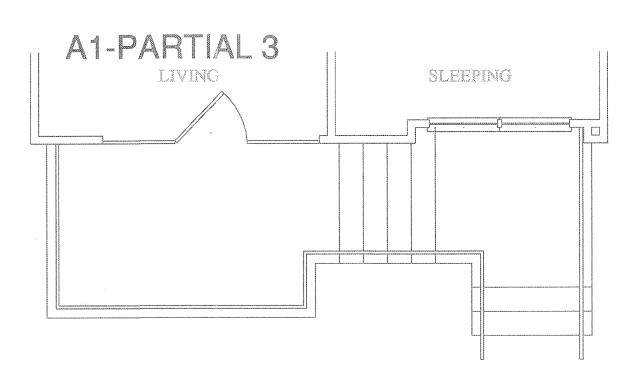


UNIT A1 - PARTIAL 3 OCCURS AT: (1) TOTAL UNITS ON SITE

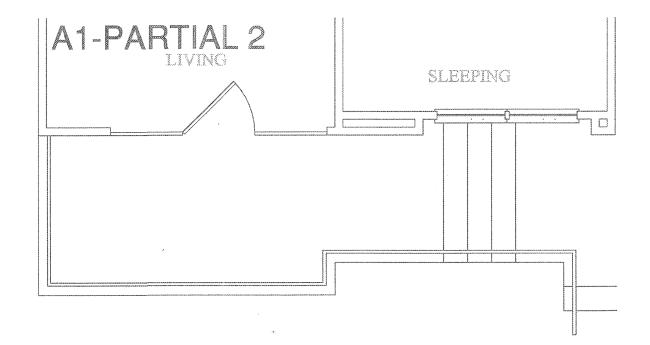



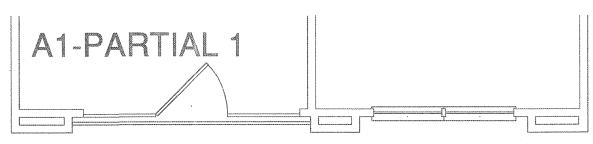




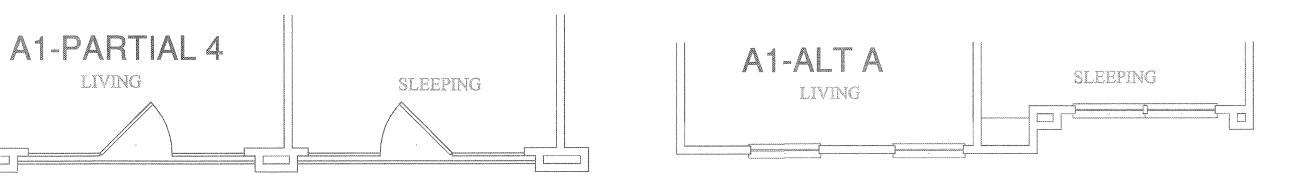

LIVING

OCCURS AT: (18) TOTAL UNITS ON SITE

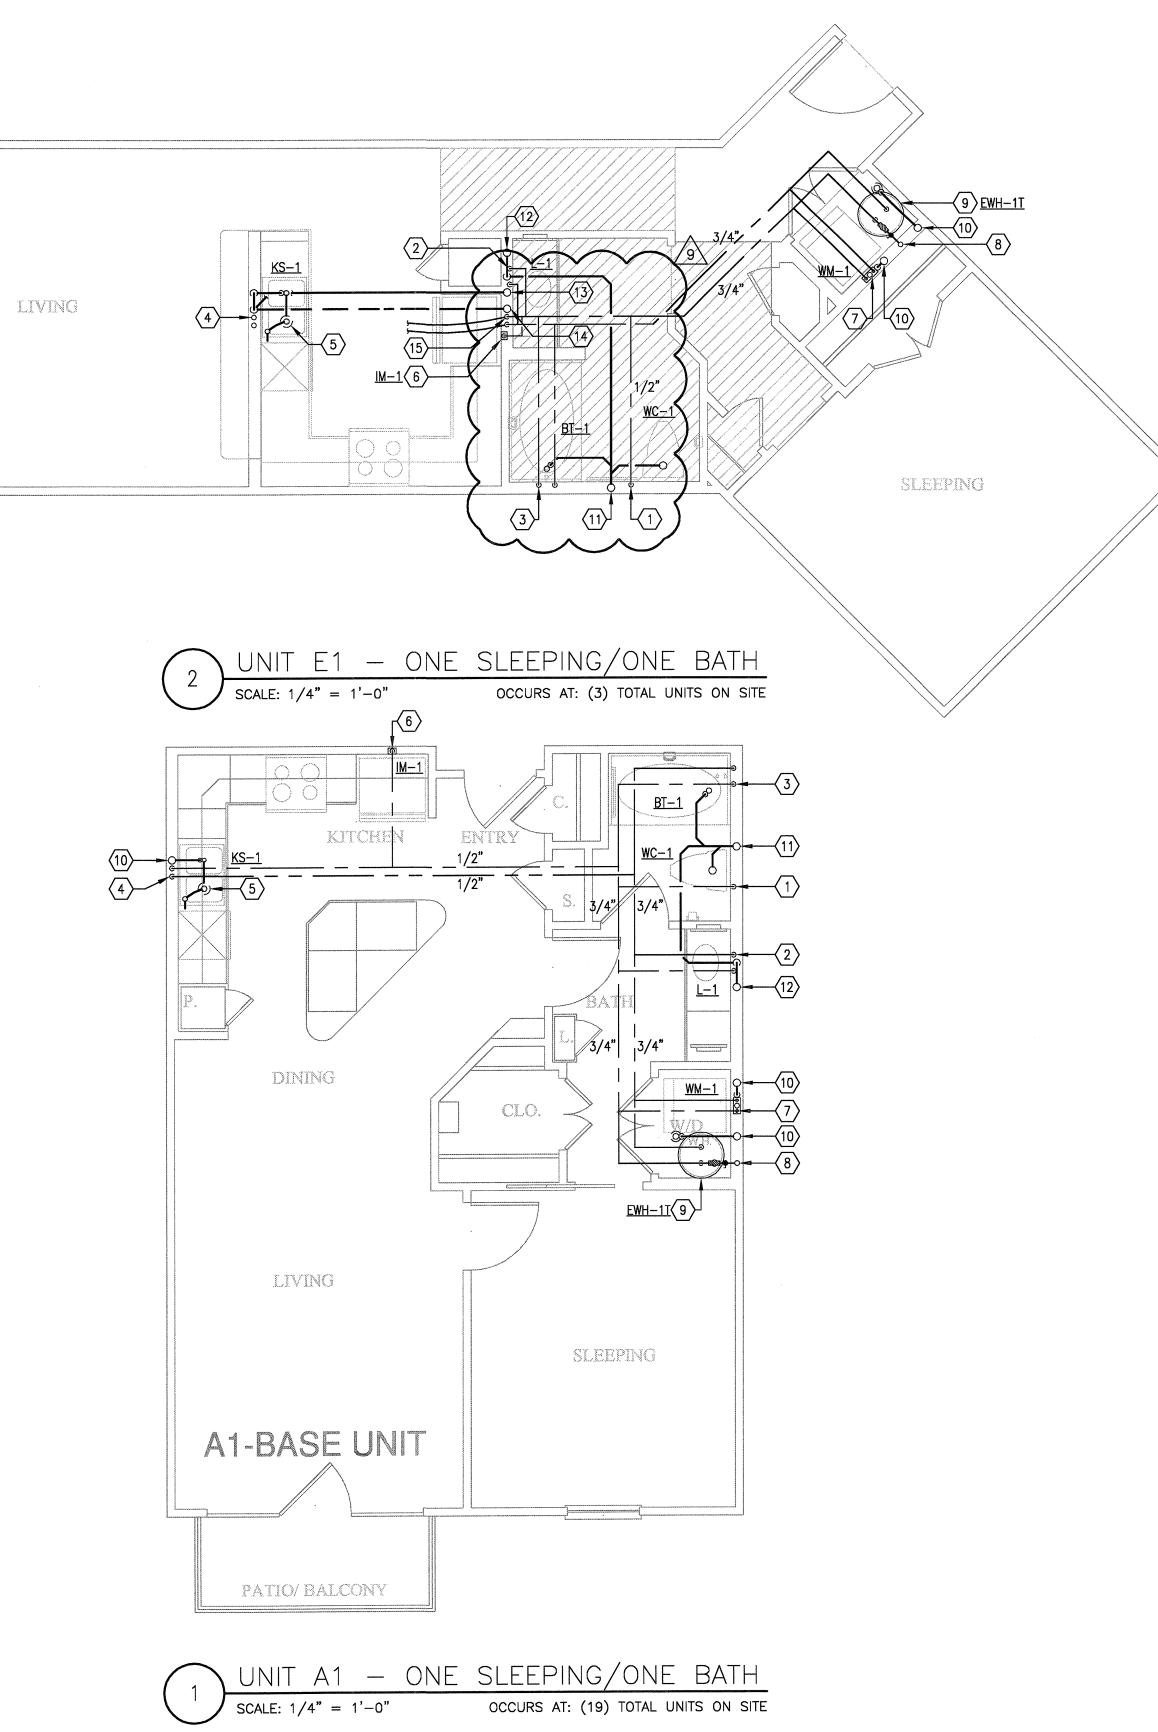





REVISIONS

9-2-2011 DESIGN REVISIONS 9-13-2011 ANSI/FHA COMMENTS
DESIGN REVISIONS 4 10-17-2011 CONSTRUCTION ISSUE 5 12-21-2011 DESIGN REVISIONS 6 1–17–2012 DESIGN REVISIONS TRANSFORMER
7 2-15-2012 REVISIONS

8 3-27-2012 CLUBHOUSE REVISIONS 4–17–2012 COORDINATION


**BBGO** architects 4144 N. Central Expy. Suite 855 Dallas, TX 75204 214.520.8878 bgoarchitects.com


08-05-1

PROJECT

11129

SHEET NUMBER

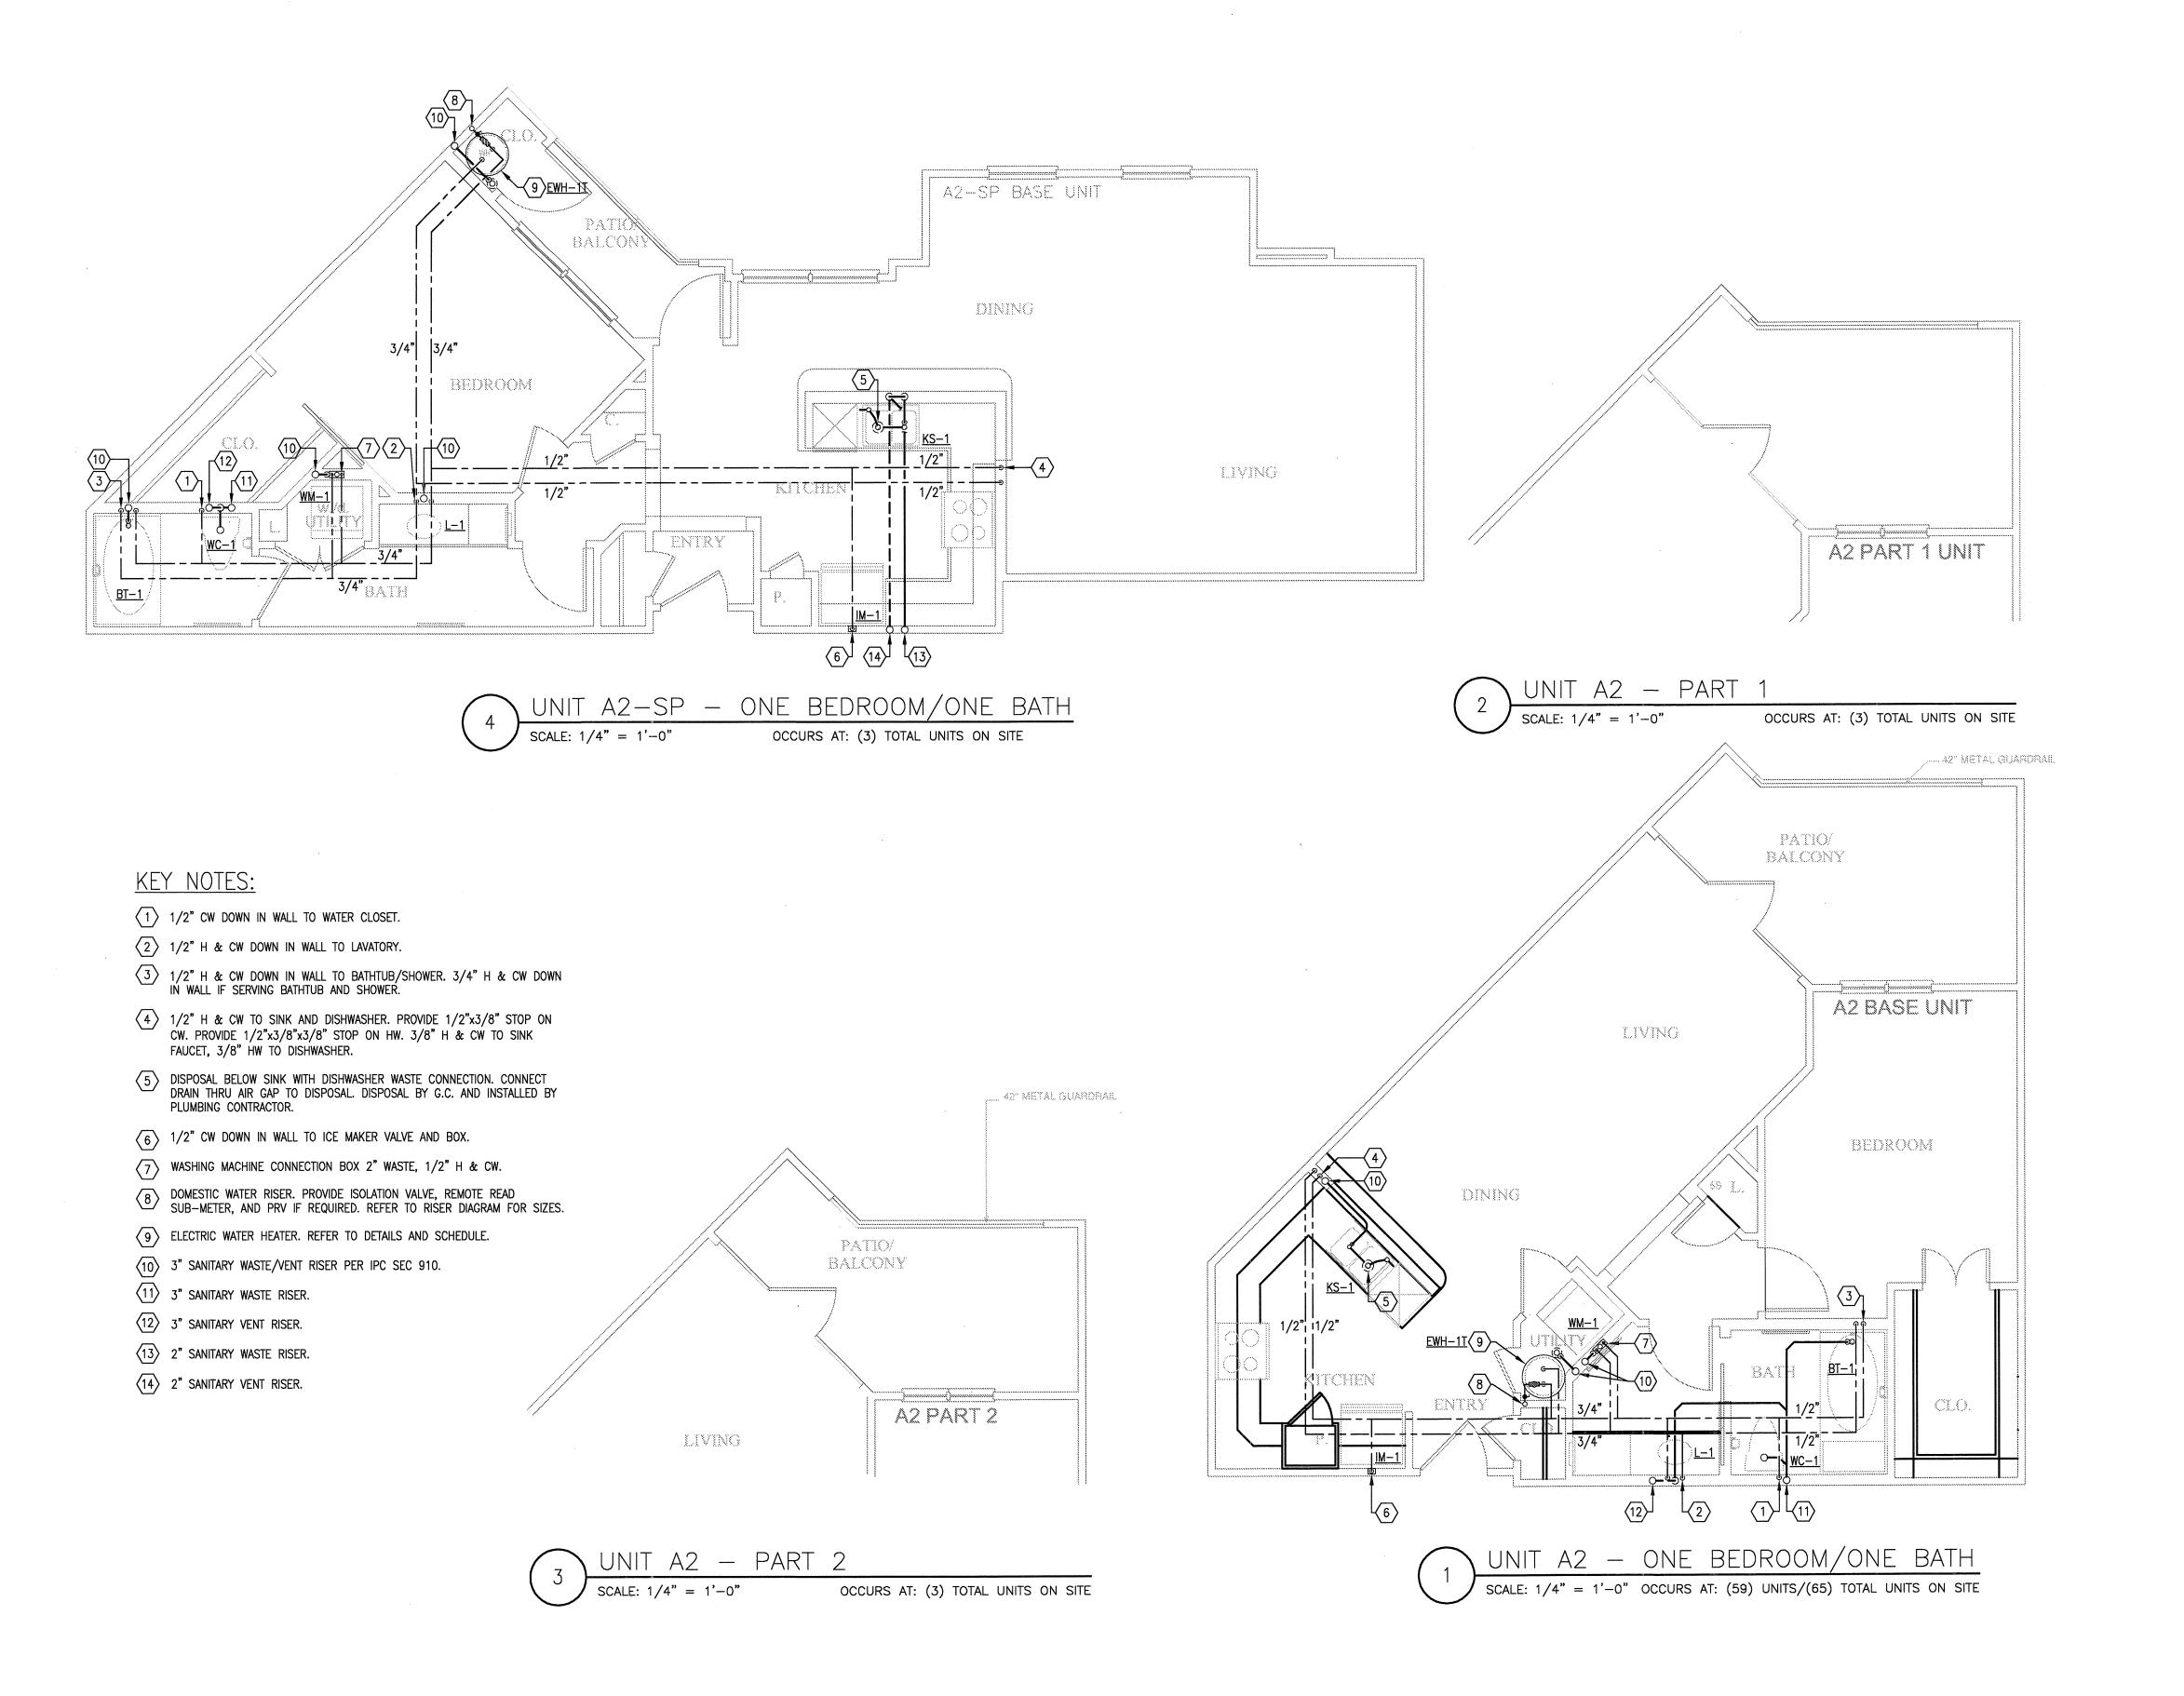

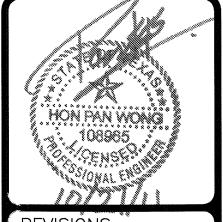

REVISIÔNS

9-2-2011 DESIGN REVISIONS

9-13-2011 ANSI/FHA COMMENTS

3 9-23-2011 DESIGN REVISIONS

4 10-17-2011 CONSTRUCTION ISSUE

SPRINGS LOFTS

LOFT APARTMENTS IN A



4144 N. Central Expy. Suite 855 Dallas, TX 75204 214.520.8878 bgoarchitects.com

DATE

08-05-1

PROJECT

11129

P-2.2

SHEET NUMBER


Jordan & Skala Engineers

14240 Midway Road, Suite 350
13allas, 3X 75244-5138
v: (469) 385-1616 F: (469) 385-1615


Project Number - 113-0355

Drawn By: CV

Checked By: RC

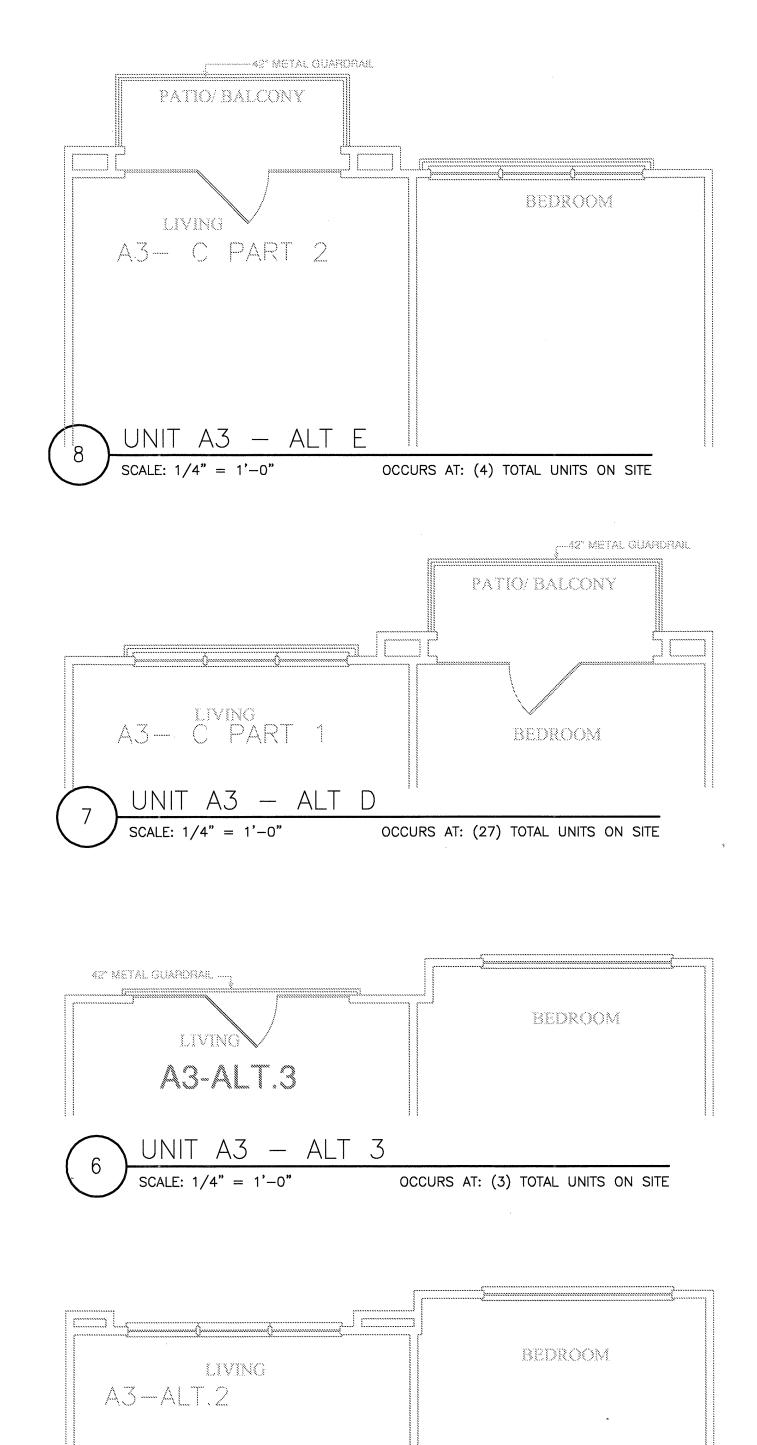

OCCURS AT: (4) TOTAL UNITS ON SITE

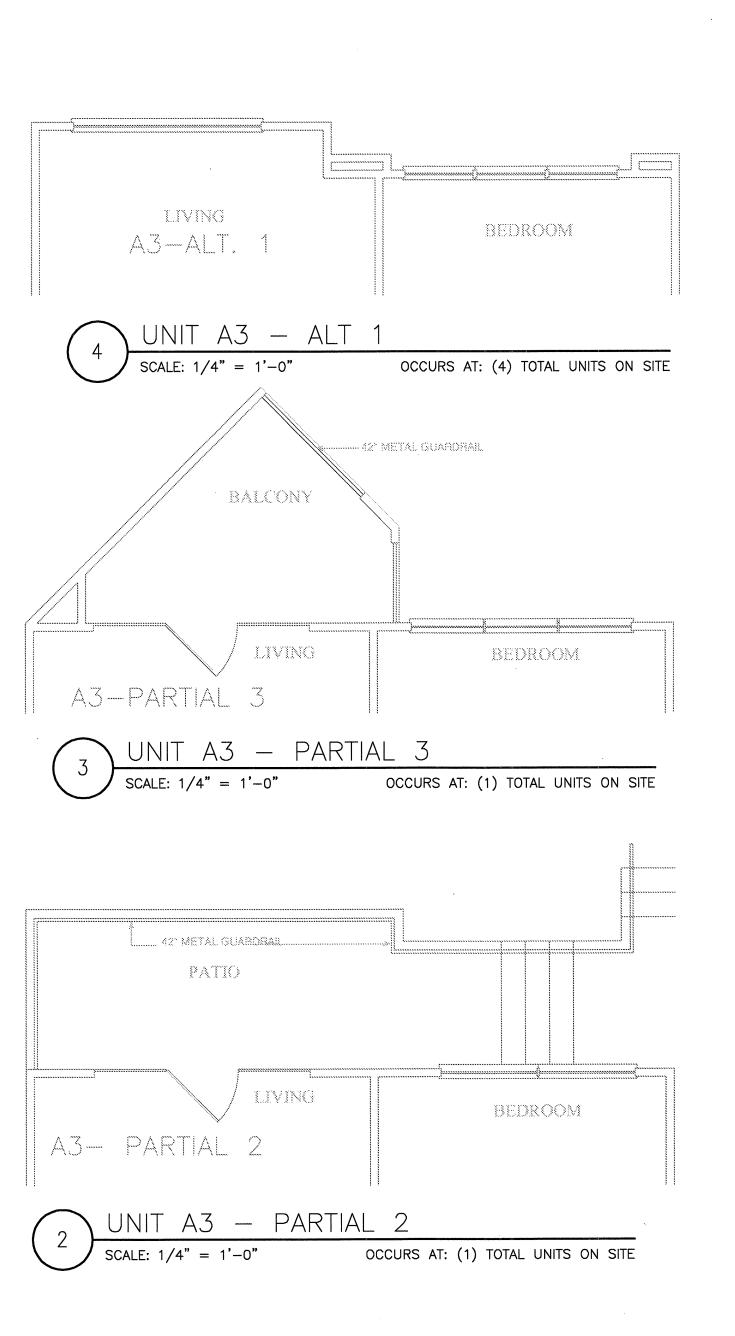





- 1) 1/2" CW DOWN IN WALL TO WATER CLOSET.
- 2 1/2" H & CW DOWN IN WALL TO LAVATORY.
- 3 1/2" H & CW DOWN IN WALL TO BATHTUB/SHOWER. 3/4" H & CW DOWN IN WALL IF SERVING BATHTUB AND SHOWER.
- 4 1/2" H & CW TO SINK AND DISHWASHER. PROVIDE 1/2"x3/8" STOP ON CW. PROVIDE 1/2"x3/8"x3/8" STOP ON HW. 3/8" H & CW TO SINK FAUCET, 3/8" HW TO DISHWASHER.
- DISPOSAL BELOW SINK WITH DISHWASHER WASTE CONNECTION. CONNECT DRAIN THRU AIR GAP TO DISPOSAL. DISPOSAL BY G.C. AND INSTALLED BY PLUMBING CONTRACTOR.
- $\overline{6}$  1/2" CW DOWN IN WALL TO ICE MAKER VALVE AND BOX.
- (7) WASHING MACHINE CONNECTION BOX 2" WASTE, 1/2" H & CW.
- DOMESTIC WATER RISER. PROVIDE ISOLATION VALVE, REMOTE READ SUB-METER, AND PRV IF REQUIRED. REFER TO RISER DIAGRAM FOR SIZES.

 $\langle 15 \rangle$  1/2" H & CW DOWN IN WALL TO BELOW FLOOR TO SERVE ISLAND SINK.

- 9 ELECTRIC WATER HEATER. REFER TO DETAILS AND SCHEDULE.
- (10) 3" SANITARY WASTE/VENT RISER PER IPC SEC 910.
- 3" SANITARY WASTE RISER.
- (12) 3" SANITARY VENT RISER.
- $\langle 13 \rangle$  2" SANITARY WASTE RISER.
- $\langle 14 \rangle$  2" Sanitary vent riser.

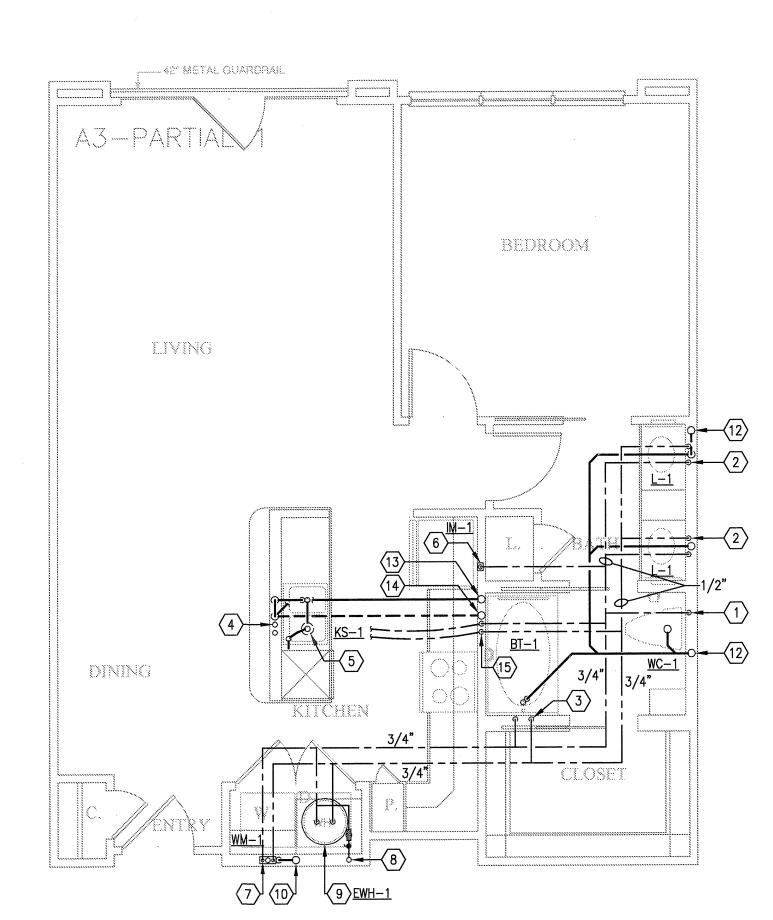



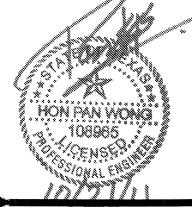

REVISIONS

9-2-2011 DESIGN REVISIONS 9-13-2011 ANSI/FHA COMMENTS 3 9-23-2011 DESIGN REVISIONS 4 10-17-2011 CONSTRUCTION ISSUE

IIBGO architects 4144 N. Central Expy. Suite 855 Dallas, TX 75204 214.520.8878 bgoarchitects.com

08-05-1

PROJECT


11129


P-2.3

SHEET NUMBER

Jordan & Skala Engineer Texas Firm Registration # F-499


Checked By: RC

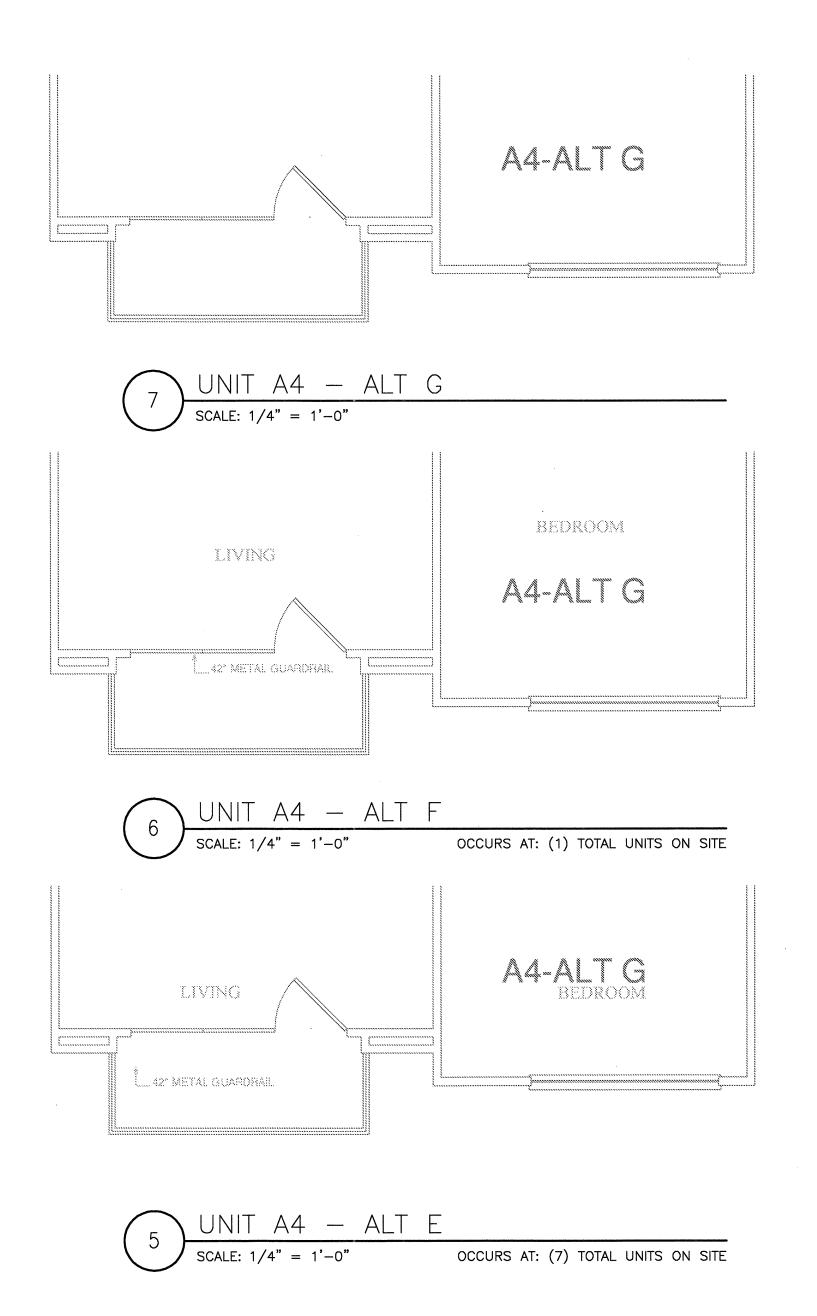

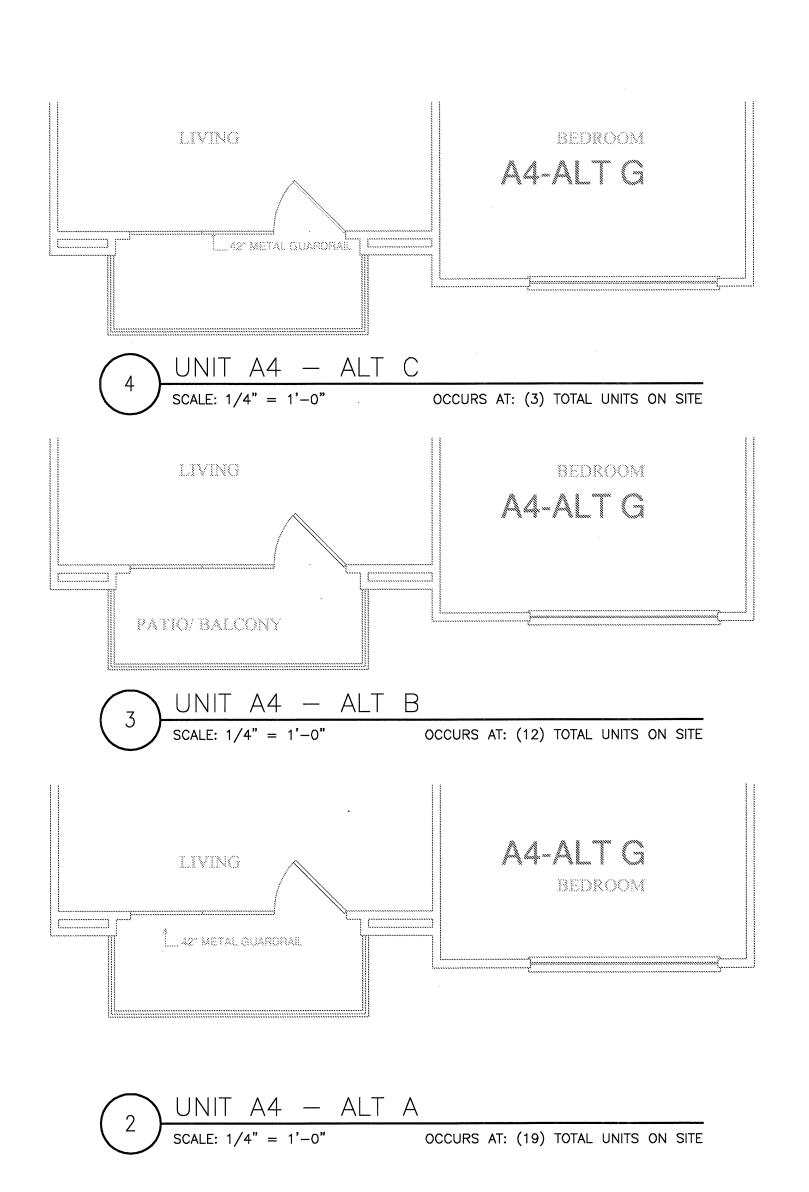




- 1) 1/2" CW DOWN IN WALL TO WATER CLOSET.
- (2) 1/2" H & CW DOWN IN WALL TO LAVATORY.
- 3 1/2" H & CW DOWN IN WALL TO BATHTUB/SHOWER. 3/4" H & CW DOWN IN WALL IF SERVING BATHTUB AND SHOWER.
- 4 1/2" H & CW TO SINK AND DISHWASHER. PROVIDE 1/2"x3/8" STOP ON CW. PROVIDE 1/2"x3/8"x3/8" STOP ON HW. 3/8" H & CW TO SINK FAUCET, 3/8" HW TO DISHWASHER.
- DISPOSAL BELOW SINK WITH DISHWASHER WASTE CONNECTION. CONNECT DRAIN THRU AIR GAP TO DISPOSAL. DISPOSAL BY G.C. AND INSTALLED BY PLUMBING CONTRACTOR.
- $\overline{6}$  1/2" CW DOWN IN WALL TO ICE MAKER VALVE AND BOX.
- $\overline{7}$  WASHING MACHINE CONNECTION BOX 2" WASTE, 1/2" H & CW.
- DOMESTIC WATER RISER. PROVIDE ISOLATION VALVE, REMOTE READ SUB-METER, AND PRV IF REQUIRED. REFER TO RISER DIAGRAM FOR SIZES.
- 9 ELECTRIC WATER HEATER. REFER TO DETAILS AND SCHEDULE.
- $\langle 10 \rangle$  3" SANITARY WASTE/VENT RISER PER IPC SEC 910.
- (11) 3" SANITARY WASTE RISER.
- (12) 3" SANITARY VENT RISER.

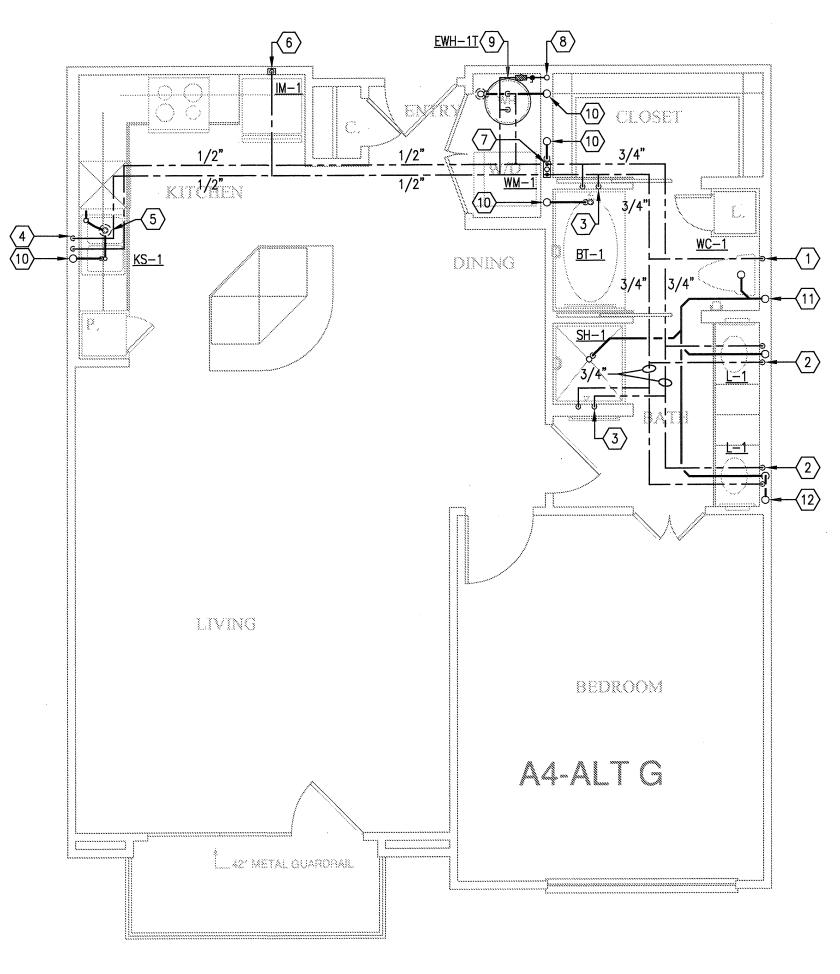



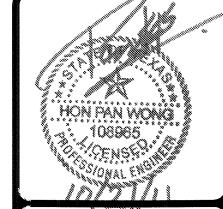

REVISIÔNS

9-2-2011 DESIGN REVISIONS 9-13-2011 ANSI/FHA COMMENTS 3 9-23-2011 DESIGN REVISIONS

4 10-17-2011 CONSTRUCTION ISSUE

R

BGO architects 4144 N. Central Expy. Suite 855 Dallas, TX 75204 214.520.8878 bgoarchitects.com


08-05-1

PROJECT

11129

SHEET NUMBER




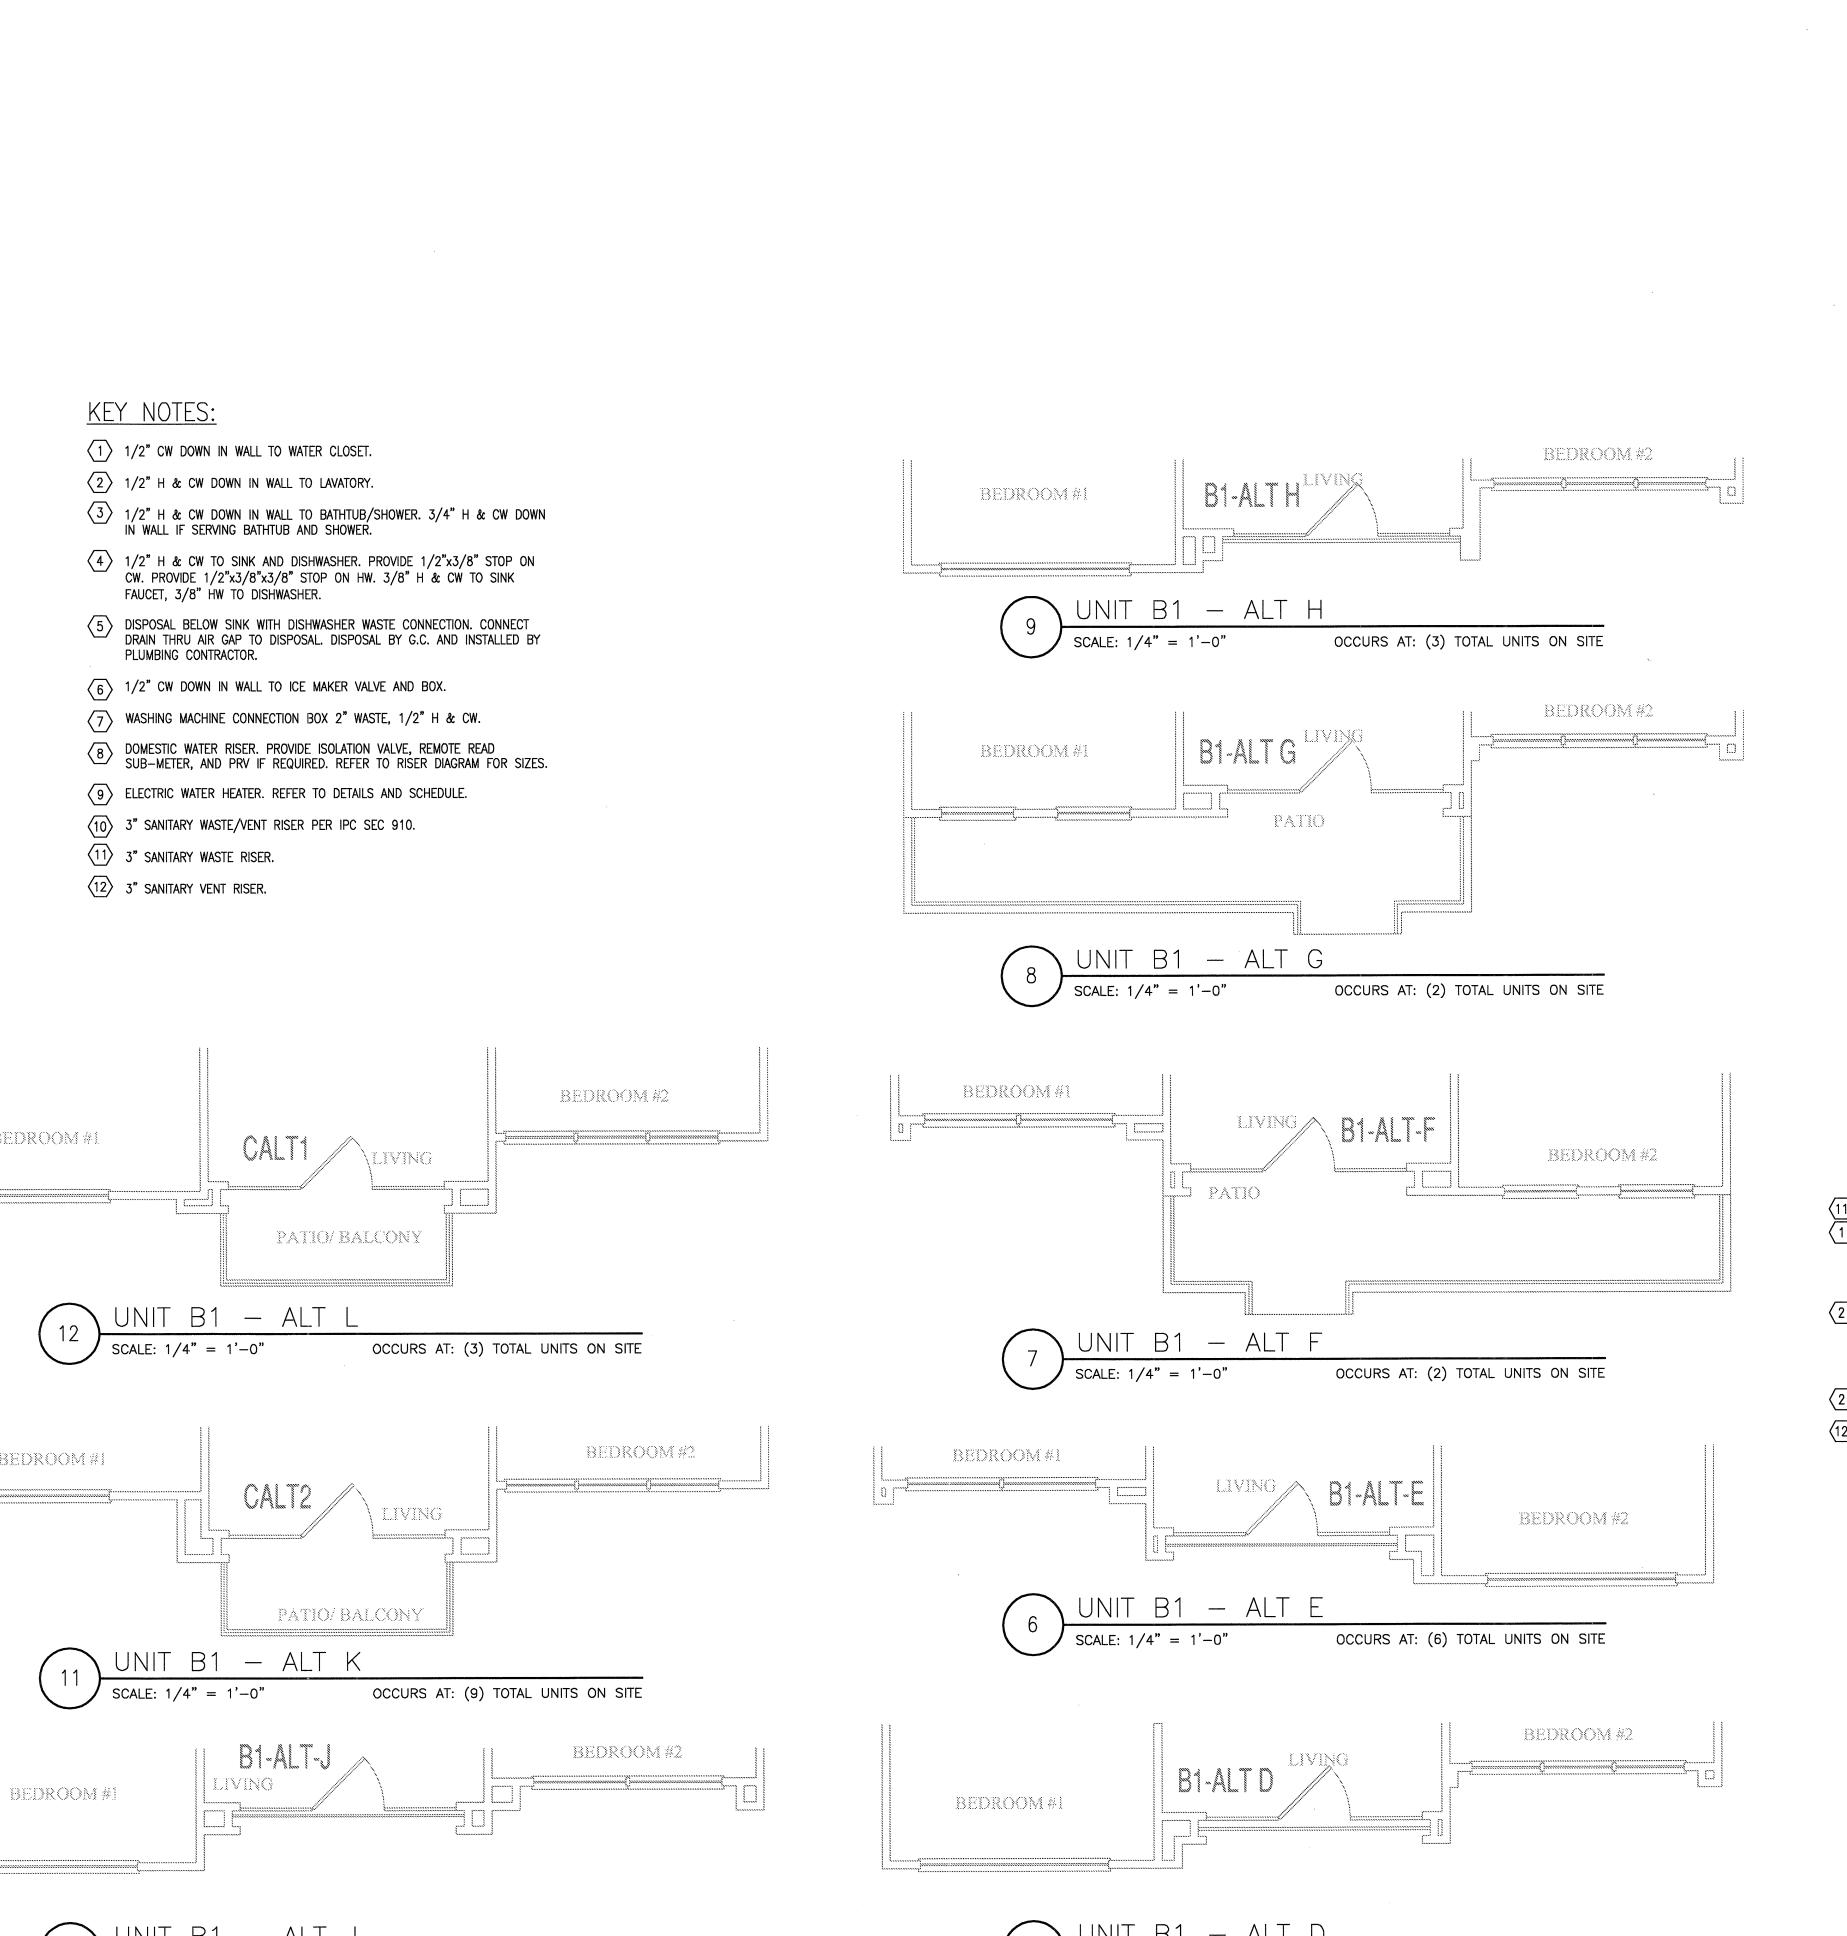

BEDROOM #1

BEDROOM#I

OCCURS AT: (15) TOTAL UNITS ON SITE

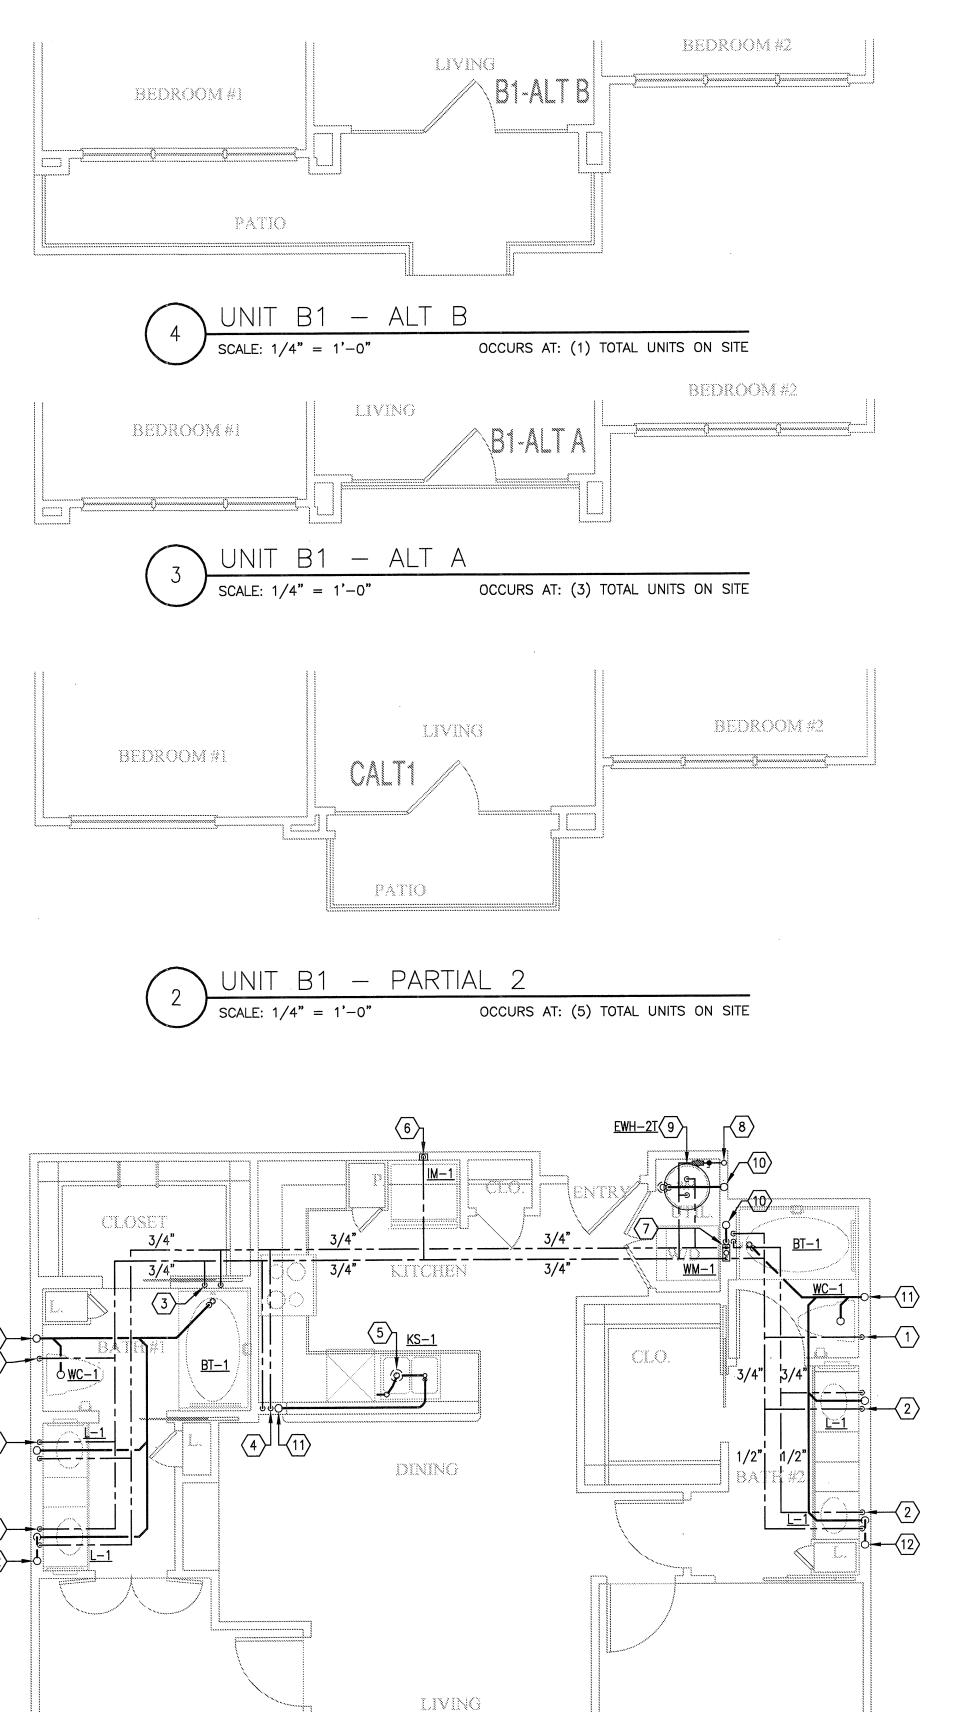


BEDROOM#I

OCCURS AT: (6) TOTAL UNITS ON SITE

TETT 42 METAL GUARONAIL /

UNIT B1 - TWO BEDROOM/TWO BATH (PARTIAL 1)

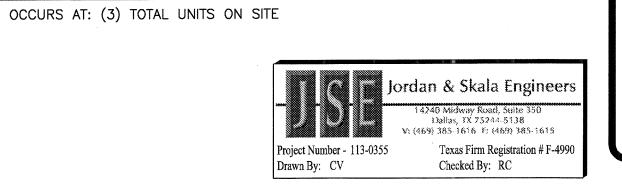

BEDROOM #2

HON PAN WONG 108985

REVISIONS

1 9-2-2011 REVISIONS 2 9-13-2011 ANSI/FHA COMMENTS 1/3 9-23-2011 DESIGN 10-17-2011 CONSTRUCTION


ADDISON, | N

architects 4144 N. Central Expy. Suite 855 Dallas, TX 75204 214.520.8878 bgoarchitects.com

08-05-1

PROJECT 11129

SHEET NUMBER

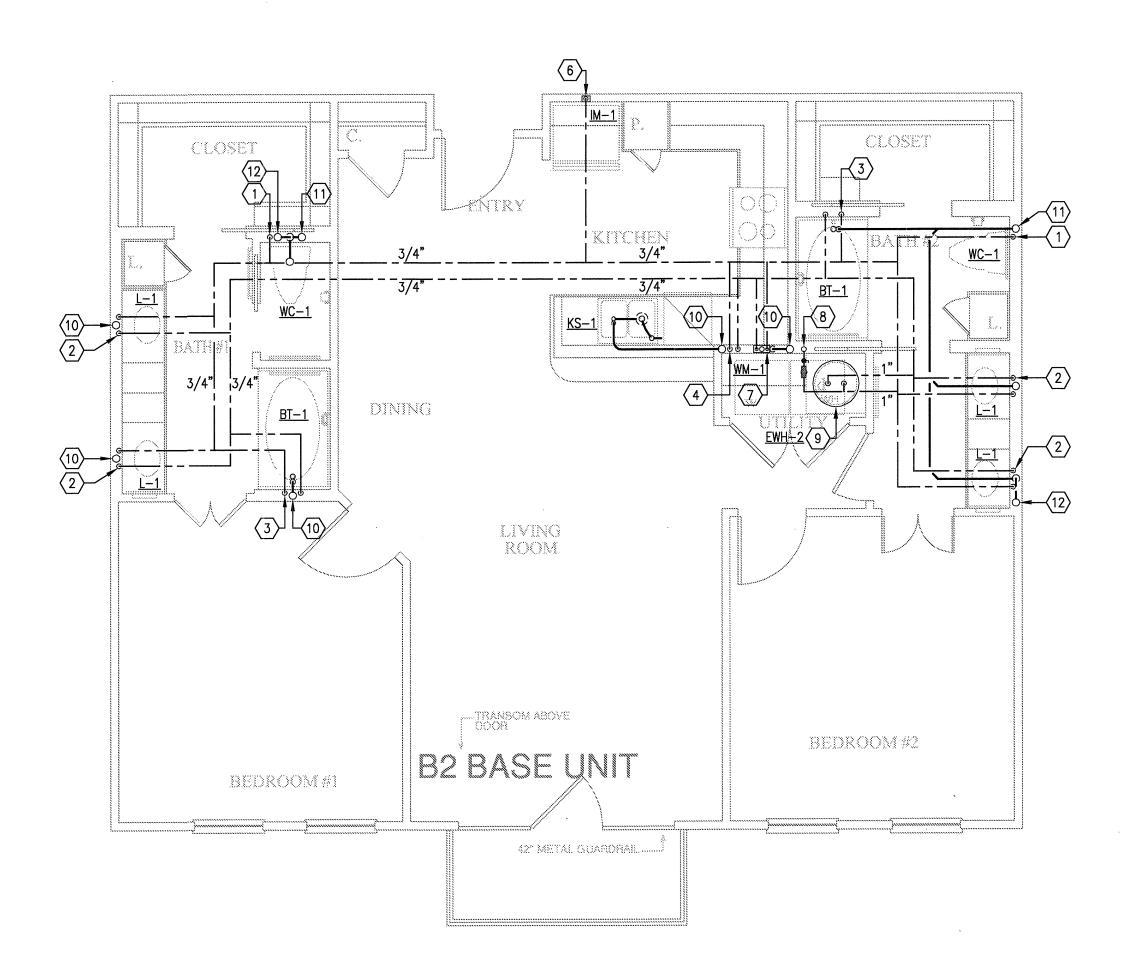

UNIT B2 - TWO BEDROOM/TWO BATH

SCALE: 1/4" = 1'-0" OCCURS AT: (3) TOTAL UNITS ON SITE

## **KEY NOTES:**

- 1) 1/2" CW DOWN IN WALL TO WATER CLOSET.
- 2 1/2" H & CW DOWN IN WALL TO LAVATORY.
- 3 1/2" H & CW DOWN IN WALL TO BATHTUB/SHOWER. 3/4" H & CW DOWN IN WALL IF SERVING BATHTUB AND SHOWER.
- 4 1/2" H & CW TO SINK AND DISHWASHER. PROVIDE 1/2"x3/8" STOP ON CW. PROVIDE 1/2"x3/8"x3/8" STOP ON HW. 3/8" H & CW TO SINK FAUCET, 3/8" HW TO DISHWASHER.
- DISPOSAL BELOW SINK WITH DISHWASHER WASTE CONNECTION. CONNECT DRAIN THRU AIR GAP TO DISPOSAL. DISPOSAL BY G.C. AND INSTALLED BY PLUMBING CONTRACTOR.
- 6 1/2" CW DOWN IN WALL TO ICE MAKER VALVE AND BOX.
- WASHING MACHINE CONNECTION BOX 2" WASTE, 1/2" H & CW.
- DOMESTIC WATER RISER. PROVIDE ISOLATION VALVE, REMOTE READ SUB-METER, AND PRV IF REQUIRED. REFER TO RISER DIAGRAM FOR SIZES.
- 9 ELECTRIC WATER HEATER. REFER TO DETAILS AND SCHEDULE.
- 3" SANITARY WASTE/VENT RISER PER IPC SEC 910.
- (11) 3" SANITARY WASTE RISER.
- $\overline{(12)}$  3" SANITARY VENT RISER.



REVISIÔNS 1 9-2-2011 DESIGN REVISIONS

9-13-2011 ANSI/FHA COMMENTS 3 9-23-2011 DESIGN REVISIONS

4 10-17-2011 CONSTRUCTION ISSUE



4144 N. Central Expy. Suite 855 Dallas, TX 75204 214.520.8878 bgoarchitects.com


08-05-1


PROJECT


11129 SHEET NUMBER

P-2.6

Jordan & Skala Engineers 14240 Midway Road, Suite 350 Dallas, FX 75244-5138 V: (469) 385-1616 - E: (469) 385-1615 Texas Firm Registration # F-4990 Checked By: RC

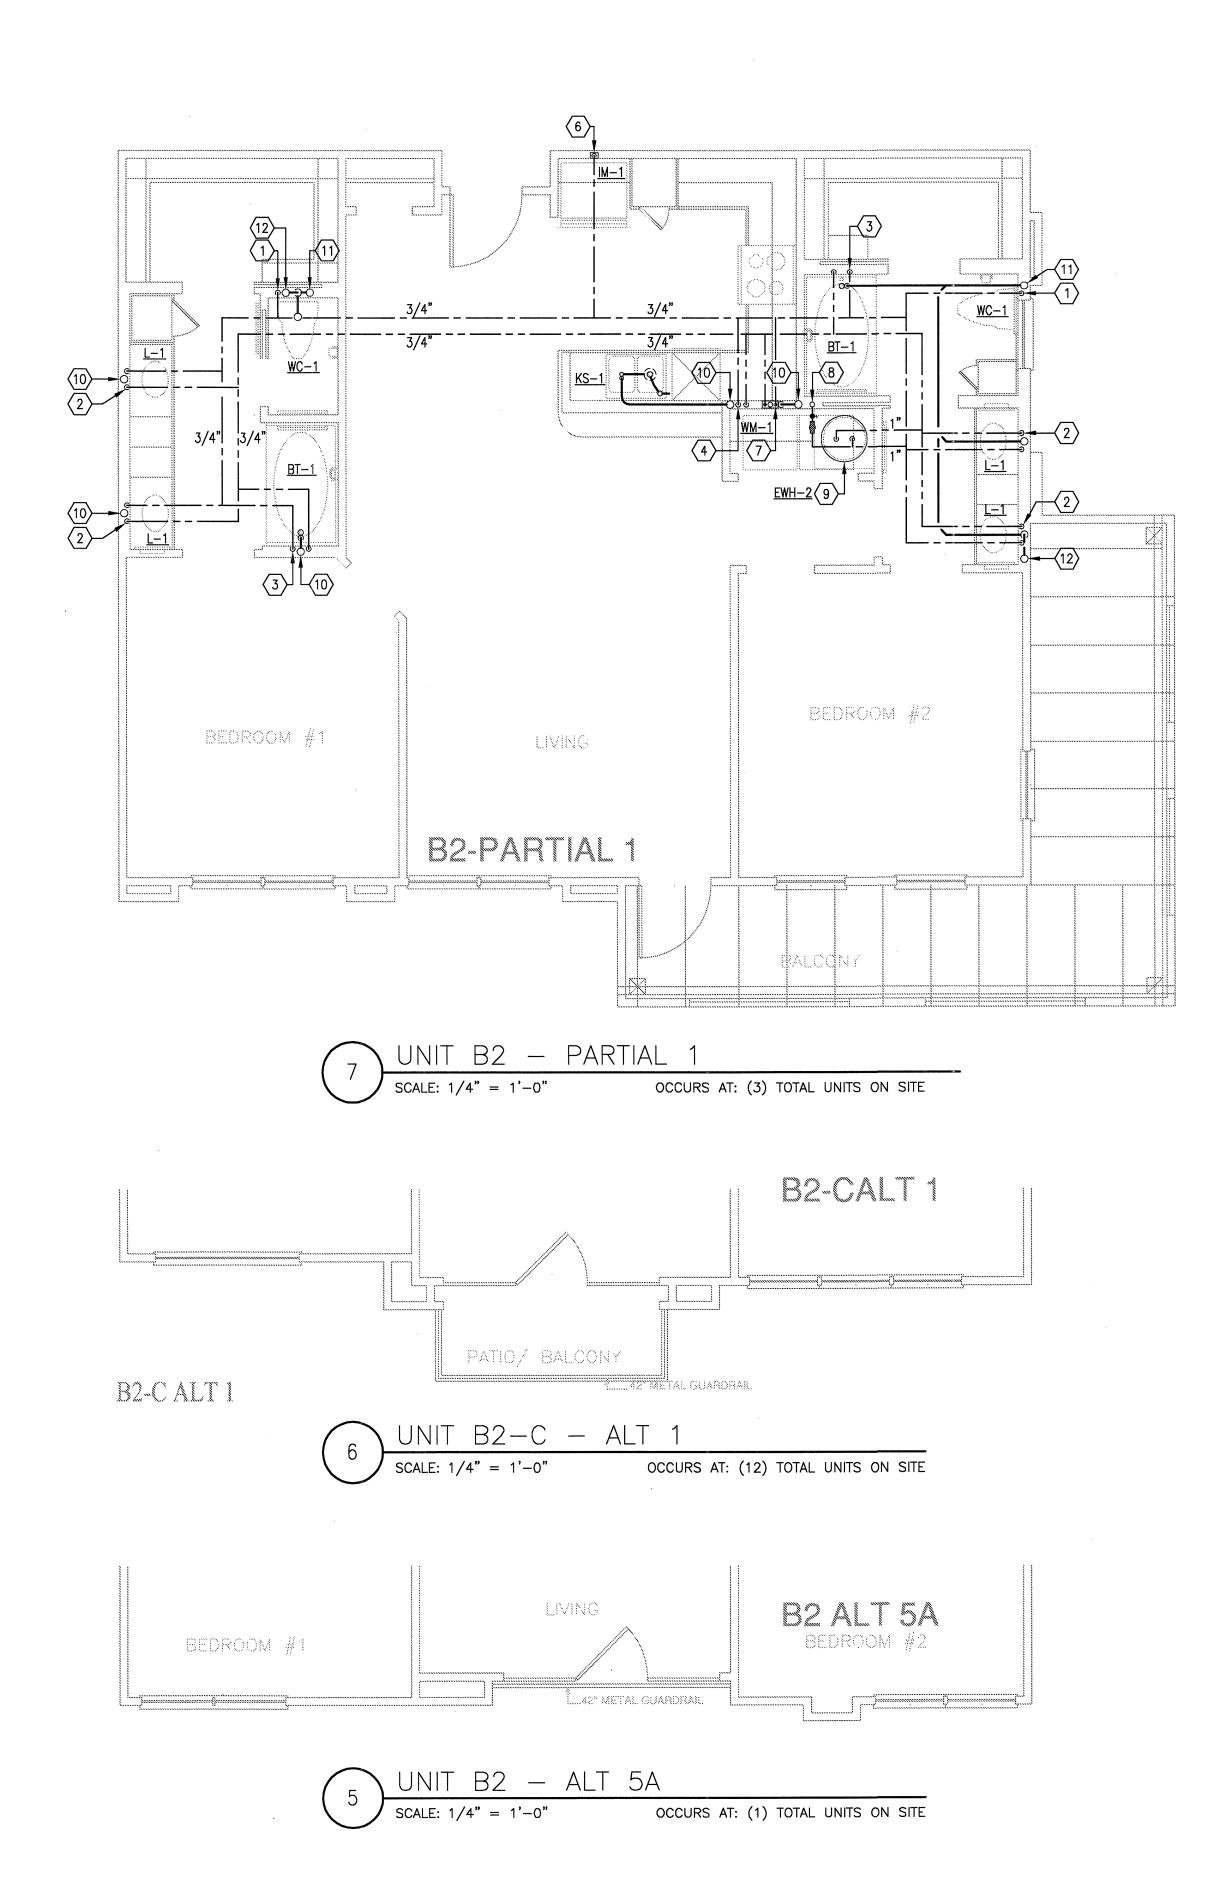

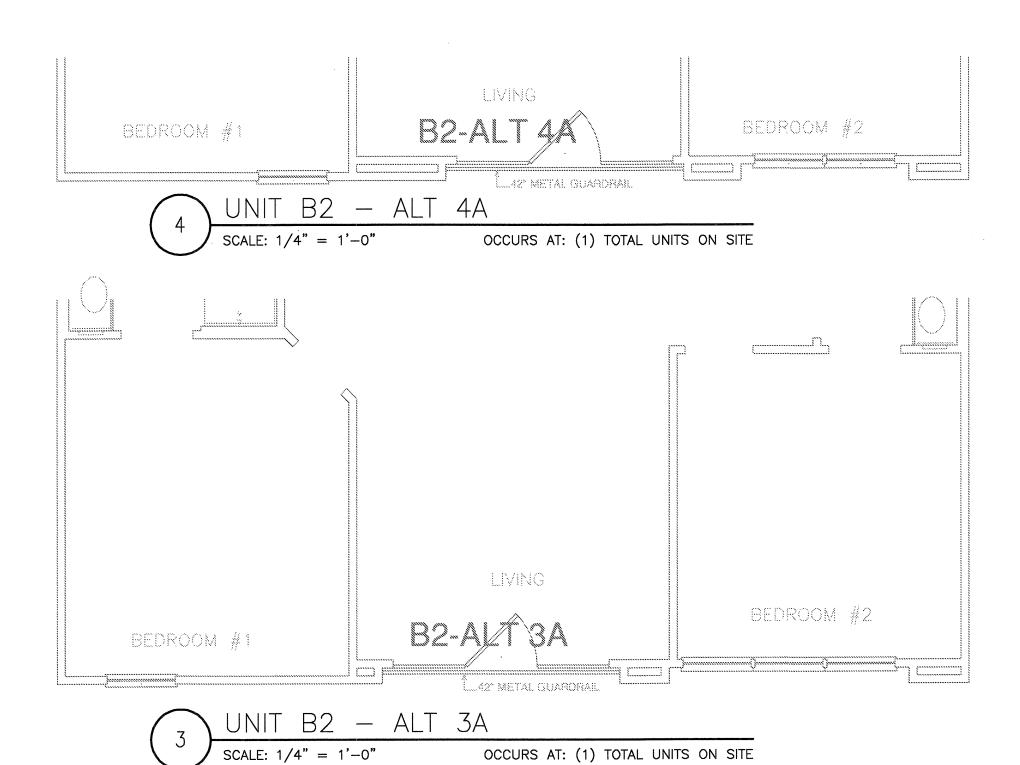


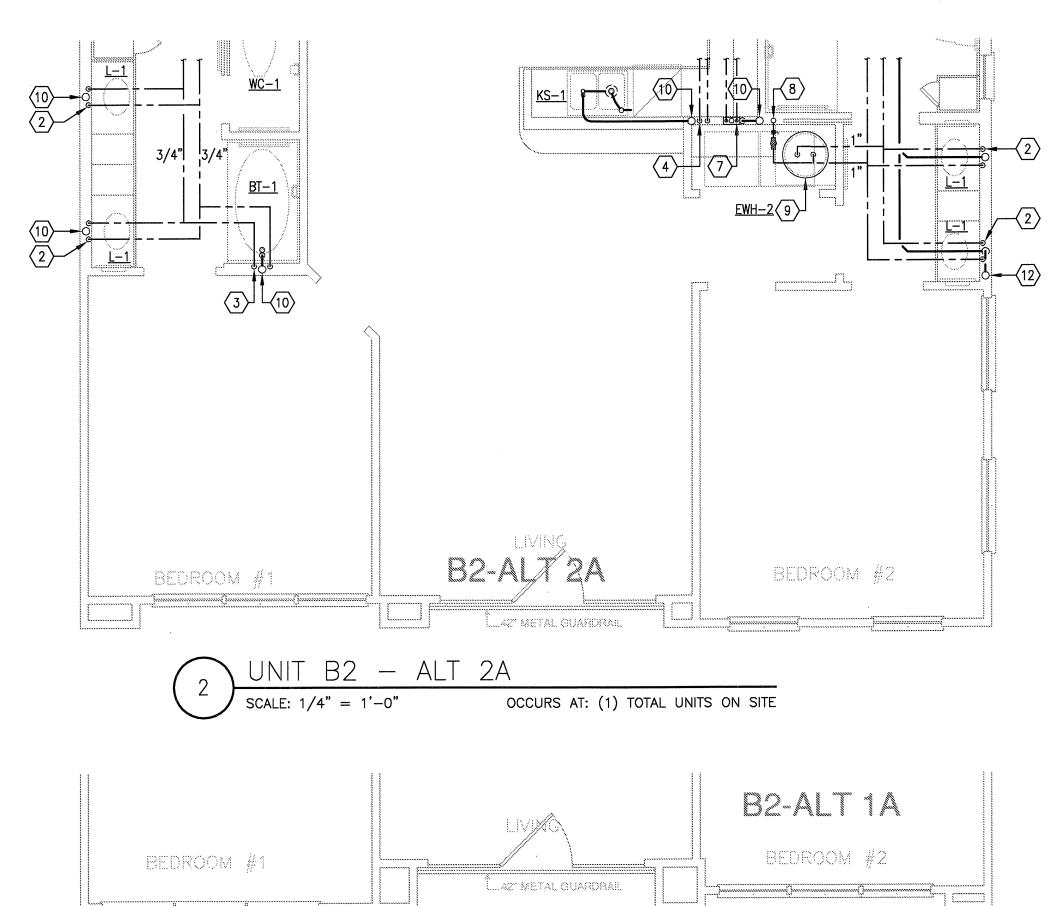

OCCURS AT: (2) TOTAL UNITS ON SITE



- 1) 1/2" CW DOWN IN WALL TO WATER CLOSET.
- 3 1/2" H & CW DOWN IN WALL TO BATHTUB/SHOWER. 3/4" H & CW DOWN IN WALL IF SERVING BATHTUB AND SHOWER.
- 4 1/2" H & CW TO SINK AND DISHWASHER. PROVIDE 1/2"x3/8" STOP ON CW. PROVIDE 1/2"x3/8"x3/8" STOP ON HW. 3/8" H & CW TO SINK FAUCET, 3/8" HW TO DISHWASHER.
- DISPOSAL BELOW SINK WITH DISHWASHER WASTE CONNECTION. CONNECT DRAIN THRU AIR GAP TO DISPOSAL. DISPOSAL BY G.C. AND INSTALLED BY PLUMBING CONTRACTOR.
- 6 1/2" CW DOWN IN WALL TO ICE MAKER VALVE AND BOX.
- DOMESTIC WATER RISER. PROVIDE ISOLATION VALVE, REMOTE READ SUB-METER, AND PRV IF REQUIRED. REFER TO RISER DIAGRAM FOR SIZES.
- 9 ELECTRIC WATER HEATER. REFER TO DETAILS AND SCHEDULE.
- (10) 3" SANITARY WASTE/VENT RISER PER IPC SEC 910.
- (11) 3" SANITARY WASTE RISER.

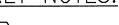

- 2 1/2" H & CW DOWN IN WALL TO LAVATORY.

- 7 WASHING MACHINE CONNECTION BOX 2" WASTE, 1/2" H & CW.
- (12) 3" SANITARY VENT RISER.



REVISIÔNS

1 9-2-2011 DESIGN REVISIONS

9-13-2011 ANSI/FHA COMMENTS

9-23-2011 DESIGN REVISIONS

4 10-17-2011 CONSTRUCTION ISSUE




08-05-1

PROJECT 11129


SHEET NUMBER



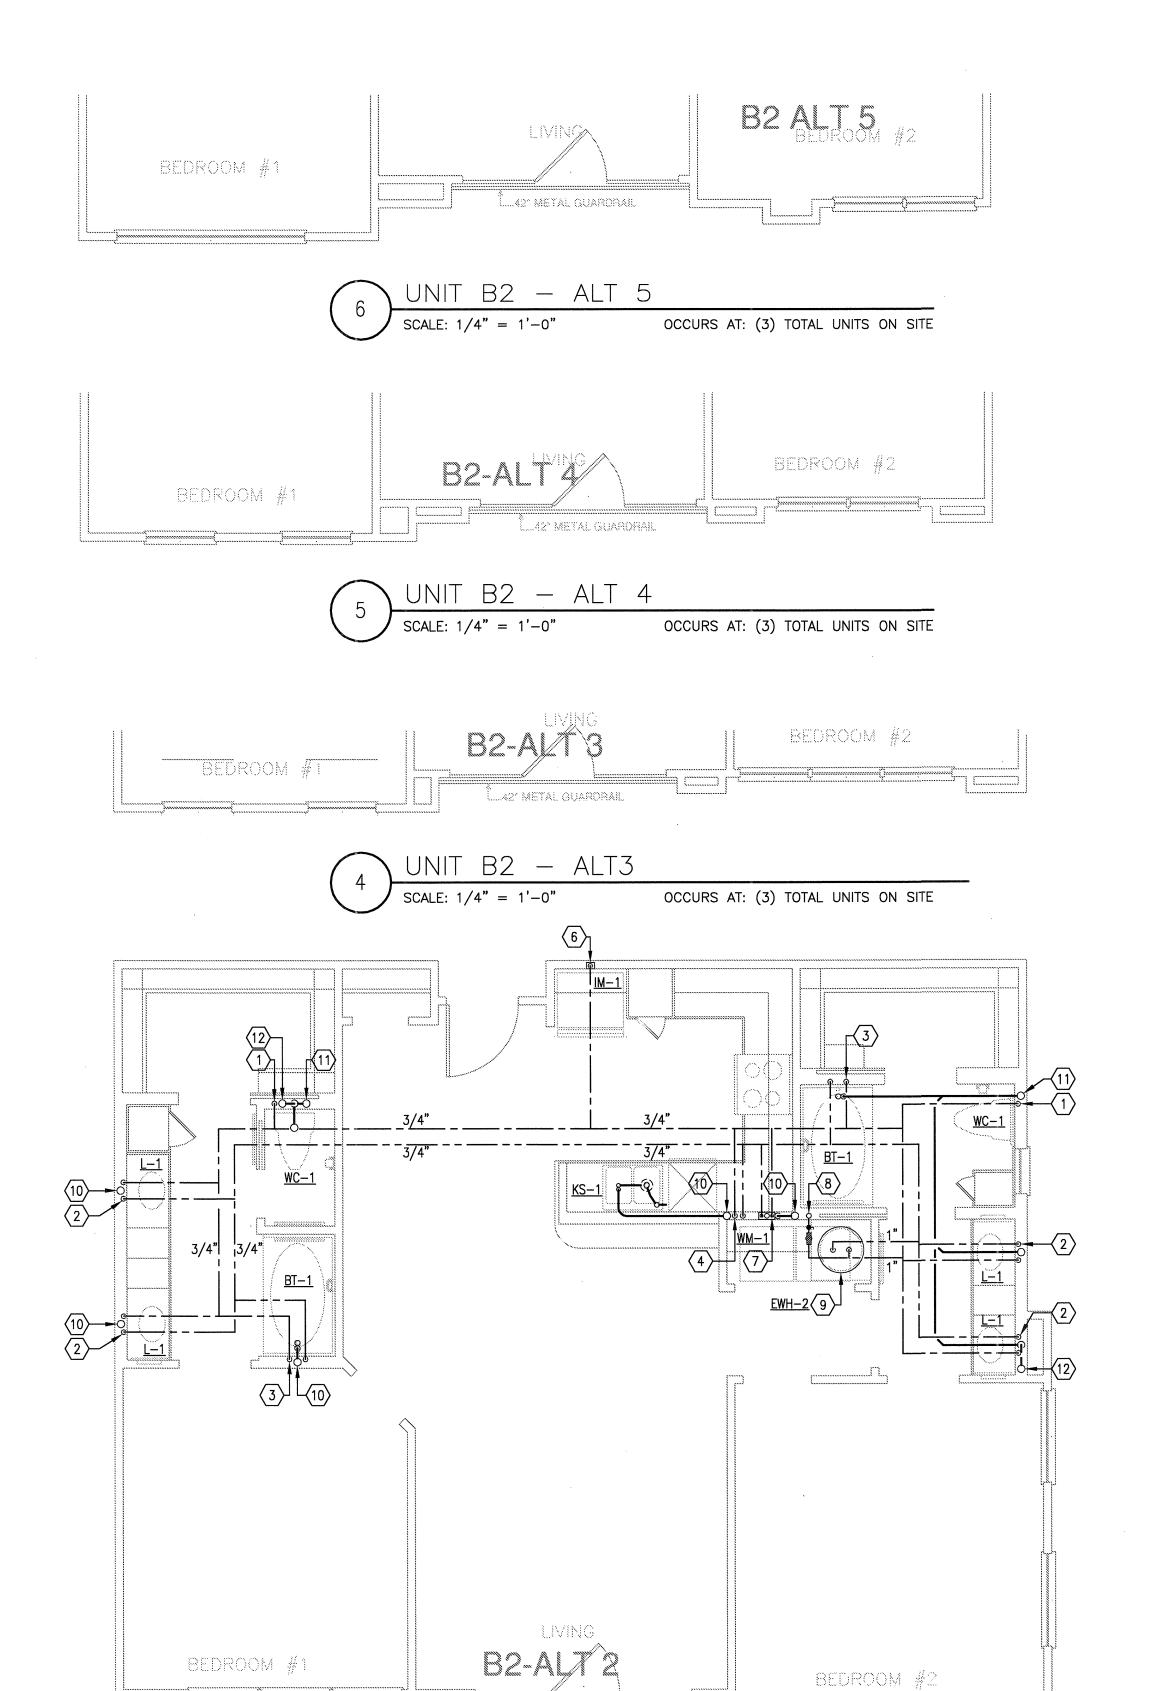


- [....42° METAL GUARDRAIL

OCCURS AT: (3) TOTAL UNITS ON SITE

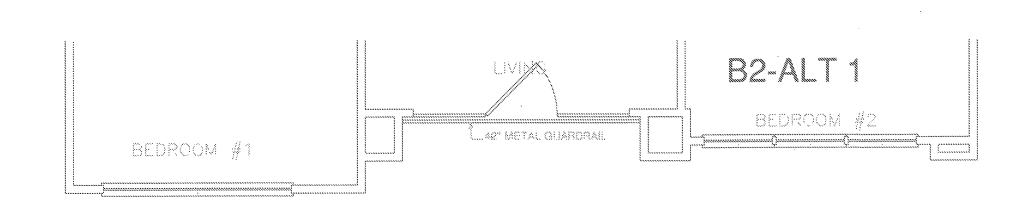



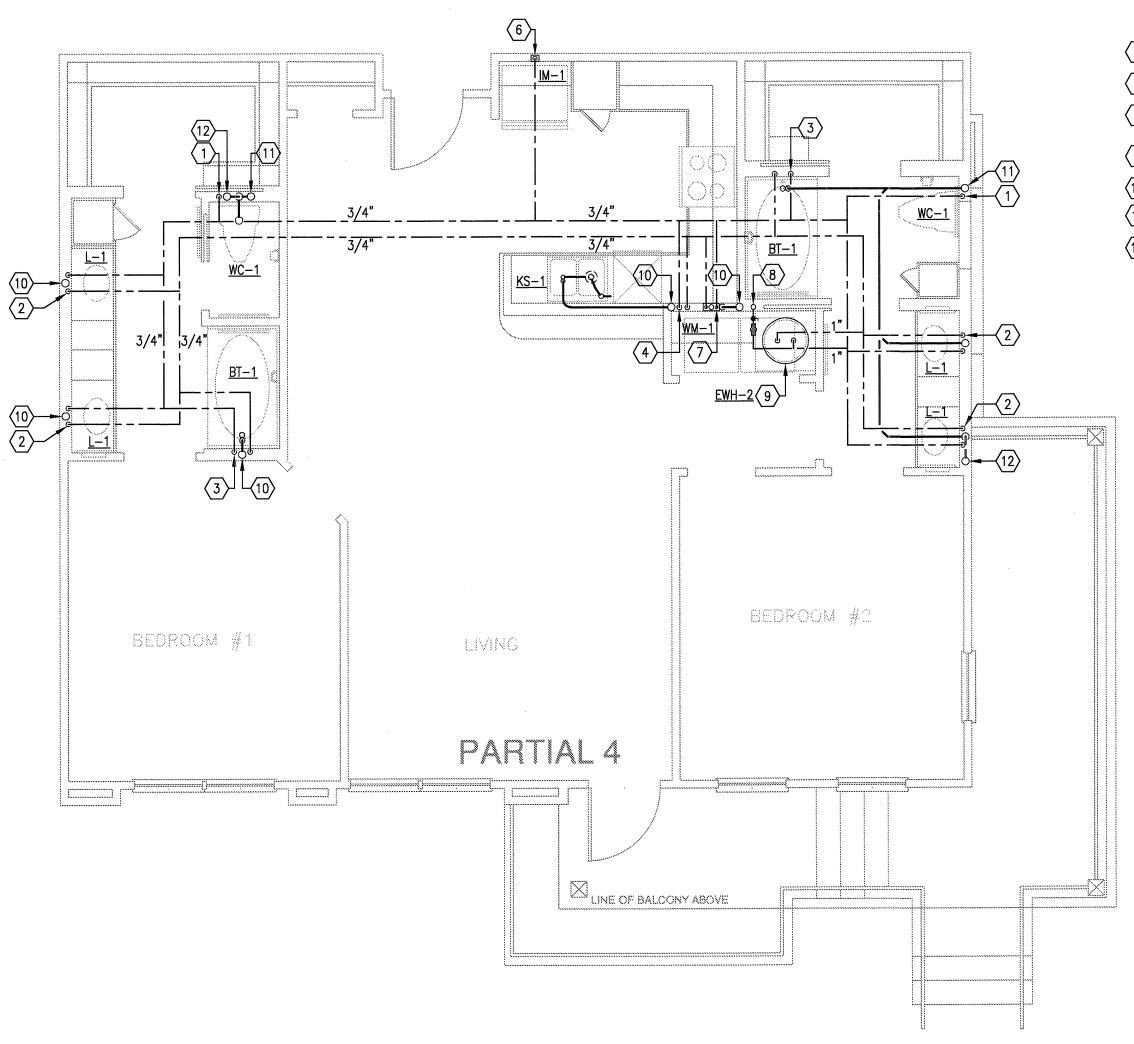

OCCURS AT: (1) TOTAL UNITS ON SITE




- 1) 1/2" CW DOWN IN WALL TO WATER CLOSET.
- 2 1/2" H & CW DOWN IN WALL TO LAVATORY.
- 3 1/2" H & CW DOWN IN WALL TO BATHTUB/SHOWER. 3/4" H & CW DOWN IN WALL IF SERVING BATHTUB AND SHOWER.
- 4 1/2" H & CW TO SINK AND DISHWASHER. PROVIDE 1/2"x3/8" STOP ON CW. PROVIDE 1/2"x3/8"x3/8" STOP ON HW. 3/8" H & CW TO SINK FAUCET, 3/8" HW TO DISHWASHER.
- DISPOSAL BELOW SINK WITH DISHWASHER WASTE CONNECTION. CONNECT DRAIN THRU AIR GAP TO DISPOSAL. DISPOSAL BY G.C. AND INSTALLED BY PLUMBING CONTRACTOR.
- 6 1/2" CW DOWN IN WALL TO ICE MAKER VALVE AND BOX.
- 7 WASHING MACHINE CONNECTION BOX 2" WASTE, 1/2" H & CW.
- DOMESTIC WATER RISER. PROVIDE ISOLATION VALVE, REMOTE READ SUB-METER, AND PRV IF REQUIRED. REFER TO RISER DIAGRAM FOR SIZES.
- 9 ELECTRIC WATER HEATER. REFER TO DETAILS AND SCHEDULE.
- $\langle 10 \rangle$  3" SANITARY WASTE/VENT RISER PER IPC SEC 910.
- (11) 3" SANITARY WASTE RISER.
- (12) 3" SANITARY VENT RISER.






PROJECT

Jordan & Skala Engineers Texas Firm Registration # F-4990 Checked By: RC

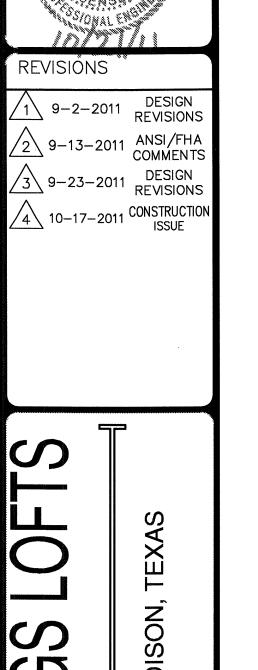


HONFANVONG

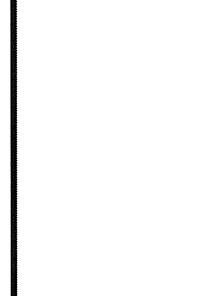


**BBGO** architects

08-05-1

11129 SHEET NUMBER

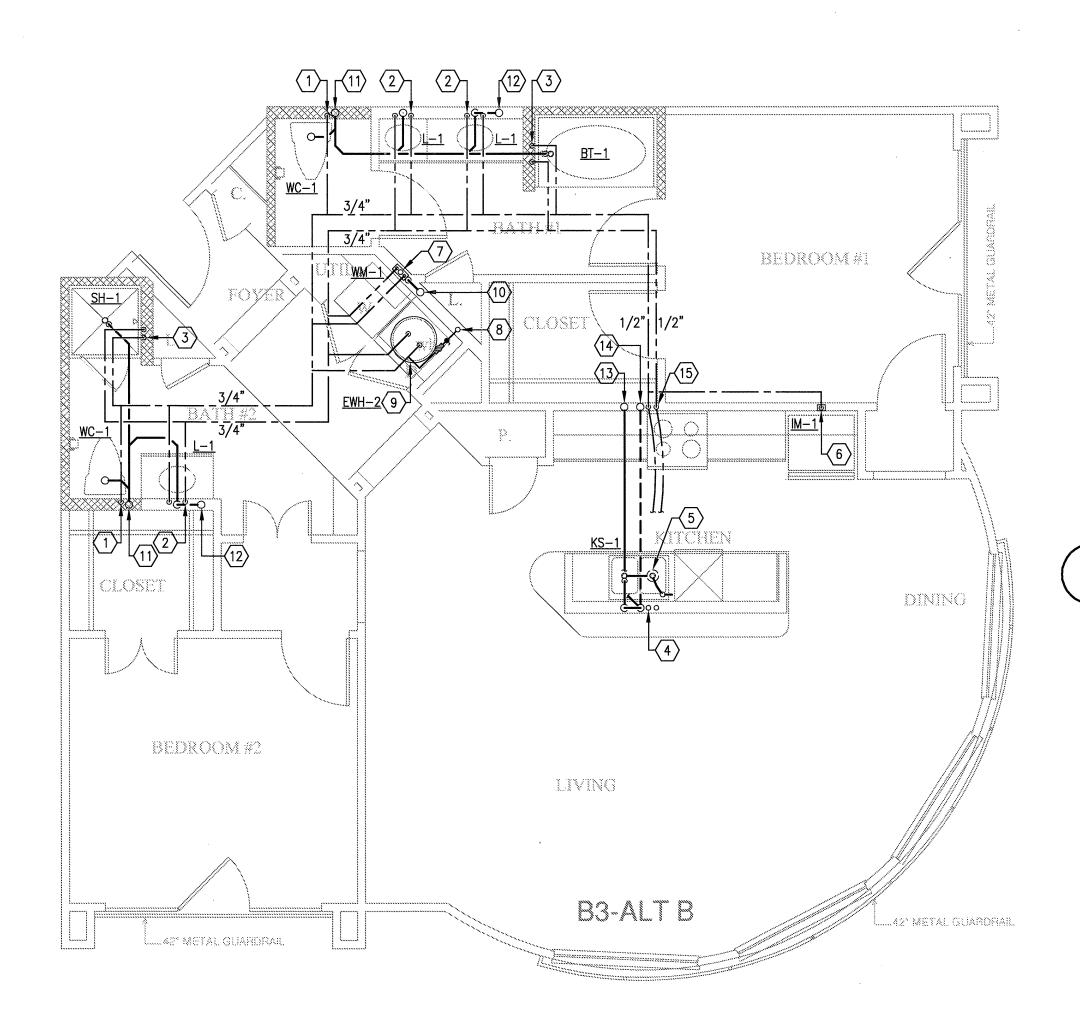



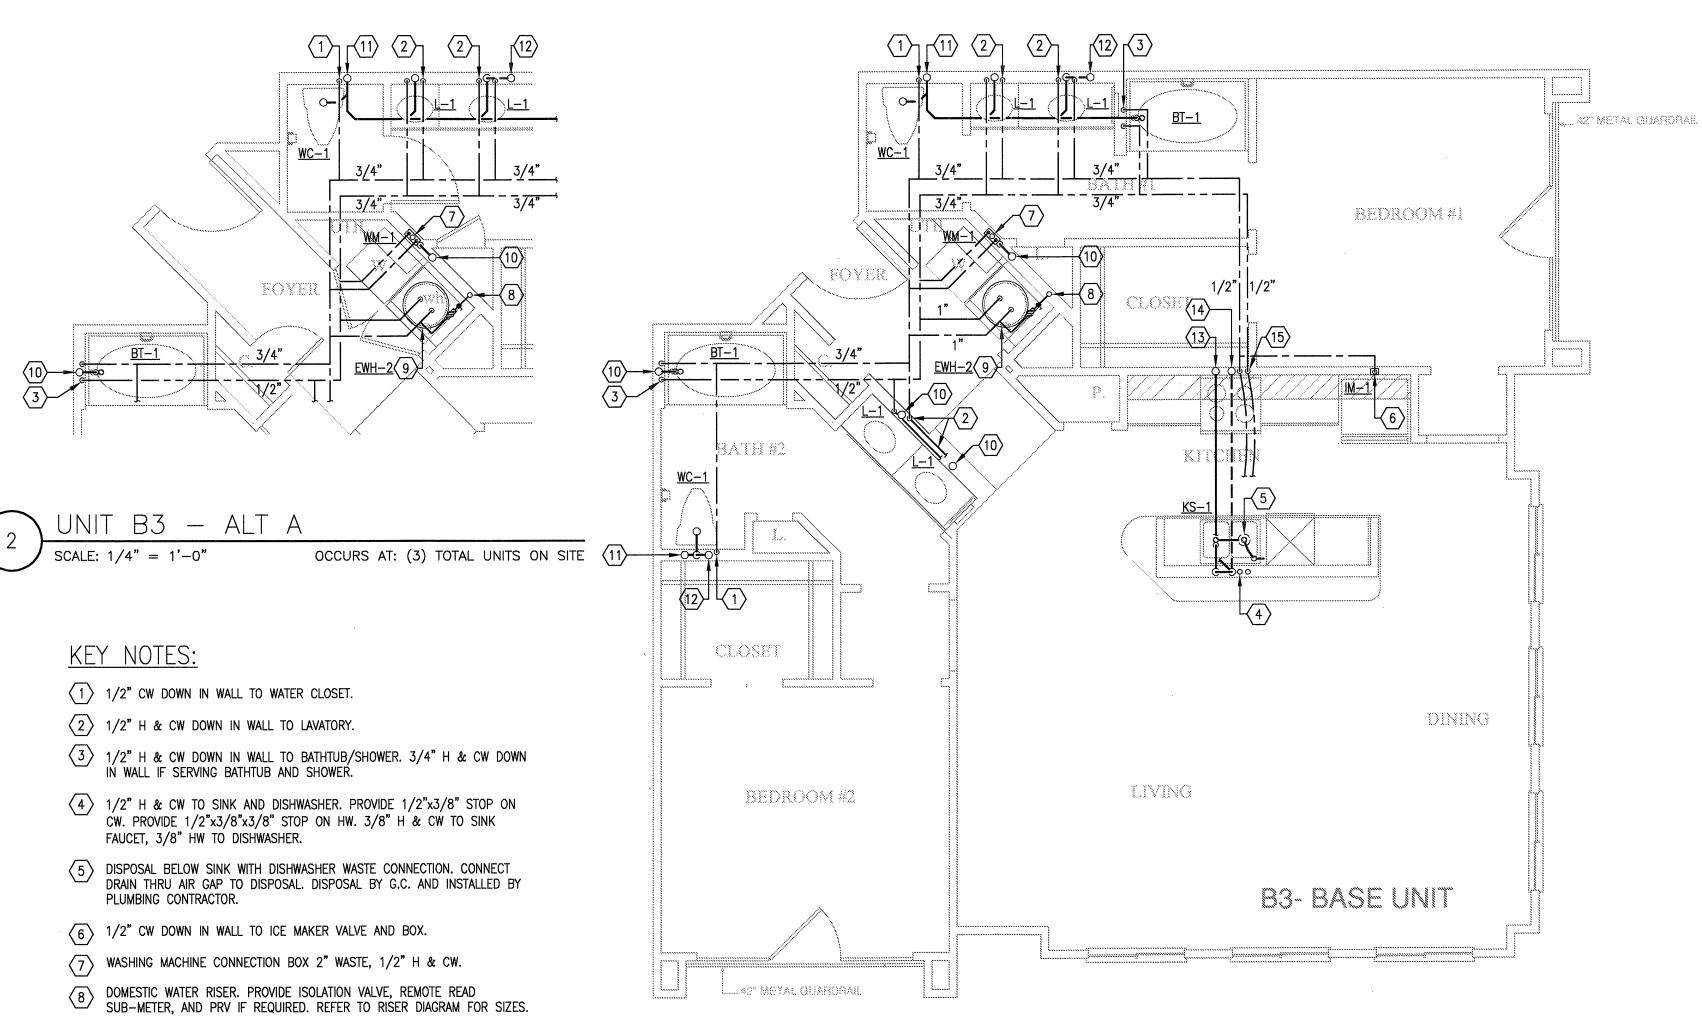

LLIAST MOTAL GUARDRAIL

9 ELECTRIC WATER HEATER. REFER TO DETAILS AND SCHEDULE.

15 1/2" H & CW DOWN IN WALL TO BELOW FLOOR TO SERVE ISLAND SINK.

(10) 3" SANITARY WASTE/VENT RISER PER IPC SEC 910.


(11) 3" SANITARY WASTE RISER.

(12) 3" SANITARY VENT RISER.

(13) 2" SANITARY WASTE RISER.

(14) 2" SANITARY VENT RISER.



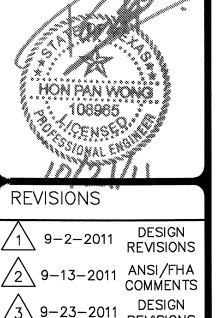

9-2-2011 DESIGN REVISIONS 9-13-2011 ANSI/FHA COMMENTS

3 9-23-2011 DESIGN REVISIONS

4 10-17-2011 CONSTRUCTION ISSUE



4144 N. Central Expy. Suite 855 Dallas, TX 75204 214.520.8878 bgoarchitects.com


08-05-1

PROJECT

SHEET NUMBER

P-2.9


Jordan & Skala Engineers 14248 Midwyy Roed, Suite 358 Dailw, FX 73244-5138 V: (469) 385-1616 F: (469) 385-1615 Texas Firm Registration # F-4990 Checked By: RC Drawn By: CV

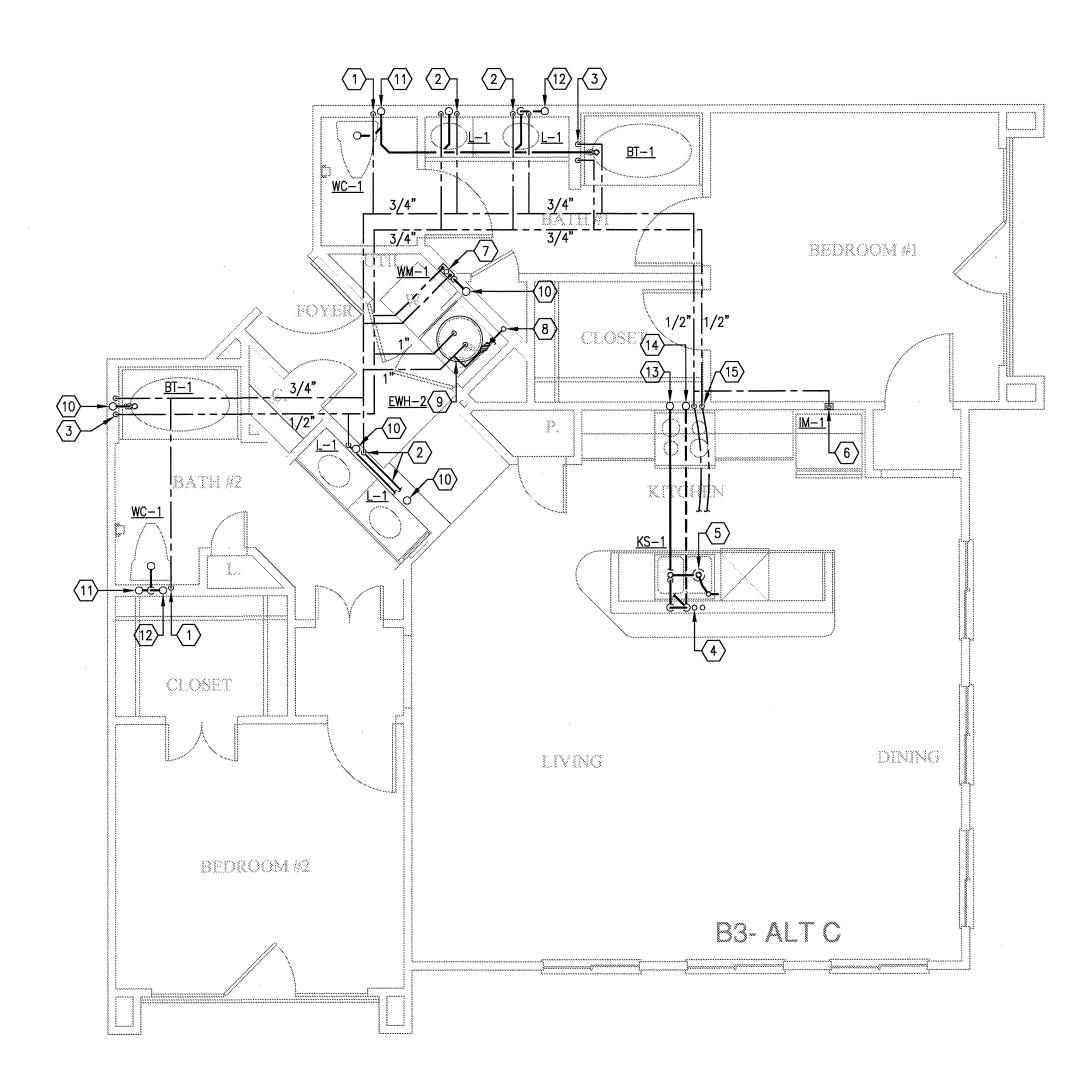

UNIT B3-1 - TWO BEDROOM/TWO BATH SCALE: 1/4" = 1'-0" OCCURS AT: (1) TOTAL UNITS ON SITE

# KEY NOTES:

- 1/2" CW DOWN IN WALL TO WATER CLOSET.
- 2 1/2" H & CW DOWN IN WALL TO LAVATORY.
- 3 1/2" H & CW DOWN IN WALL TO BATHTUB/SHOWER. 3/4" H & CW DOWN IN WALL IF SERVING BATHTUB AND SHOWER.
- 4 1/2" H & CW TO SINK AND DISHWASHER. PROVIDE 1/2"x3/8" STOP ON CW. PROVIDE 1/2"x3/8"x3/8" STOP ON HW. 3/8" H & CW TO SINK FAUCET, 3/8" HW TO DISHWASHER.
- DISPOSAL BELOW SINK WITH DISHWASHER WASTE CONNECTION. CONNECT DRAIN THRU AIR GAP TO DISPOSAL. DISPOSAL BY G.C. AND INSTALLED BY PLUMBING CONTRACTOR.
- 6 1/2" CW DOWN IN WALL TO ICE MAKER VALVE AND BOX.
- WASHING MACHINE CONNECTION BOX 2" WASTE, 1/2" H & CW.
- DOMESTIC WATER RISER. PROVIDE ISOLATION VALVE, REMOTE READ SUB-METER, AND PRV IF REQUIRED. REFER TO RISER DIAGRAM FOR SIZES.
- 9 ELECTRIC WATER HEATER. REFER TO DETAILS AND SCHEDULE.
- 3" SANITARY WASTE/VENT RISER PER IPC SEC 910.
- (11) 3" SANITARY WASTE RISER.
- (12) 3" SANITARY VENT RISER.
- (13) 2" SANITARY WASTE RISER.
- (14) 2" SANITARY VENT RISER.
- 15 1/2" H & CW DOWN IN WALL TO BELOW FLOOR TO SERVE ISLAND SINK.

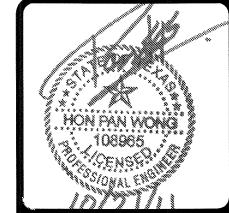

REVISIÔNS

9-2-2011 DESIGN REVISIONS 2 9-13-2011 ANSI/FHA COMMENTS 9-23-2011 DESIGN REVISIONS 4 10-17-2011 CONSTRUCTION ISSUE



4144 N. Central Expy. Suite 855 Dallas, TX 75204 214.520.8878 bgoarchitects.com

08-05-1


PROJECT

11129

SHEET NUMBER

P-2.10

Jordan & Skala Engineers 14240 Midway Road, Suite 350 Dallas, EX 75244-5138 V: (469) 385-1616 E: (469) 385-1615 Texas Firm Registration # F-4990 Checked By: RC

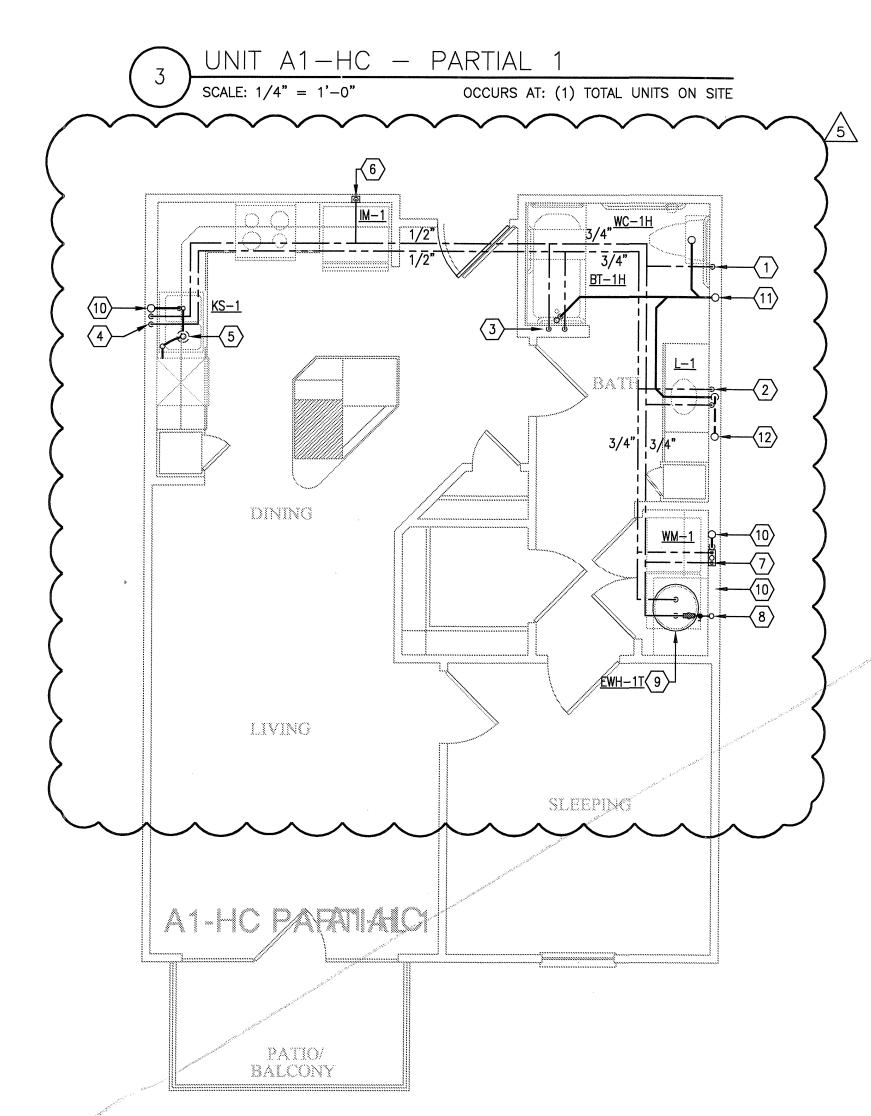

UNIT A1-HC - ONE SLEEPING/ONE BATH

OCCURS AT: (1) TOTAL UNITS ON SITE

KEY NOTES:

1) 1/2" CW DOWN IN WALL TO WATER CLOSET.

 $\bigcirc$  1/2" H & CW DOWN IN WALL TO LAVATORY.

3 1/2" H & CW DOWN IN WALL TO BATHTUB/SHOWER. 3/4" H & CW DOWN IN WALL IF SERVING BATHTUB AND SHOWER.

4 1/2" H & CW TO SINK AND DISHWASHER. PROVIDE 1/2"x3/8" STOP ON CW. PROVIDE 1/2"x3/8"x3/8" STOP ON HW. 3/8" H & CW TO SINK FAUCET, 3/8" HW TO DISHWASHER.

DISPOSAL BELOW SINK WITH DISHWASHER WASTE CONNECTION. CONNECT DRAIN THRU AIR GAP TO DISPOSAL. DISPOSAL BY G.C. AND INSTALLED BY PLUMBING CONTRACTOR.

6 1/2" CW DOWN IN WALL TO ICE MAKER VALVE AND BOX.

 $\overline{7}$  WASHING MACHINE CONNECTION BOX 2" WASTE, 1/2" H & CW.


DOMESTIC WATER RISER. PROVIDE ISOLATION VALVE, REMOTE READ SUB-METER, AND PRV IF REQUIRED. REFER TO RISER DIAGRAM FOR SIZES.

(9) ELECTRIC WATER HEATER. REFER TO DETAILS AND SCHEDULE.

(10) 3" SANITARY WASTE/VENT RISER PER IPC SEC 910.

 $\langle 11 \rangle$  3" SANITARY WASTE RISER.

(12) 3" SANITARY VENT RISER.

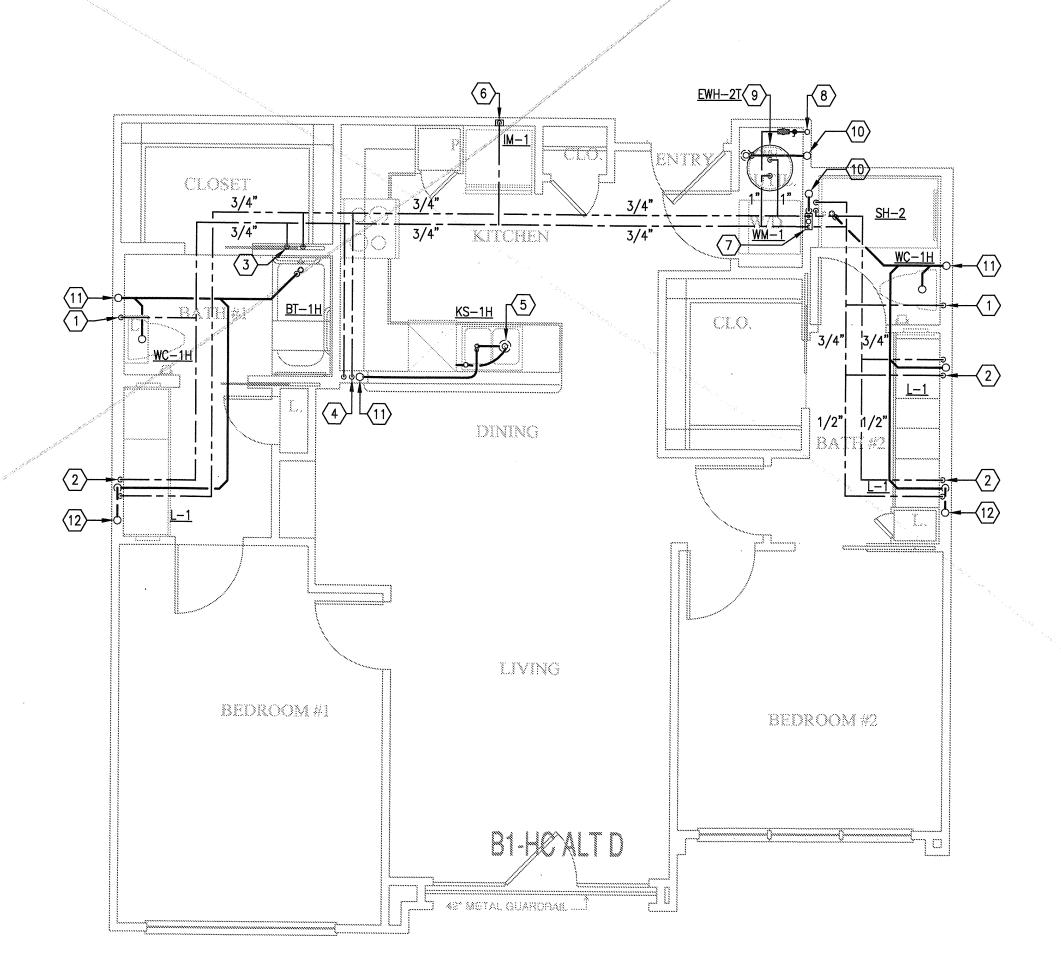

UNIT B1-HC-ALT D - TWO BEDROOM/TWO BATH OCCURS AT: (3) TOTAL UNITS ON SITE



REVISIONS

1 9-2-2011 DESIGN REVISIONS 2 9-13-2011 ANSI/FHA COMMENTS 3 9-23-2011 DESIGN REVISIONS

4 10-17-2011 CONSTRUCTION ISSUE

5 12-21-2011 DESIGN REVISIONS

BGO architects


4144 N. Central Expy. Suite 855 Dallas, TX 75204 214.520.8878 bgoarchitects.com


08-05-1

PROJECT

11129 SHEET NUMBER




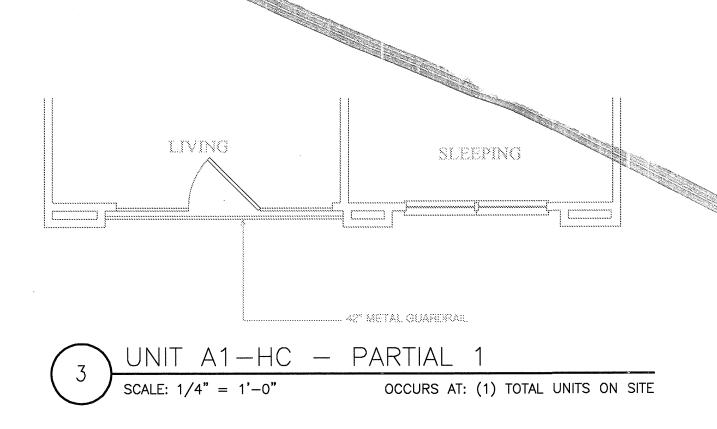

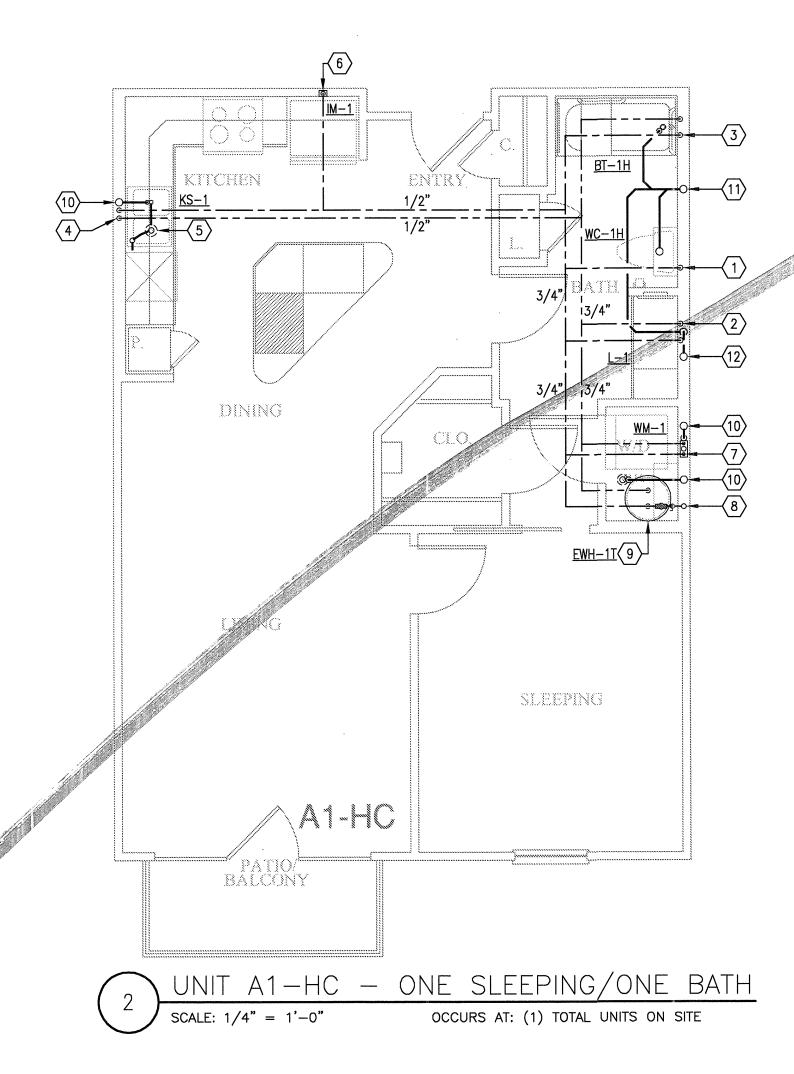




- $\bigcirc$  1/2" CW DOWN IN WALL TO WATER CLOSET.
- 2 1/2" H & CW DOWN IN WALL TO LAVATORY.
- 3 1/2" H & CW DOWN IN WALL TO BATHTUB/SHOWER. 3/4" H & CW DOWN IN WALL IF SERVING BATHTUB AND SHOWER.
- 4 1/2" H & CW TO SINK AND DISHWASHER. PROVIDE 1/2"x3/8" STOP ON CW. PROVIDE 1/2"x3/8"x3/8" STOP ON HW. 3/8" H & CW TO SINK FAUCET, 3/8" HW TO DISHWASHER.
- DISPOSAL BELOW SINK WITH DISHWASHER WASTE CONNECTION. CONNECT DRAIN THRU AIR GAP TO DISPOSAL. DISPOSAL BY G.C. AND INSTALLED BY PLUMBING CONTRACTOR.
- 6 1/2" CW DOWN IN WALL TO ICE MAKER VALVE AND BOX.
- 7 WASHING MACHINE CONNECTION BOX 2" WASTE, 1/2" H & CW.
- DOMESTIC WATER RISER. PROVIDE ISOLATION VALVE, REMOTE READ SUB-METER, AND PRV IF REQUIRED. REFER TO RISER DIAGRAM FOR SIZES.
- 9 ELECTRIC WATER HEATER. REFER TO DETAILS AND SCHEDULE.
- 3" SANITARY WASTE/VENT RISER PER IPC SEC 910.
- 3" SANITARY WASTE RISER.
- (12) 3" SANITARY VENT RISER.

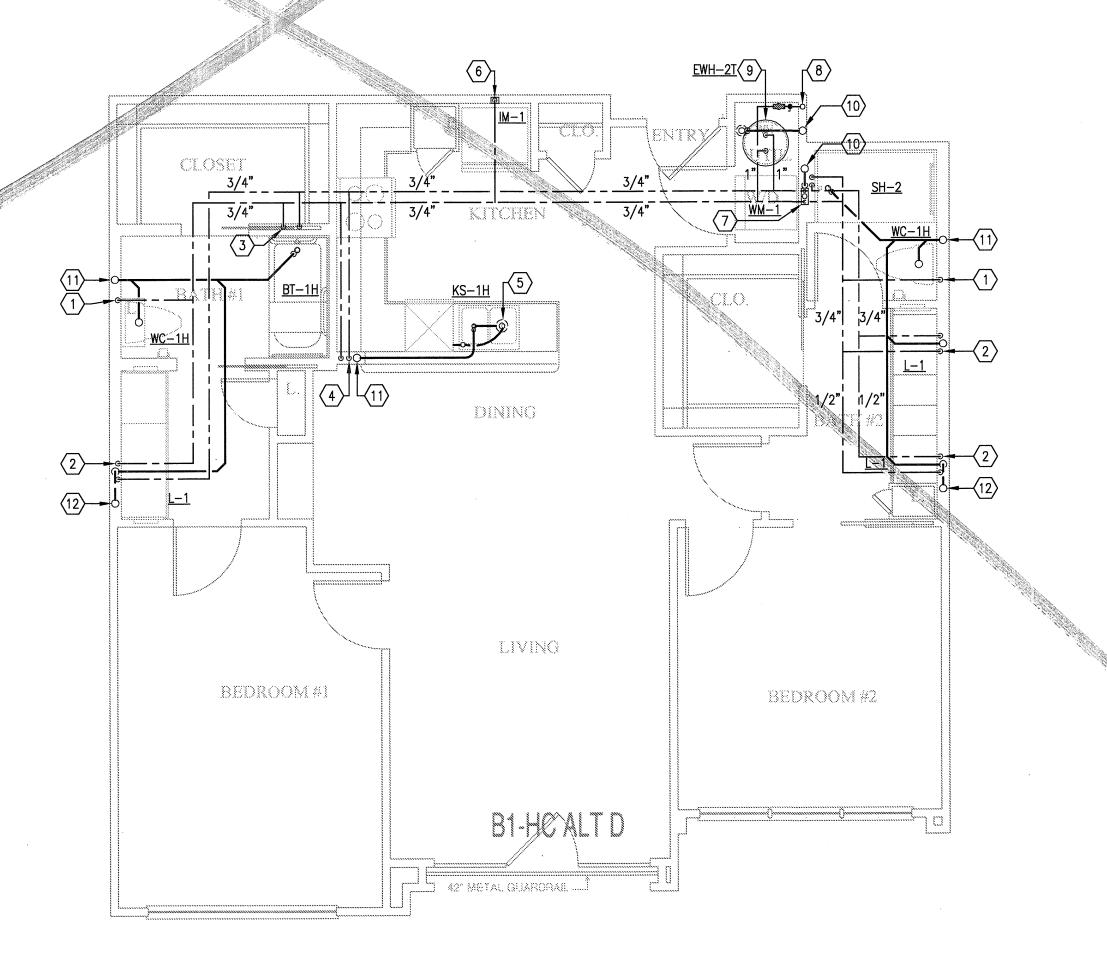

UNIT B1-HC-ALT D - TWO BEDROOM/TWO BATH OCCURS AT: (3) TOTAL UNITS ON SITE

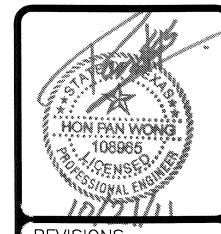

REVISIÔNS

1 9-2-2011 DESIGN REVISIONS 9-13-2011 ANSI/FHA COMMENTS

9-23-2011 DESIGN REVISIONS 4 10-17-2011 CONSTRUCTION ISSUE


BGO architects 4144 N. Central Expy. Suite 855 Dallas, TX 75204 214.520.8878 bgoarchitects.com

08-05-11

PROJECT


SHEET NUMBER



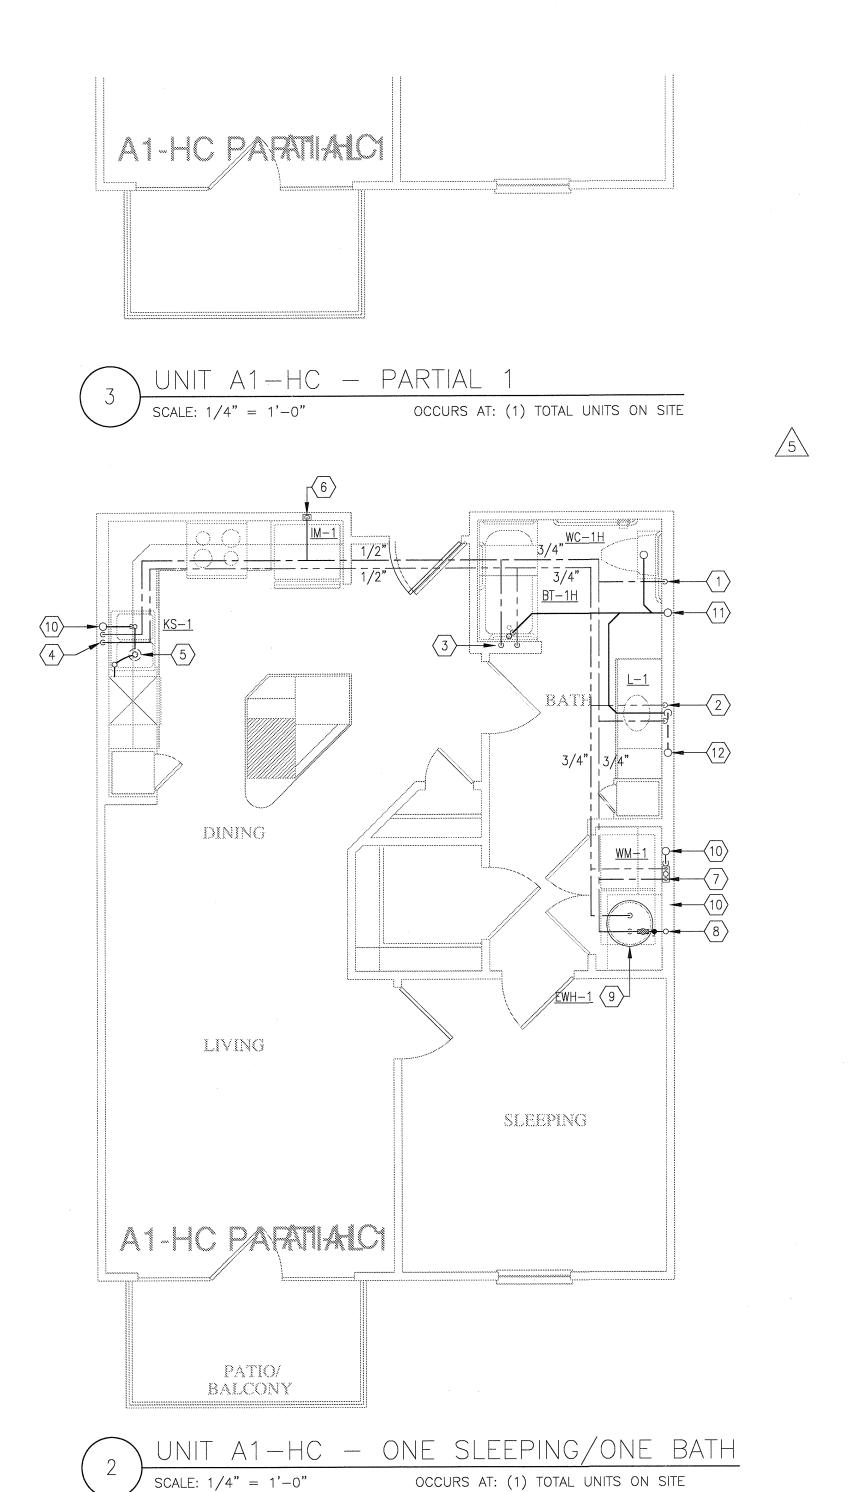

#### KEY NOTES:

- 1) 1/2" CW DOWN IN WALL TO WATER CLOSET.
- 2 1/2" H & CW DOWN IN WALL TO LAVATORY.
- 3 1/2" H & CW DOWN IN WALL TO BATHTUB/SHOWER. 3/4" H & CW DOWN IN WALL IF SERVING BATHTUB AND SHOWER.
- 4 1/2" H & CW TO SINK AND DISHWASHER. PROVIDE 1/2"x3/8" STOP ON CW. PROVIDE 1/2"x3/8"x3/8" STOP ON HW. 3/8" H & CW TO SINK FAUCET, 3/8" HW TO DISHWASHER.
- DISPOSAL BELOW SINK WITH DISHWASHER WASTE CONNECTION. CONNECT DRAIN THRU AIR GAP TO DISPOSAL. DISPOSAL BY G.C. AND INSTALLED BY PLUMBING CONTRACTOR.
- 6 1/2" CW DOWN IN WALL TO ICE MAKER VALVE AND BOX.
- 7 WASHING MACHINE CONNECTION BOX 2" WASTE, 1/2" H & CW.
- DOMESTIC WATER RISER. PROVIDE ISOLATION VALVE, REMOTE READ SUB-METER, AND PRV IF REQUIRED. REFER TO RISER DIAGRAM FOR SIZES.
- 9 ELECTRIC WATER HEATER. REFER TO DETAILS AND SCHEDULE.
- (10) .3" SANITARY WASTE/VENT RISER PER IPC SEC 910.
- (11) 3" SANITARY WASTE RISER.
- (12) 3" SANITARY VENT RISER.

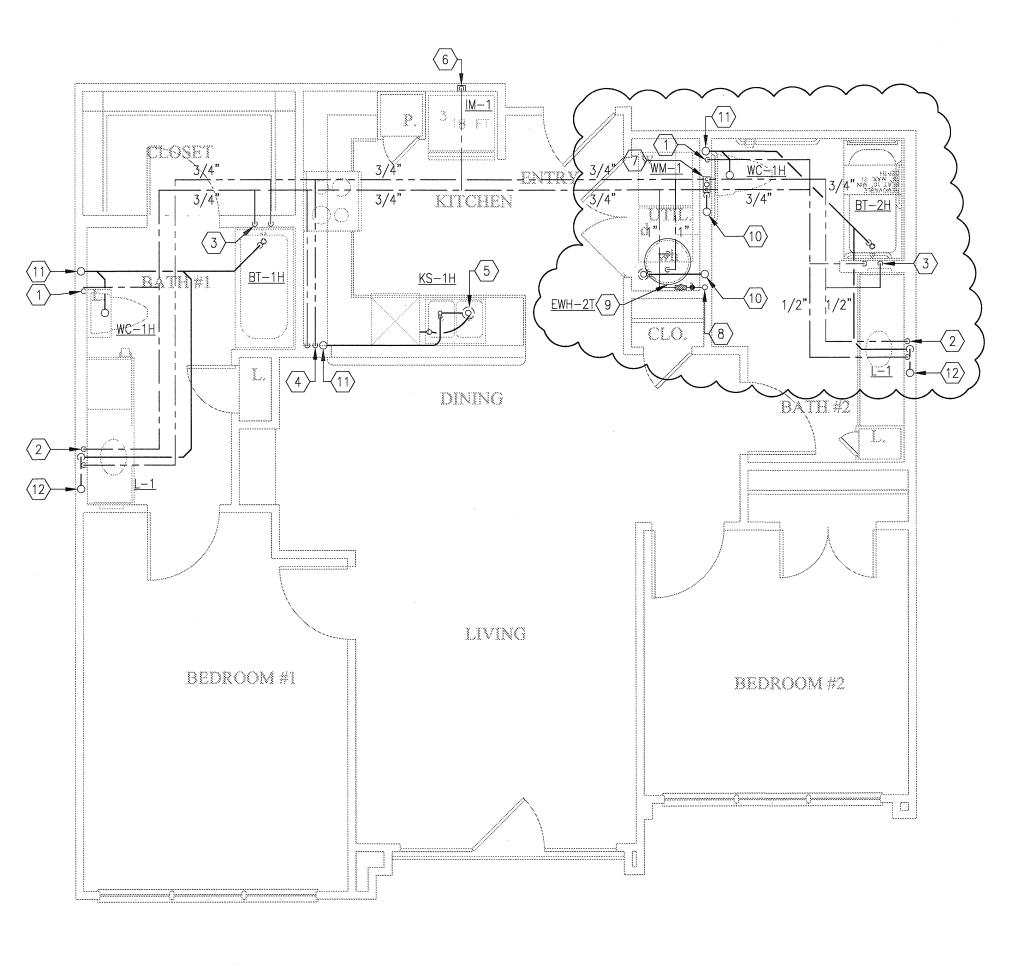

JNIT B1—HC—ALT D — TWO BEDROOM/TWO BATH OCCURS AT: (3) TOTAL UNITS ON SITE

REVISIONS

9-2-2011 DESIGN REVISIONS 2 9-13-2011 ANSI/FHA COMMENTS 3 9-23-2011 REVISIONS 10-17-2011 CONSTRUCTION

5 12-21-2011 REVISIONS 6 1-17-2012 REVISIONS TRANSFORME 7\ 2-15-2012 REVISIONS

8 3-27-2012 CLUBHOUSE REVISIONS 4-17-2012 COORDINATION

5-15-2012 COORDINATION 5-30-2012 SITE
COORDINATION

5-30-2012 SITE
COORDINATION

6-01-12 LIGHTING
REVISIONS

6-29-12 SITE
COORDINATION



4144 N. Central Expy. Suite 855 Dallas, TX 75204 214.520.8878 bgoarchitects.com

08-05-17

PROJECT


11129


P-2.11

SHEET NUMBER






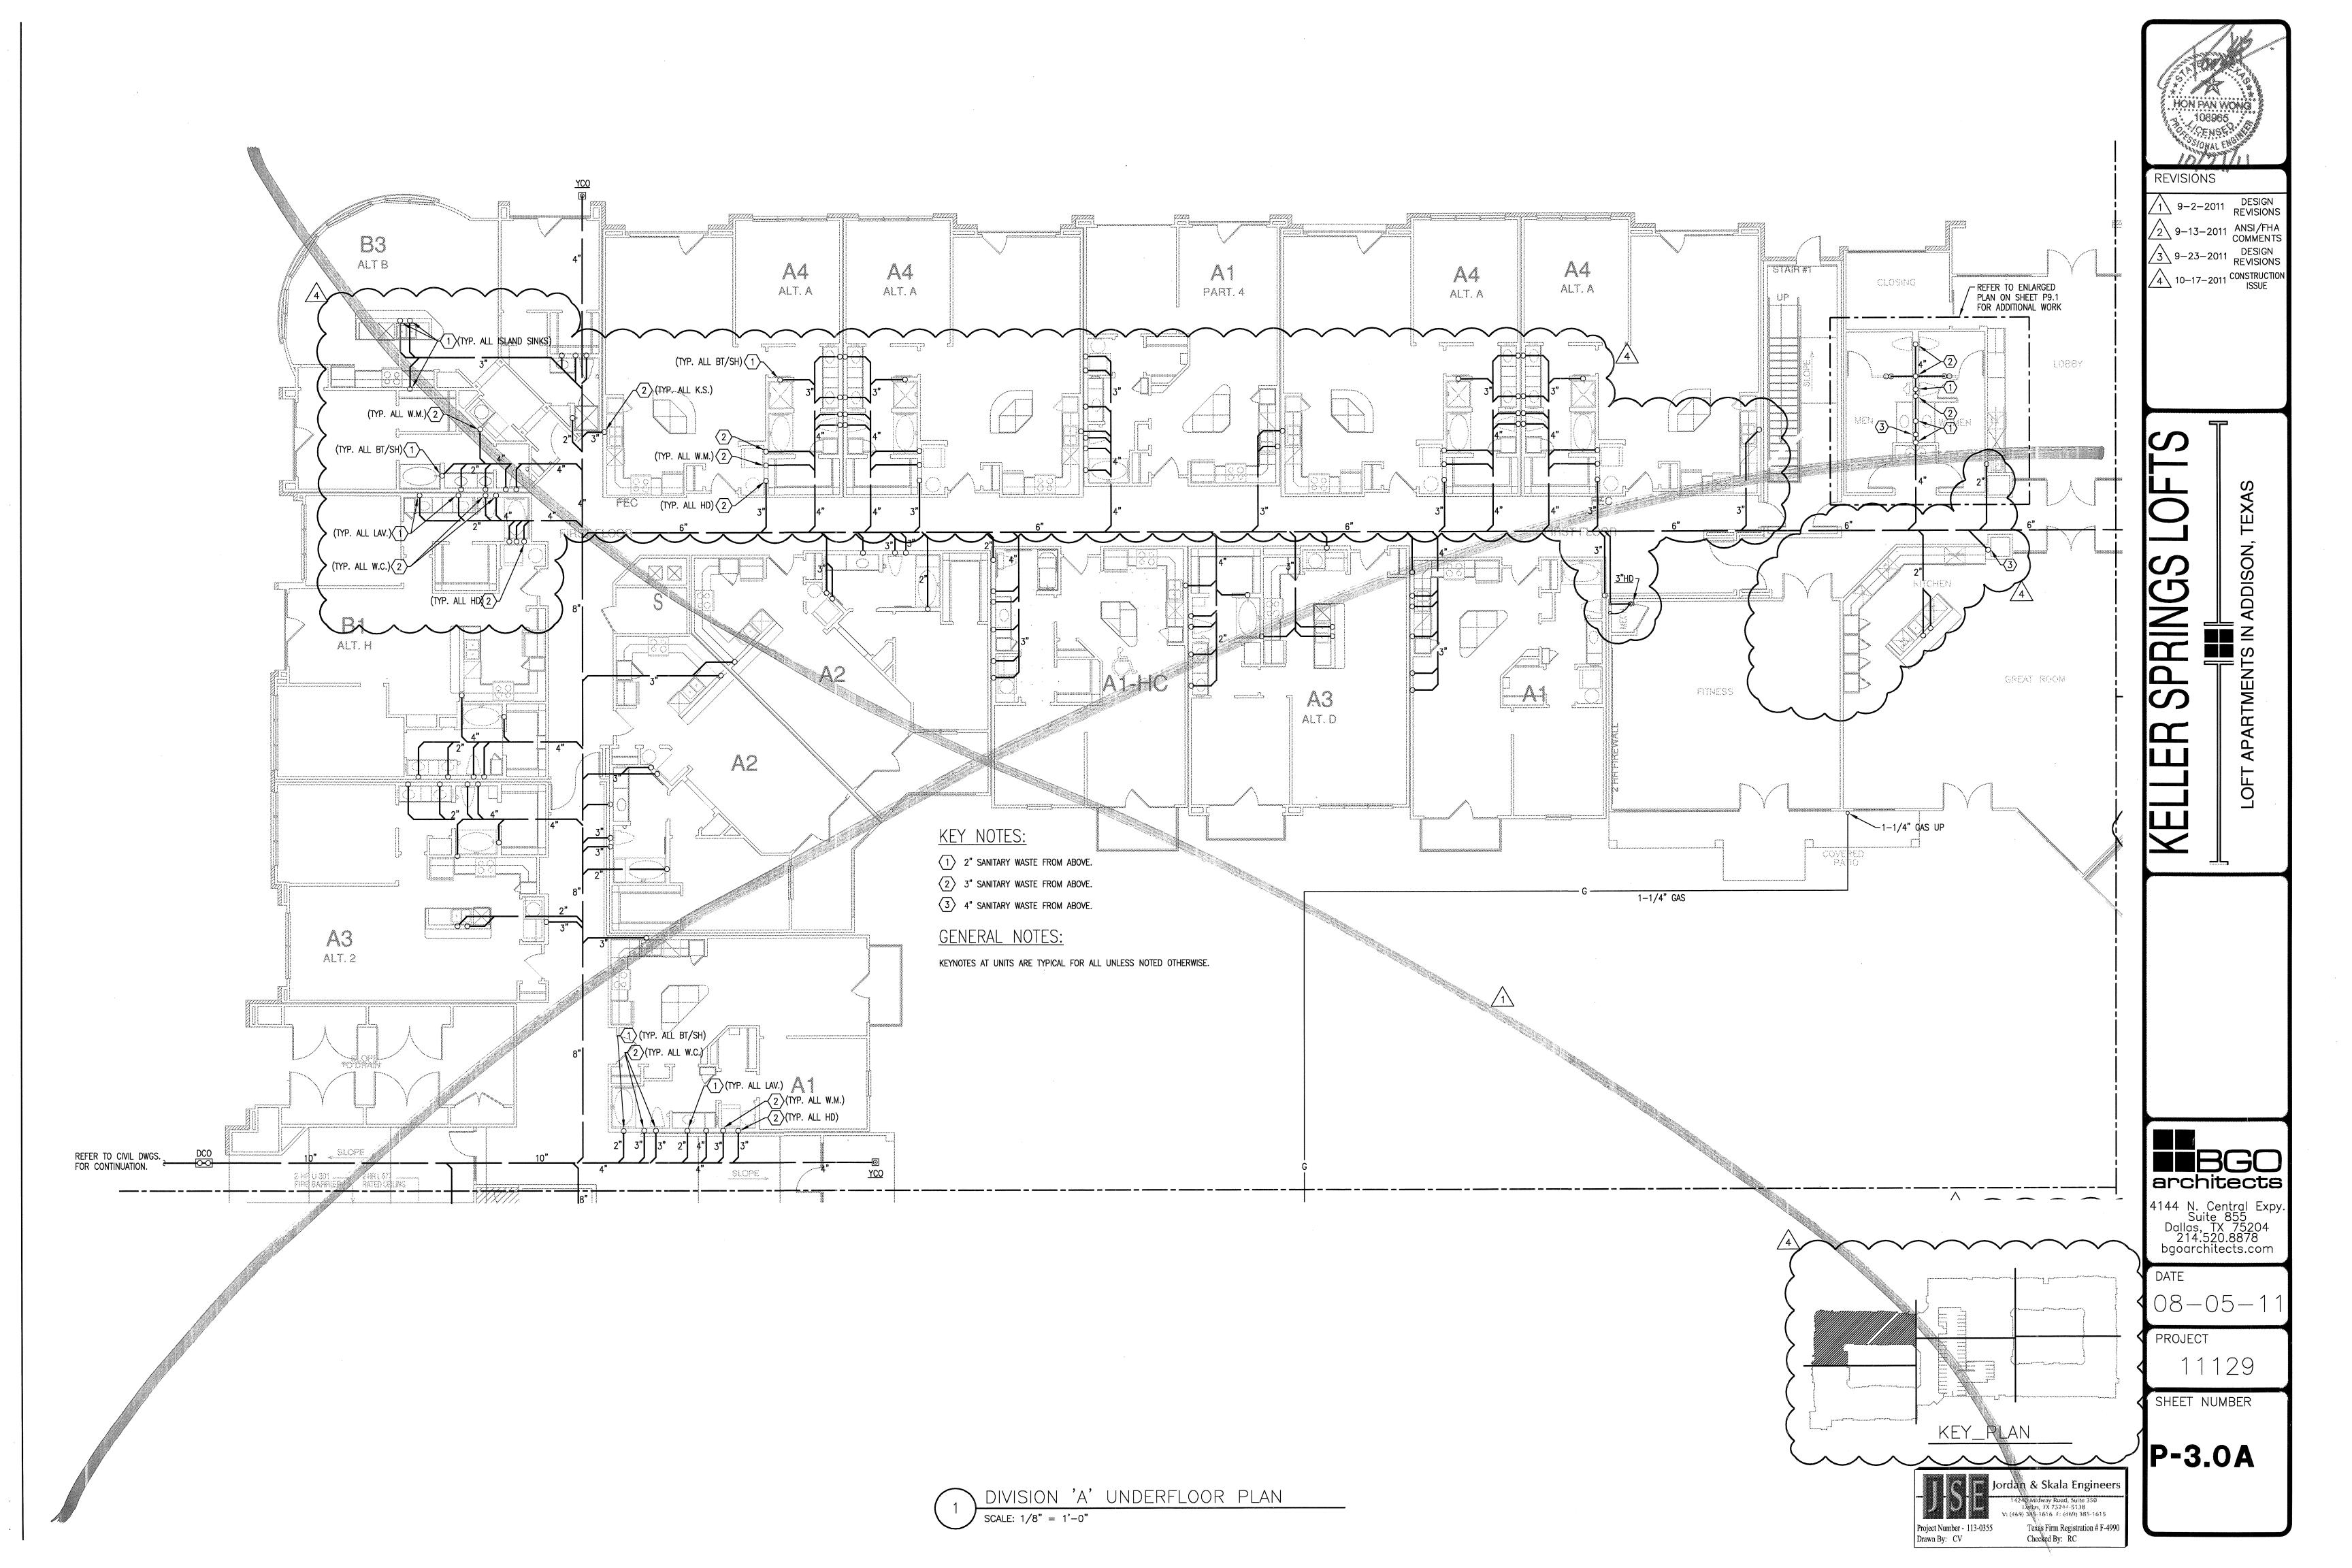

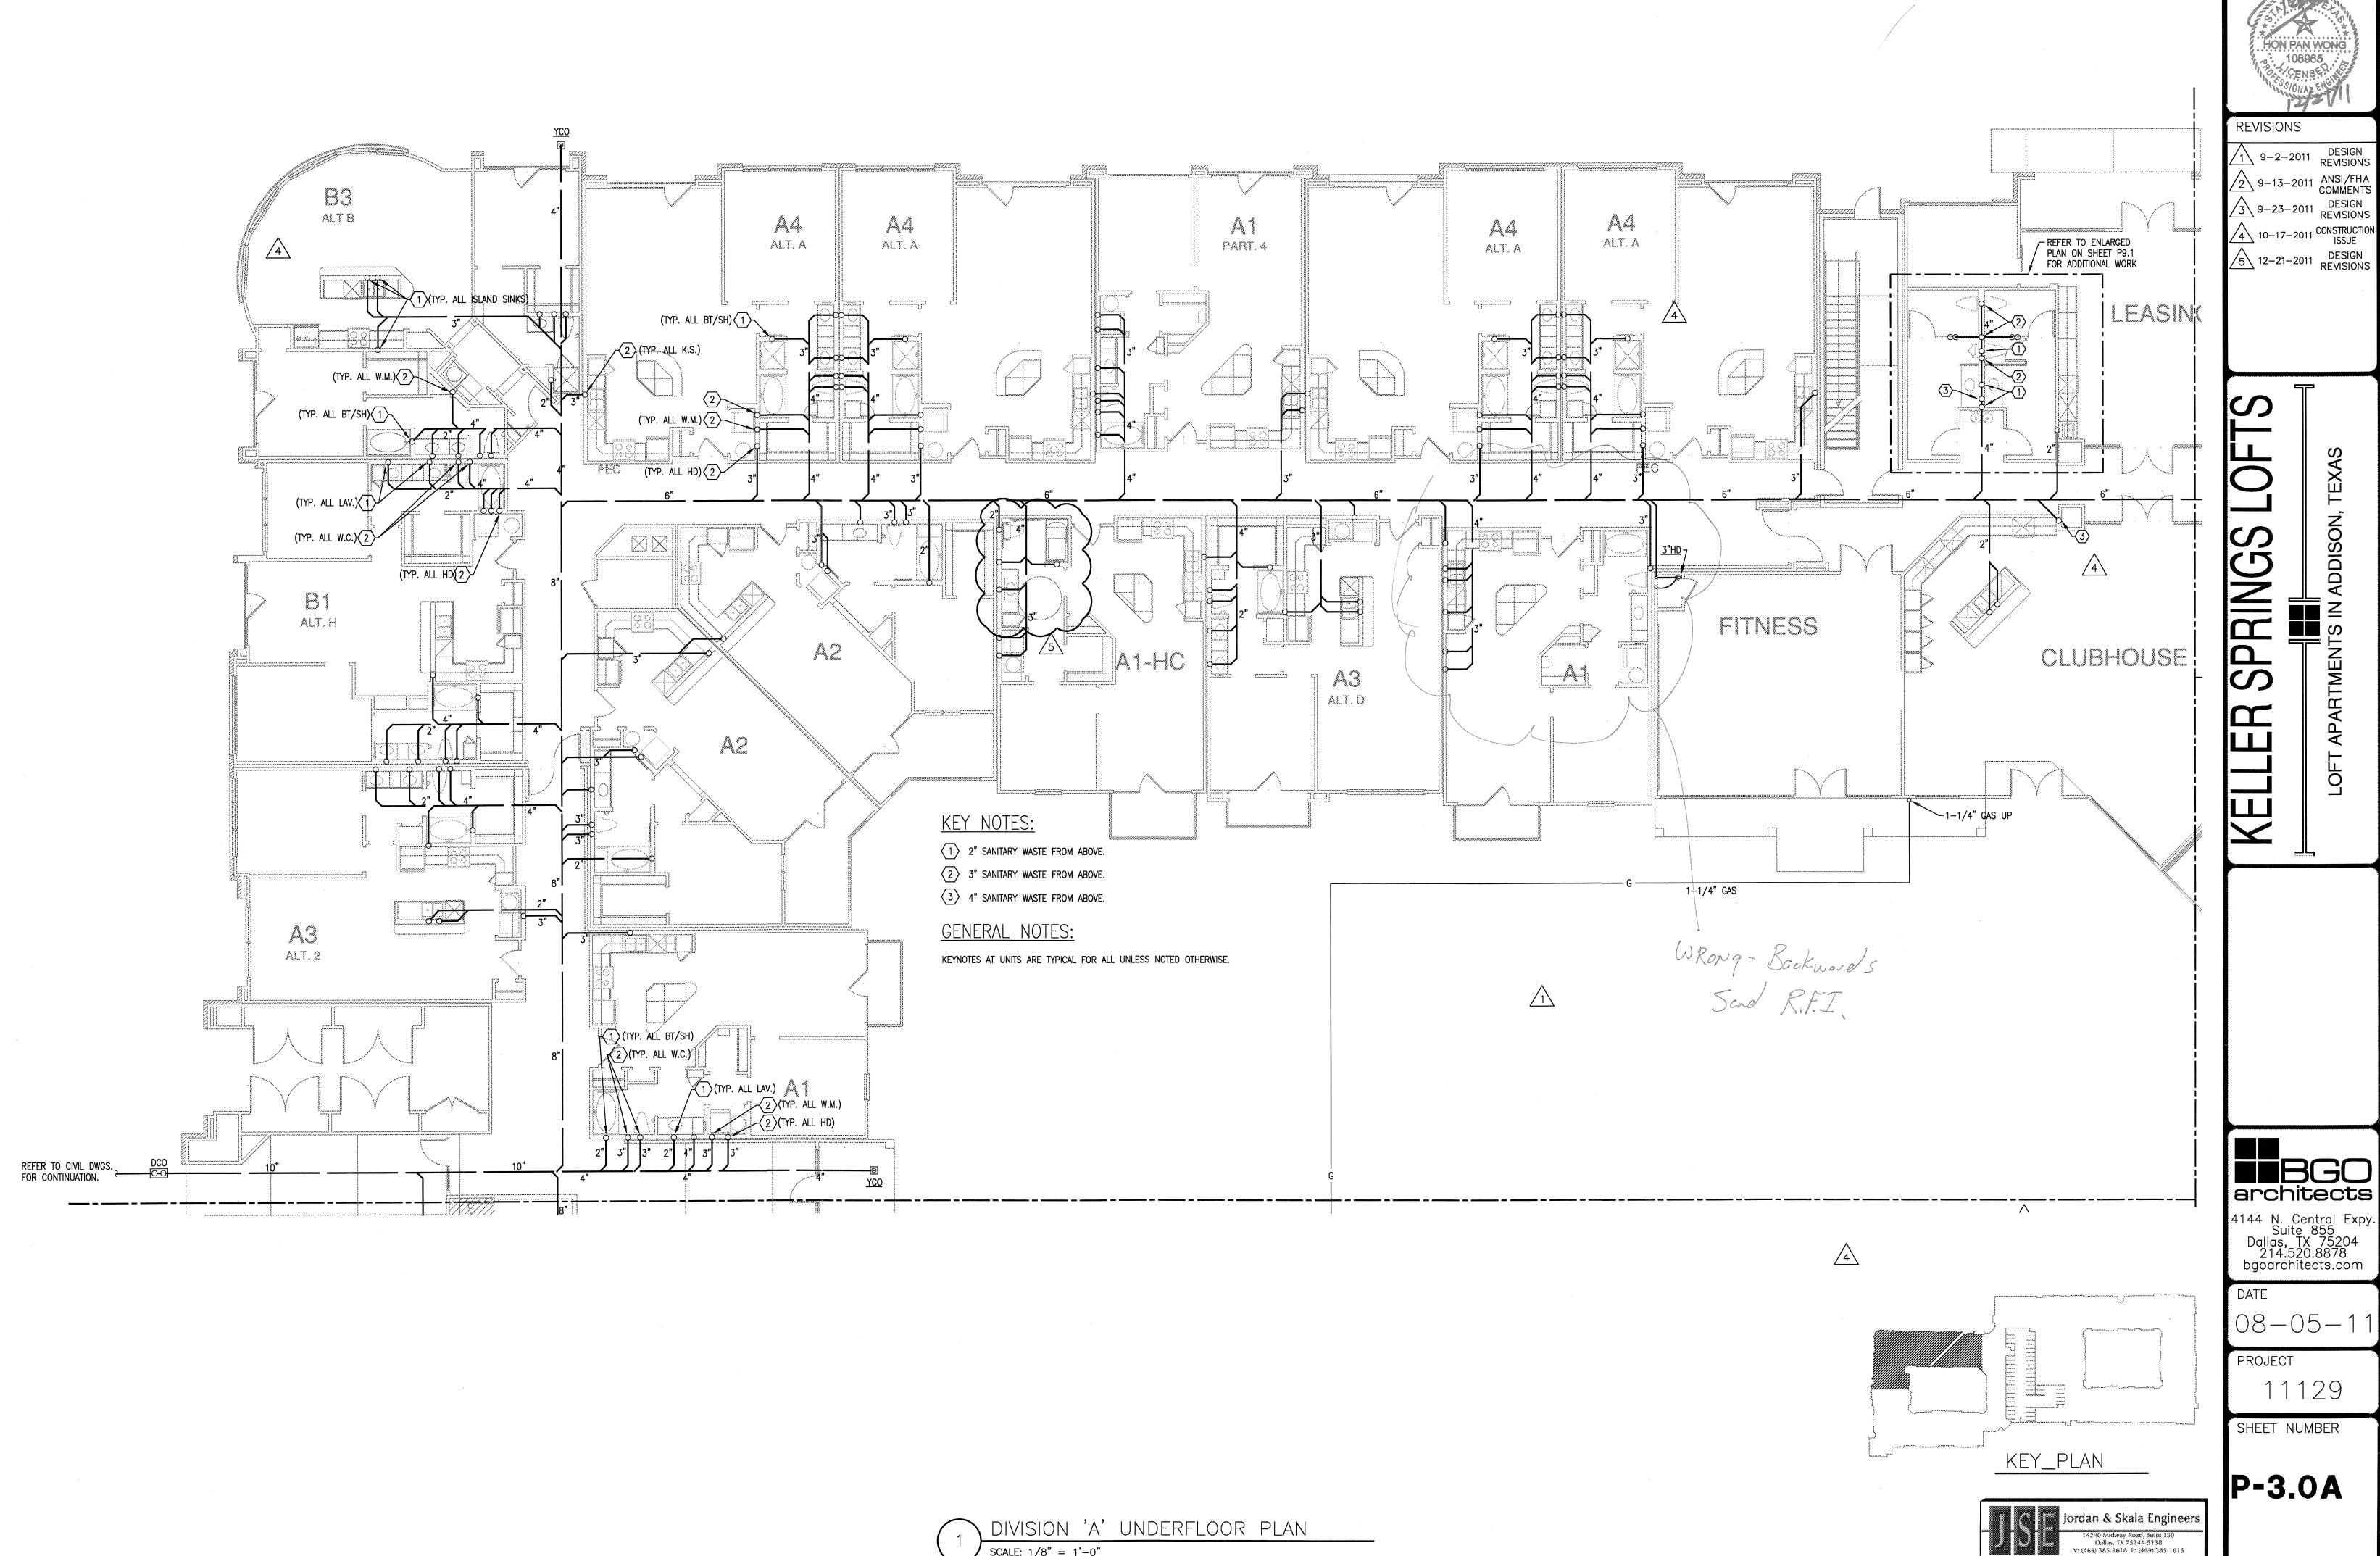

Texas Firm Registration # F-4990 Checked By: RC

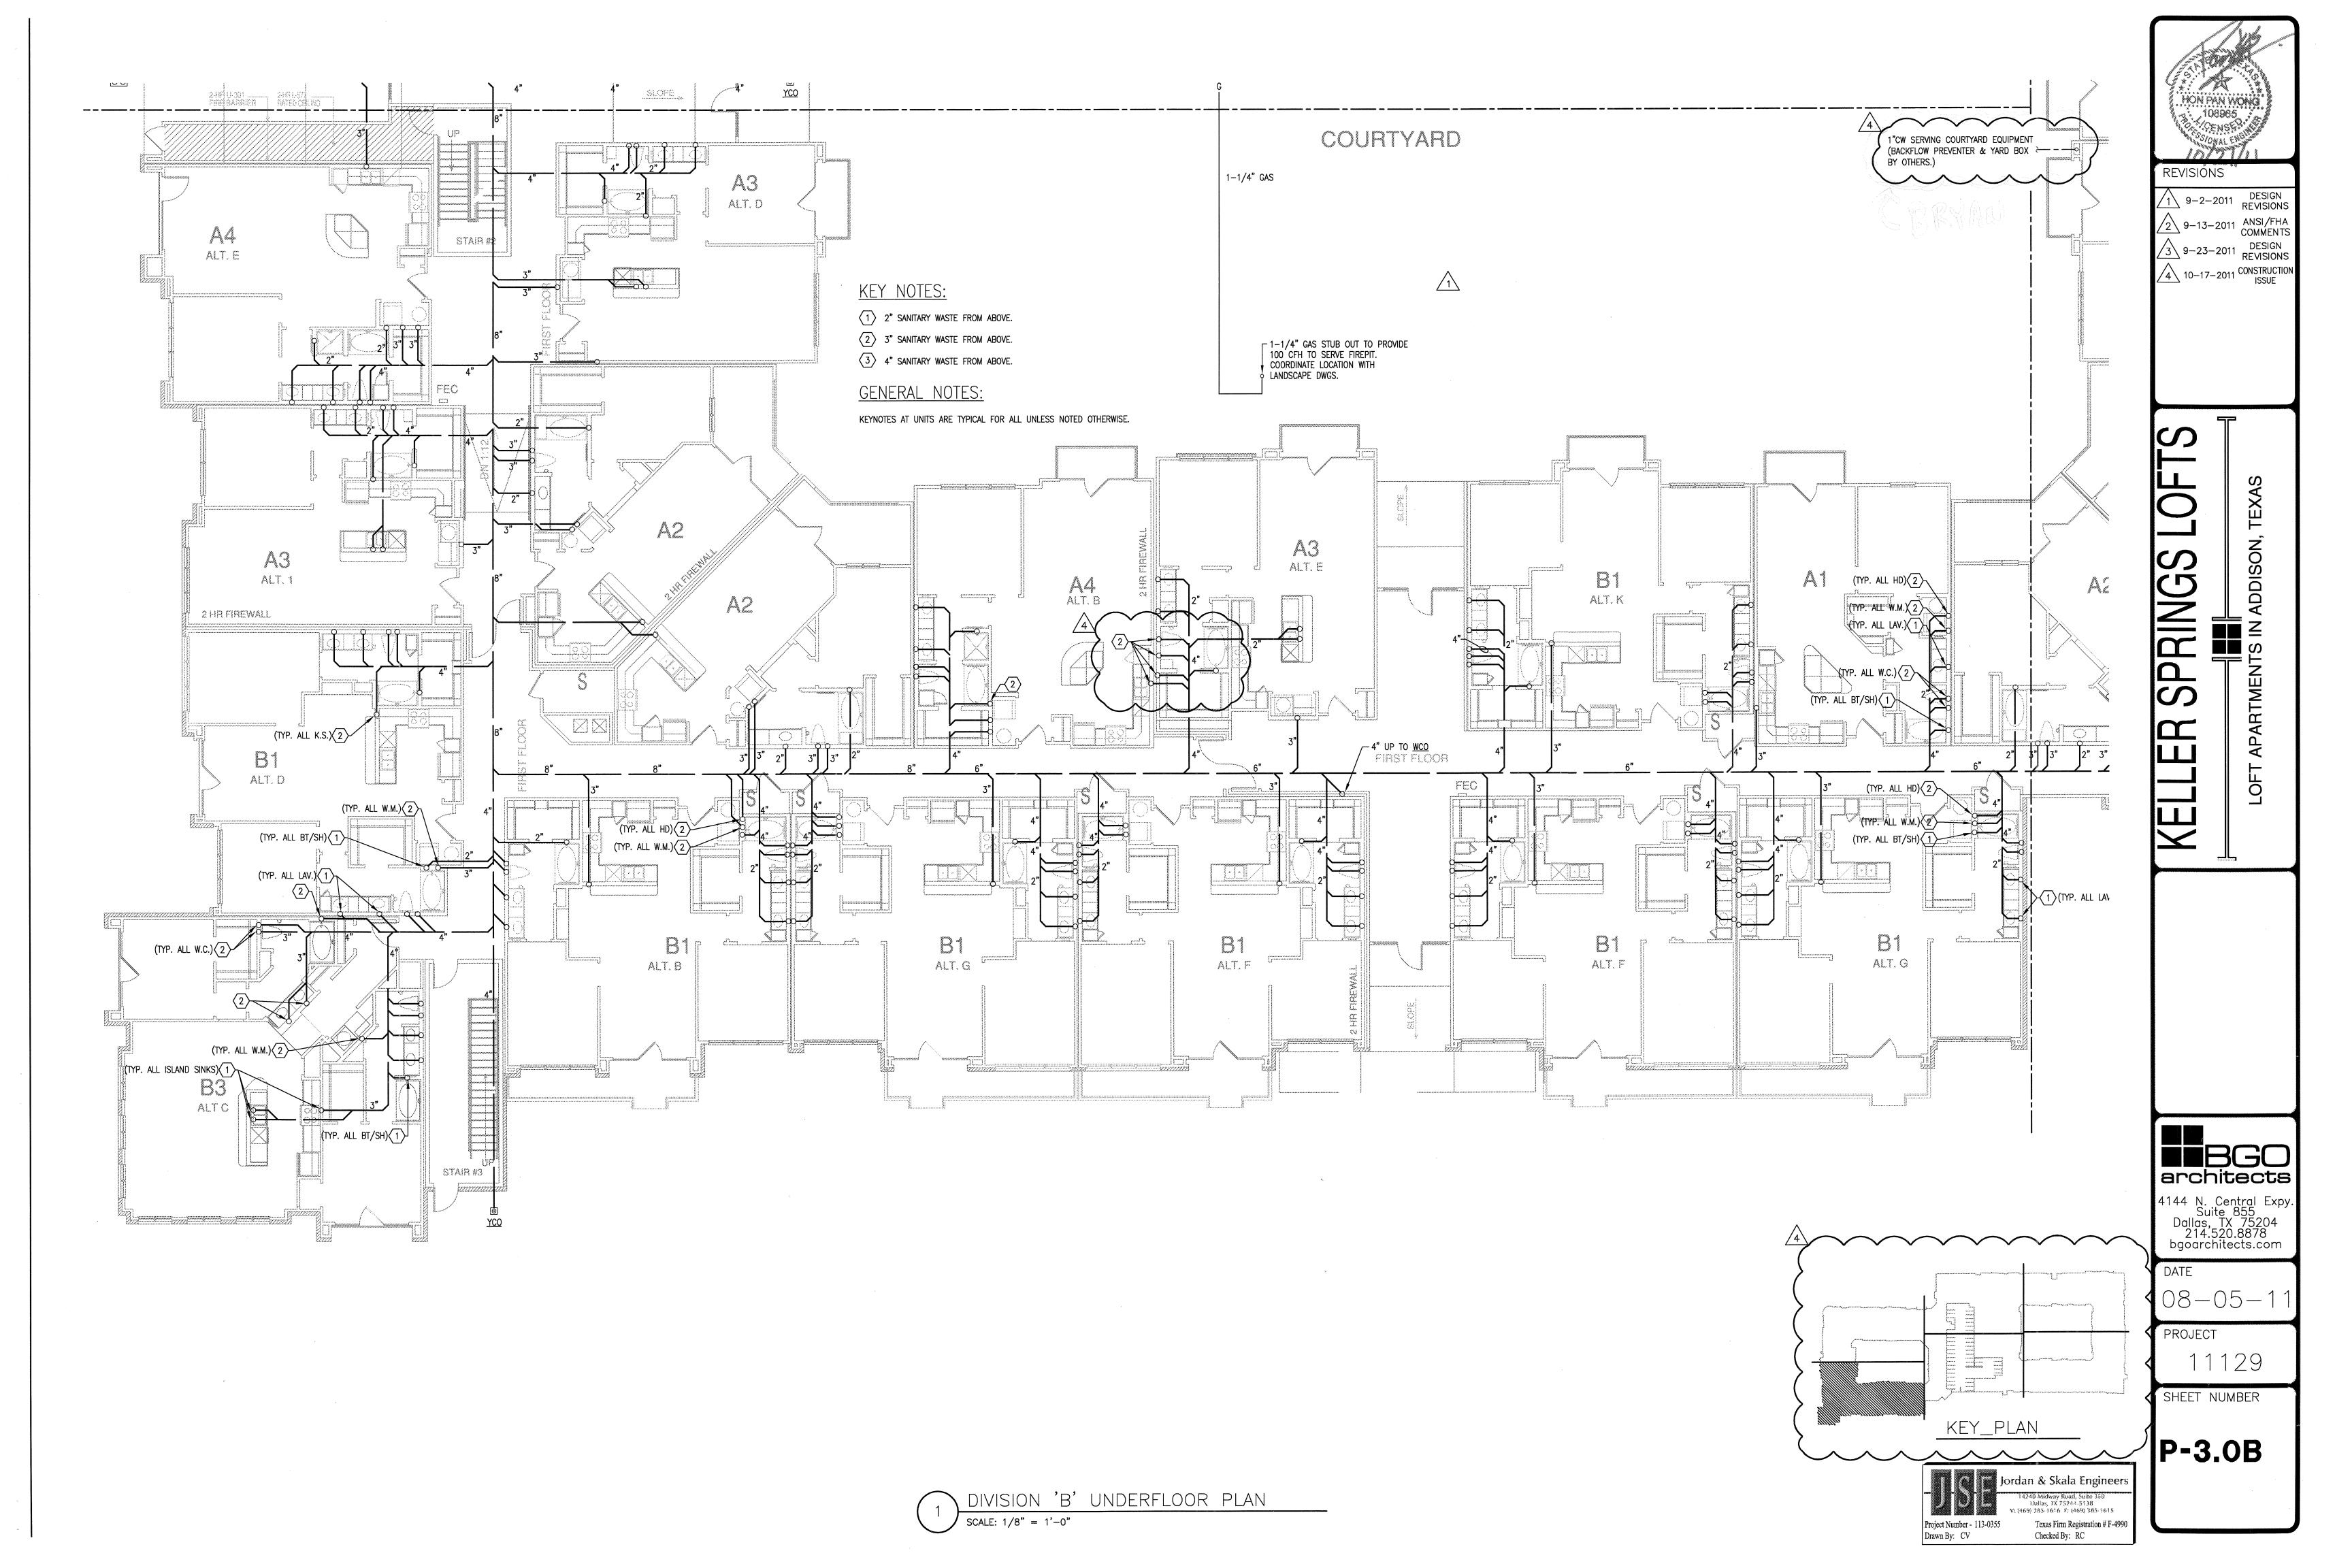

20 N. E. Loop 410, Suite 700 In Antonio, TX 78209 I : (210) 824-6044 Fax: (210) 824-7656	
Ţ	RFI
To: Jordan & Skala Engineers, Inc. 14240 Midway Road, Suite 350 Dallas, TX 75244 Ph: 469/385-1616 Fax: 469/385-1615	RFI #: 37  Date: 1/23/2012  Job: EB-02 Keller Springs Lofts  Phone: 877-777-5115
cc:	
Subject: 6" main sanitary trunk line	
of the garage. It joins another 6" running east along the is no designation as to the size of the line after that unto the size of this line either. I feel this may be an ove	running in the center of the corridors. It is 6" running north along the east side the north side of the garage. So we have a 6" joining with another 6" but there ntil it meets the 10" that leaves the building. Sheet P-3.0E gives no designation ersight and the intention would be to have the line enlarge to an 8" after the (2)
Cost Impact: None  Request:  On sheet P-3.0C the main sanitary trunk line is shown of the garage. It joins another 6" running east along the is no designation as to the size of the line after that unto the size of this line either. I feel this may be an over	Schedule Impact: None  Date Required: 1/2  a running in the center of the corridors. It is 6" running north along the east side the north side of the garage. So we have a 6" joining with another 6" but there titl it meets the 10" that leaves the building. Sheet P-3.0E gives no designation
Request:  On sheet P-3.0C the main sanitary trunk line is shown of the garage. It joins another 6" running east along the is no designation as to the size of the line after that unto the size of this line either. I feel this may be an ove 6" lines merge. Please advice and respond as we are Requested by:  Bryan Pickler  Embrey Partners, Ltd.	Schedule Impact: None  Date Required: 1/2  Trunning in the center of the corridors. It is 6" running north along the east side the north side of the garage. So we have a 6" joining with another 6" but there titl it meets the 10" that leaves the building. Sheet P-3.0E gives no designation trisight and the intention would be to have the line enlarge to an 8" after the (2)
Request: On sheet P-3.0C the main sanitary trunk line is shown of the garage. It joins another 6" running east along the is no designation as to the size of the line after that unto the size of this line either. I feel this may be an ove 6" lines merge. Please advice and respond as we are Requested by:  Bryan Pickler	Date Required: 1/2 prunning in the center of the corridors. It is 6" running north along the east side the north side of the garage. So we have a 6" joining with another 6" but there not it it meets the 10" that leaves the building. Sheet P-3.0E gives no designation easight and the intention would be to have the line enlarge to an 8" after the (2) agoing to be installing these lines in the next two days.
Request:  On sheet P-3.0C the main sanitary trunk line is shown of the garage. It joins another 6" running east along the is no designation as to the size of the line after that unto the size of this line either. I feel this may be an ove 6" lines merge. Please advice and respond as we are Requested by:  Bryan Pickler  Embrey Partners, Ltd.  Response:	Date Required: 1/2 prunning in the center of the corridors. It is 6" running north along the east side the north side of the garage. So we have a 6" joining with another 6" but there not it it meets the 10" that leaves the building. Sheet P-3.0E gives no designation easight and the intention would be to have the line enlarge to an 8" after the (2) agoing to be installing these lines in the next two days.
Request:  On sheet P-3.0C the main sanitary trunk line is shown of the garage. It joins another 6" running east along the is no designation as to the size of the line after that unto the size of this line either. I feel this may be an ove 6" lines merge. Please advice and respond as we are  Requested by: Bryan Pickler Embrey Partners, Ltd.  Response:  The line should increase to an 8" once the two 6"	Date Required: 1/2 prunning in the center of the corridors. It is 6" running north along the east side the north side of the garage. So we have a 6" joining with another 6" but there not it it meets the 10" that leaves the building. Sheet P-3.0E gives no designation easight and the intention would be to have the line enlarge to an 8" after the (2) agoing to be installing these lines in the next two days.
Request:  On sheet P-3.0C the main sanitary trunk line is shown of the garage. It joins another 6" running east along the is no designation as to the size of the line after that unto the size of this line either. I feel this may be an ove 6" lines merge. Please advice and respond as we are  Requested by: Bryan Pickler Embrey Partners, Ltd.  Response:  The line should increase to an 8" once the two 6"	Date Required: 1/2 prunning in the center of the corridors. It is 6" running north along the east side the north side of the garage. So we have a 6" joining with another 6" but there not it it meets the 10" that leaves the building. Sheet P-3.0E gives no designation easight and the intention would be to have the line enlarge to an 8" after the (2) agoing to be installing these lines in the next two days.
Request:  On sheet P-3.0C the main sanitary trunk line is shown of the garage. It joins another 6" running east along the is no designation as to the size of the line after that unto the size of this line either. I feel this may be an ove 6" lines merge. Please advice and respond as we are  Requested by: Bryan Pickler Embrey Partners, Ltd.  Response:  The line should increase to an 8" once the two 6"	Date Required: 1/2 prunning in the center of the corridors. It is 6" running north along the east side the north side of the garage. So we have a 6" joining with another 6" but there not it it meets the 10" that leaves the building. Sheet P-3.0E gives no designation easight and the intention would be to have the line enlarge to an 8" after the (2) agoing to be installing these lines in the next two days.
Request:  On sheet P-3.0C the main sanitary trunk line is shown of the garage. It joins another 6" running east along the is no designation as to the size of the line after that unto the size of this line either. I feel this may be an ove 6" lines merge. Please advice and respond as we are  Requested by: Bryan Pickler Embrey Partners, Ltd.  Response:  The line should increase to an 8" once the two 6"	Date Required: 1/2 prunning in the center of the corridors. It is 6" running north along the east side the north side of the garage. So we have a 6" joining with another 6" but there not it it meets the 10" that leaves the building. Sheet P-3.0E gives no designation easight and the intention would be to have the line enlarge to an 8" after the (2) agoing to be installing these lines in the next two days.
Request:  On sheet P-3.0C the main sanitary trunk line is shown of the garage. It joins another 6" running east along the is no designation as to the size of the line after that unto the size of this line either. I feel this may be an ove 6" lines merge. Please advice and respond as we are  Requested by: Bryan Pickler Embrey Partners, Ltd.  Response:  The line should increase to an 8" once the two 6"	Date Required: 1/2 prunning in the center of the corridors. It is 6" running north along the east side the north side of the garage. So we have a 6" joining with another 6" but there not it it meets the 10" that leaves the building. Sheet P-3.0E gives no designation easight and the intention would be to have the line enlarge to an 8" after the (2) agoing to be installing these lines in the next two days.
Request:  On sheet P-3.0C the main sanitary trunk line is shown of the garage. It joins another 6" running east along the is no designation as to the size of the line after that unto the size of this line either. I feel this may be an ove 6" lines merge. Please advice and respond as we are  Requested by: Bryan Pickler Embrey Partners, Ltd.  Response:  The line should increase to an 8" once the two 6"	Date Required: 1/2 prunning in the center of the corridors. It is 6" running north along the east side the north side of the garage. So we have a 6" joining with another 6" but there not it it meets the 10" that leaves the building. Sheet P-3.0E gives no designation easight and the intention would be to have the line enlarge to an 8" after the (2) agoing to be installing these lines in the next two days.

EMBREY BUILDERS, LLC.

1020 N. E. Loop 410, Suite 700 San Antonio, TX 78209 Ph : (210) 824-6044 Fax: (210) 824-7656

RFI

To: Jordan & Skala Engineers, Inc. 14240 Midway Road, Suite 350 RFI #: 51

Dallas, TX 75244 Ph: 469/385-1616 Fax: 469/385-1615

Date: 2/7/2012 Job: EB-02 Keller Springs Lofts Phone: 877-777-5115

cc: David Gallagher (Embrey Build (Embrey Construction LLC)

Subject: Pool and fountain equipment drain requirements

Drawing: landscape 5C

Spec Section: Schedule Impact: None

Cost Impact: None

Date Required: 2/14/2012 Request: Jordan and Skala, In discussing the courtyards fountain and pool equipment requirements with our pool contractor, it has come to our attention that since the pool equipment will have a chlorinated filter system, by code, we are required to run that into the sanitary sewer. The fact that the fountain equipment is run with a non-chlorinated system, the pool contractor believes that the fountain equipment can be run into the existing storm sewer system in the fountain courtyard. Therefore we need Jordan and Skala to revise the plans accordingly.

Please reference landscape sheet 5C of 9 for pool equipment location.

Requested by: Bryan Pickler


Embrey Partners, Ltd.

A 6" sanitary waste line has been routed to pool equipment area for pool drainage. See attached sketch.

Russell Cox Answered by

SK-P1 

Page 1 of 1

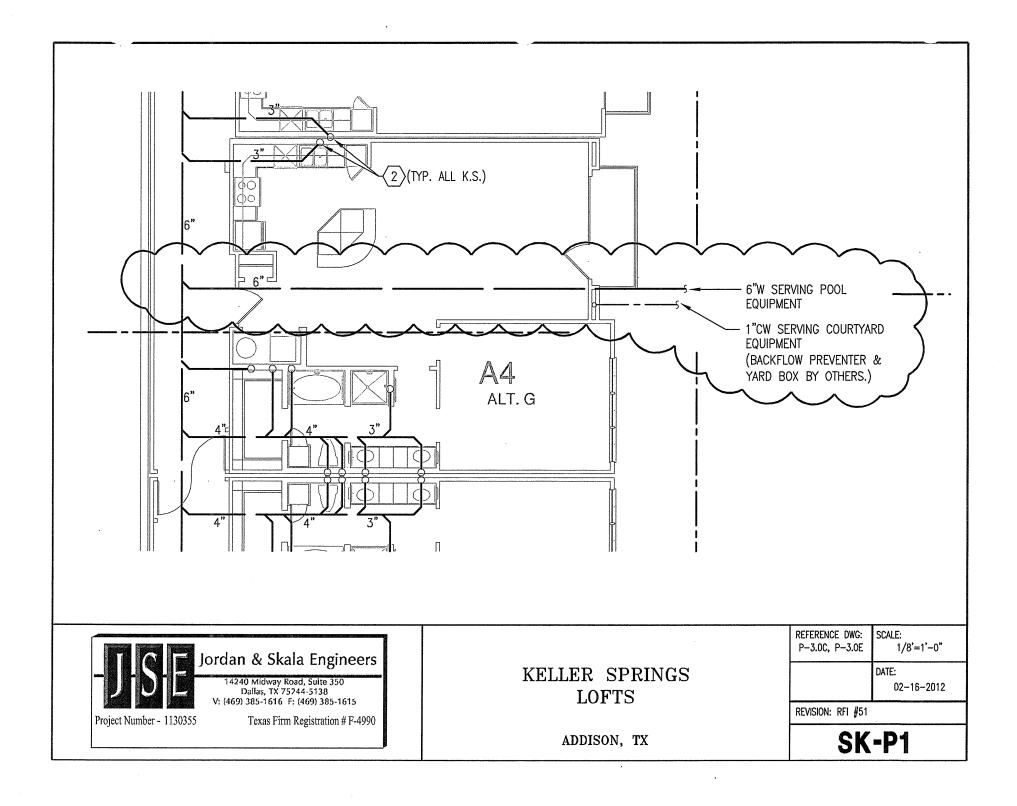

#### EMBREY BUILDERS, LLC.

1020 N. E. Loop 410, Suite 700 San Antonio, TX 78209 Ph : (210) 824-6044 Fax: (210) 824-7656

RFI

To: Jordan & Skala Engineers, Inc. 14240 Midway Road, Suite 350 Dallas, TX 75244 Ph: 469/385-1616 Fax: 469/385-1615

RFI#: 37 Date: 1/23/2012 Job: EB-02 Keller Springs Lofts Phone: 877-777-5115

Subject: 6" main sanitary trunk line

Drawing: P-3.0C P-3.0E Cost Impact: None

Spec Section: Schedule Impact: None

Date Required: 1/25/2012 Request: On sheet P-3.0C the main sanitary trunk line is shown running in the center of the corridors. It is 6" running north along the east side of the garage. It joins another 6" running east along the north side of the garage. So we have a 6" joining with another 6" but there is no designation as to the size of the line after that until it meets the 10" that leaves the building. Sheet P-3.0E gives no designation to the size of this line either. I feel this may be an oversight and the intention would be to have the large to an 8" after the (2) 6" lines merge. Please advice and respond as we are going to be installing these lines in the next two days.

Requested by:	Bryan Pickler Embrey Partners, Ltd.
Response:	
The line sh	ould increase to an 8" once the two 6" lines come together as mentioned above.
Russell Co.	x - Jordan & Skala
Answered by	
Company	Date

Page 1 of 1

#### EMBREY BUILDERS, LLC.

1020 N. E. Loop 410, Suite 700 San Antonio, TX 78209 Ph : (210) 824-6044 Fax: (210) 824-7656

RFI

To: Jordan & Skala Engineers, Inc. 14240 Midway Road, Suite 350 Dallas, TX 75244

Date: 2/7/2012 Job: EB-02 Keller Springs Lofts Phone: 877-777-5115

cc: David Gallagher (Embrey Build (Embrey Construction LLC)

Subject: Pool and fountain equipment drain requirements

Ph: 469/385-1616 Fax: 469/385-1615


Spec Section: Drawing: landscape 5C Schedule Impact: None Cost Impact: None


Date Required: 2/14/2012 Request: Jordan and Skala, In discussing the courtyards fountain and pool equipment requirements with our pool contractor, it has come to our attention that since the pool equipment will have a chlorinated filter system, by code, we are required to run that into the sanitary sewer. The fact that the fountain equipment is run with a non-chlorinated system, the pool contractor believes that the fountain equipment can be run into the existing storm sewer system in the fountain courtyard. Therefore we need Jordan and Skala to revise the plans accordingly.


Please reference landscape sheet 5C of 9 for pool equipment location. Requested by: Bryan Pickler Embrey Partners, Ltd.


A 6" sanitary waste line has been routed to pool equipment area for pool drainage. See attached sketch. Russell Cox Answered by 2-16-2012 Date Company


Page 1 of 1

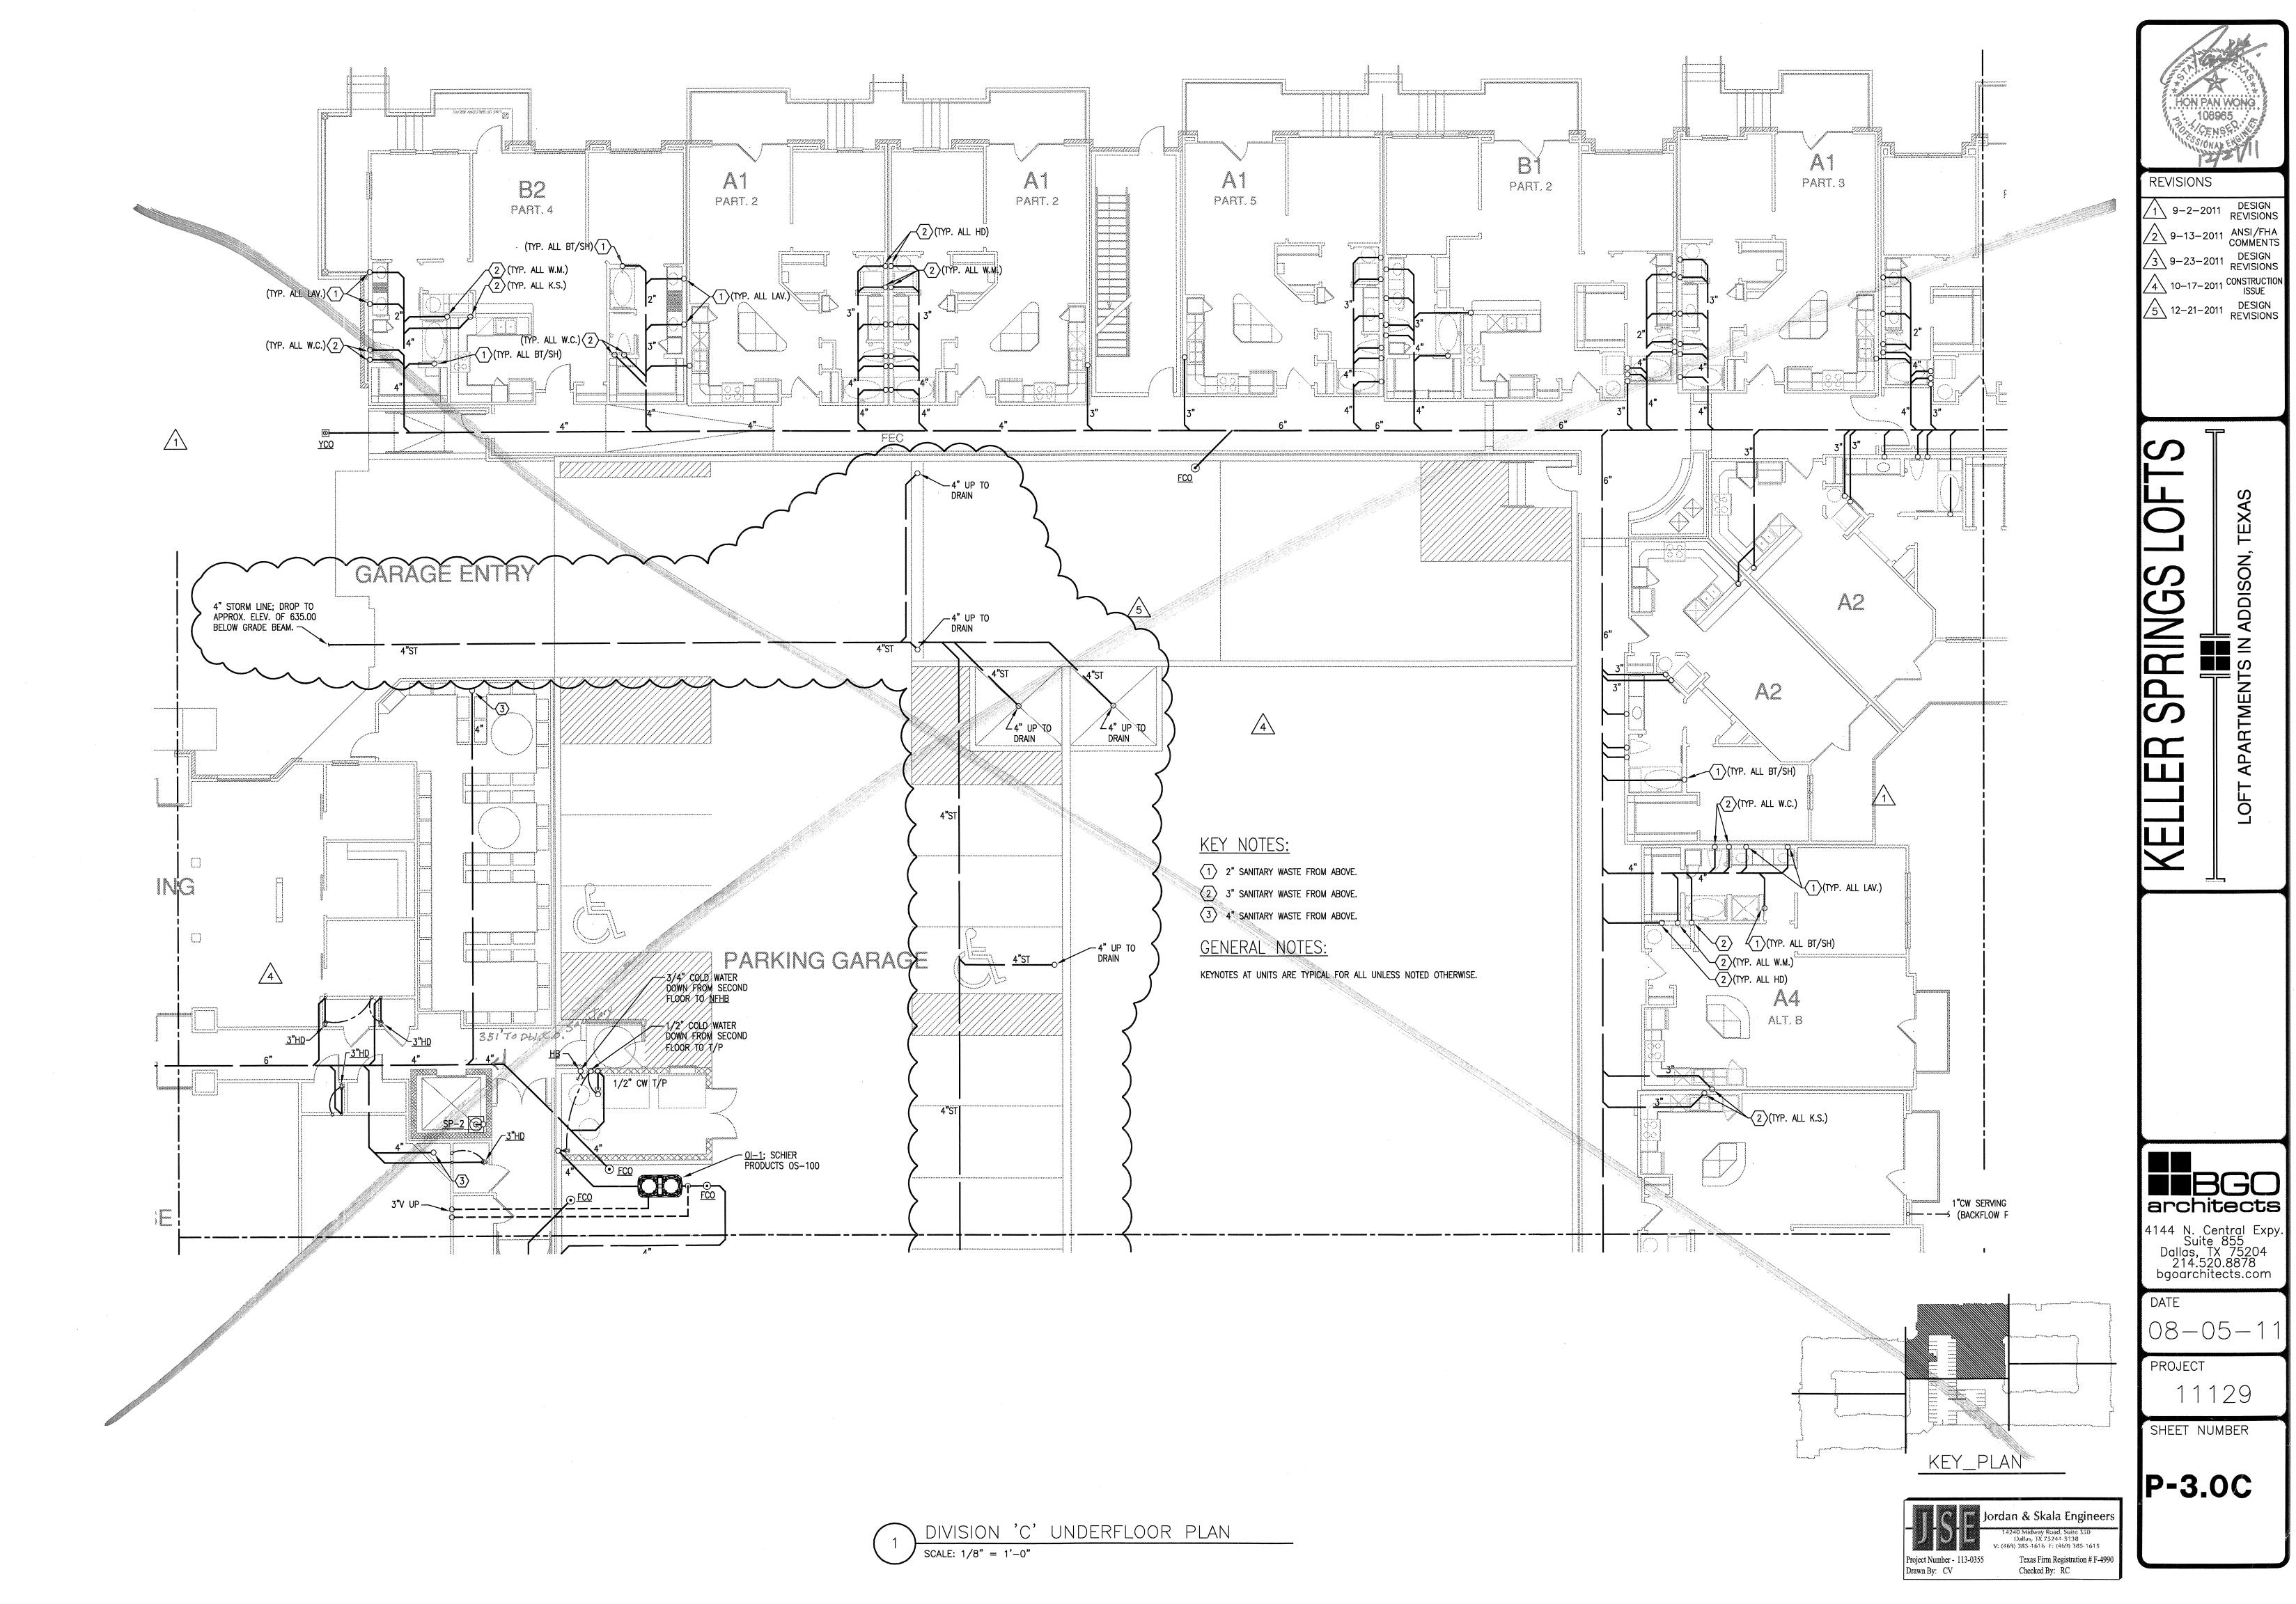

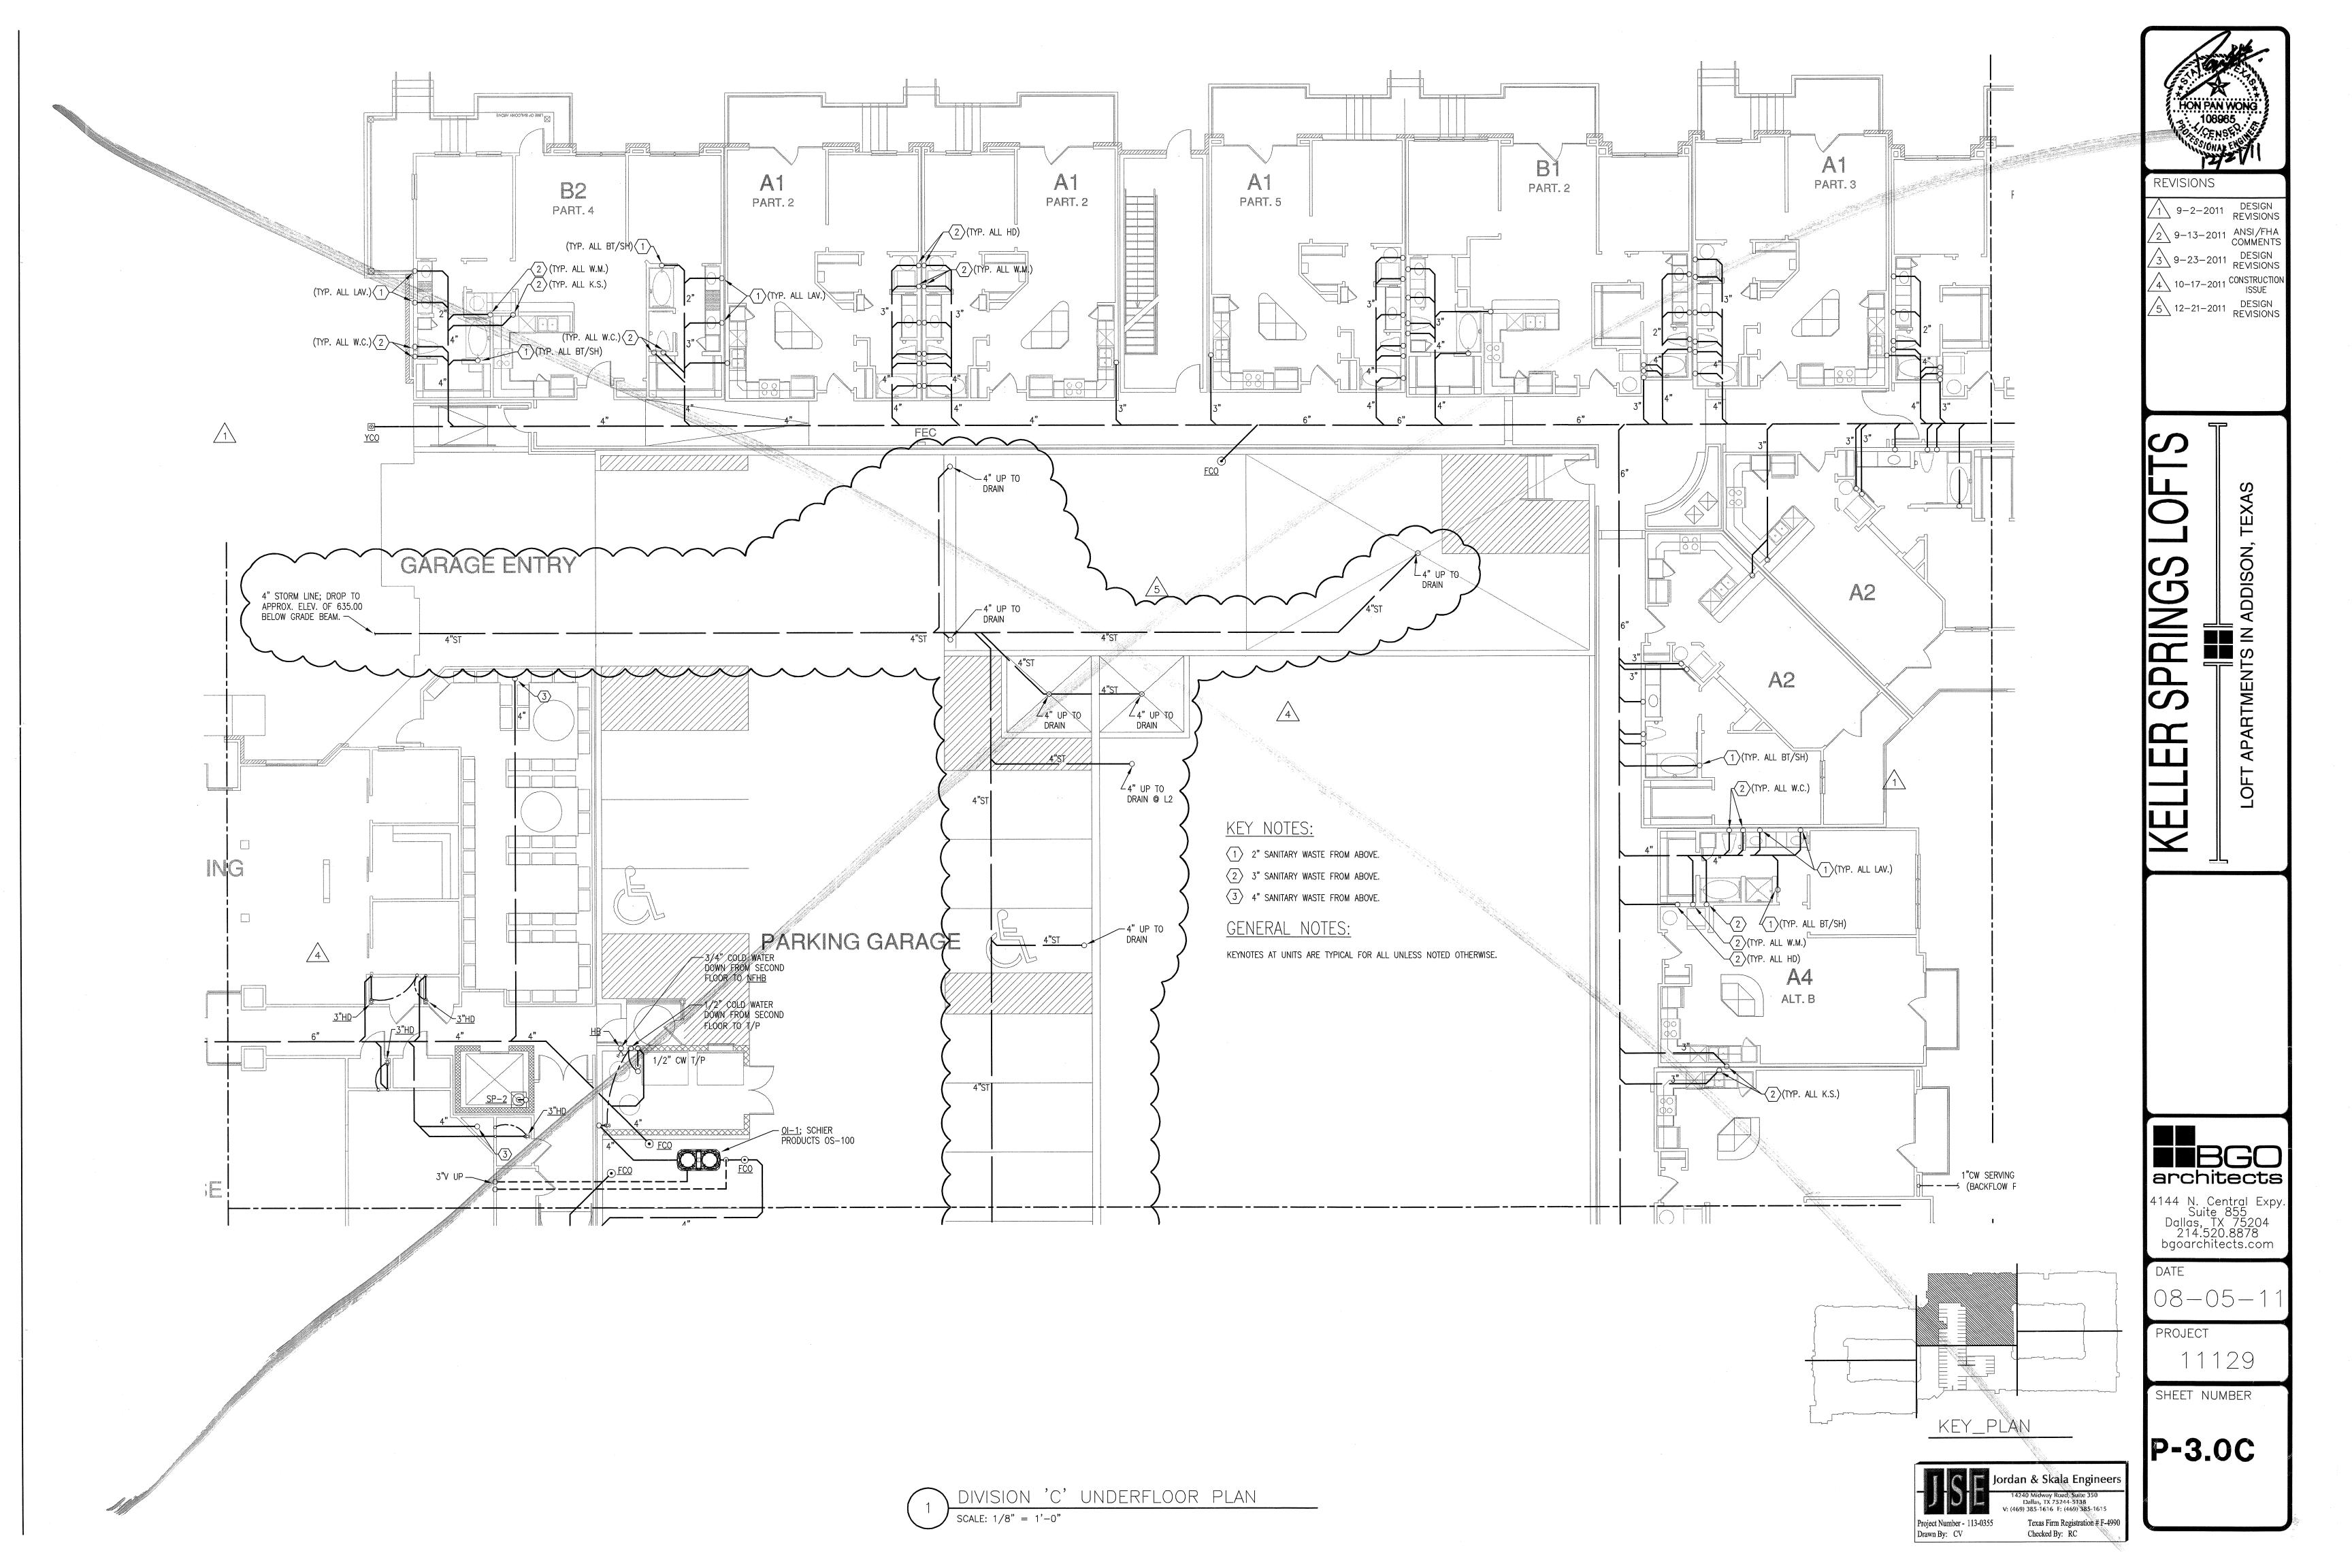

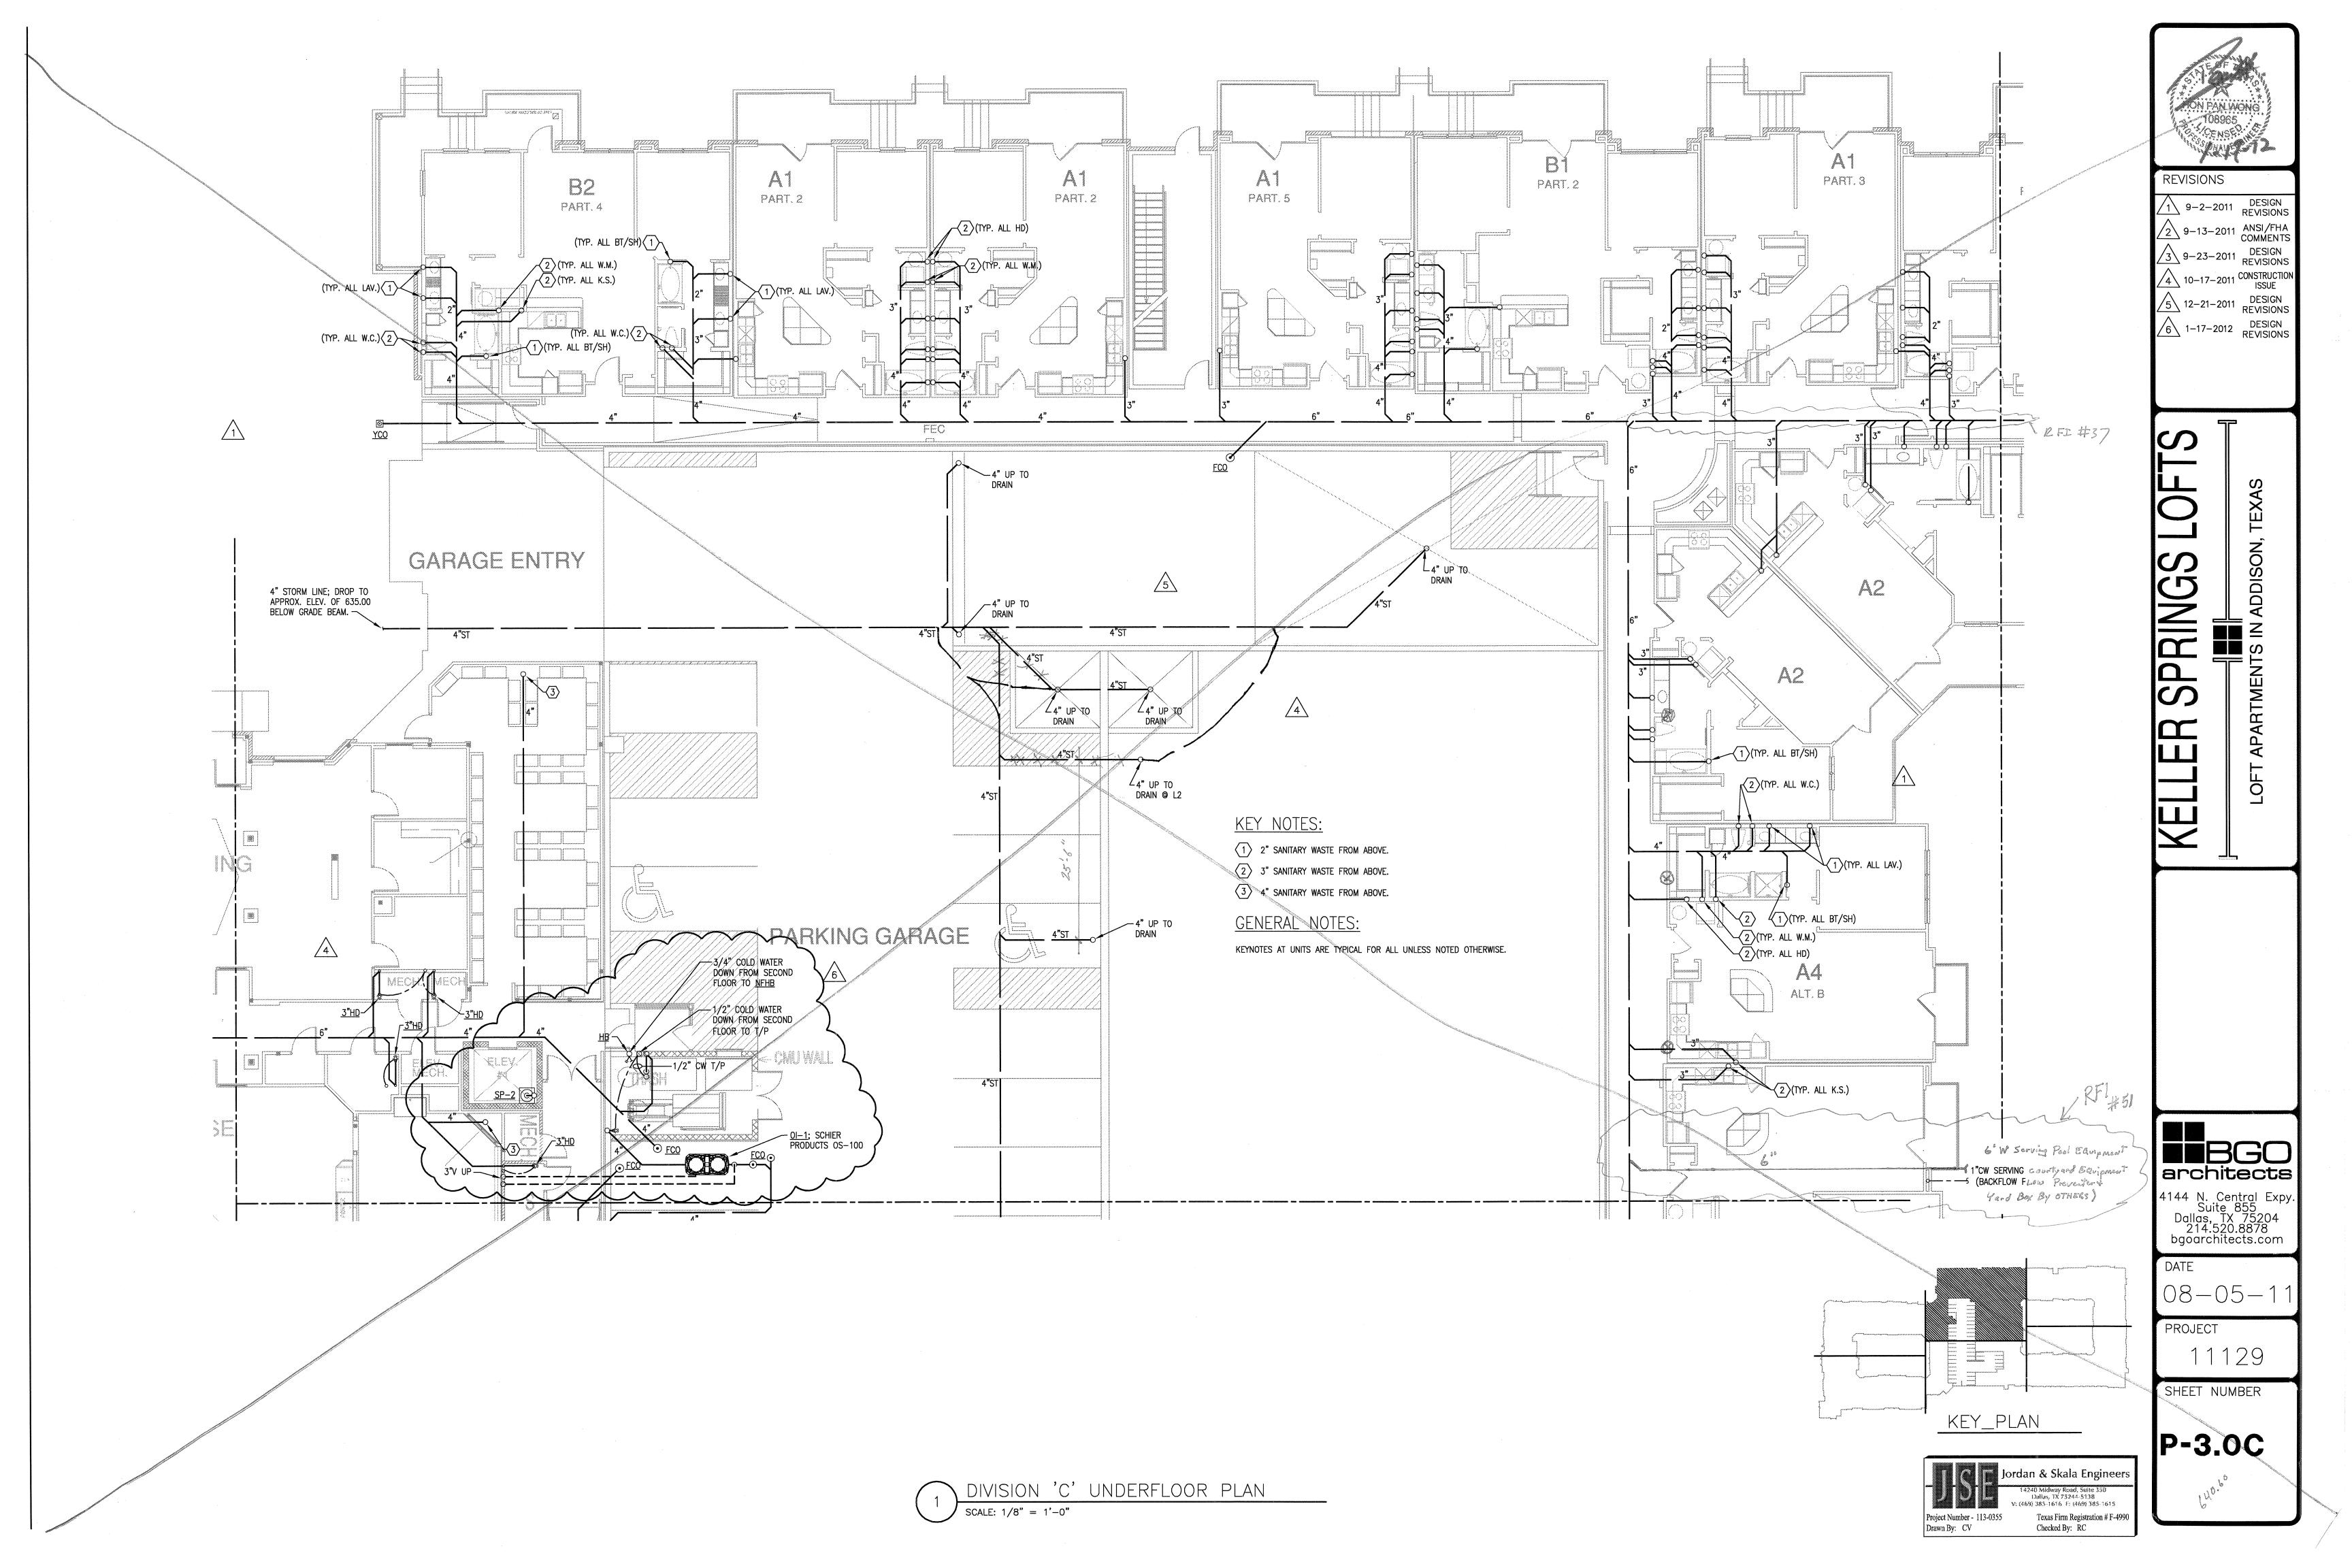

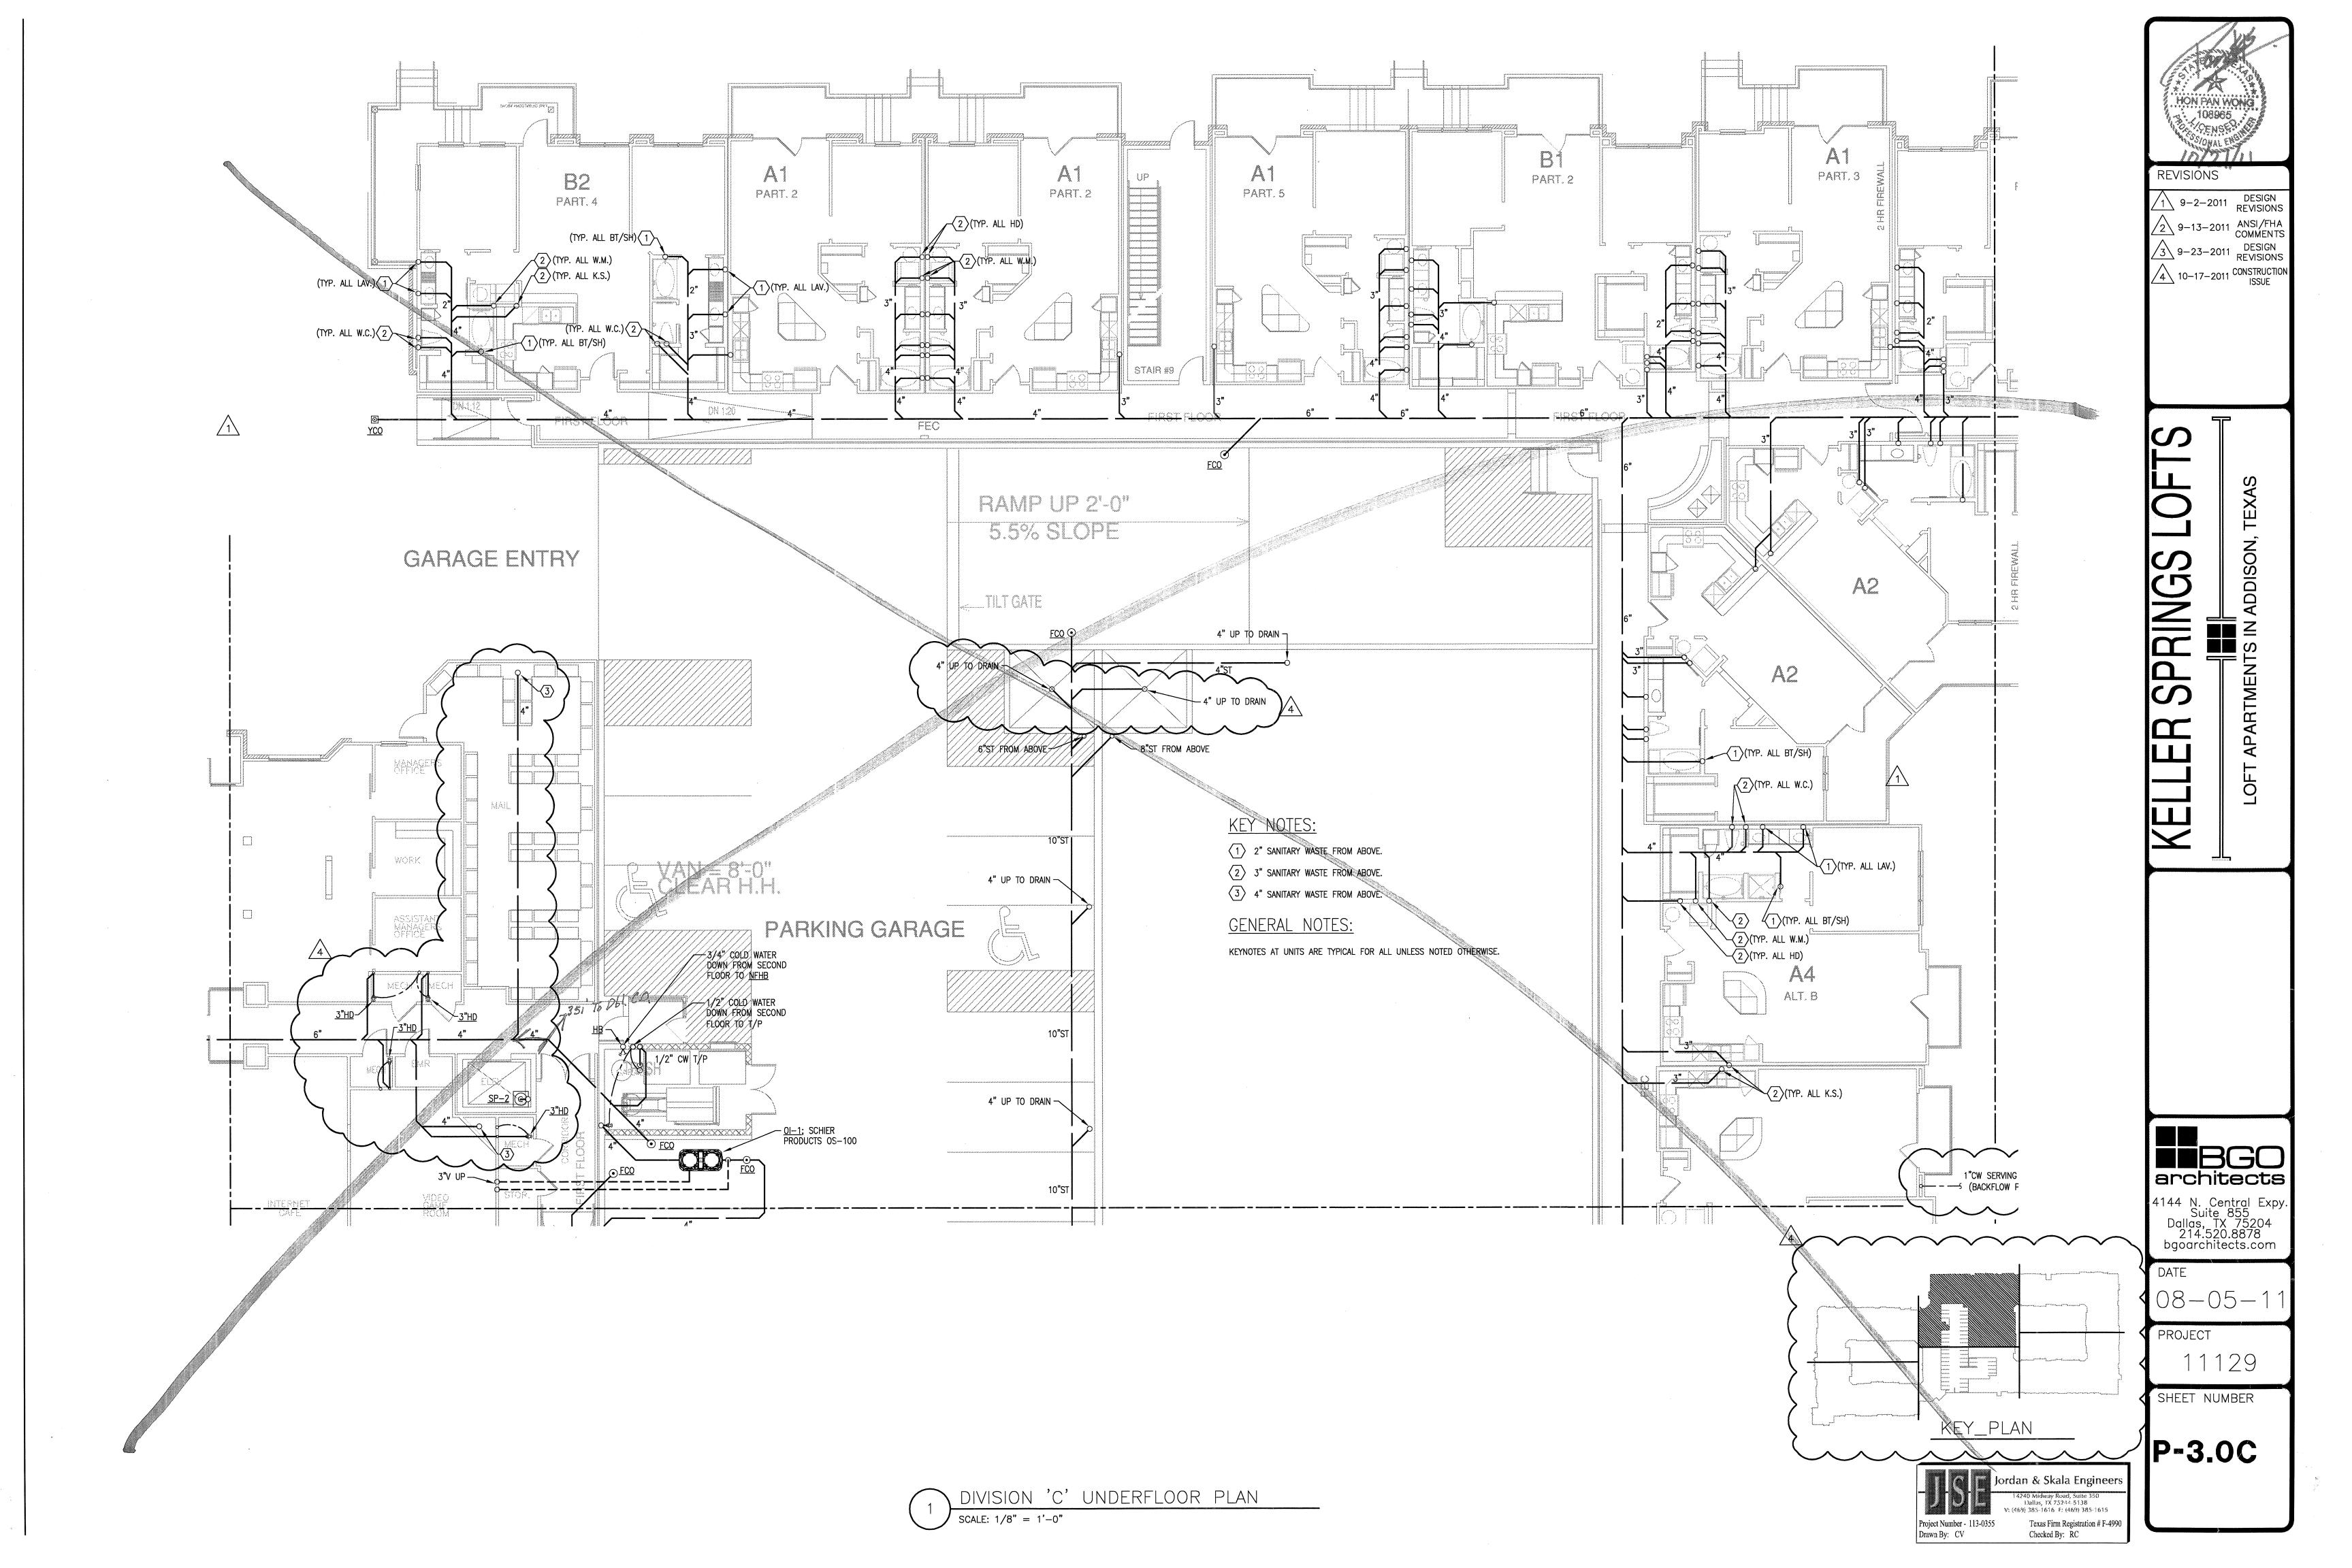

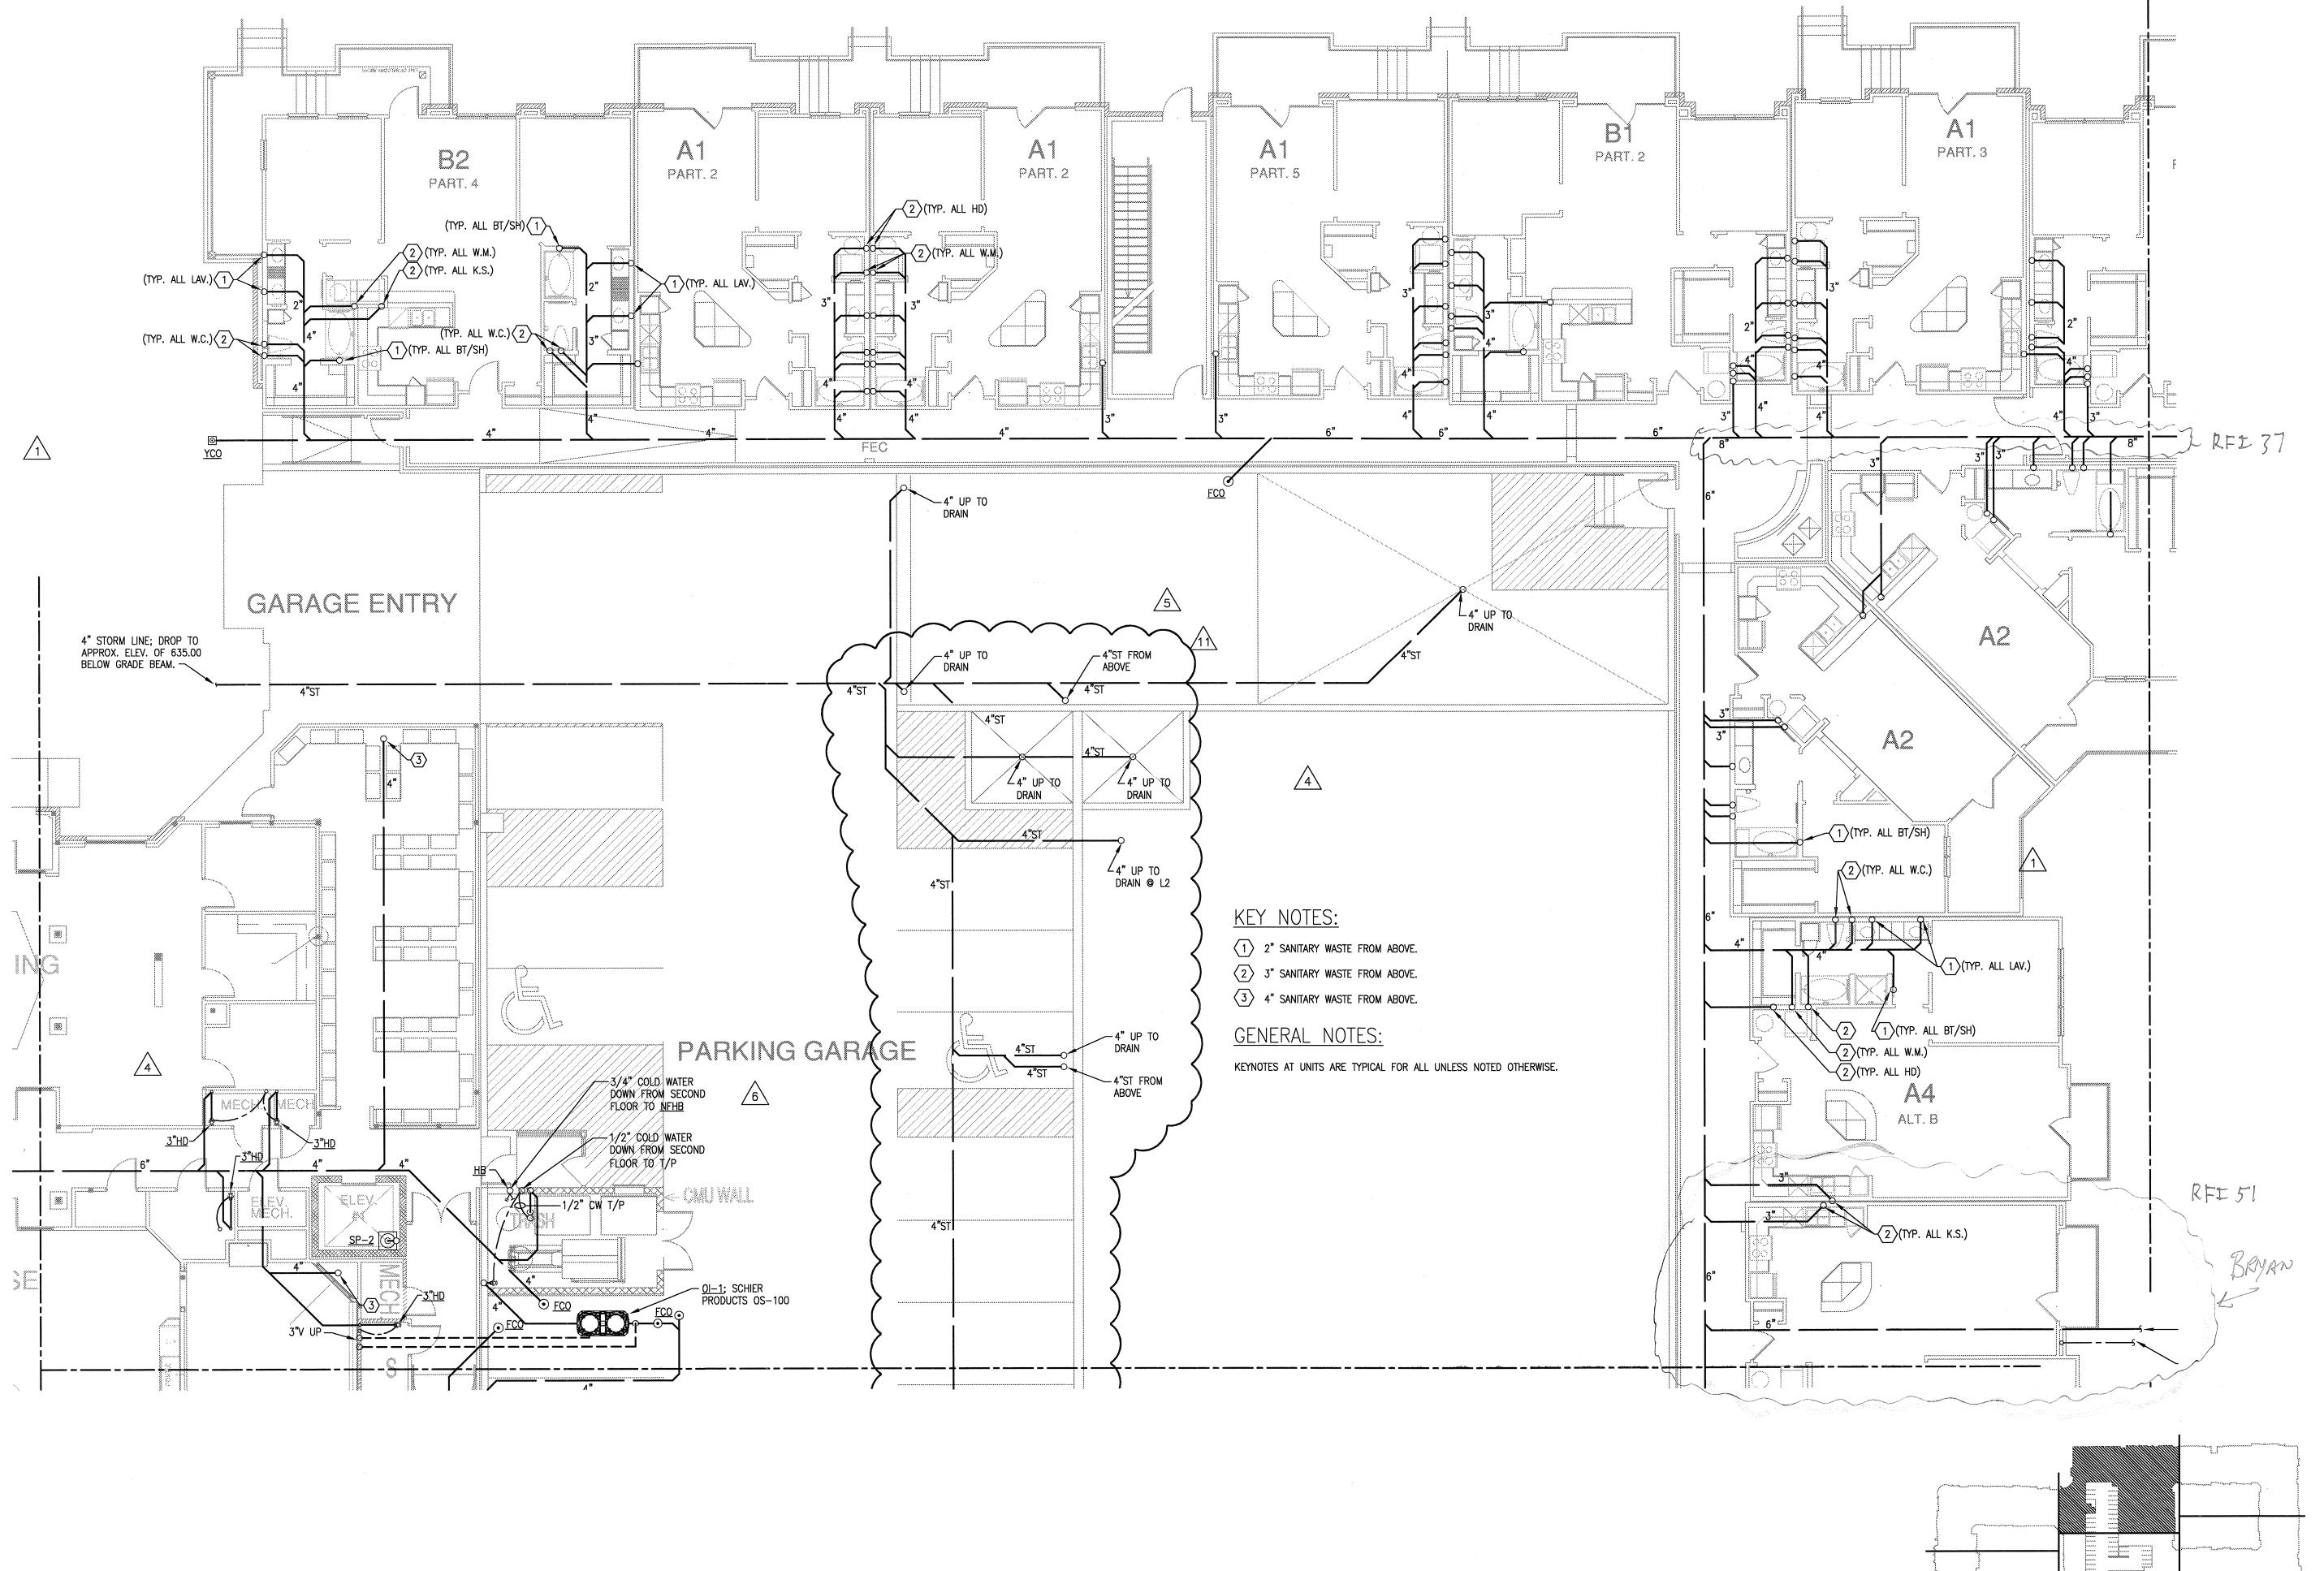

HON PAN WONG
106965

REVISIONS

9-2-2011 DESIGN REVISIONS

9-13-2011 ANSI/FHA COMMENTS
DESIGN REVISIONS

10-17-2011 CONSTRUCTION ISSUE
DESIGN REVISIONS

12-21-2011 DESIGN REVISIONS

CONSTRUCTION ISSUE
DESIGN REVISIONS

TRANSFORMER
2-15-2012 REVISIONS

3-27-2012 CLUBHOUSE REVISIONS

4-17-2012 COORDINATION

ER SPRINGS LOFTS

5-15-2012 COORDINATION 5-30-2012 SITE COORDINATION

architects

4144 N. Central Expy.
Suite 855
Dallas, TX 75204
214.520.8878
bgoarchitects.com

DATE 08-05-11

PROJECT

PROJECT 11129

SHEET NUMBER

P-3.0C

KEY\_PLAN

Jordan & Skala Engineers

V: (469) 385-1616 Web:www.jordanskala

Checked By: RC

Texas Firm Registration # F-4990

EMBREY BUILDERS, LLC. 1020 N. E. Loop 410, Suite 700 San Antonio, TX 78209 Ph: (210) 824-6044 Fax: (210) 824-7656

	RFI
To: Trent Perkins Parkin Perkins Olsen 9330 LBJ Freeway, Suite 1055 Dallas, TX 75243 Ph: (214)221-2220 Fax: (214)221	RFI #: 11  Date: 12/14/2011  Job: EB-02 Keller Springs Lofts  Phone: 877-777-5115
cc: David Gallagher (Embrey Build (F	Embrey Construction LLC)
Subject: Detail for 15" leave out	
Drawing: Cost Impact: None	Spec Section: Schedule Impact: None
Request:	Date Required: 12/21/2011
Trent please provide structural detail for a	115 leave out for stern wan
Requested by: Trent Perkins Parkin Perkins Olsen	
Response:	
Please provide addition vertical location of "leav	al information including purpose of "leave-out" and horizontal/ re-out".
Trent Perkins, P.E.	12-14-2011
Answered by PPO Consulting Engineer	

EMBREY BUILDERS, LLC.

1020 N. E. Loop 410, Suite 700 San Antonio, TX 78209

Ph: (210) 824-6044 Fax: (210) 824-7656

RFI

To: Trent Perkins Parkin Perkins Olsen 9330 LBJ Freeway, Suite 1055 Dallas, TX 75243 Ph: (214)221-2220 Fax: (214)221-2252

RFI#: 31 Date: 1/10/2012 Job: EB-02 Keller Springs Lofts Phone: 877-777-5115

cc: Jordan & Skala Engineers, Inc. (Dallas)

Subject: Detail for 12 sleeve pentration and elevation

Drawing: P3.0D Cost Impact: None

Answered by

Parkin-Perkins-Olsen

Spec Section: Schedule Impact: None

Date Required: 1/17/2012 Trent we need a detail for (2) 12" drain sleeves that penitrate the southern beam wall of the garage Ref P 3.0D attached. The structural engineer wants sleeves in the middle third of the beam wall. Top of Beam Wall = 639'-71/4" and beam is 4' deep 635'-71/4". Middle of the beam =  $637'-71/4"-6"(1/2 \times 12")=637'-11/4"$ . So the bottom of the two 12" sleeves should be at 637'-11/4" or 637.10. This should give us plenty of fall as the original flow line of the 15" on C8 was 636.22 just inside the building. Ref C8. Can both PPO and Jordan& Skala concur and reflect it on their plans and detail? Requested by: Bryan Pickler Embrey Partners, Ltd. Please see attached for a grade beam penetration detail that will accommodate the above mentioned 12 inch diameter penetrations. If the center line of either of the penetrations is closer than 2'-6" to grid line B, notify PPO for an alternate If you have questions or require additional information regarding this matter, please do not hesitate to contact us.

Page 1 of 1

Page 1 of 1

EMBREY BUILDERS, LLC.

1020 N. E. Loop 410, Suite 700 San Antonio, TX 78209 Ph : (210) 824-6044 Fax: (210) 824-7656

To: Jordan & Skala Engineers, Inc. 14240 Midway Road, Suite 350 Dallas, TX 75244 Ph: 469/385-1616 Fax: 469/385-1615

Date: 1/16/2012 Job: EB-02 Keller Springs Lofts Phone: 877-777-5115

cc: David Gallagher (Embrey Build (Embrey Construction LLC)


Subject: Purposed relocation of oil Separator

Spec Section: Drawing: P-3.0D Schedule Impact: None Cost Impact: None

Sheet P-3.0D shows the OS-100 (oil separator) located in the resident walkway from the garage to the building. I believe this will almost certainly be a tripping hazard, and purpose we move its location to the trash compactor room. I have an attached detail showing the location my plumber and myself think would be an alternative location. Please review and advised Requested by: Bryan Pickler Embrey Partners, Ltd.

JSE takes no exception to the proposed re-location of the oil separator. New location will be reflected on Design Revision plans dated 01-17-2012 (Delta 6). Russell Cox - Jordan & Skala Answered by

Page 1 of 1

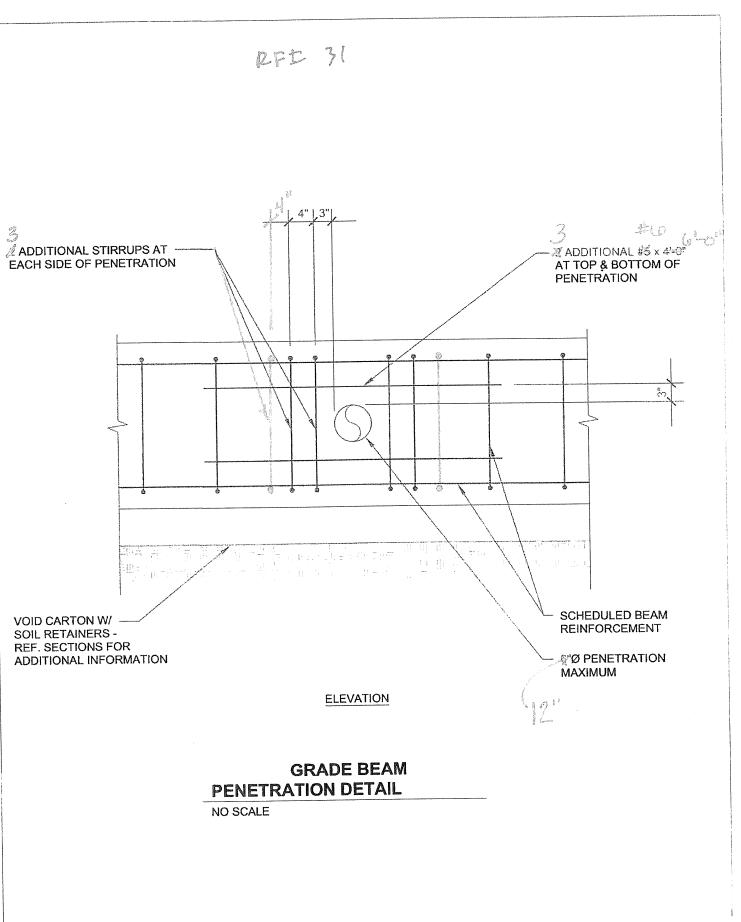

EMBREY BUILDERS, LLC. 1020 N. E. Loop 410, Suite 700 San Antonio, TX 78209 Ph : (210) 824-6044 Fax: (210) 824-7656

RFI

To: Trent Perkins Parkin Perkins Olsen 9330 LBJ Freeway, Suite 1055 Dallas, TX 75243 Ph: (214)221-2220 Fax: (214)221-2252

Date: 1/10/2012 Job: EB-02 Keller Springs Lofts Phone: 877-777-5115

cc: Jordan & Skala Engineers, Inc. (Dallas)


Subject: Detail for 12 sleeve pentration and elevation

Drawing: P3.0D Cost Impact: None

Spec Section: Schedule Impact: None

Date Required: 1/17/2012 Trent we need a detail for (2) 12" drain sleeves that penitrate the southern beam wall of the garage Ref P 3.0D attached. The structural engineer wants sleeves in the middle third of the beam wall. Top of Beam Wall = 639'- 7 1/4" and beam is 4' deep 635' 7 1/4". Middle of the beam = 637' 7 /14" - 6" ( 1/2 x 12") = 637'-1 1/4". So thr bottom of the two 12" sleeves should be at 637'- 1 1/4" or 637.10. This should give us plenty of fall as the original flow line of the 15" on C8 was 636.22 just inside the building. Ref C8. Can both PPO and Jordan& Skala concur and reflect it on their plans and detail? Requested by: Bryan Pickler Embrey Partners, Ltd. Please see attached for a grade beam penetration detail that will accommodate the above mentioned 12 inch diameter penetrations. If the center line of either of the penetrations is closer than 2'-6" to grid line B, notify PPO for an alternate If you have questions or require additional information regarding this matter, please do not hesitate to contact us. Brande Parkey Answered by Parkin-Perkins-Olsen Company

Page 1 of 1

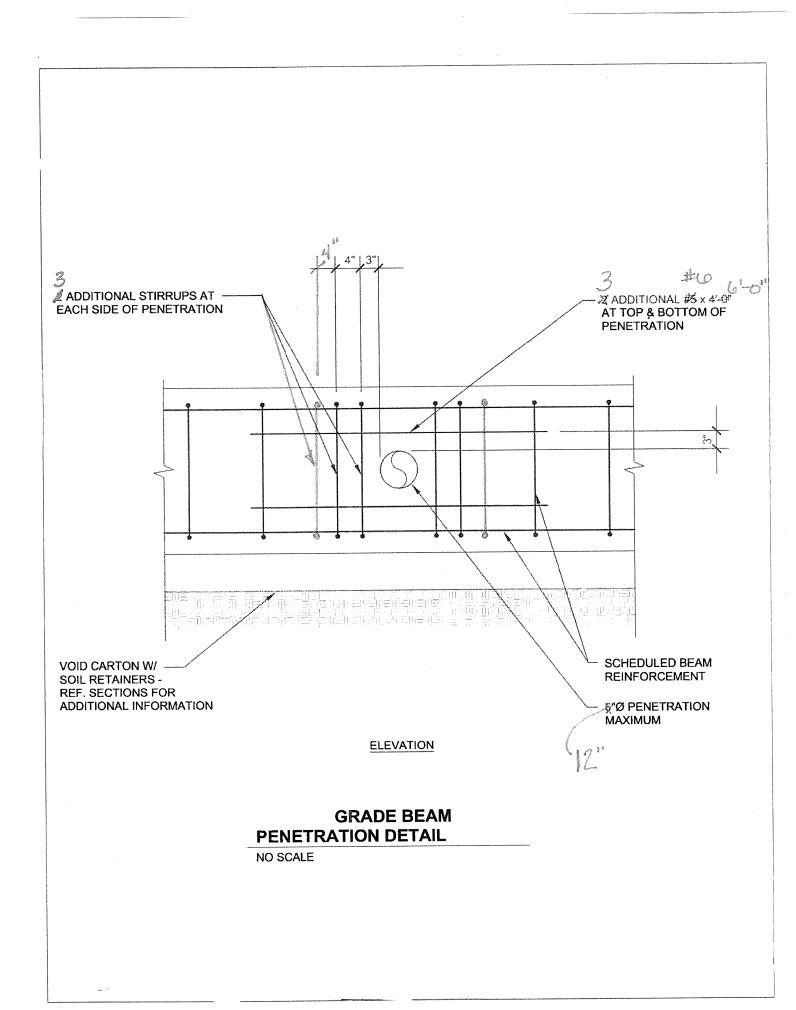

EMBREY BUILDERS, LLC.

1020 N. E. Loop 410, Suite 700 San Antonio, TX 78209 Ph : (210) 824-6044 Fax: (210) 824-7656

RFI

To: Trent Perkins Parkin Perkins Olsen 9330 LBJ Freeway, Suite 1055 Dallas, TX 75243 Ph: (214)221-2220 Fax: (214)221-2252

Date: 1/10/2012 Job: EB-02 Keller Springs Lofts Phone: 877-777-5115

RFI#: 31

cc: Jordan & Skala Engineers, Inc. (Dallas)

Subject: Detail for 12 sleeve penetration and elevation

Spec Section: Drawing: P3.0D Schedule Impact: None Cost Impact: None Date Required: 1/17/2012 Trent we need a detail for (2) 12" drain sleeves that penitrate the southern beam wall of the garage Ref P 3.0D attached. The structural engineer wants sleeves in the middle third of the beam wall. Top of Beam Wall = 639'-71/4" and beam is 4' deep 635'71/4". Middle of the beam = 637'71/4"-6" ( $1/2 \times 12"$ ) = 637'-11/4". So the bottom of the two 12" sleeves should be at 637'-11/4" or 637.10. This should give us plenty of fall as the original flow line of the 15" on C8 was 636.22 just inside the building. Ref C8. Can both PPO and Jordan& Skala concur and reflect it on their plans and detail? Requested by: Bryan Pickler Embrey Partners, Ltd. Plumbing plans have been updated to reflect to elevation of 637.10 at the garage beam wall.

Russell Cox Answered by 1-12-2012 Jordan & Skala Company

Page 1 of 1

EMBREY BUILDERS, LLC.

1020 N. E. Loop 410, Suite 700 Ph: (210) 824-6044 Fax: (210) 824-7656

RFI

To: Jordan & Skala Engineers, Inc. Date: 1/16/2012 14240 Midway Road, Suite 350 Job: EB-02 Keller Springs Lofts Dallas, TX 75244 Ph: 469/385-1616 Fax: 469/385-1615 Phone: 877-777-5115

cc: David Gallagher (Embrey Build (Embrey Construction LLC)

Subject: Purposed relocation of oil Separator


Drawing: P-3.0D Cost Impact: None


Spec Section: Schedule Impact: None


Sheet P-3.0D shows the OS-100 (oil separator) located in the resident walkway from the garage to the building. I believe this will almost certainly be a tripping hazard, and purpose we move its location to the trash compactor room. I have an attached detail showing the location my plumber and myself think would be an alternative location. Please review and advised Requested by: Bryan Pickler


Embrey Partners, Ltd. JSE takes no exception to the proposed re-location of the oil separator. New location will be reflected on Design Revision plans dated 01-17-2012 (Delta 6). Russell Cox - Jordan & Skala Company


Page 1 of 1

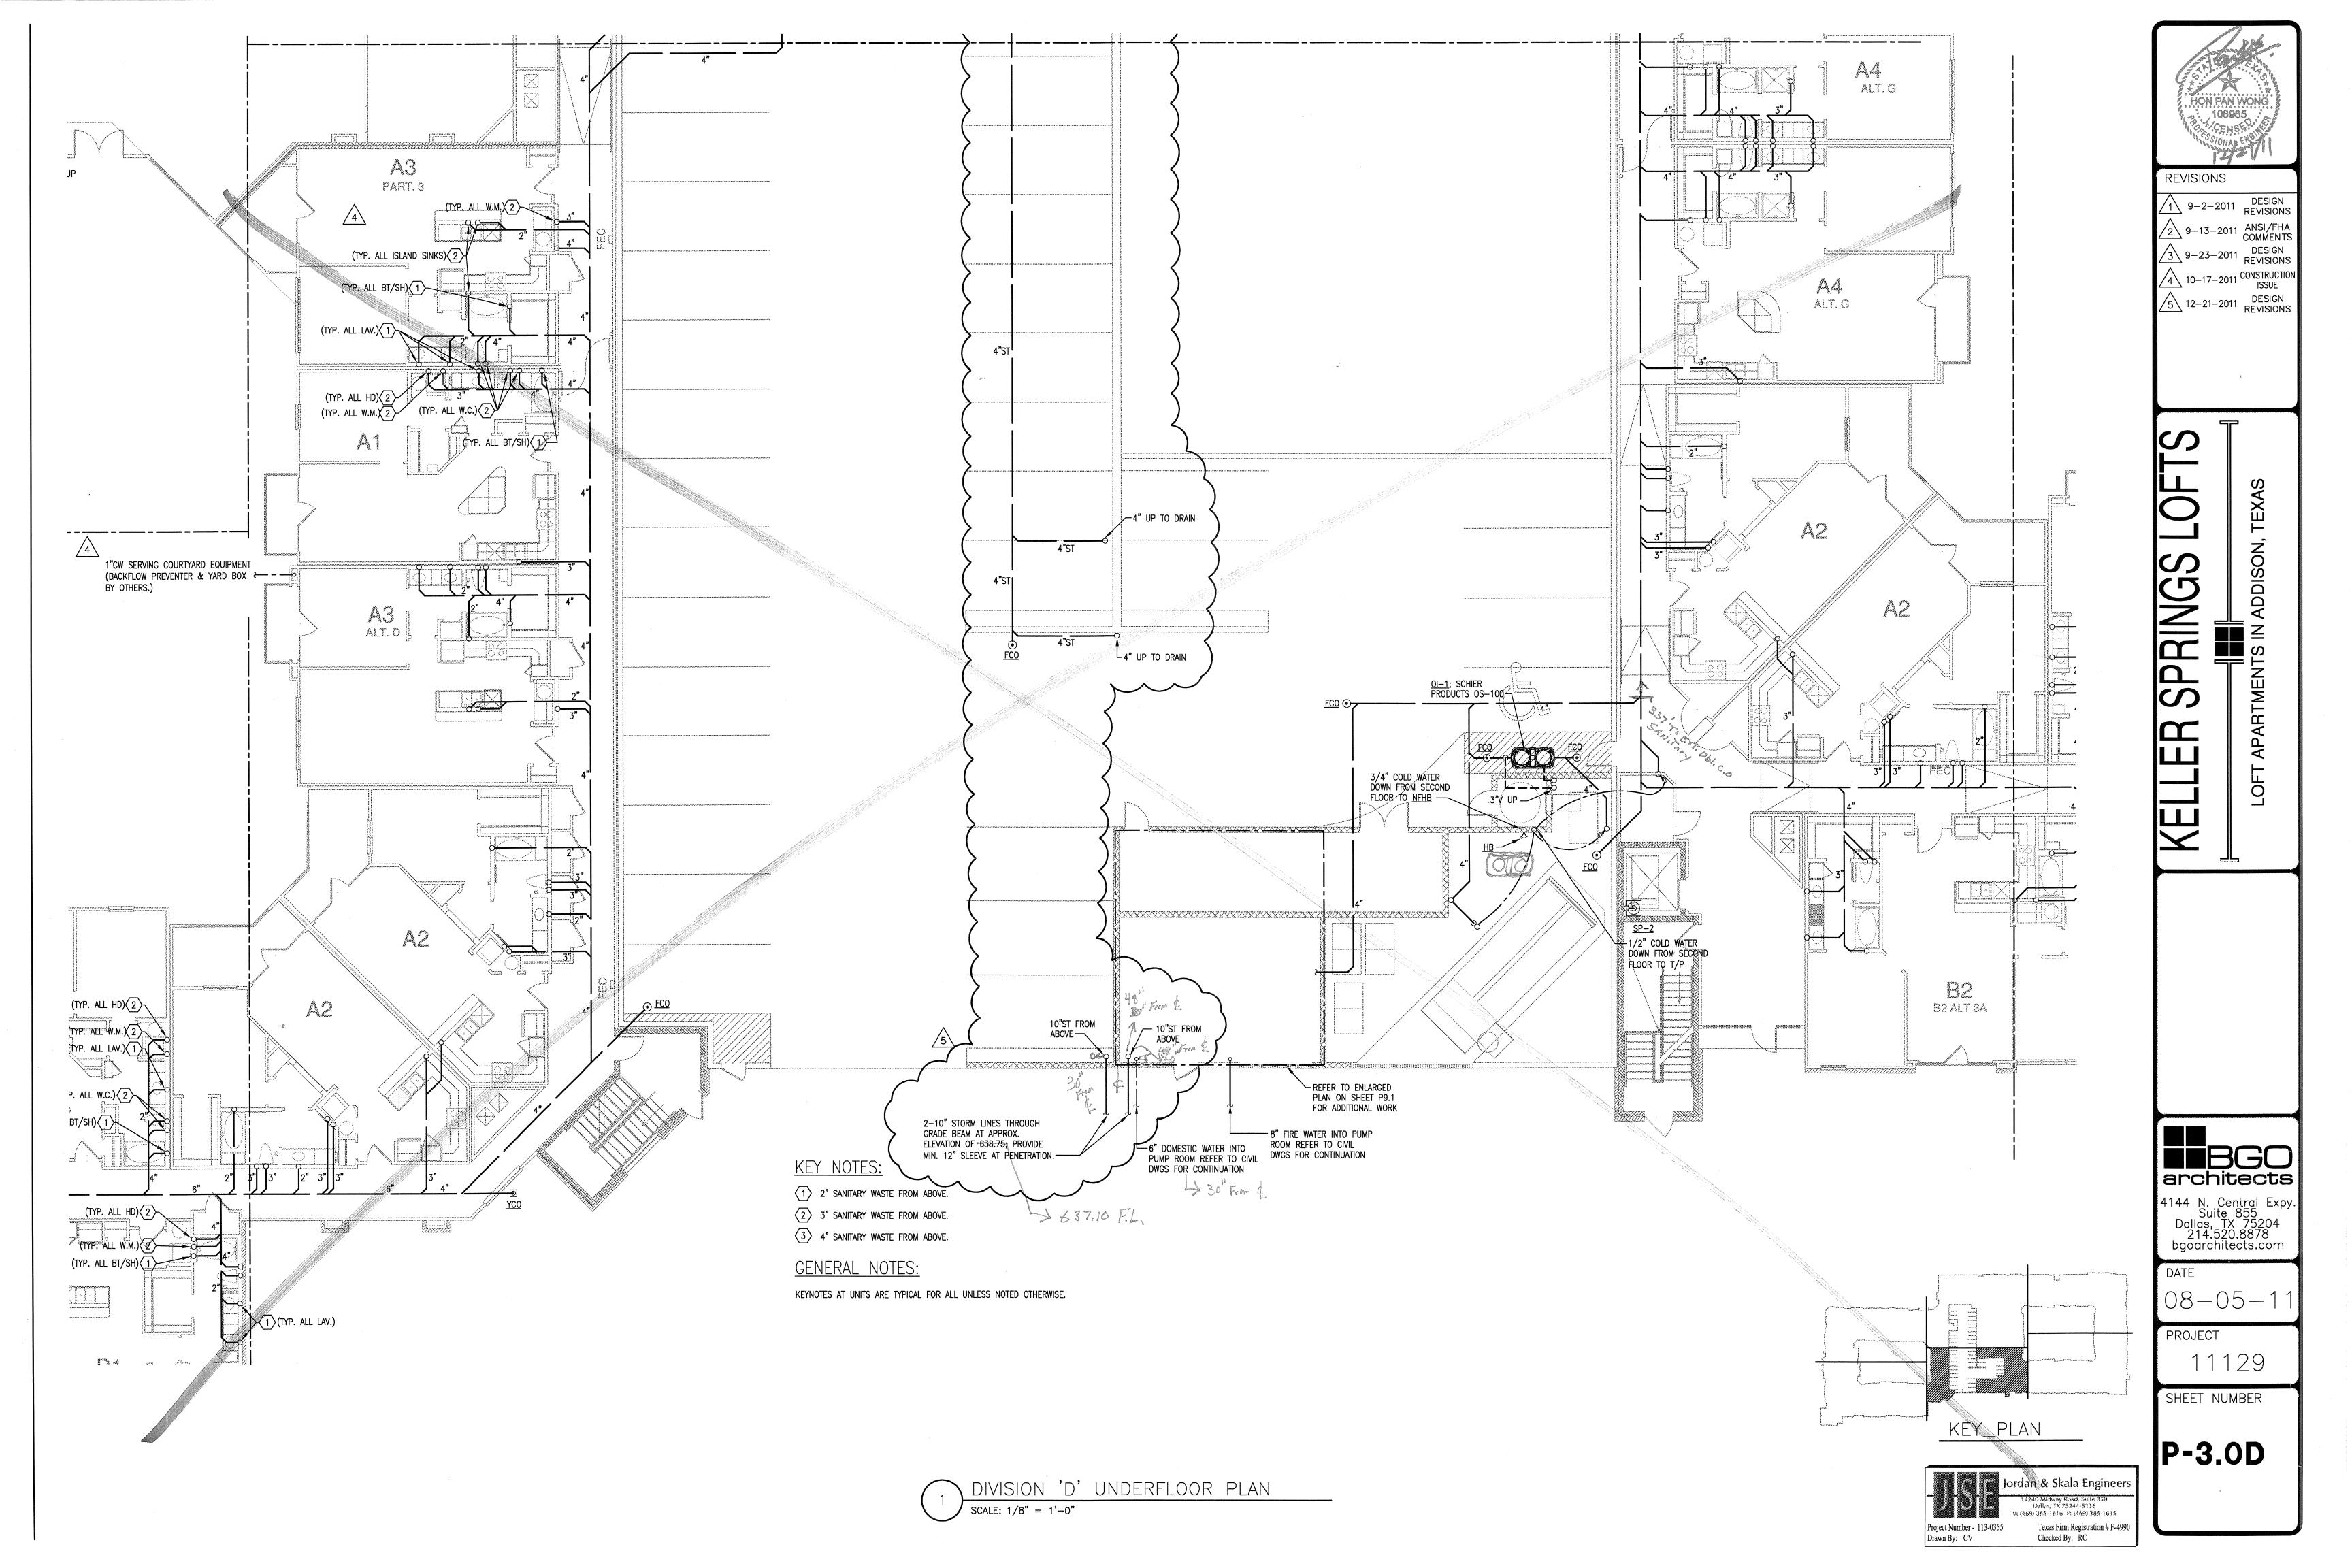


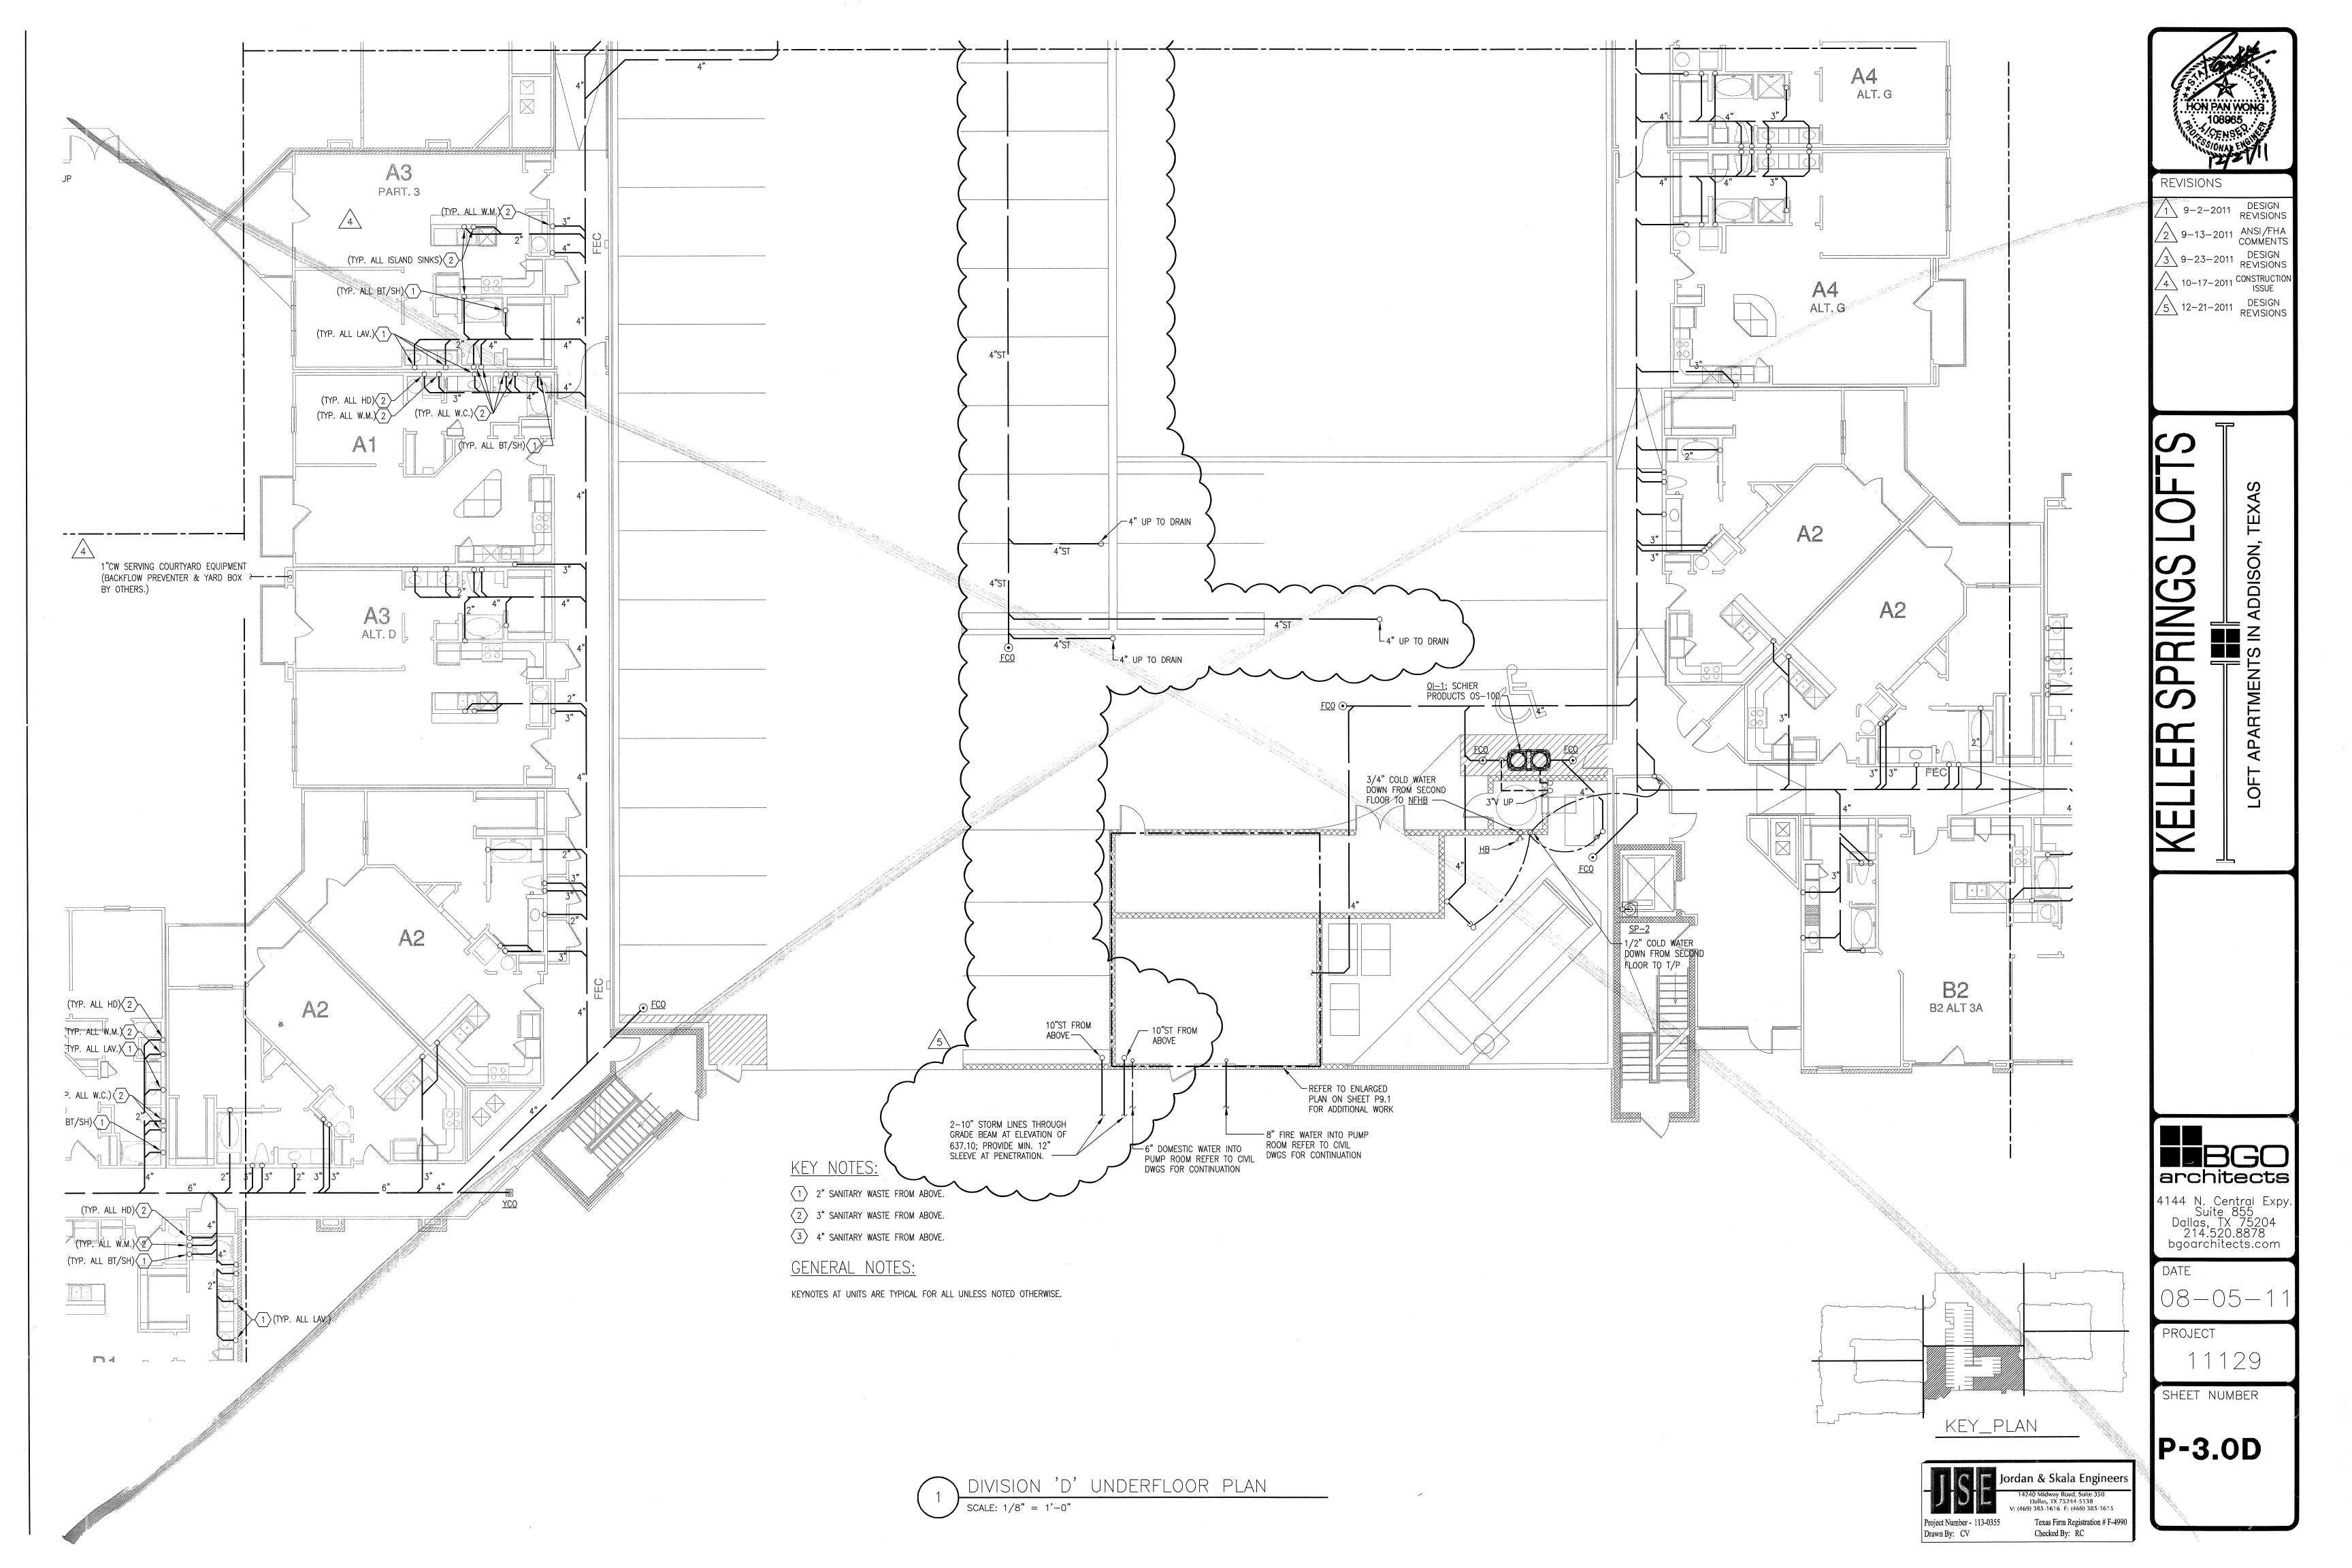


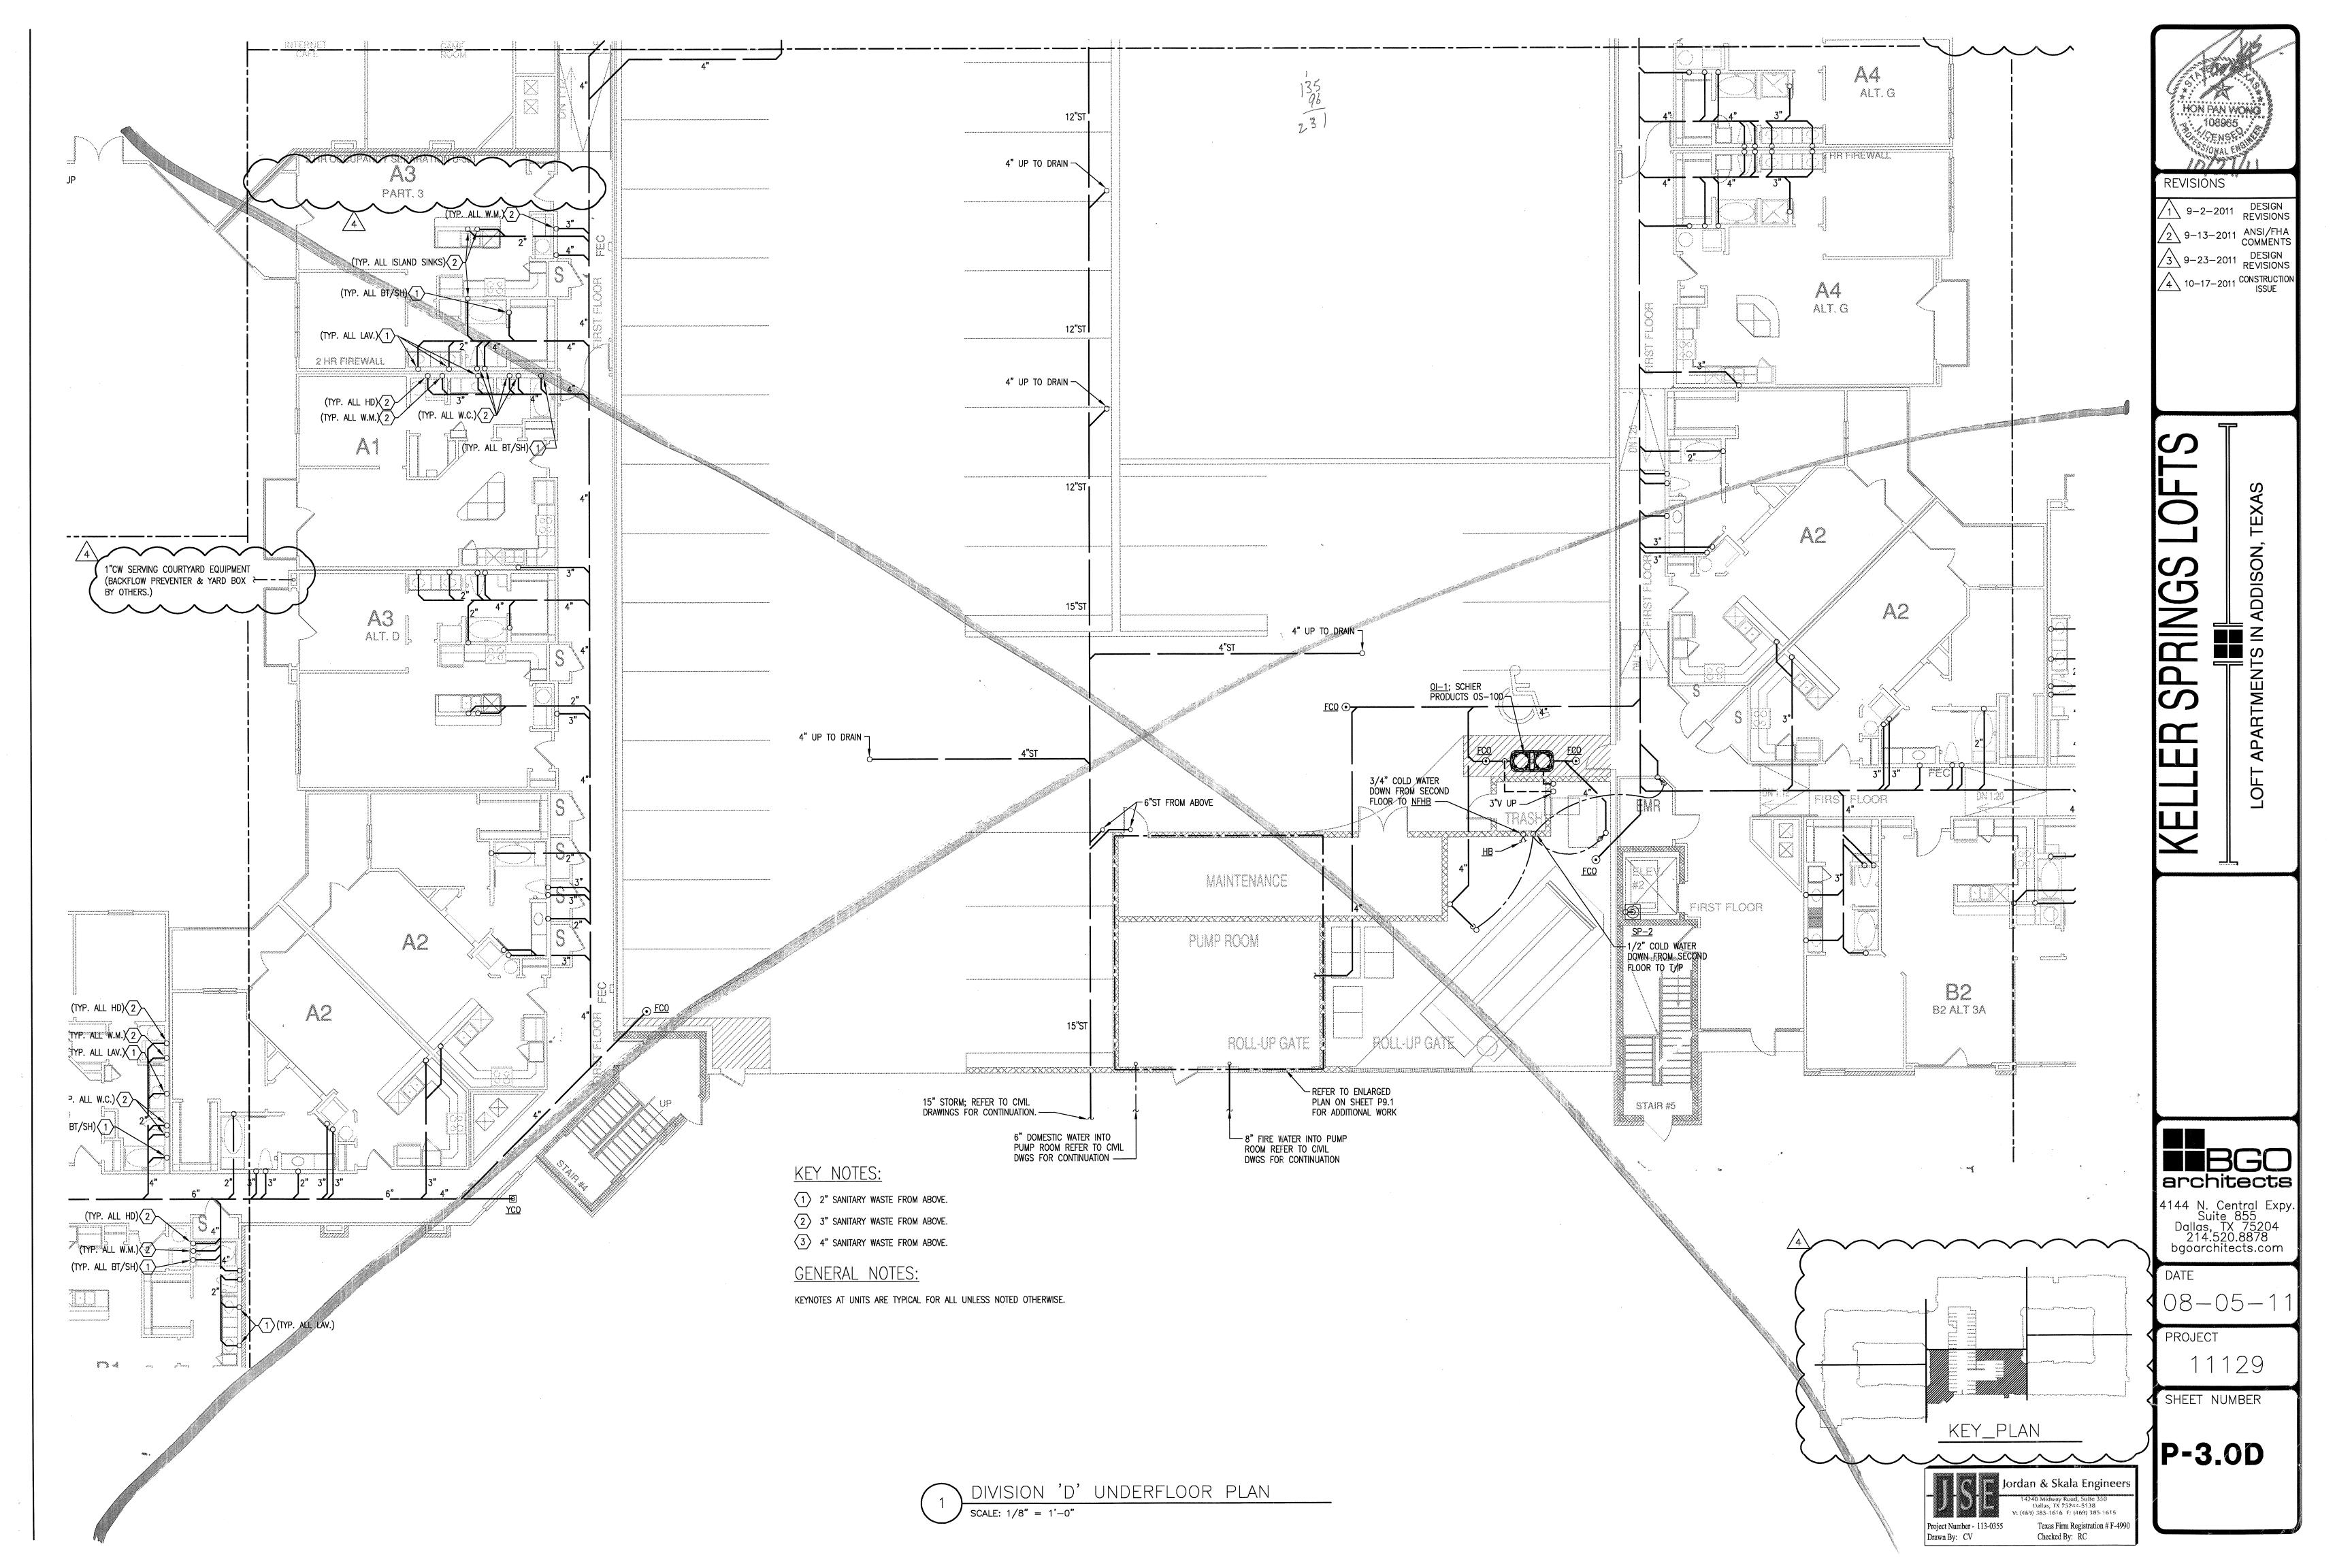


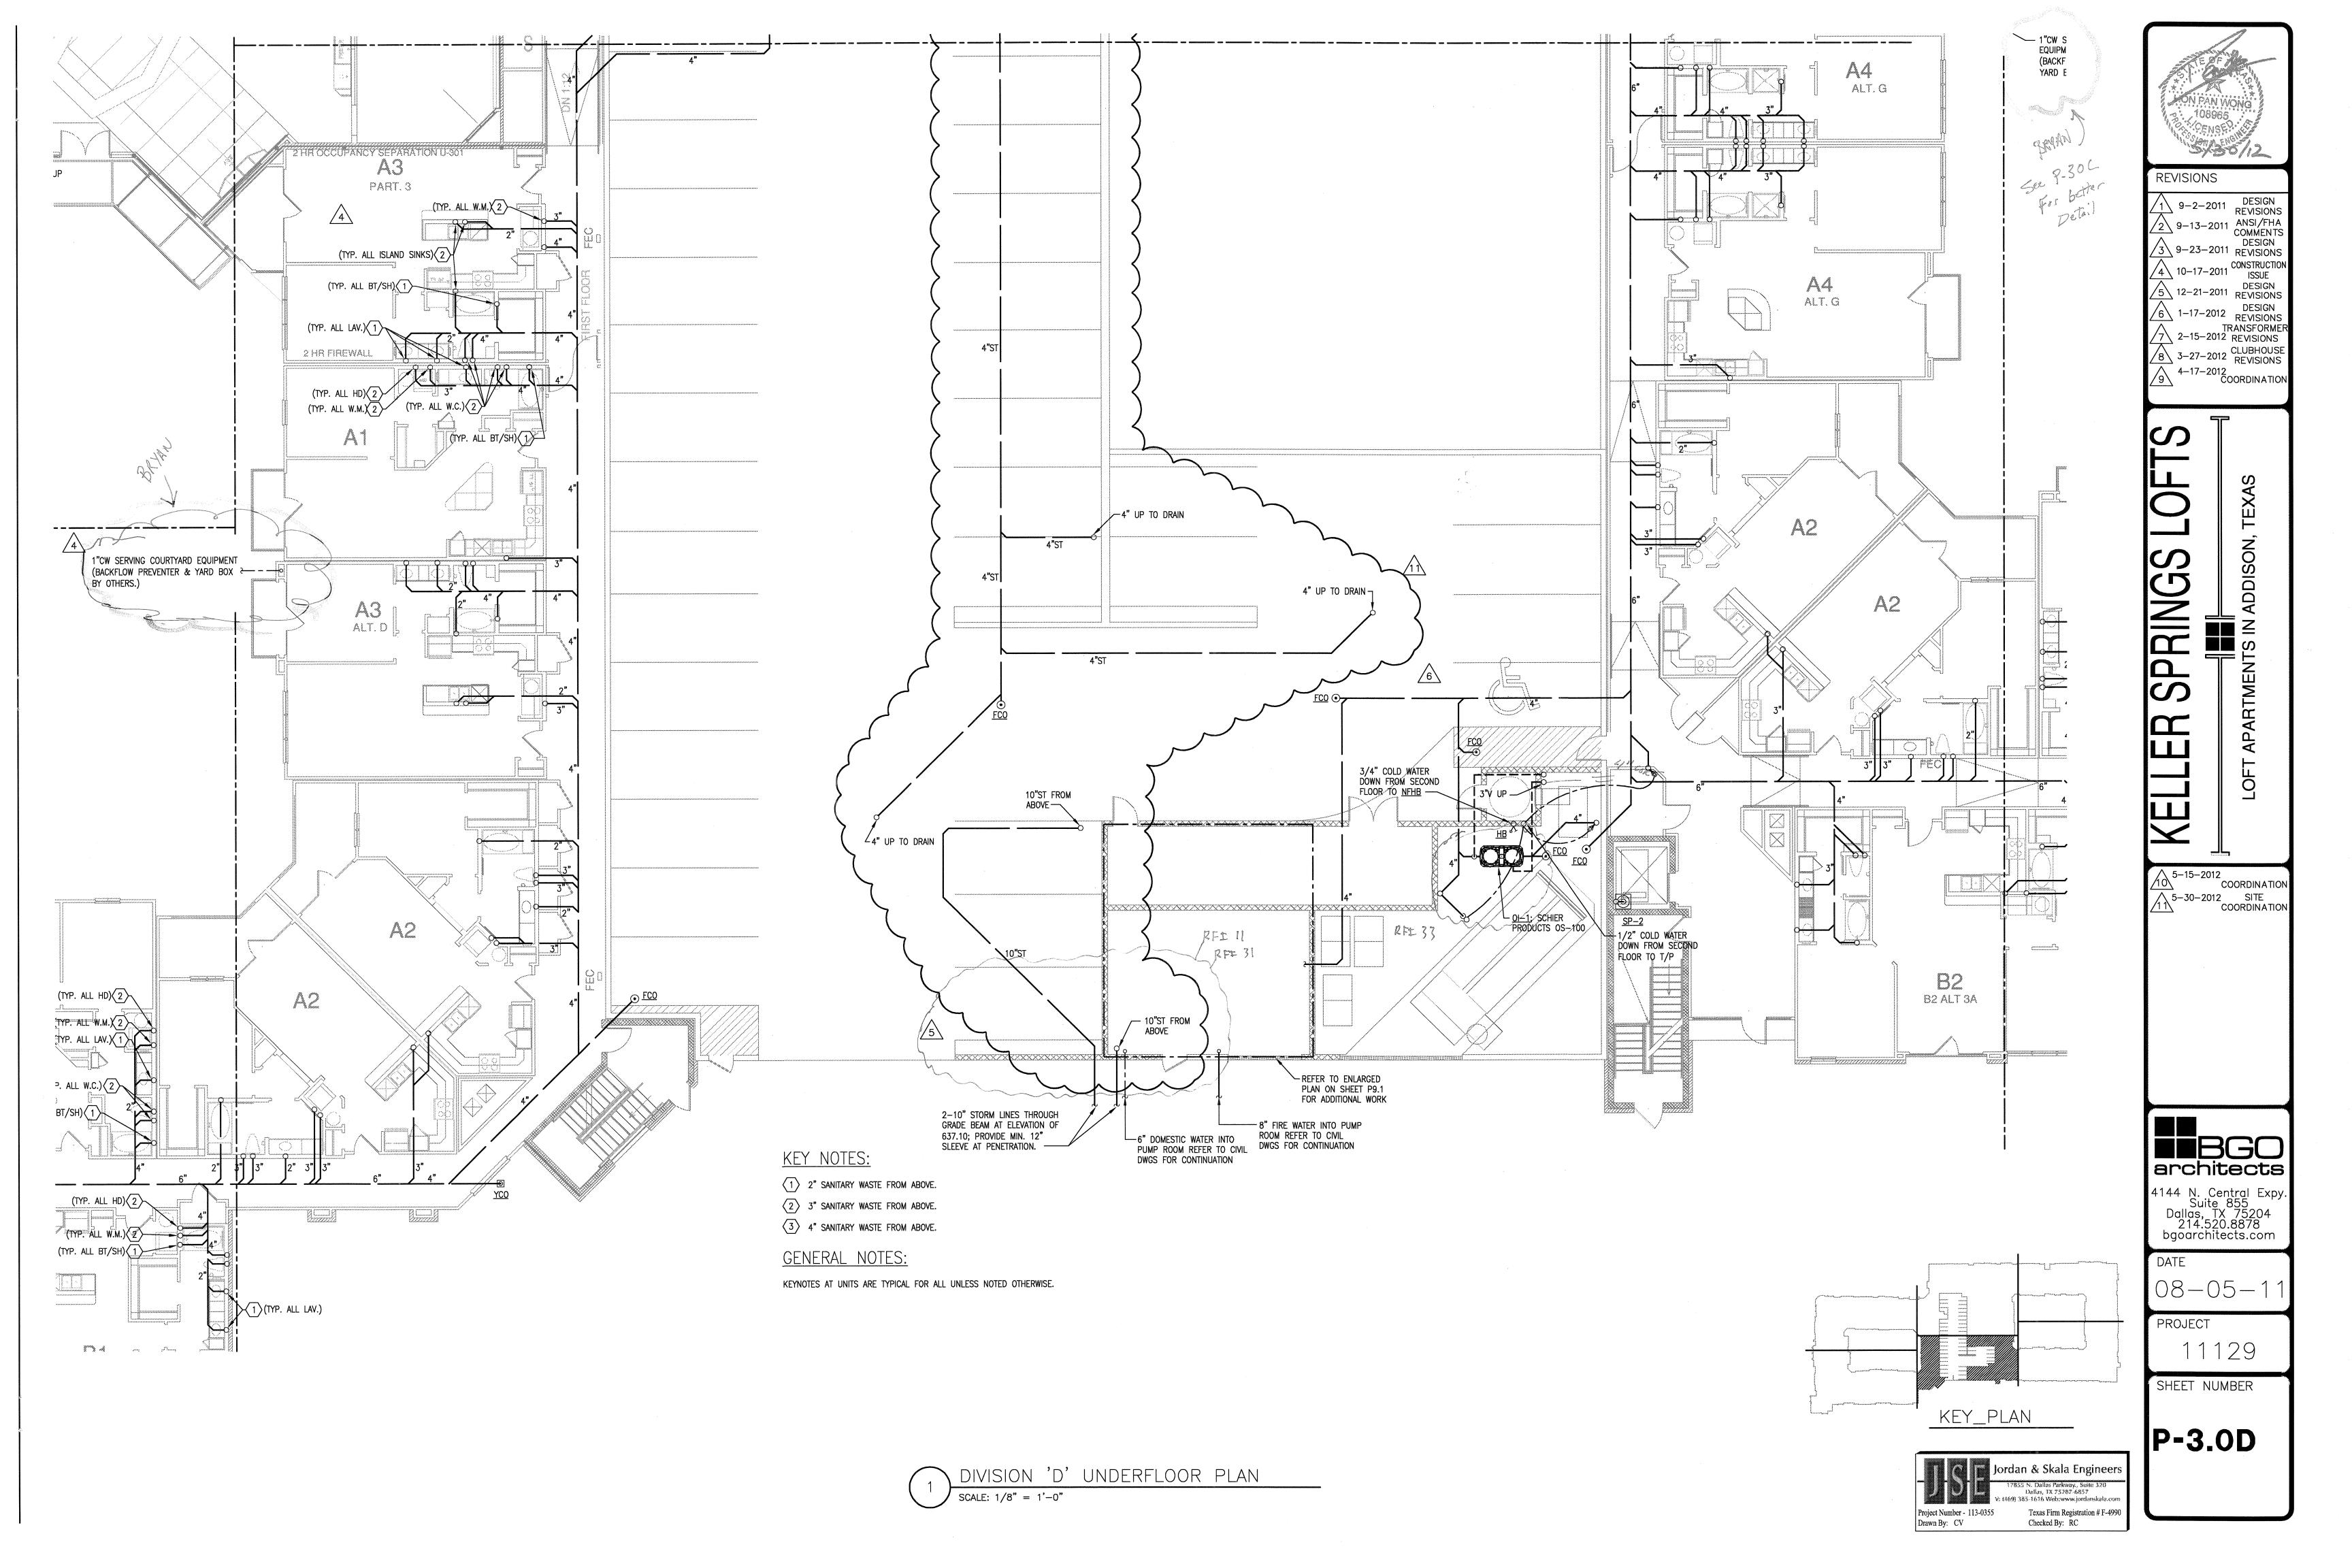

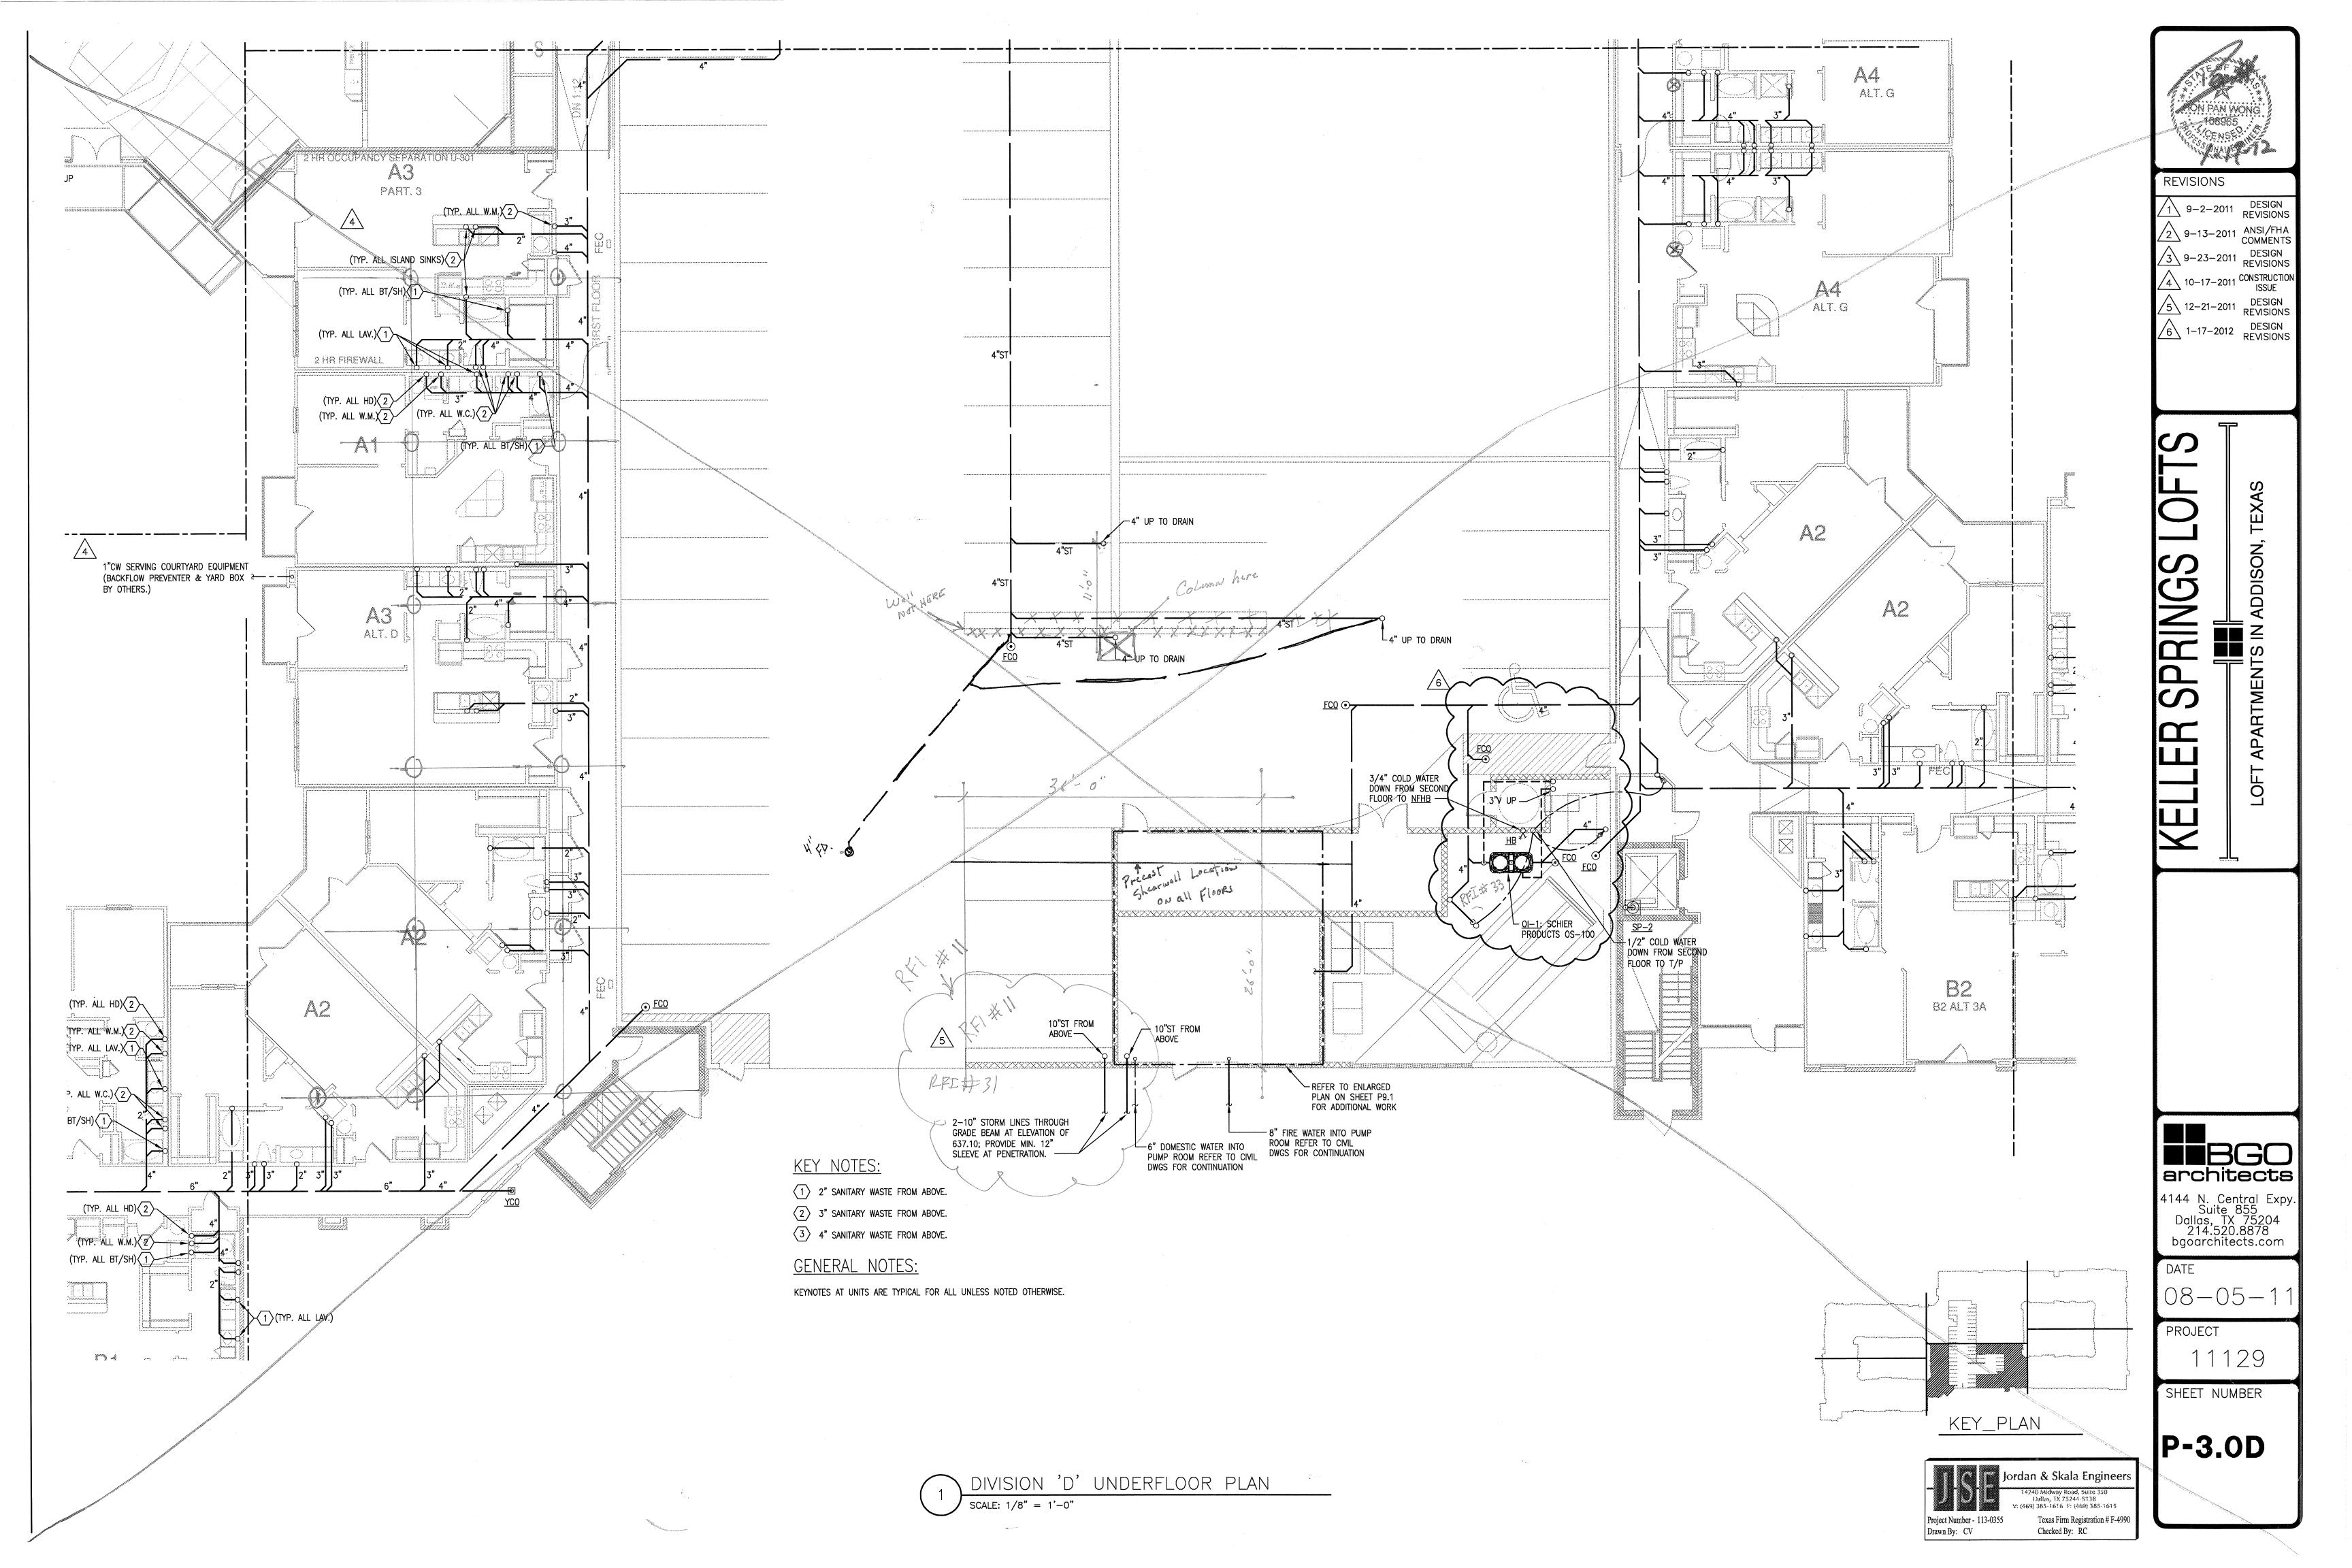

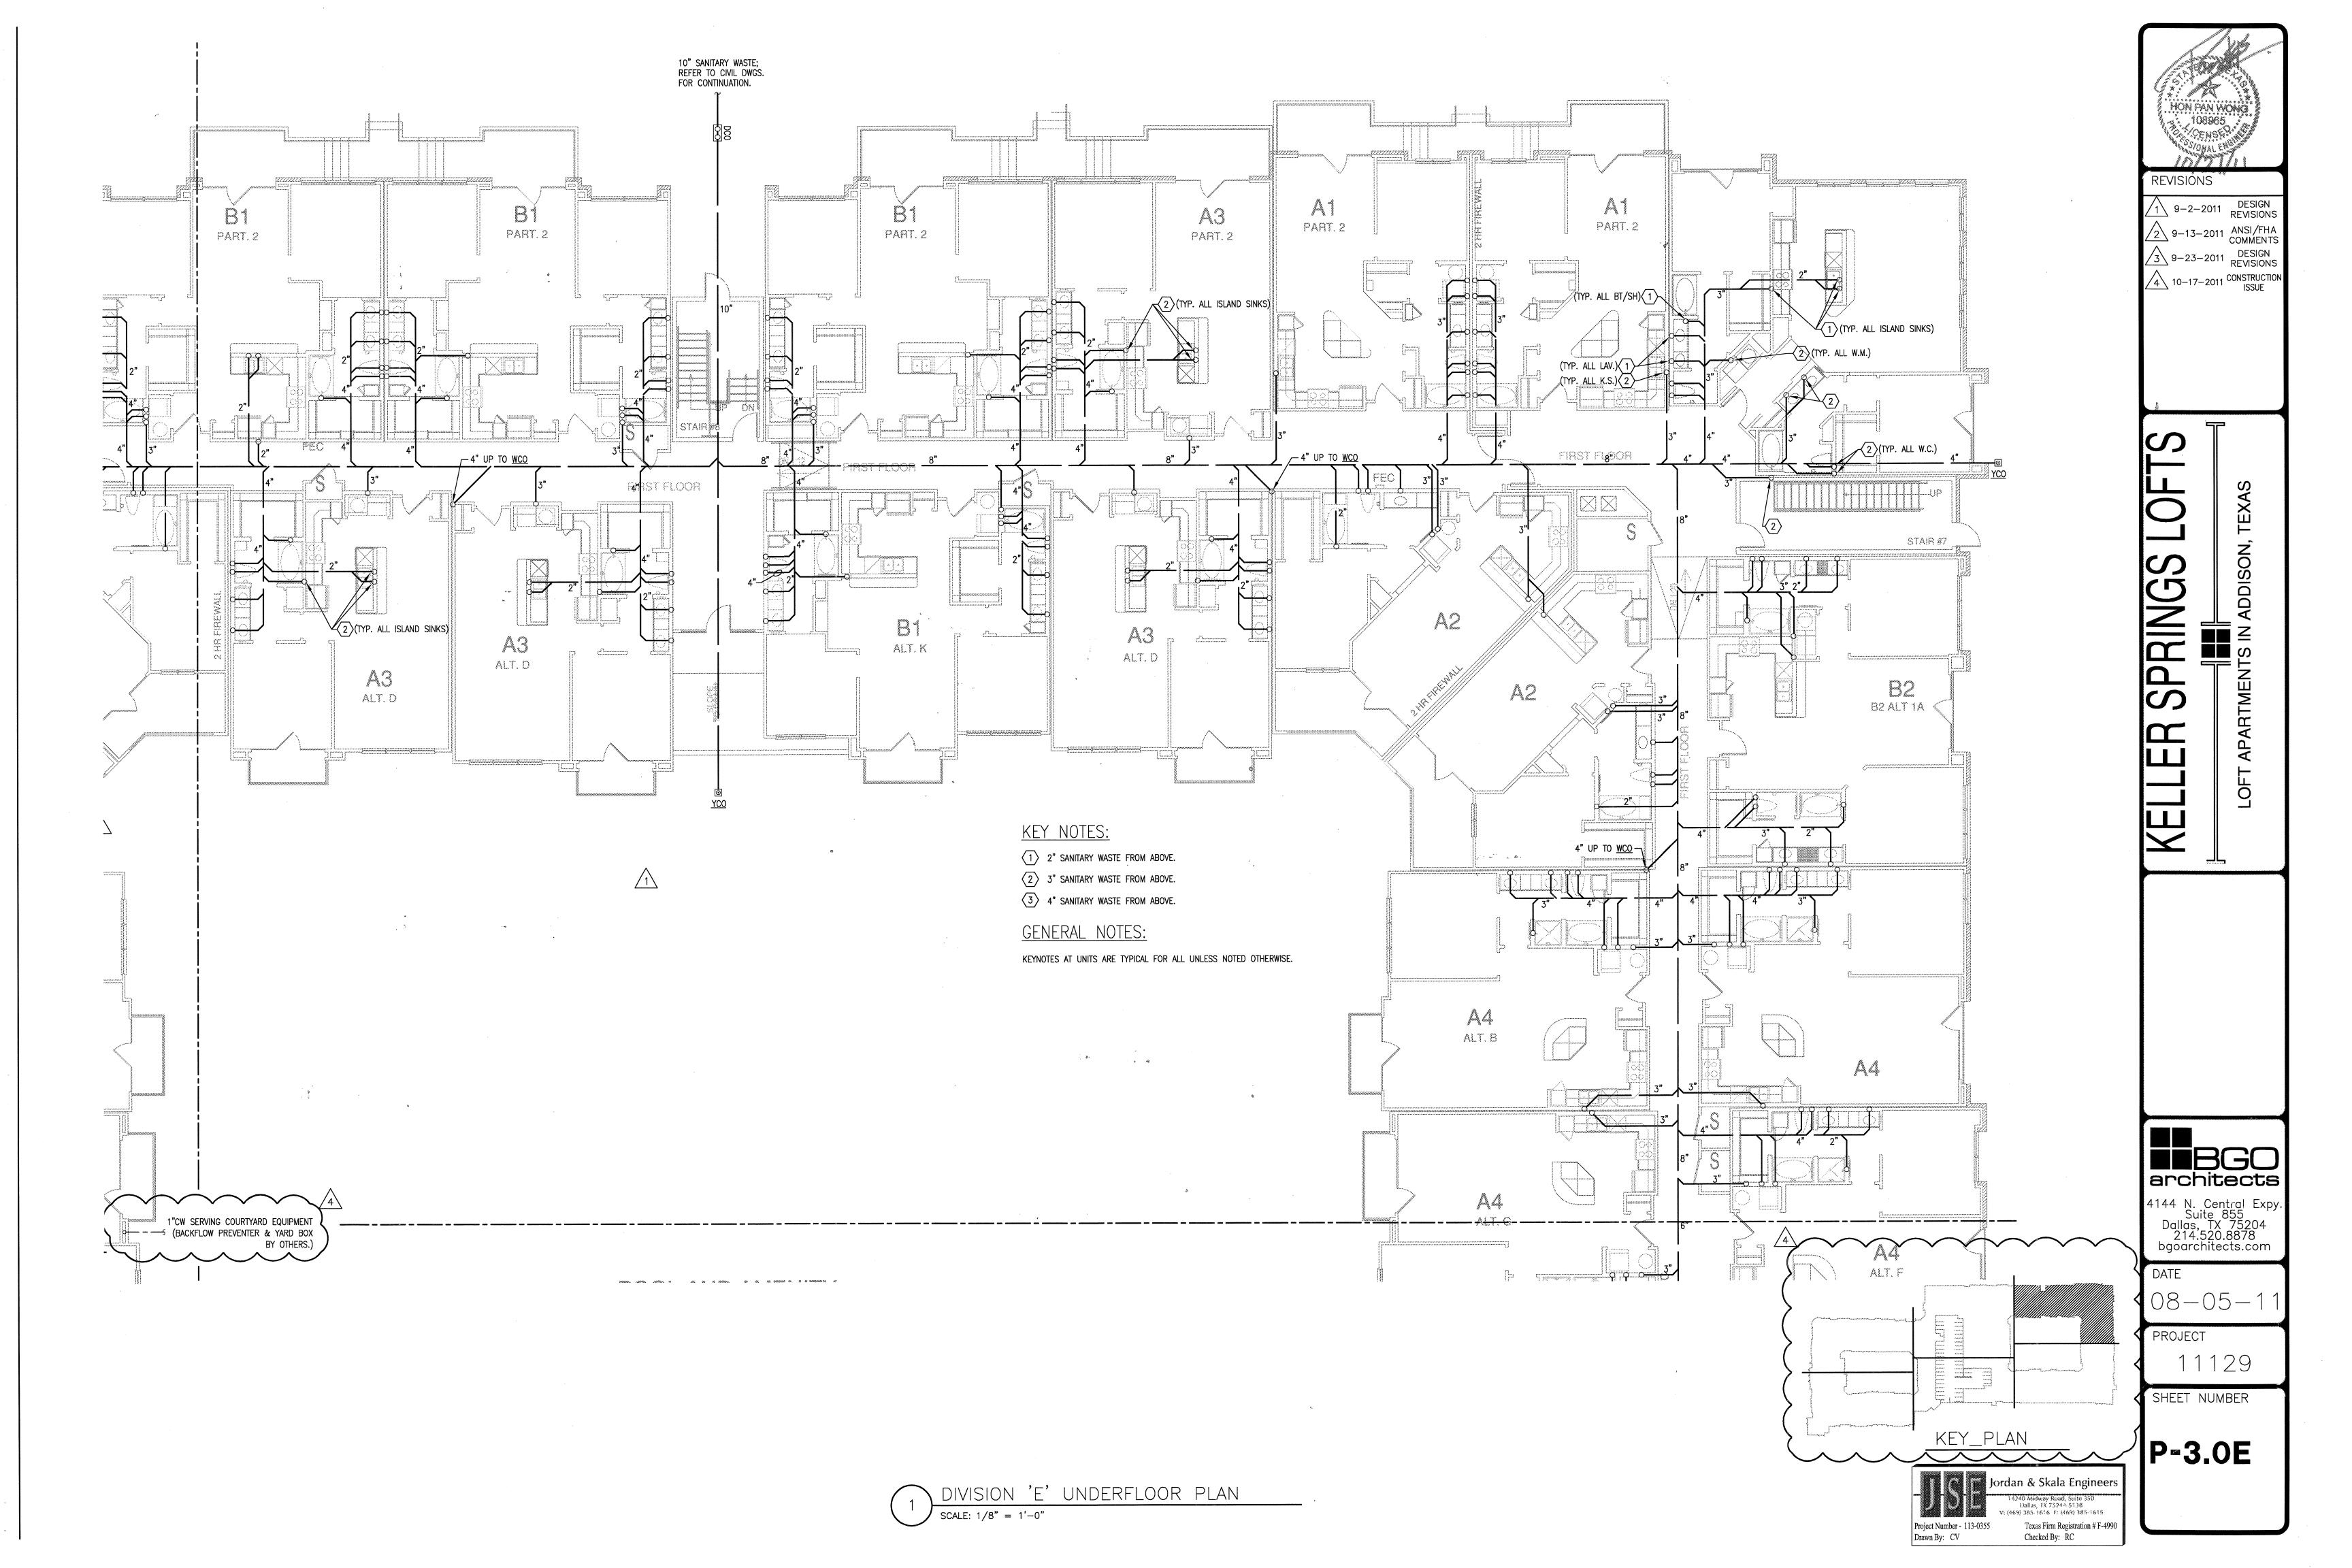

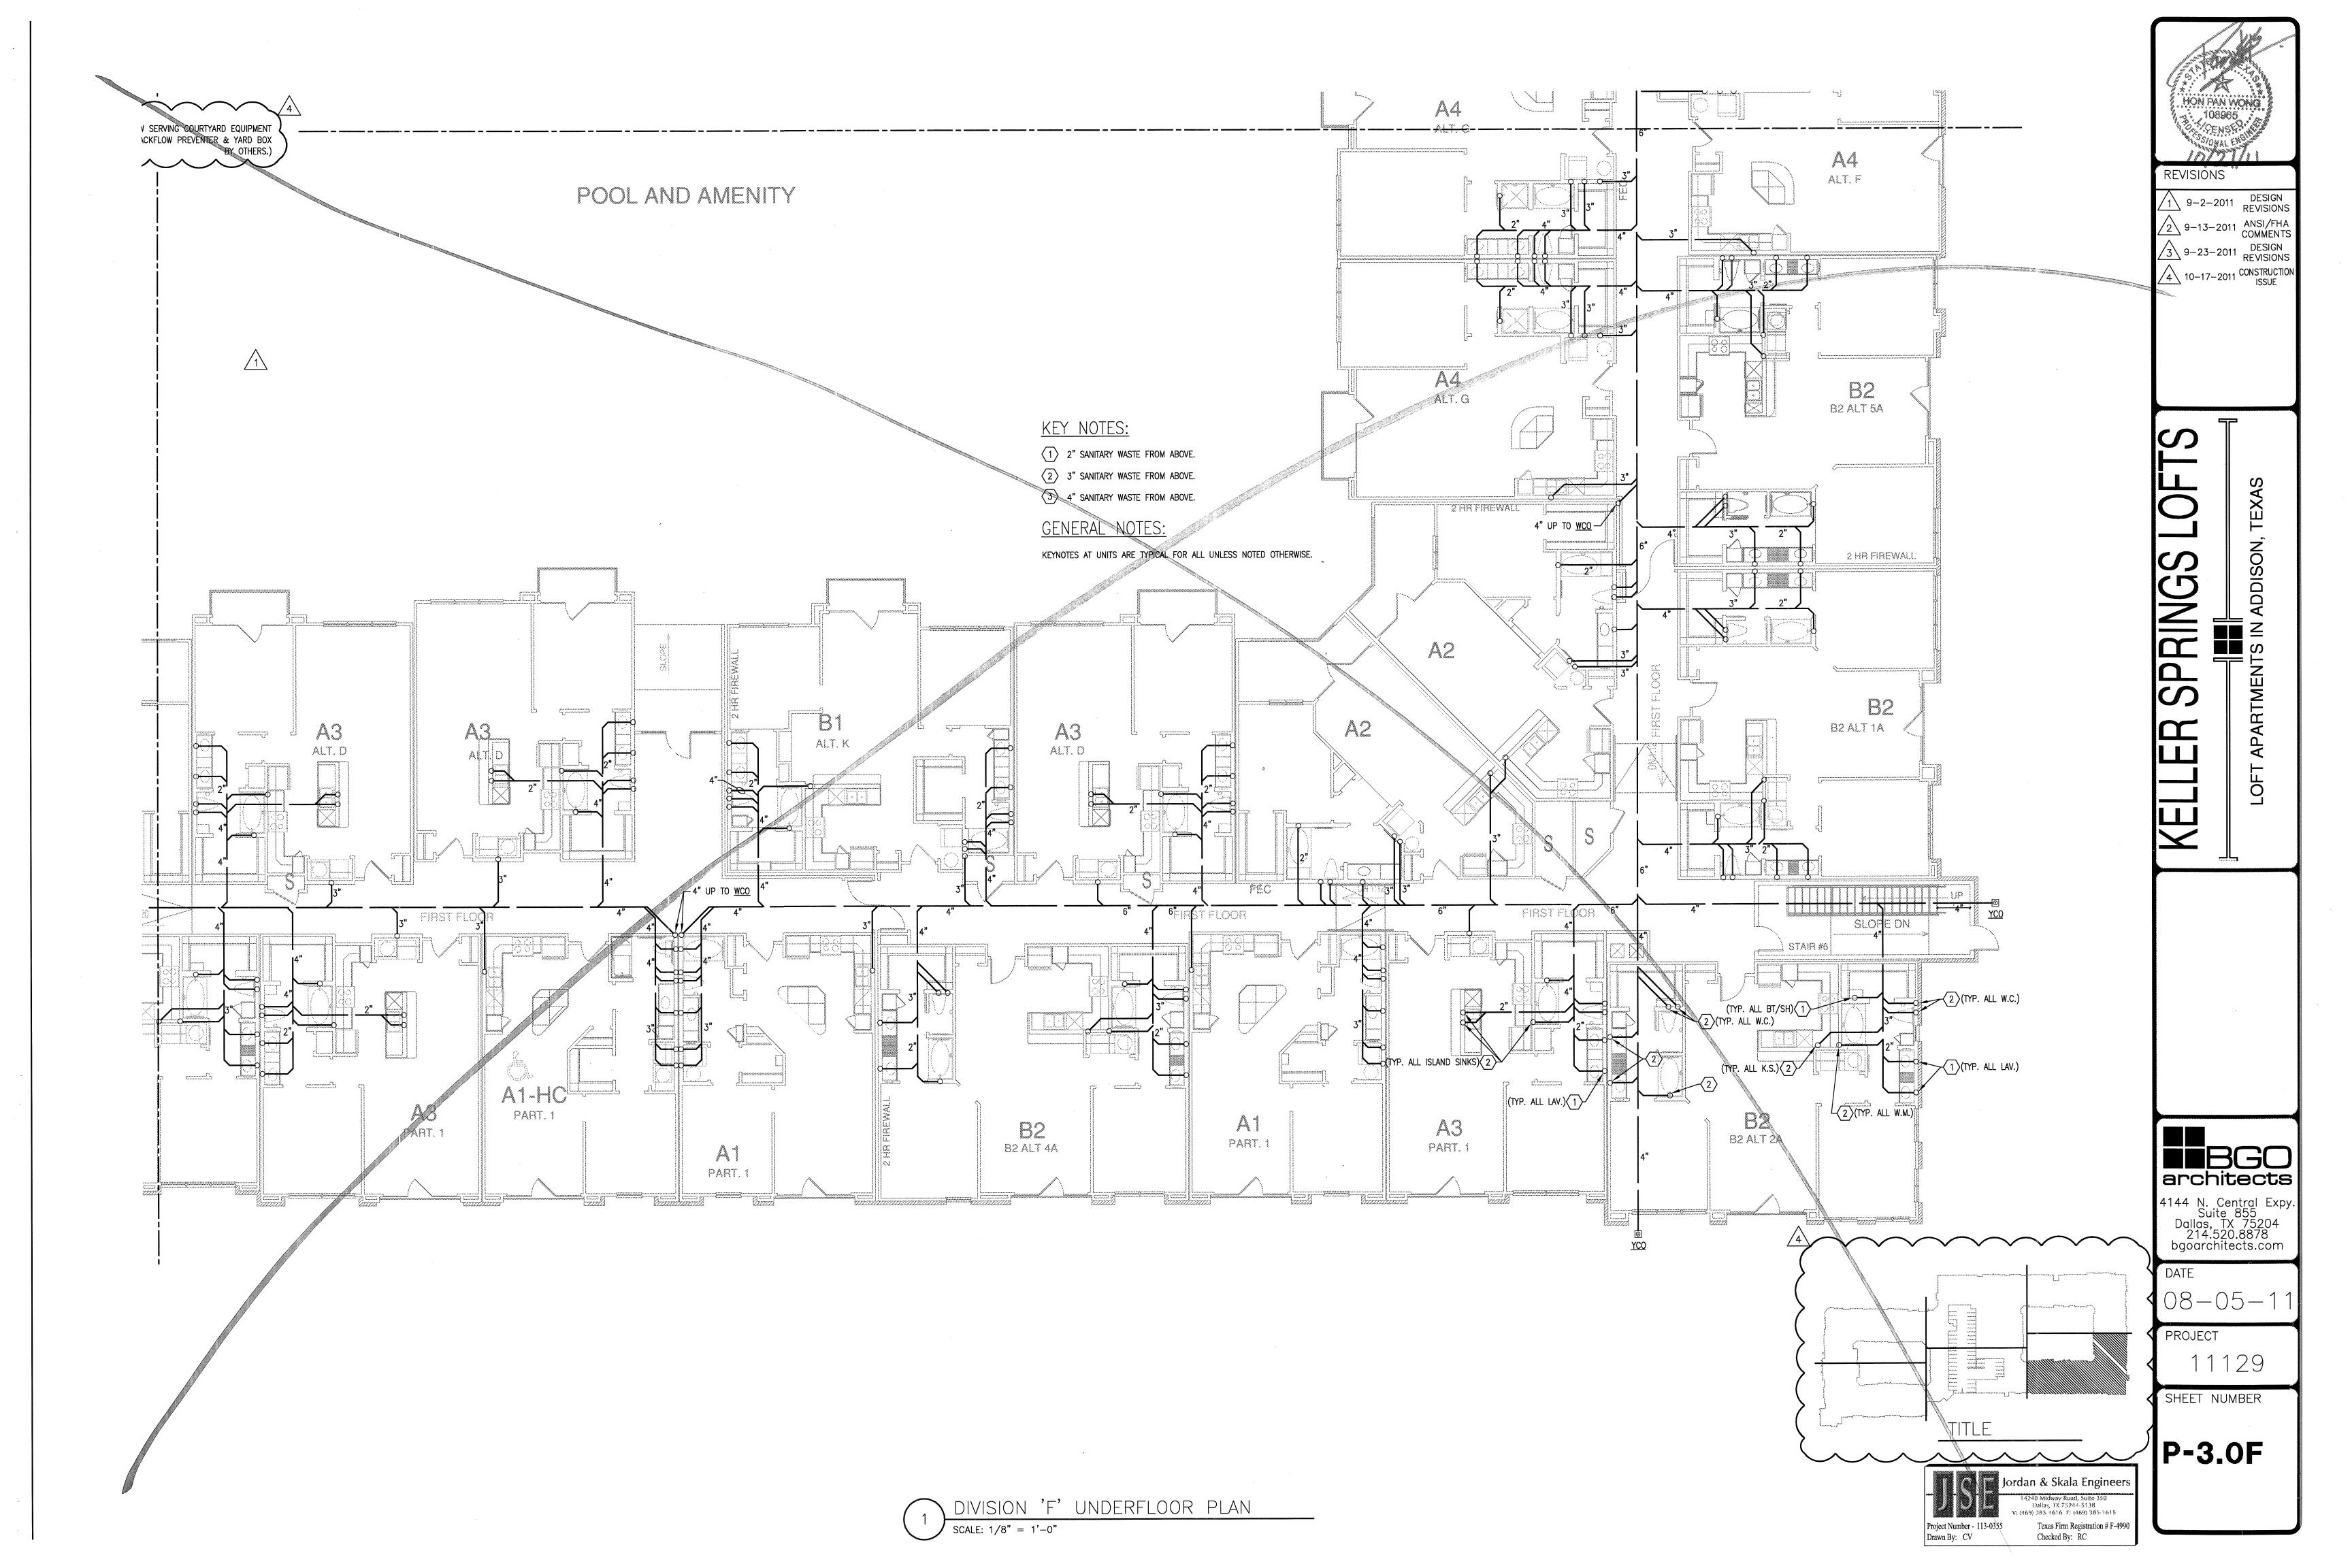

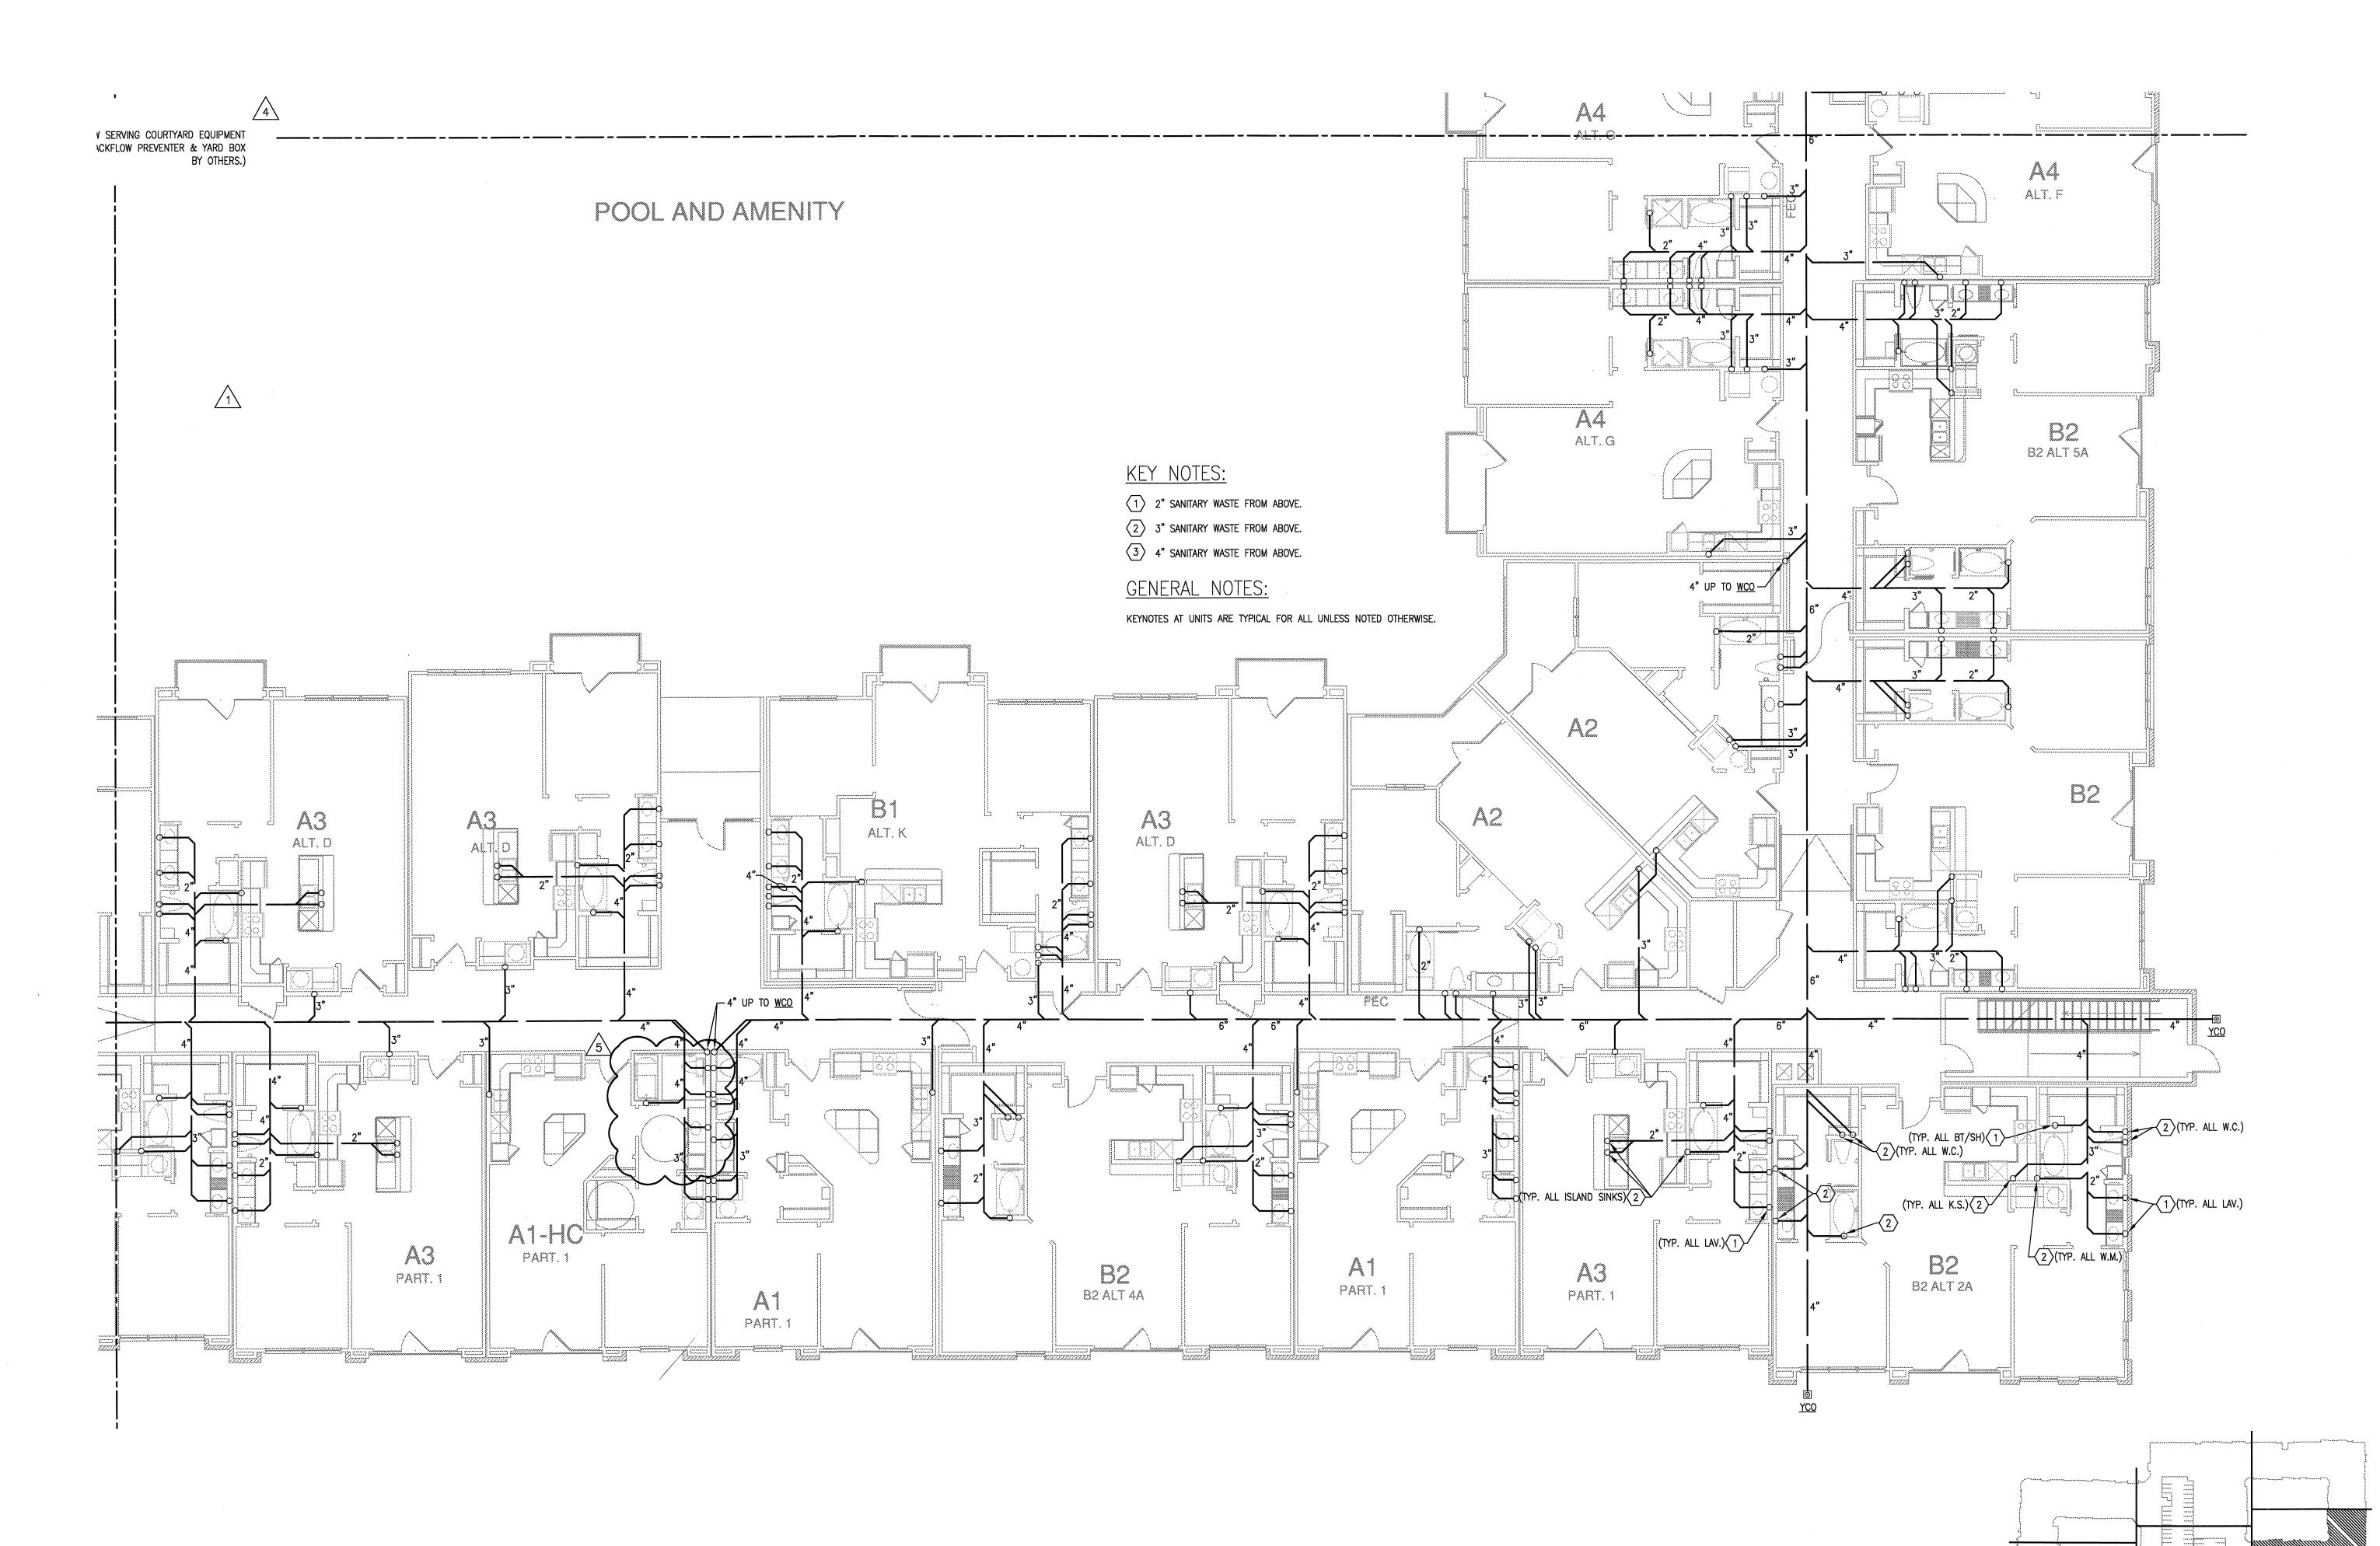

HON PAN WONG
108985

REVISIONS

 $\begin{array}{|c|c|c|c|}\hline 1 & 9-2-2011 & DESIGN \\ \hline 2 & 9-13-2011 & ANSI/FHA \\ \hline COMMENTS \\ \hline \hline 3 & 9-23-2011 & DESIGN \\ \hline \hline 4 & 10-17-2011 & CONSTRUCTION \\ \hline \hline |SSUE \\ \hline \hline 5 & 12-21-2011 & DESIGN \\ \hline REVISIONS \\ \hline \end{array}$ 

LOFT APARTMENTS IN A

## TOTAL STATE OF THE PROPERTY OF THE PROPERTY

ATE

08-05-1

PROJECT

11129 SHEET NUMBER

P-3.0F

KEY\_PLAN


Jordan & Skala Engineers


14240 Midwsy Road, Suite 350 Dallas, DX 75244-5138 V: (469) 385-1616 - F: (469) 385-1615


Texas Firm Registration # F-4990 Checked By: RC

DIVISION 'F' UNDERFLOOR PLAN

SCALE: 1/8" = 1'-0"

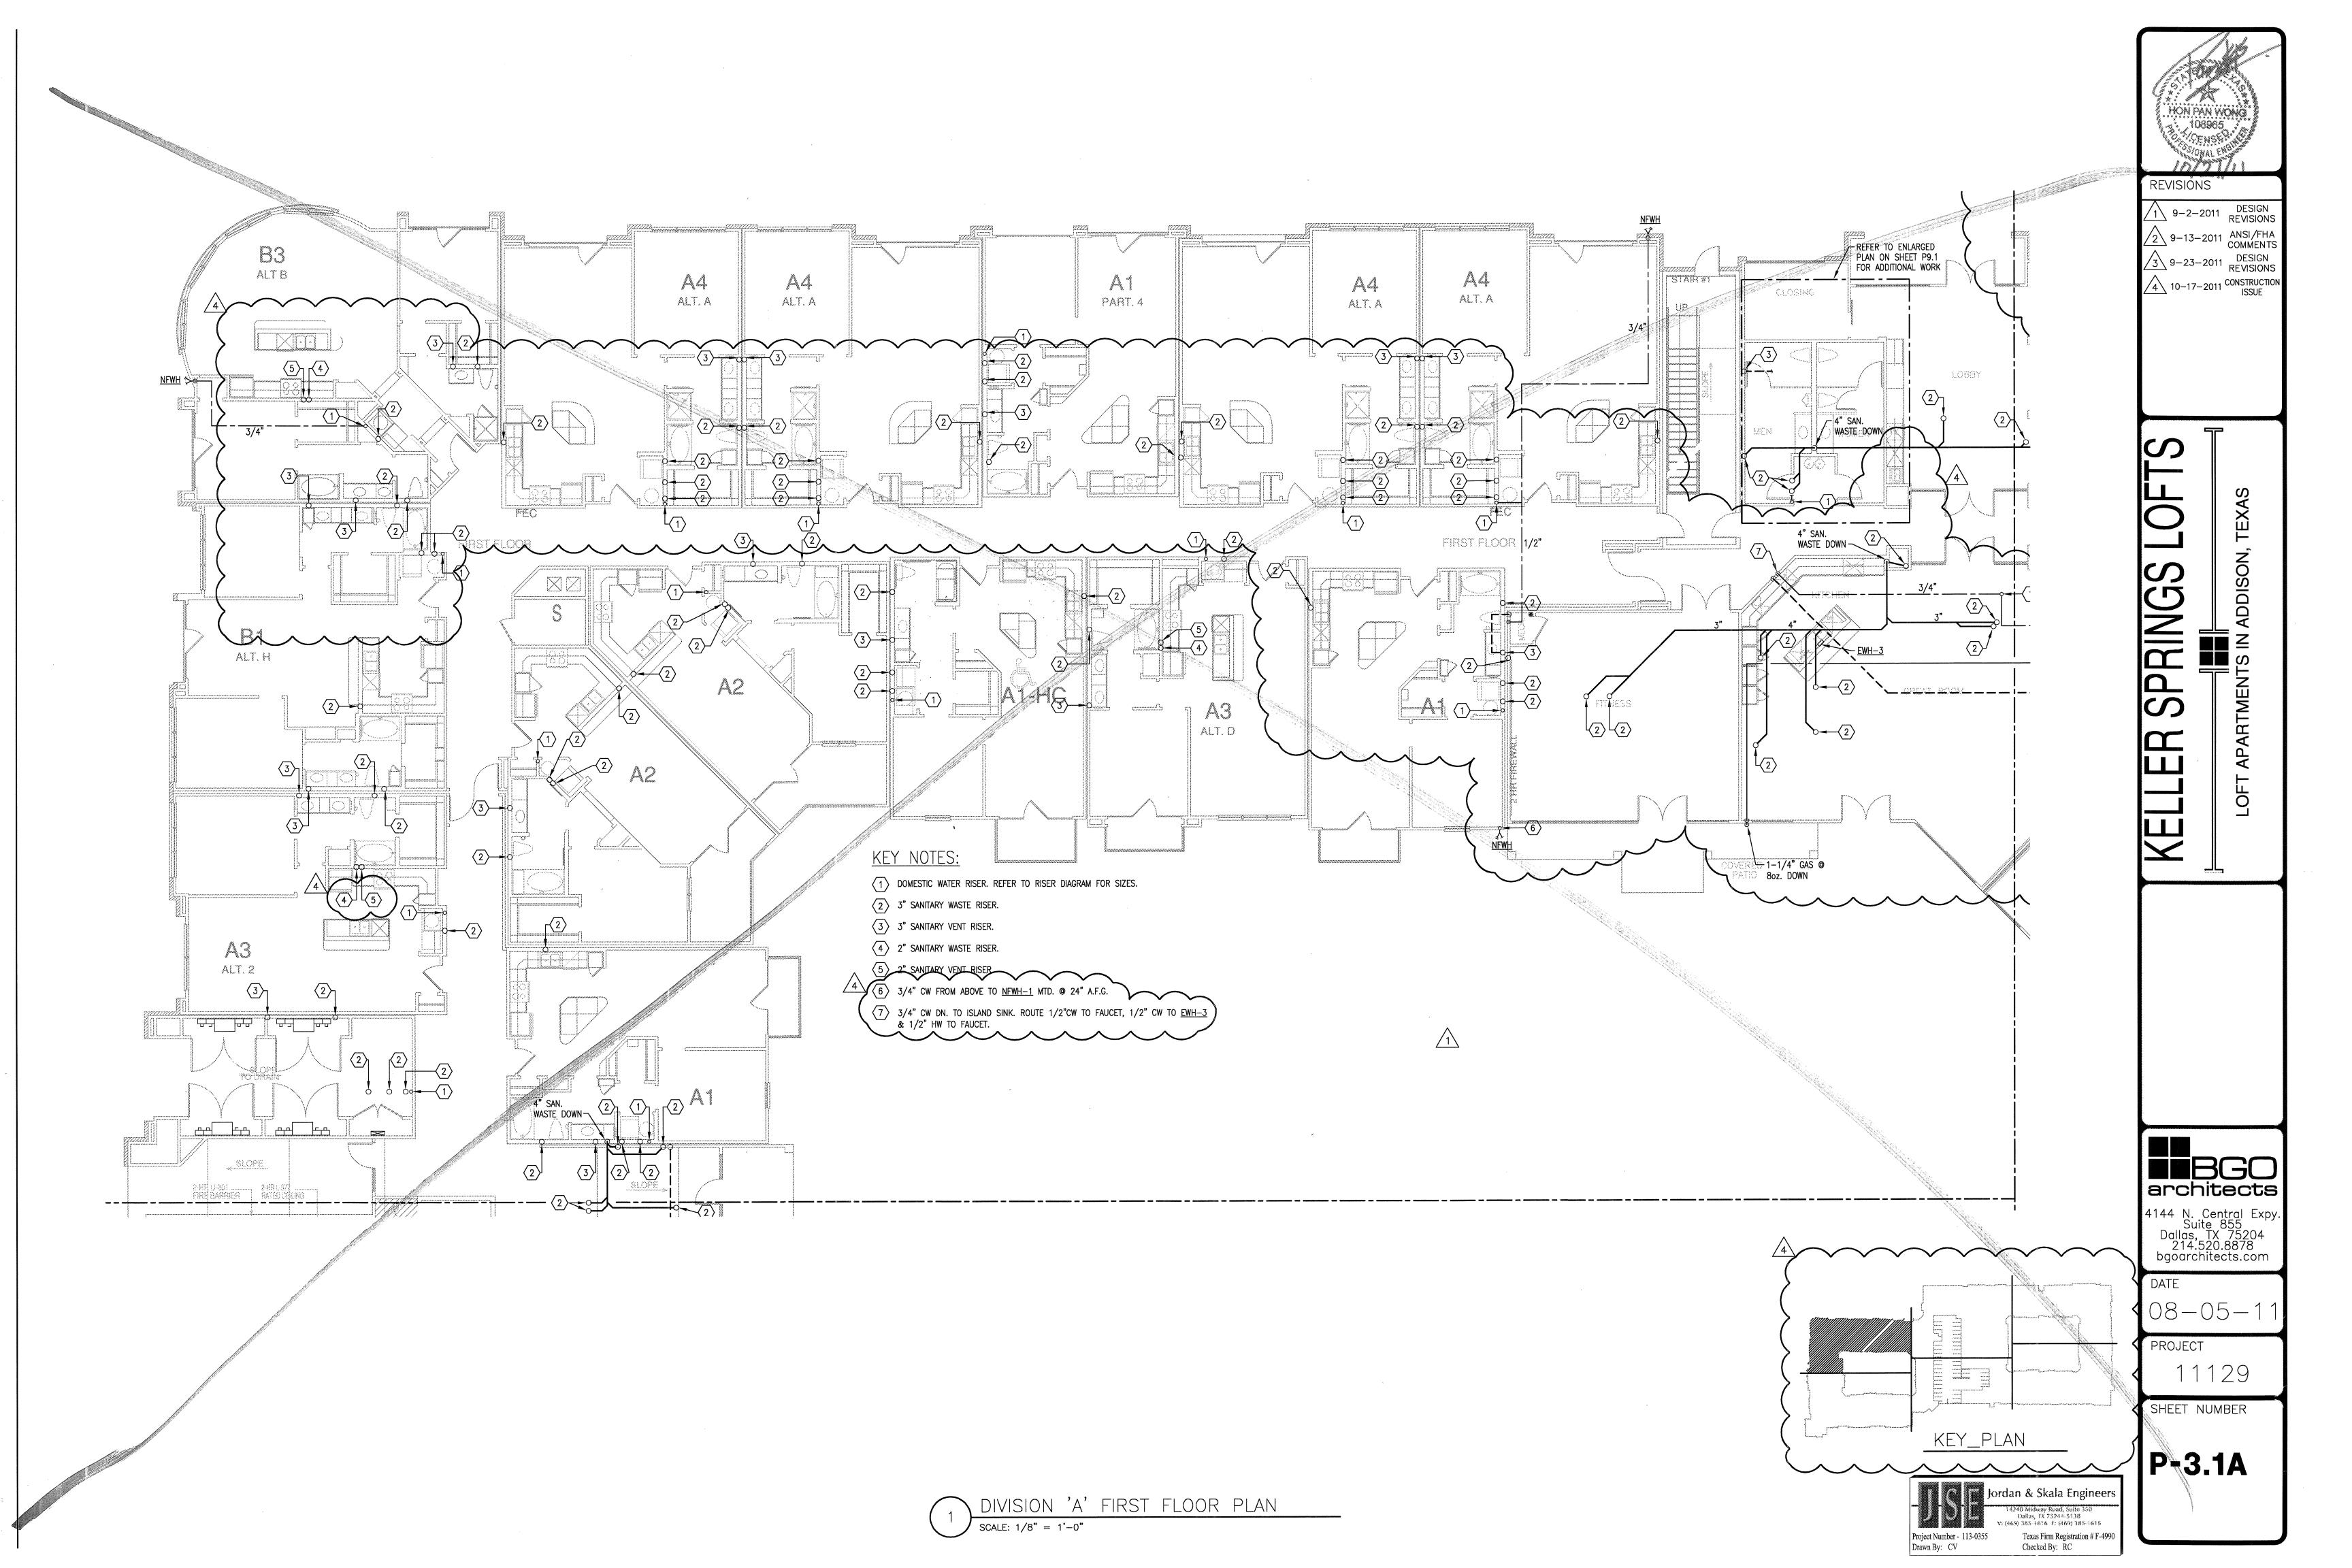

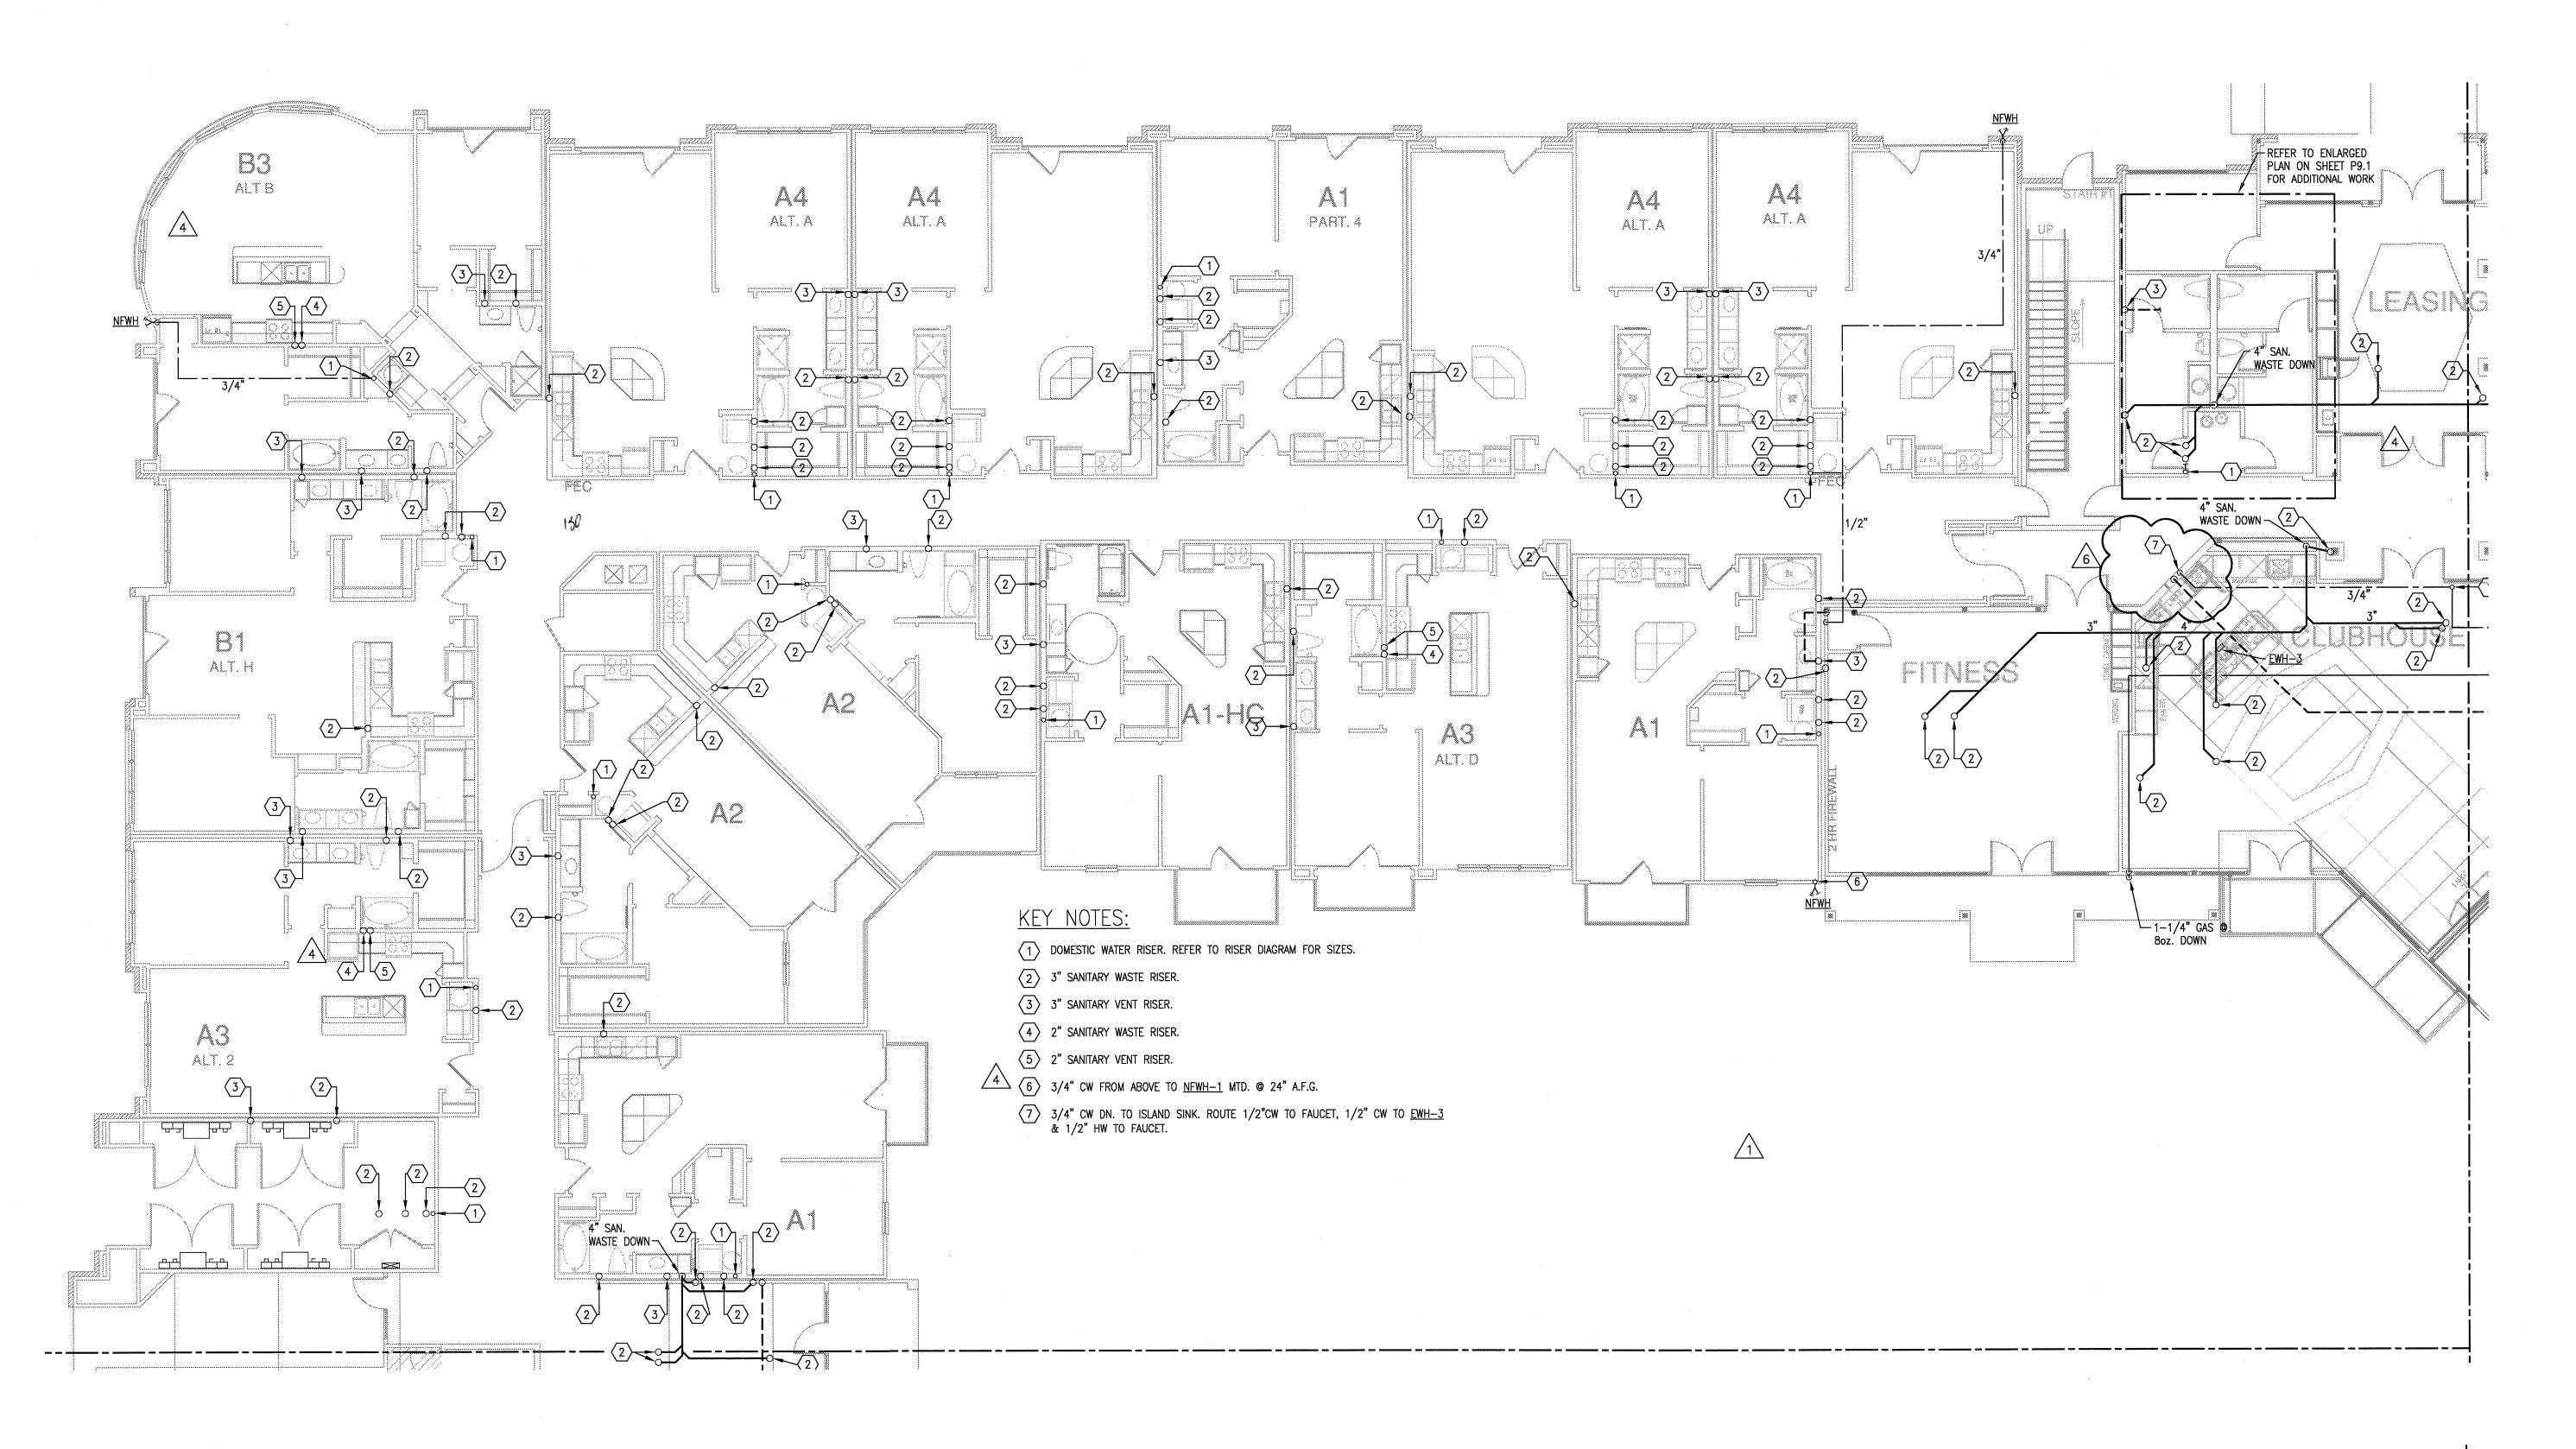

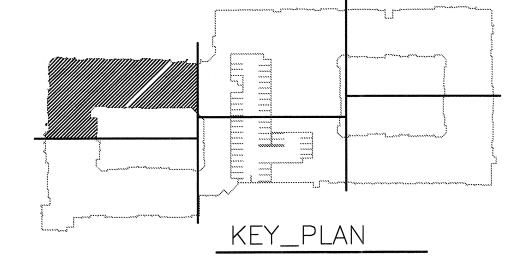

Jordan & Skala Engineers 14240 Midway Road, Saite 350 Dallas, TX 75244-5138 V: (469) 385-1616 F: (469) 385-1615 Texas Firm Registration # F-4990 Checked By: RC



REVISIONS

1 9-2-2011 DESIGN REVISIONS 9-13-2011 ANSI/FHA COMMENTS 3 9-23-2011 DESIGN REVISIONS

10-17-2011 CONSTRUCTION ISSUE

5 12-21-2011 DESIGN REVISIONS

6 1-17-2012 DESIGN REVISIONS

SPRINGS

BBGO architects 4144 N. Central Expy. Suite 855 Dallas, TX 75204 214.520.8878 bgoarchitects.com


DATE

08-05-1

PROJECT

SHEET NUMBER

P-3.1A

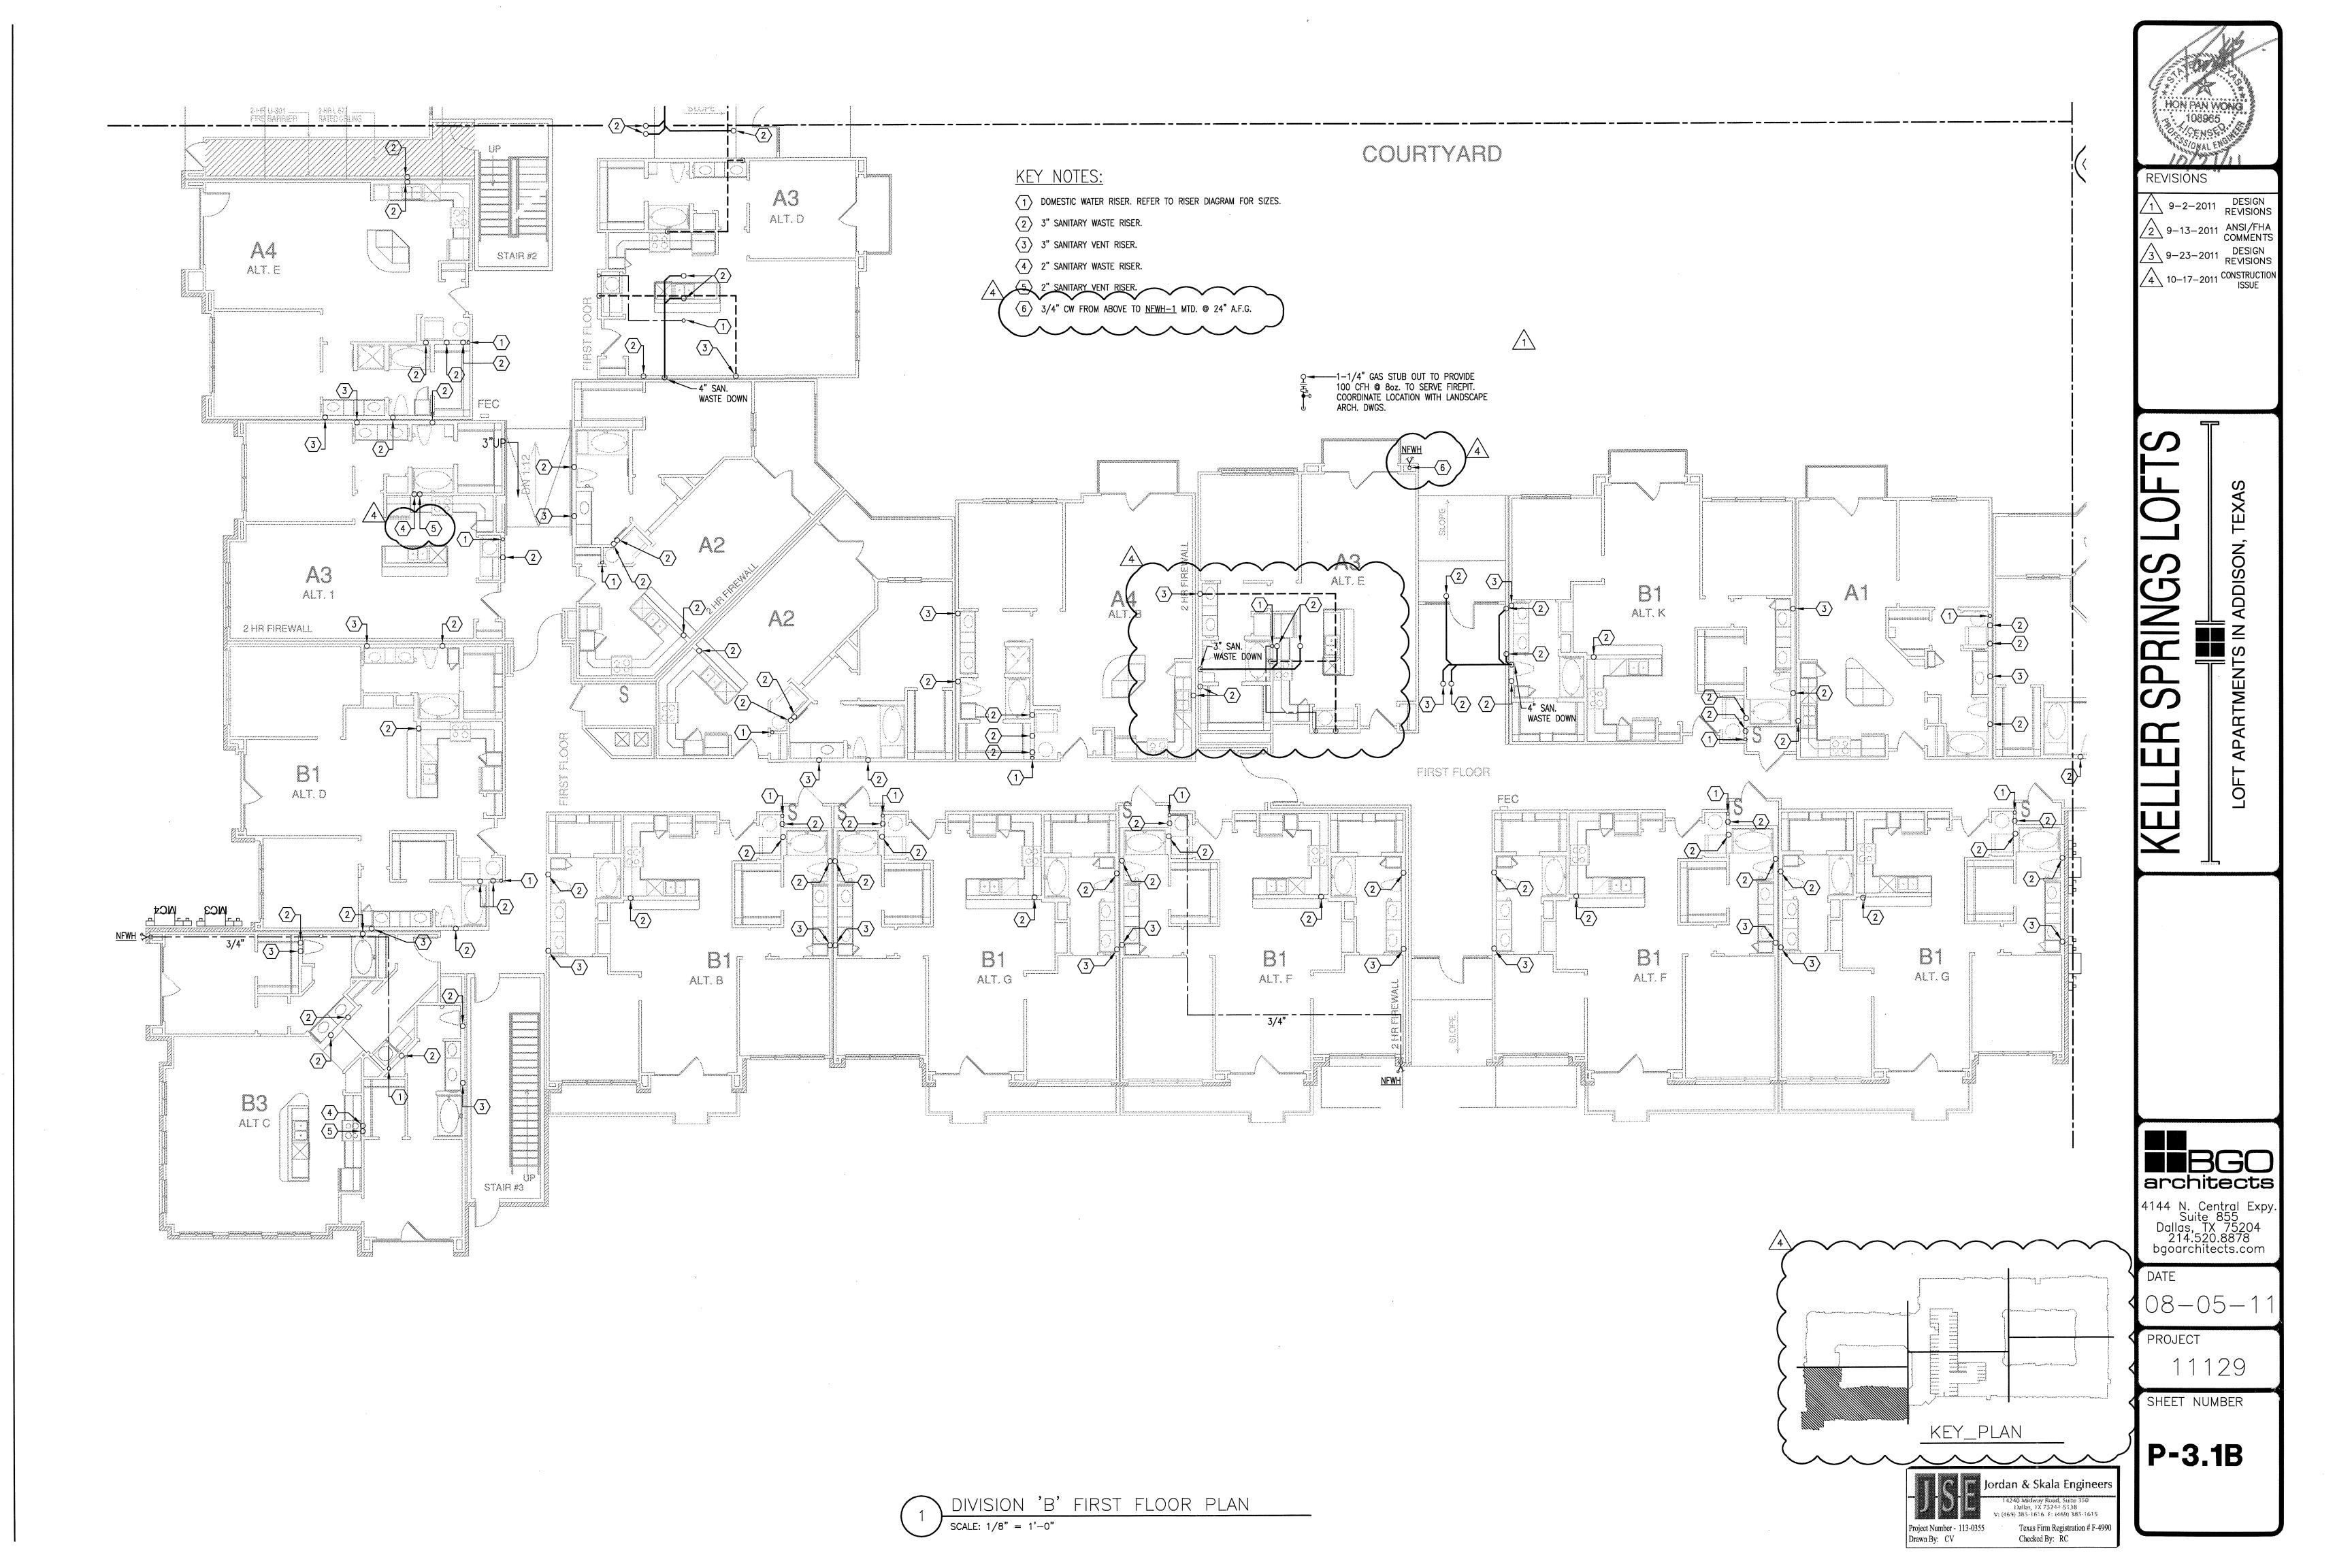

<b>EMBREY</b>	BUILDERS,	LLC
1020 N. E. Loc	op 410, Suite 700	

San Antonio, TX 78209	
Ph: (210) 824-6044 Fax: (210) 824-7656	

To: Jordan & Skala Engineers, Inc. 14240 Midway Road, Suite 350

RFI #: 73

Date: 3/12/2012

Job: EB-02 Keller Springs Lofts

Phone: 877-777-5115

cc: David Gallagher (Embrey Builders LLC)

Ph: 469/385-1616 Fax: 469/385-1615

Subject: Proper location of gas meter

Dallas, TX 75244

**Drawing:** C10 P-3.1C **Cost Impact:** None

Spec Section:
Schedule Impact: None

RFI

Request:

The location for the gas meter appears to have changed from its original location reflected on C 10 on the Civil Plans. The new location appears on the Jordan Skala

SK-P1 dated 01-19-2012. It is on a completely different part of the building from C 10 and slightly different than P-3.1C. Attached is SK-P1 which is where it's located on C 10. SK # 2 reflects where I feel it is intended to be located. SK-P1 is the revised sketch by Jordan Skala locating it where we believe it is supposed to go. I need confirmation that it does go the way I show it on SK #2 and as shown on SK-P1.

Like I said, I need the surveyors to stake the proper location tomorrow.

Requested by: Bryan Pickler

Embrey Partners, Ltd.

Response:

The gas meter should be located in the spots shown on SK#2 and SK-P1.

Heath Parnell

Answered by
JSE
Company

3-12-2012

Page 1 of 1

Embrey Builders, LLC 1020 N. E. Loop 410, Suite 700 San Antonio, TX 78209

Ph : (210) 824-6044 Fax: (210) 824-7656

RFI

To: Heath Parnell
Jordan & Skala Engineers, Inc.
14240 Midway Road, Suite 350

RFI #: 184

Date: 8/23/2012

Job: EB-02 Keller Springs Lofts

Phone: 877-777-5115

Dallas, TX 75244
Ph: 469/385-1616 Fax: 469/385-1615

CC:
Subject: New route of the domestic water line from the garage

Drawing: P-3.1C P-3.1D

Spec Section:
Schedule Impact: None

Cost Impact: None

Request:

Date Required: 8/24/2012

We are requesting approval to run the domestic water shown on P-3.2D (2nd level) on the 1st level which is reflected on the attached sketches using sheet P-3.1D. Embrey working with our plumbing contractor (Performance Mechanical) has come up with a working location sketch that we feel will work best. Please review the self-explanatory sketches and approve our new route so we can proceed.

Requested by: Bryan Pickler
Embrey Partners, Ltd.

Response:

the proposed revision is acceptable

Answered by: Heath Parnell

Answered date: August 24, 2012

Jordan & Skala Engineers, Inc.

Page 1 of 1

## EMBREY BUILDERS, LLC.

1020 N. E. Loop 410, Suite 700 San Antonio, TX 78209 Ph: (210) 824-6044 Fax: (210) 824-7656

L

To: Jordan & Skala Engineers, Inc. 14240 Midway Road, Suite 350

RFI#: 73

Date: 3/12/2012

3-12-2012

Dallas, TX 75244

Ph: 469/385-1616 Fax: 469/385-1615

Date: 3/12/2012

Job: EB-02 Keller Springs Lofts

Phone: 877-777-5115

cc: David Gallagher (Embrey Builders LLC)

Subject: Proper location of gas meter

Drawing: C10 P-3.1C
Cost Impact: None

Spec Section:
Schedule Impact: None

RFI

Request:

The location for the gas meter appears to have changed from its original location reflected on C 10 on the Civil Plans. The new location appears on the Jordan Skala
SK-P1 dated 01-19-2012. It is on a completely different part of the building from C 10 and slightly different than P-3.1C. Attached is SK # 1 which is where it's located on C 10. SK # 2 reflects where I feel it is intended to be located. SK-P1 is the revised sketch by Jordan Skala locating it where we believe it is supposed to go. I need confirmation that it does go the way I show it on SK #2 and as shown on SK-P1.

Like I said, I need the surveyors to stake the proper location tomorrow.

Requested by: Bryan Pickler

Embrey Partners, Ltd.

Response:

The gas meter should be located in the spots shown on SK#2 and SK-P1.

Heath Parnell


Answered by JSE


\_\_\_\_


Company


Do

Page 1 of 1

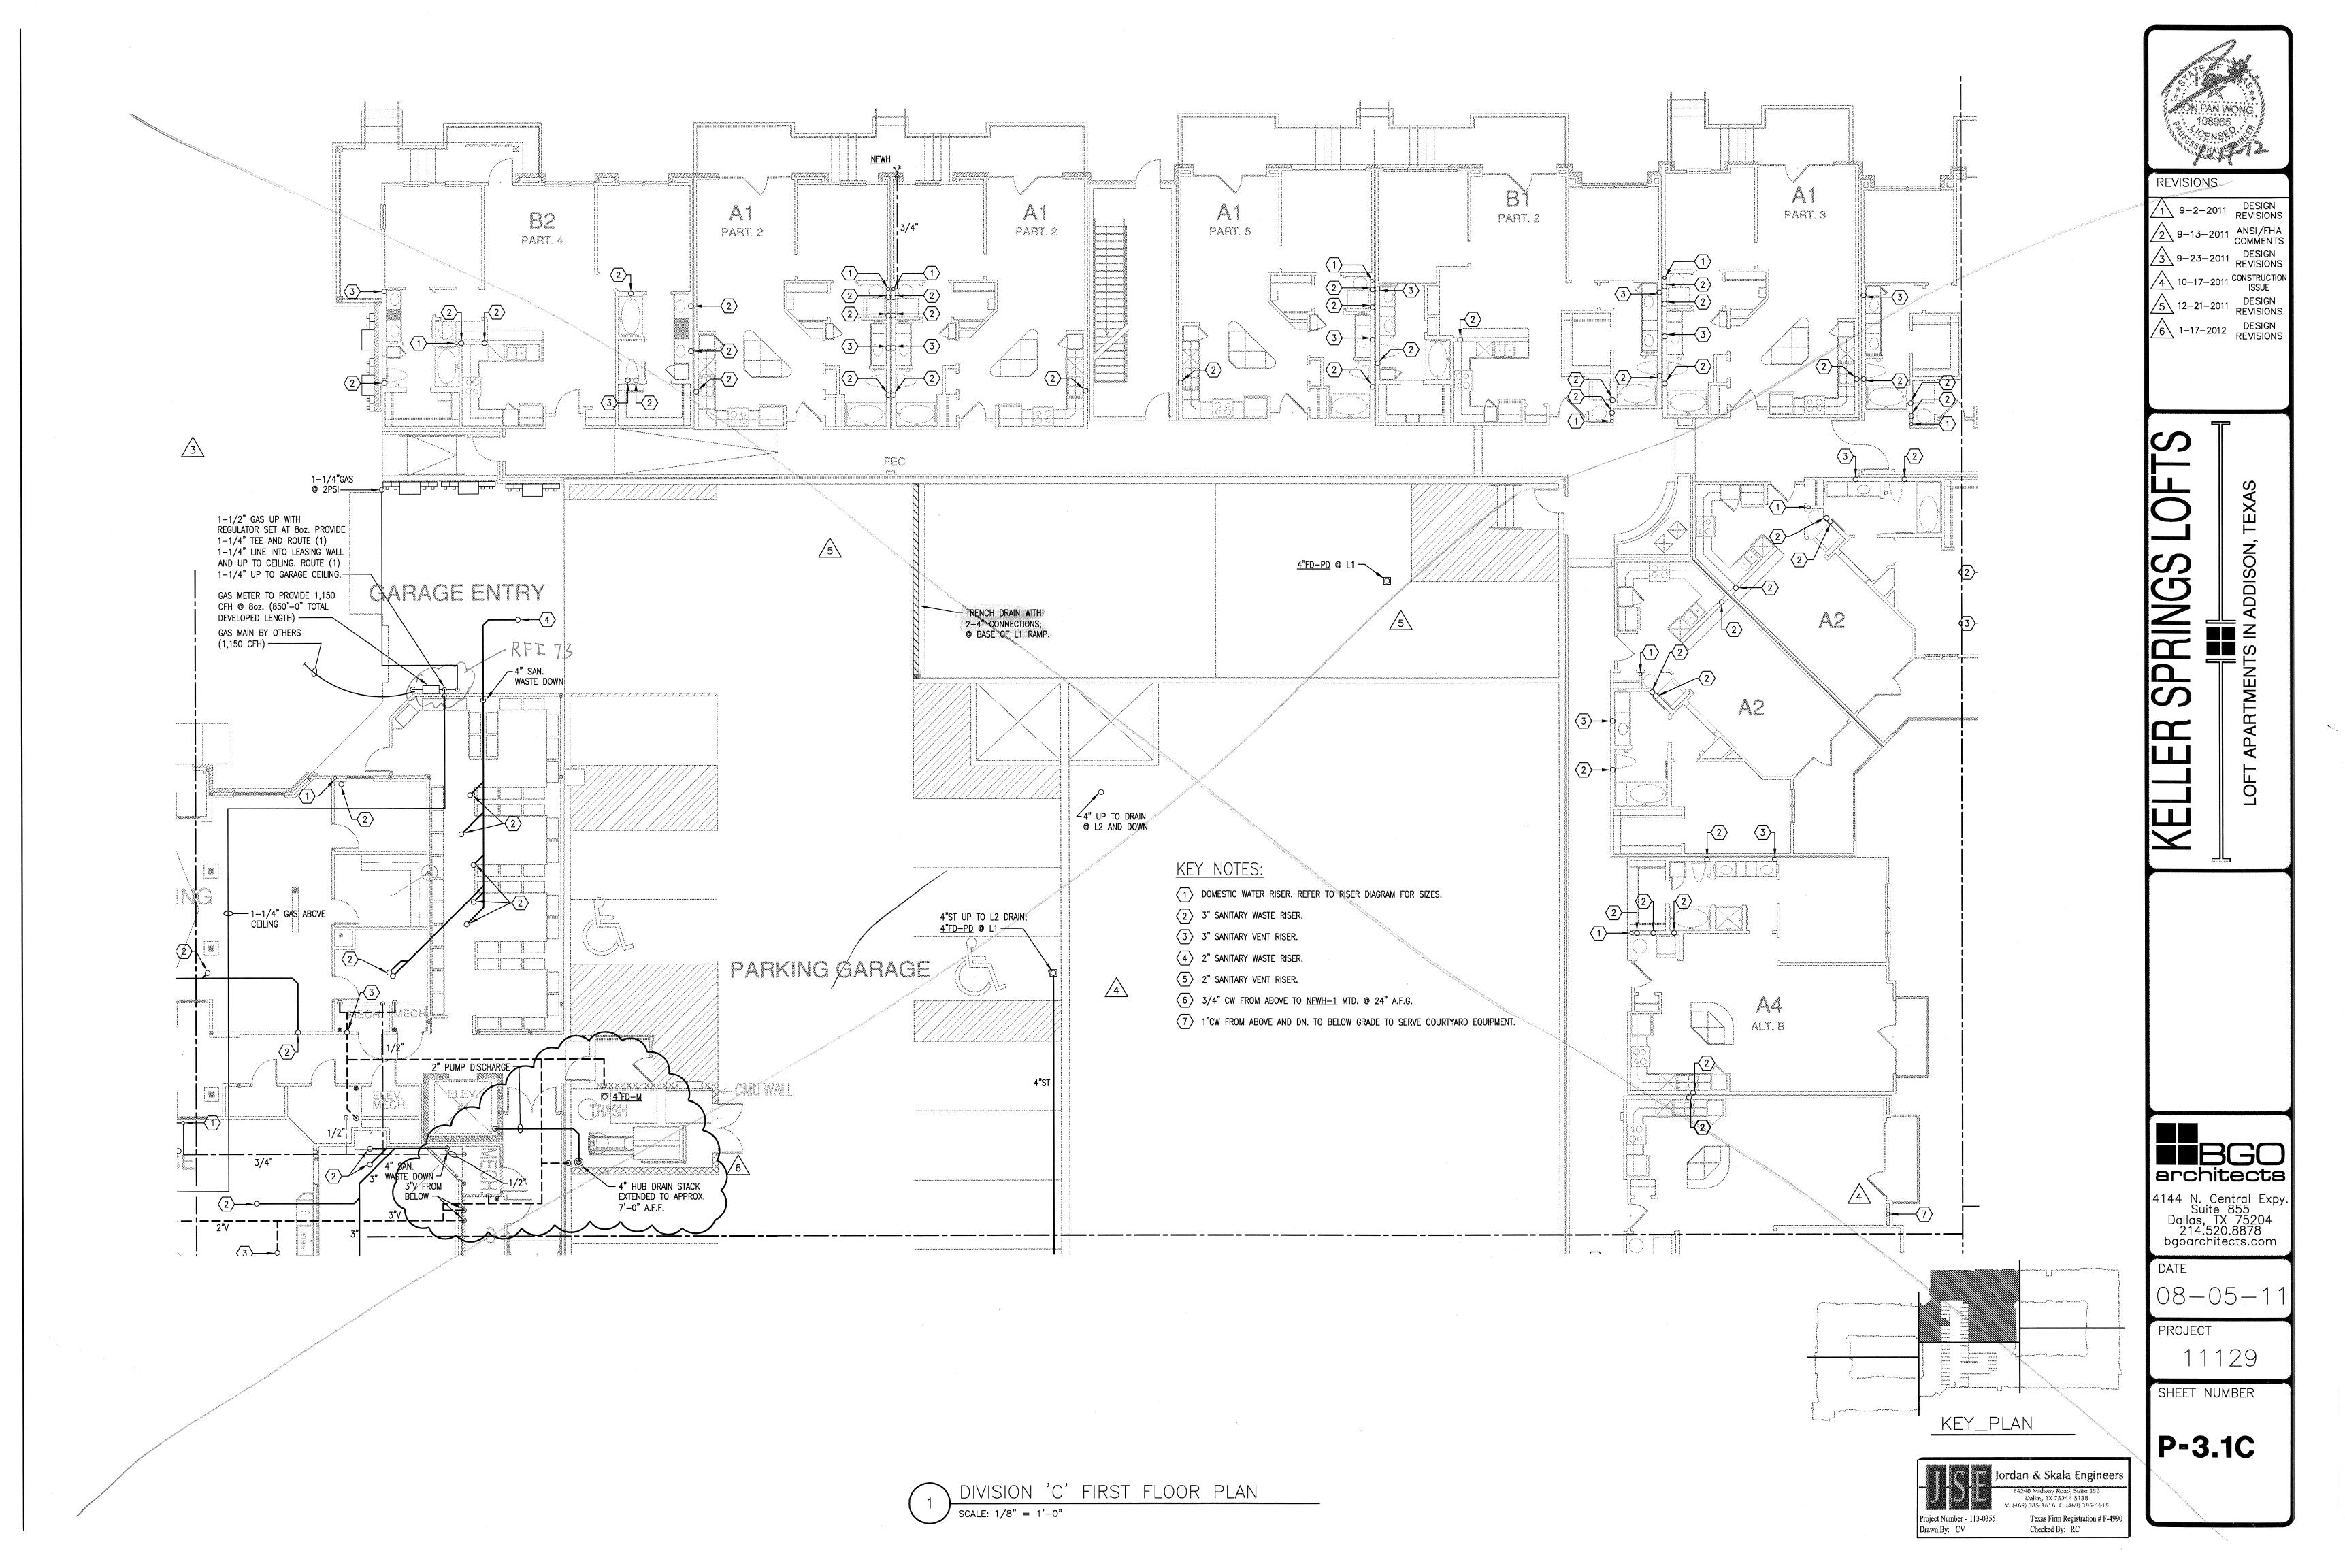


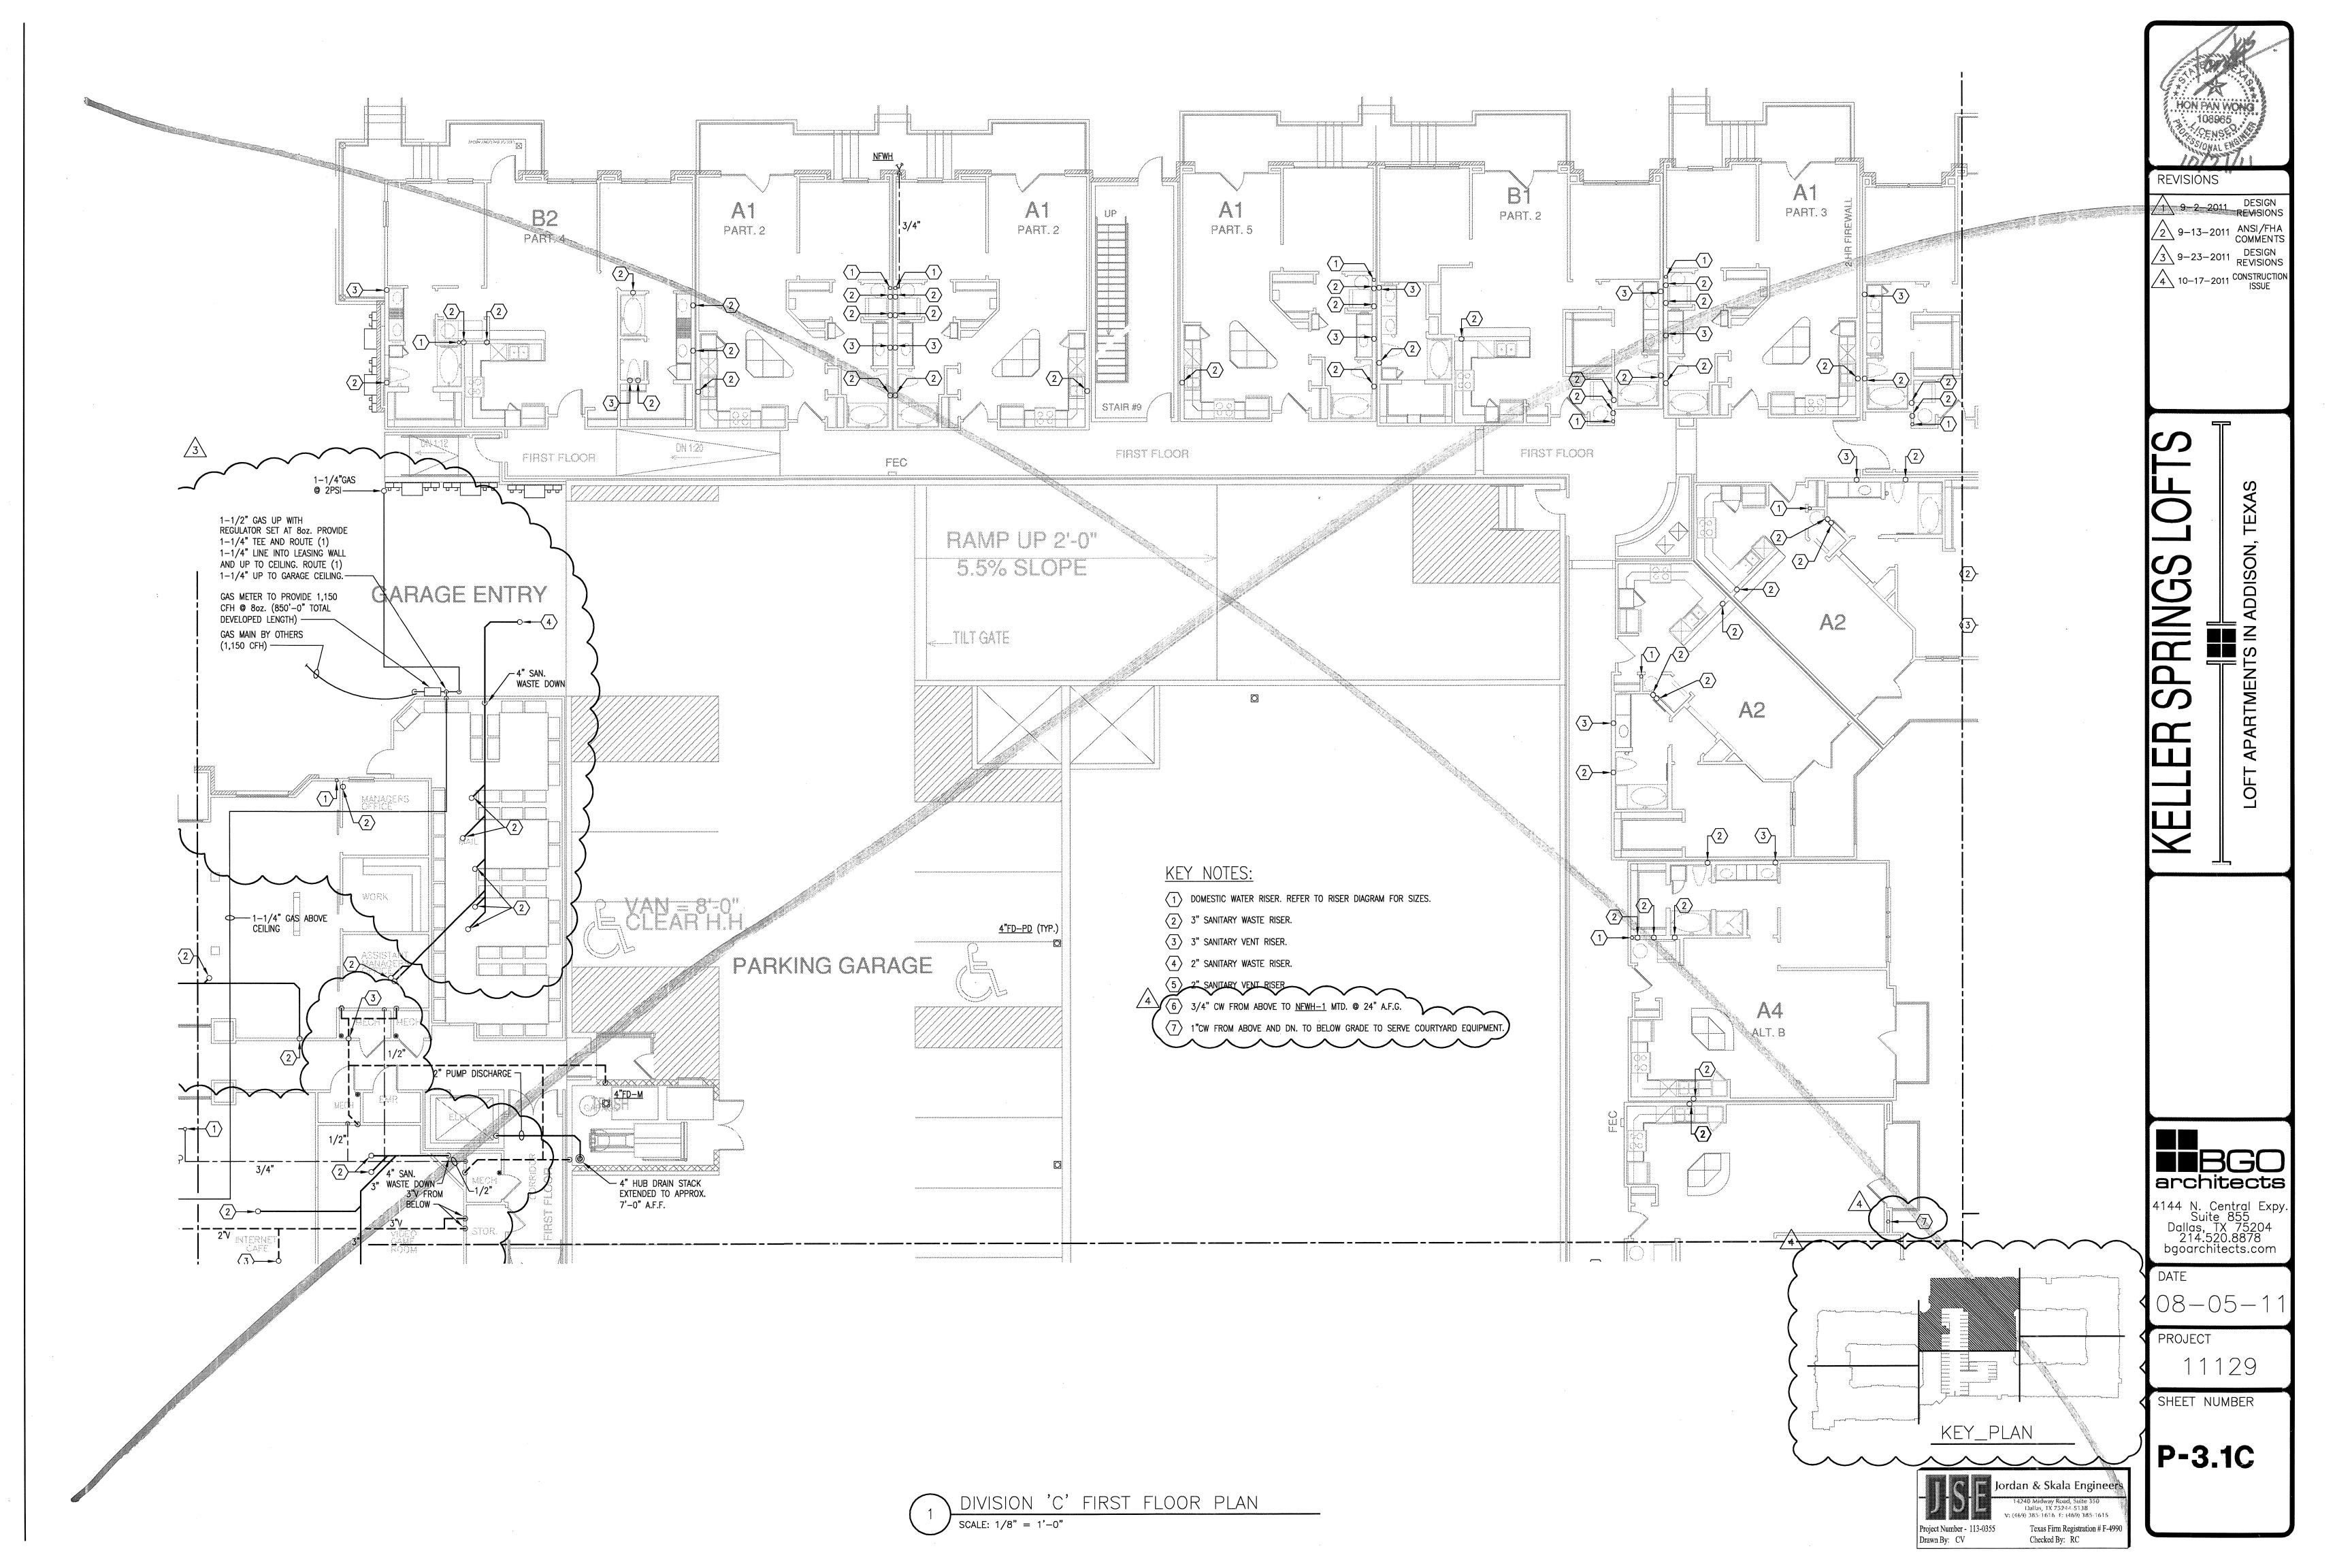

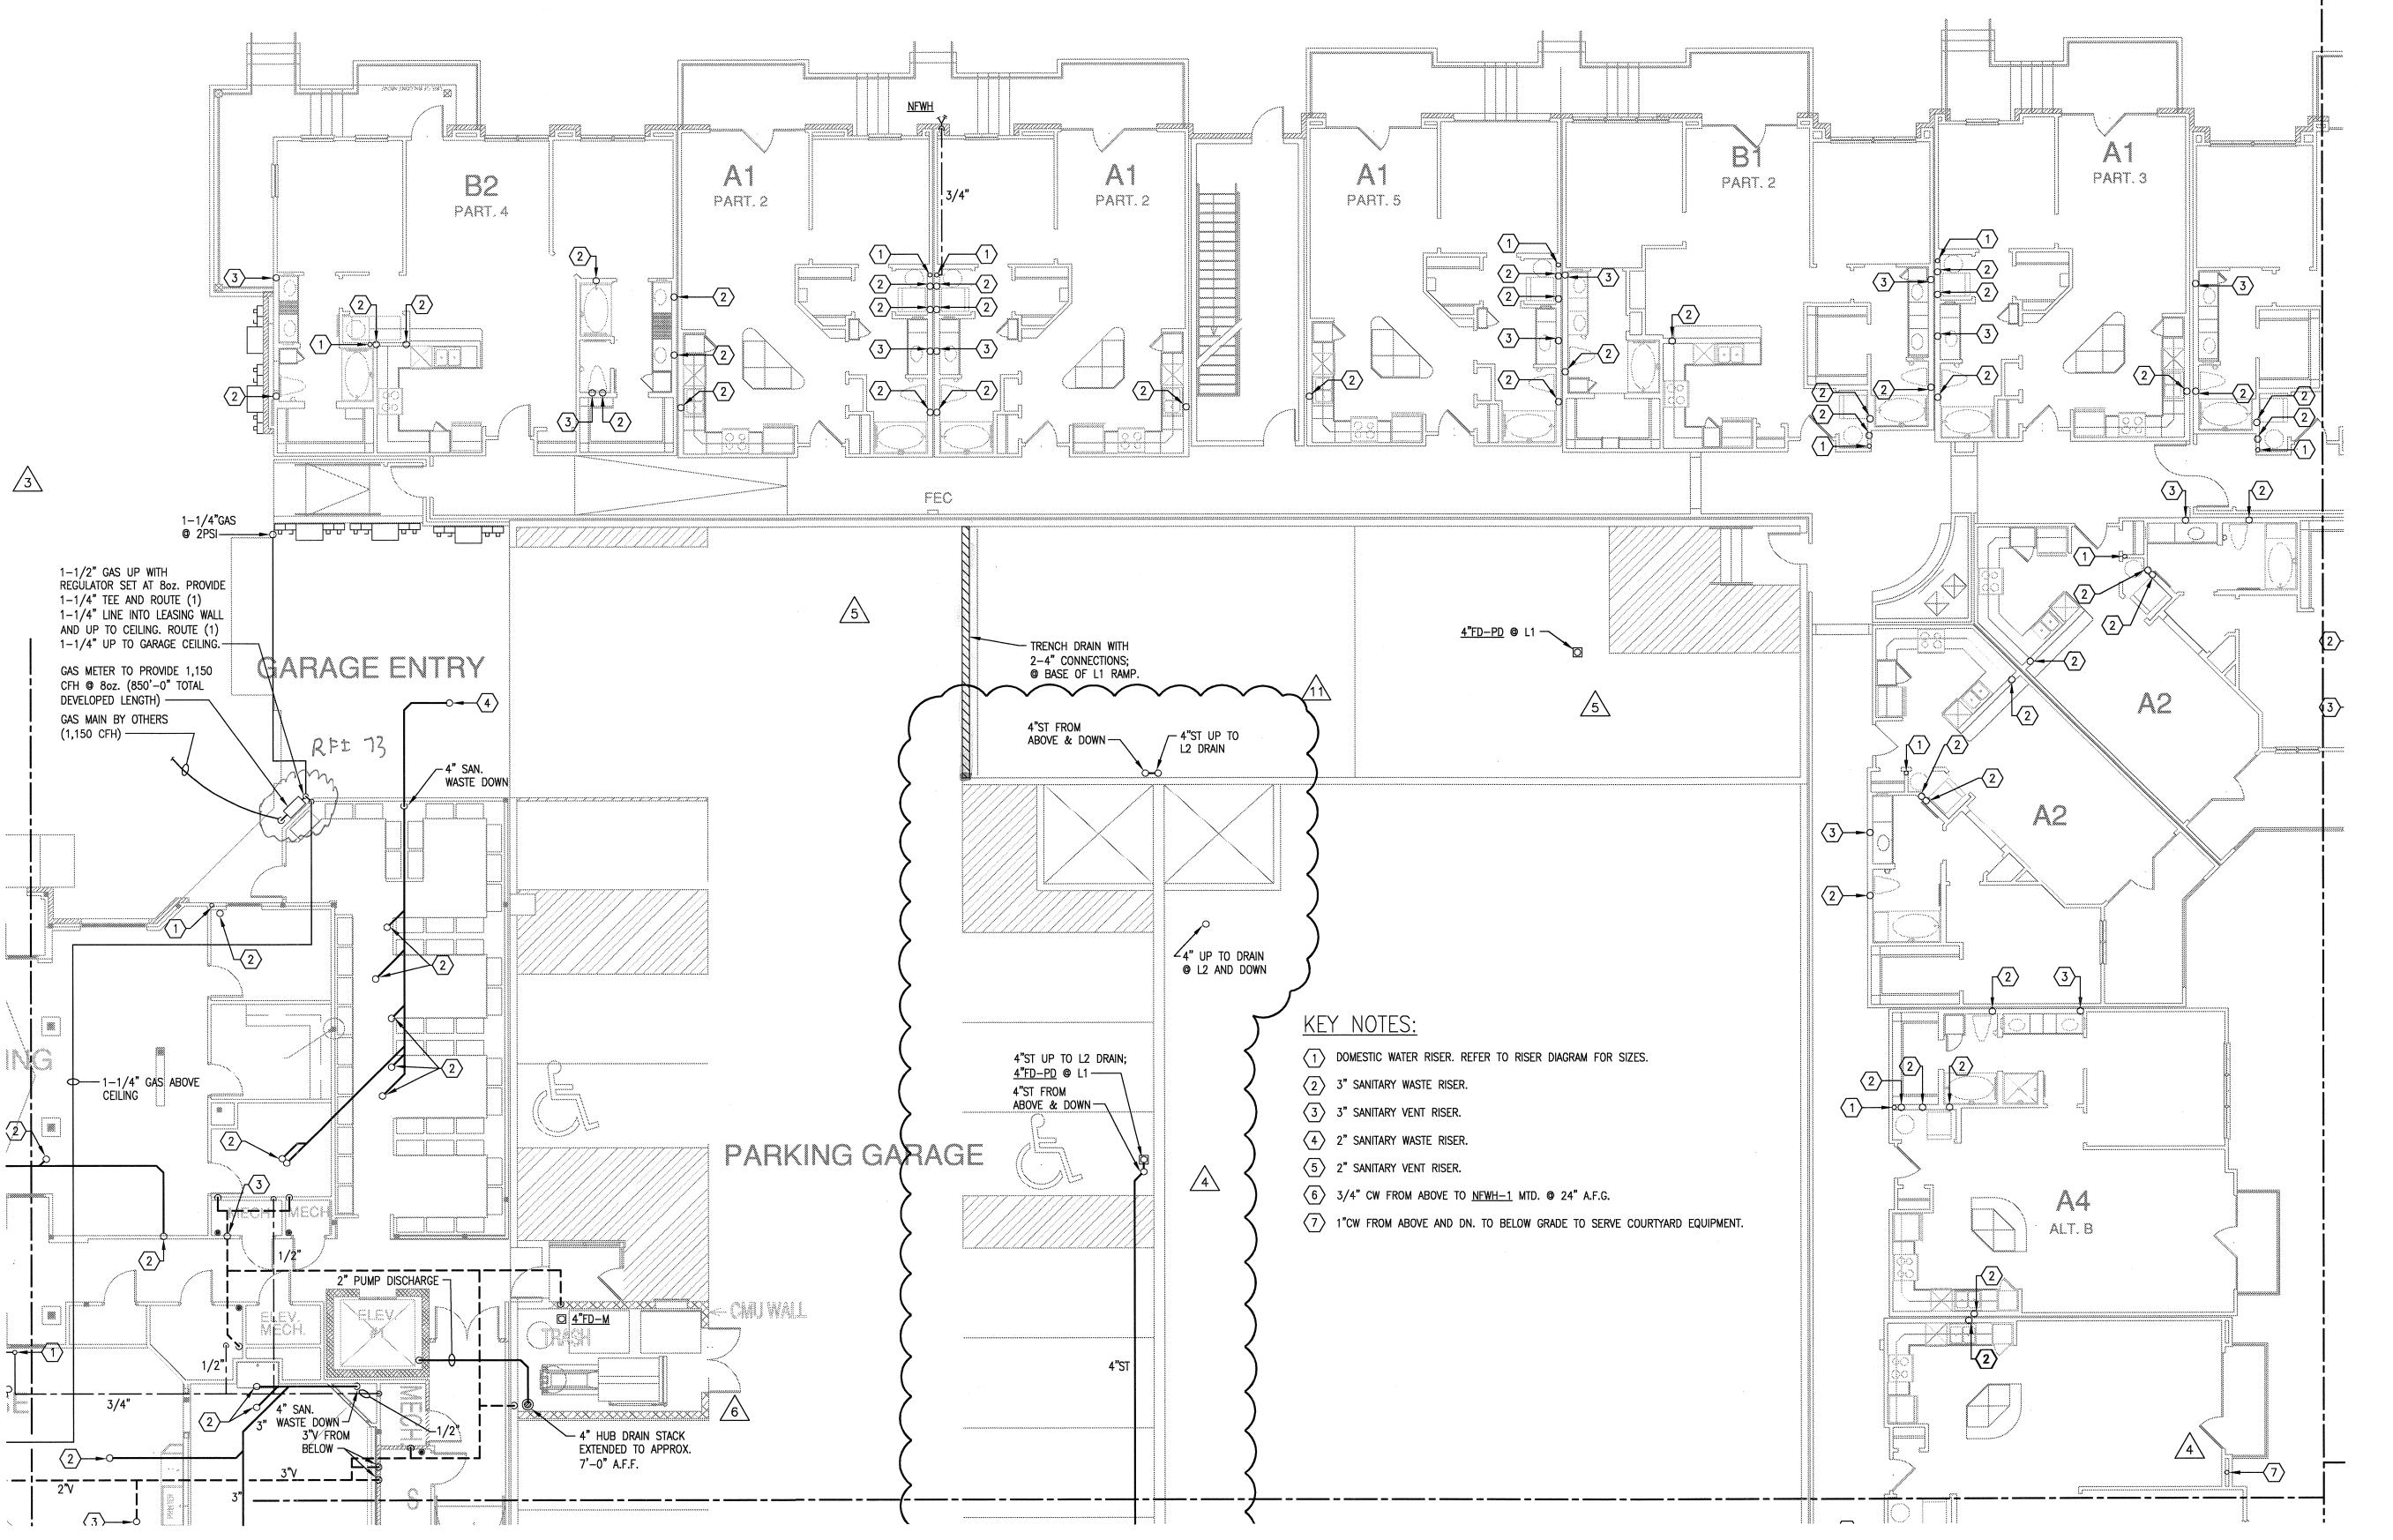

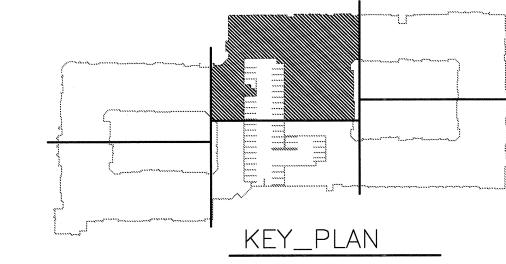



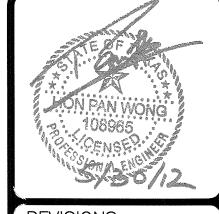

9-2-2011 DESIGN REVISIONS
2 9-13-2011 ANSI/FHA COMMENTS DESIGN REVISIONS
3 9-23-2011 CONSTRUCTION ISSUE
5 12-21-2011 DESIGN REVISIONS
6 1-17-2012 DESIGN REVISIONS
TRANSFORMER
2-15-2012 REVISIONS
8 3-27-2012 CLUBHOUSE REVISIONS
4-17-2012 COORDINATION

ル LOT V LOT LU

5-15-2012 COORDINATION 5-30-2012 SITE COORDINATION

LIBGO architects

4144 N. Central Expy.
Suite 855
Dallas, TX 75204
214.520.8878
bgoarchitects.com


DATE 08-05-1

08-05-11

PROJECT 11129

SHEET NUMBER

P-3.1C

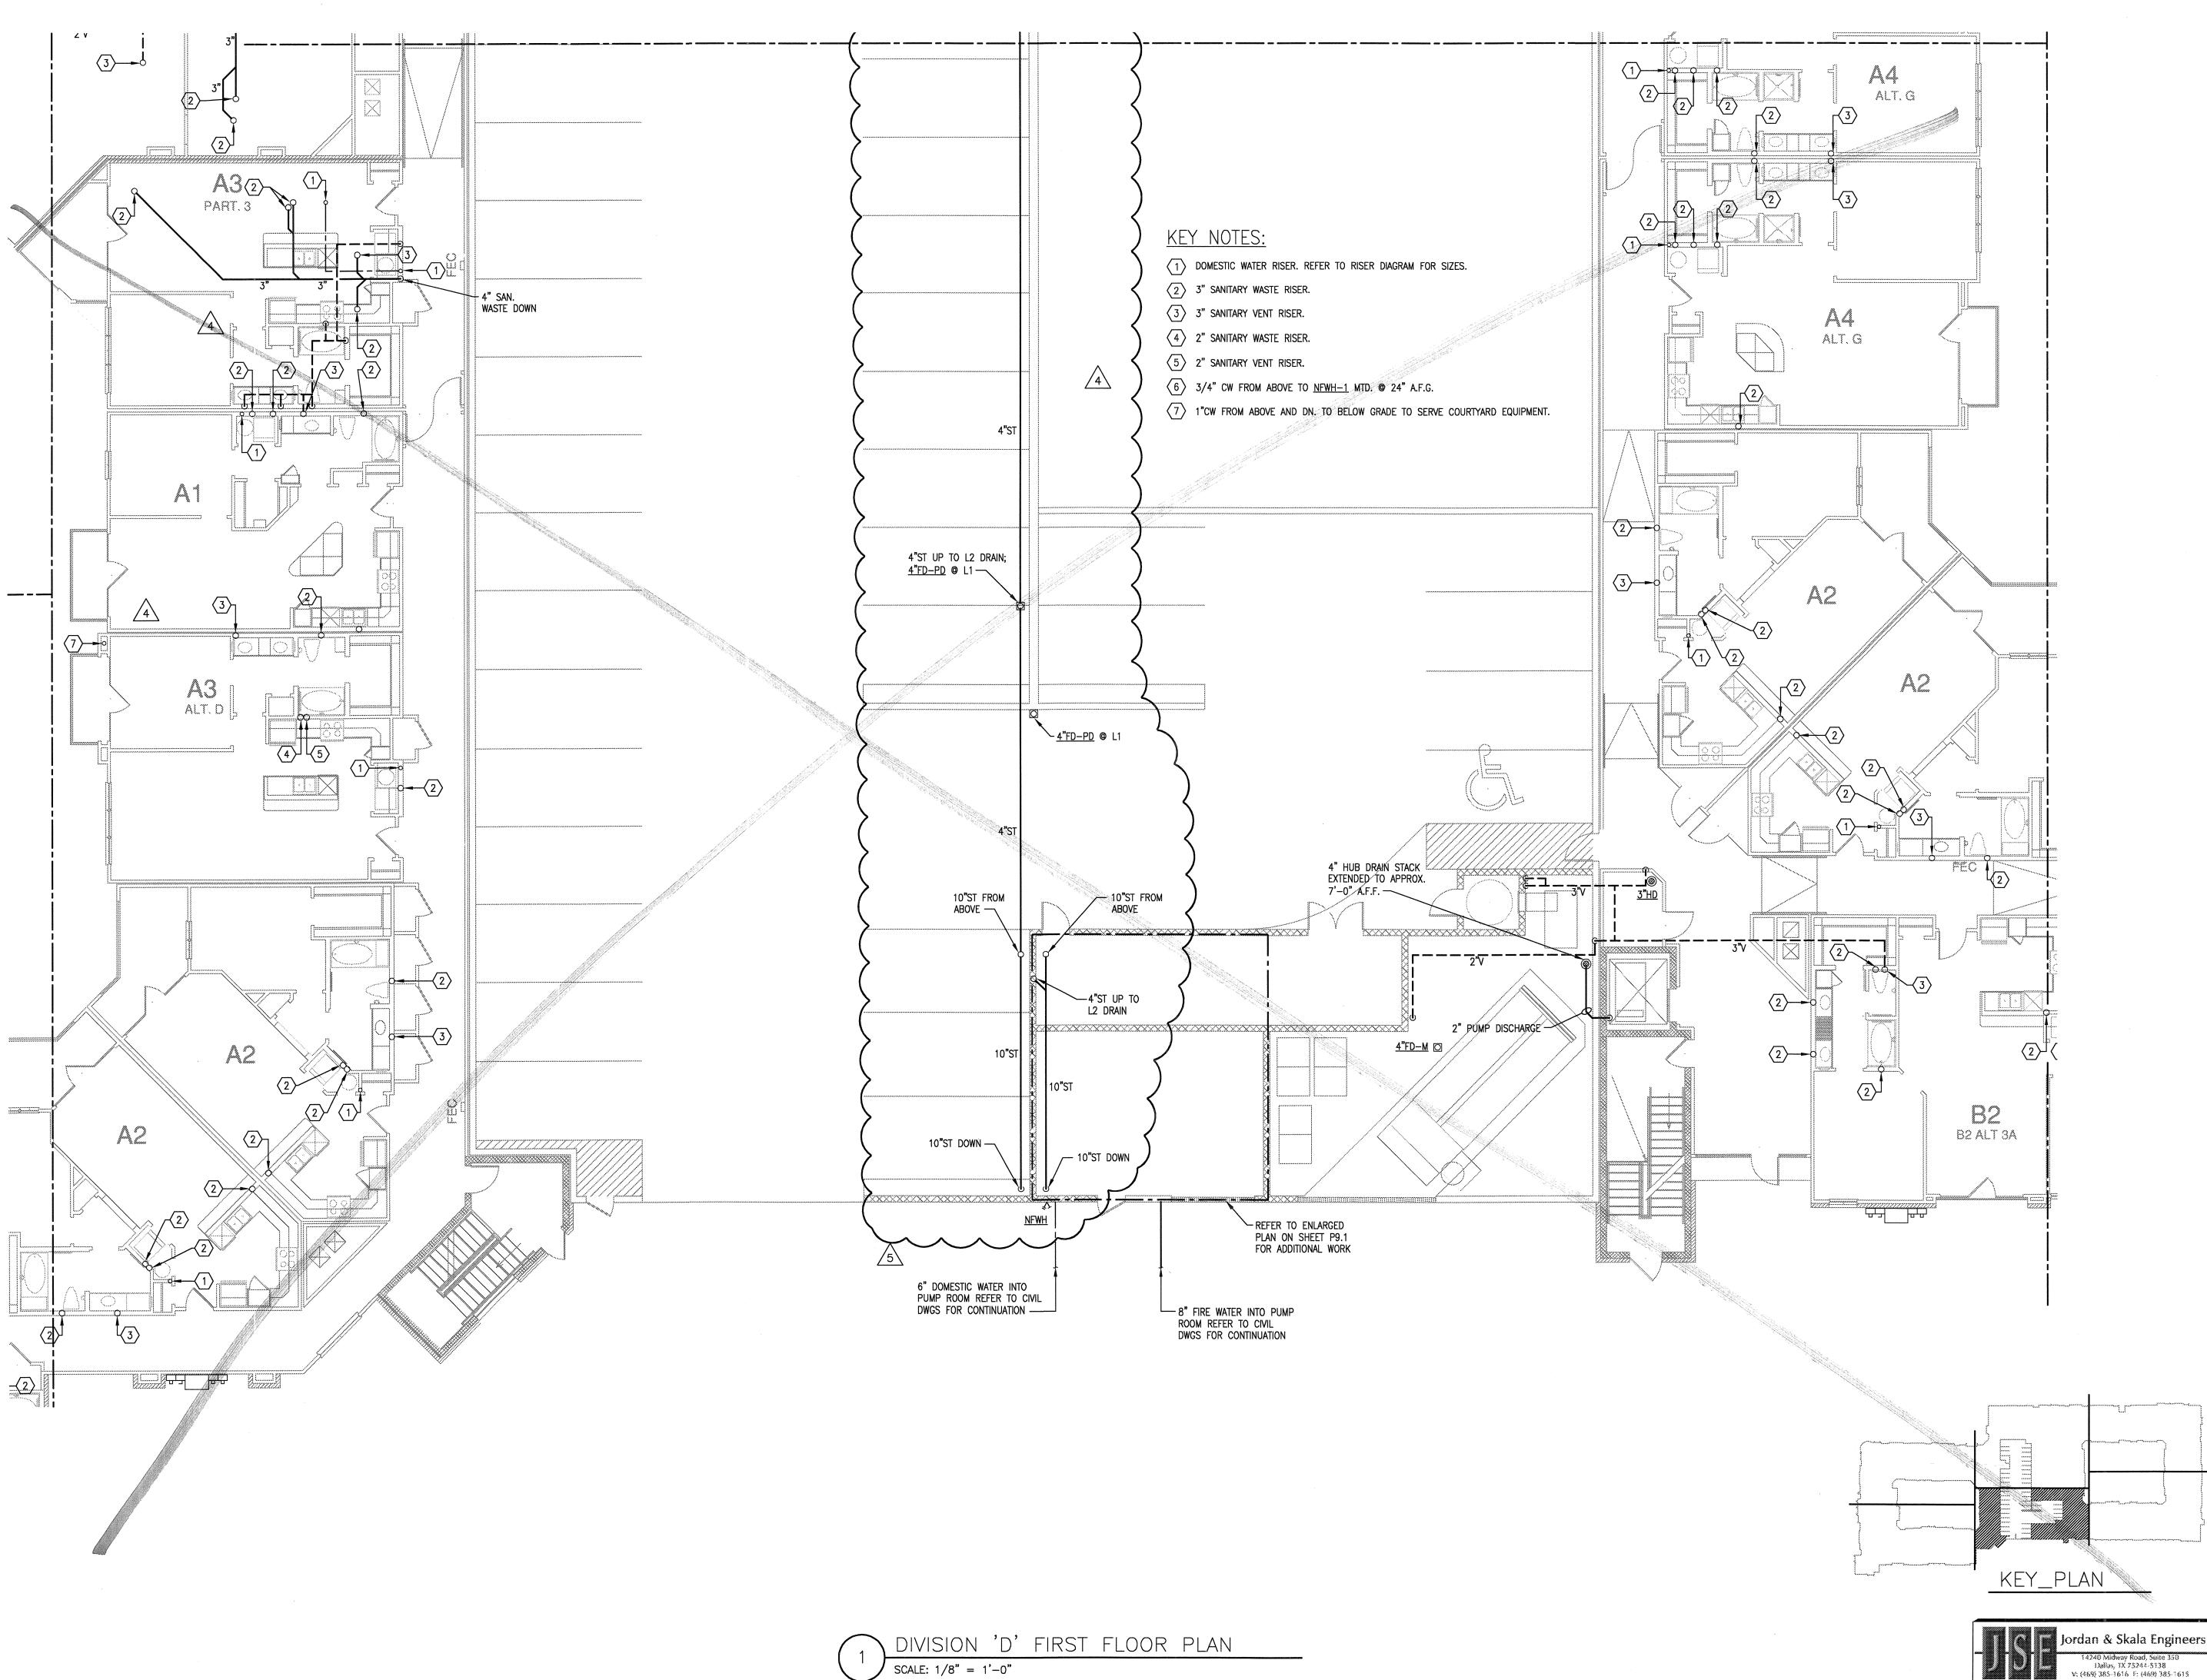



9-2-2011 DESIGN REVISIONS 9-13-2011 ANSI/FHA COMMENTS  $\sqrt{3}$  9-23-2011 DESIGN REVISIONS 10-17-2011 CONSTRUCTION ISSUE 5 12-21-2011 DESIGN REVISIONS

BBGO architects 4144 N. Central Expy. Suite 855 Dallas, TX 75204 214.520.8878 bgoarchitects.com

08-05-1

PROJECT

SHEET NUMBER


P-3.1D


Texas Firm Registration #F-4990


Checked By: RC


Drawn By: CV

SCALE: 1/8" = 1'-0"

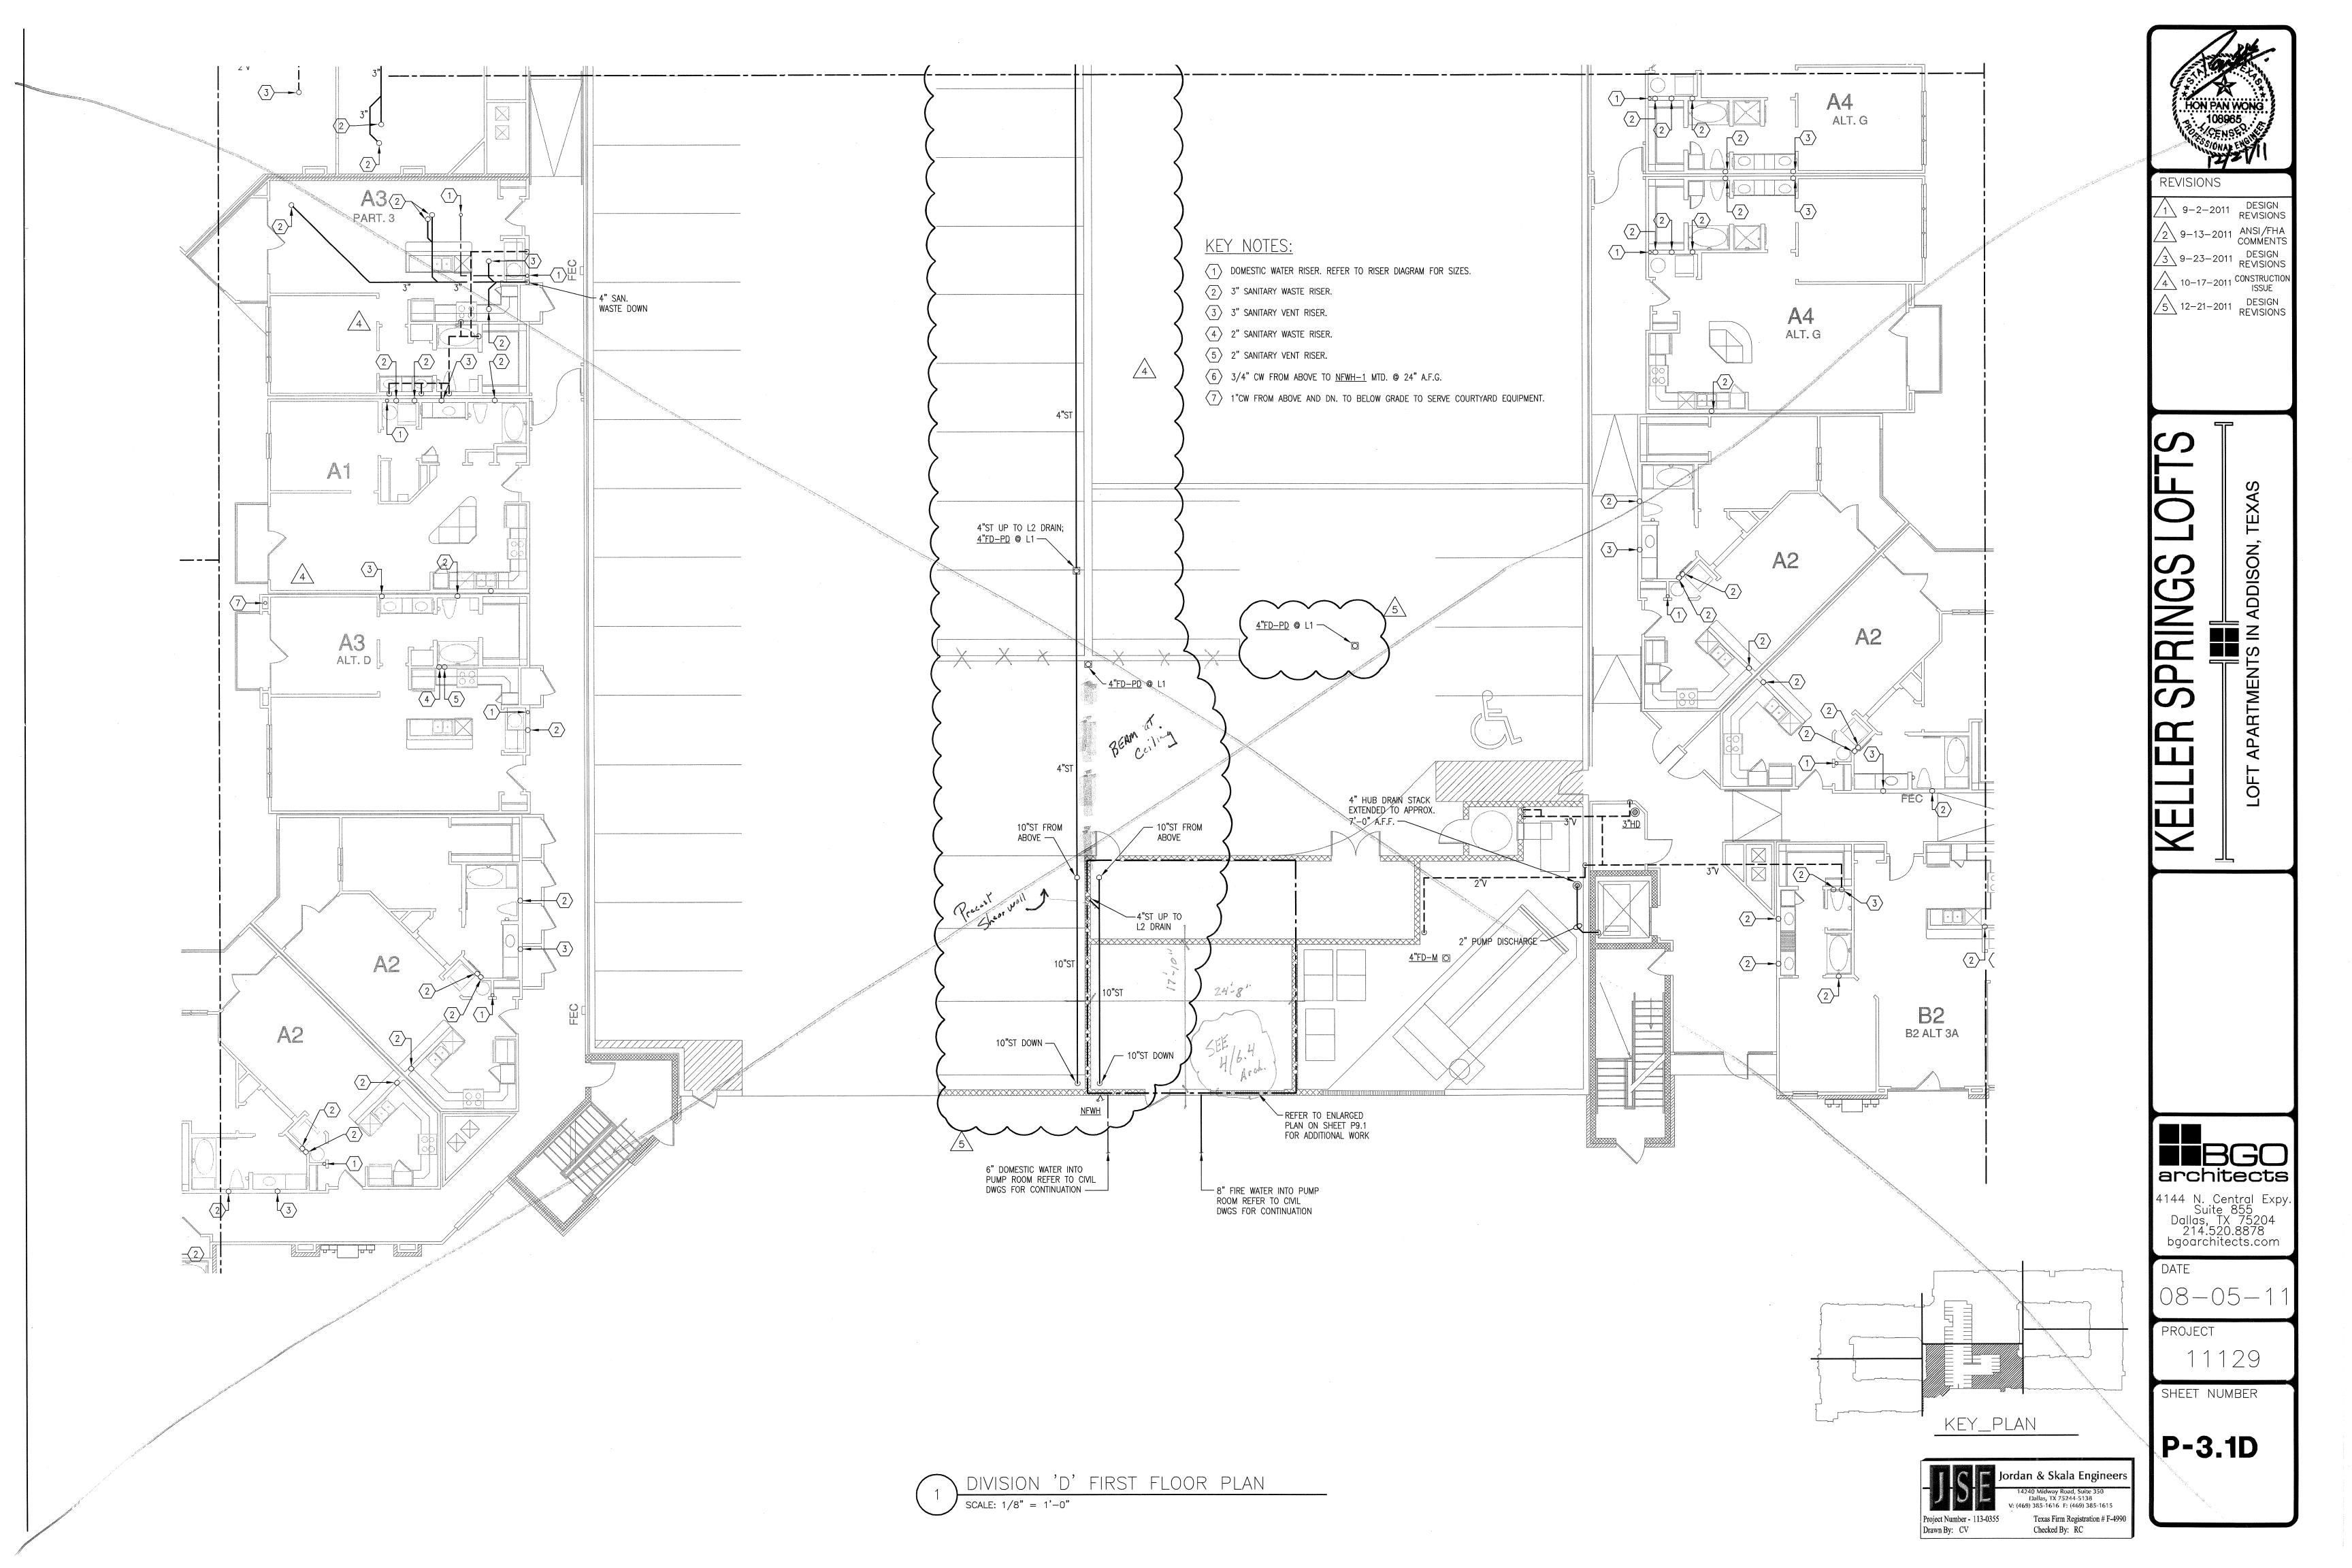

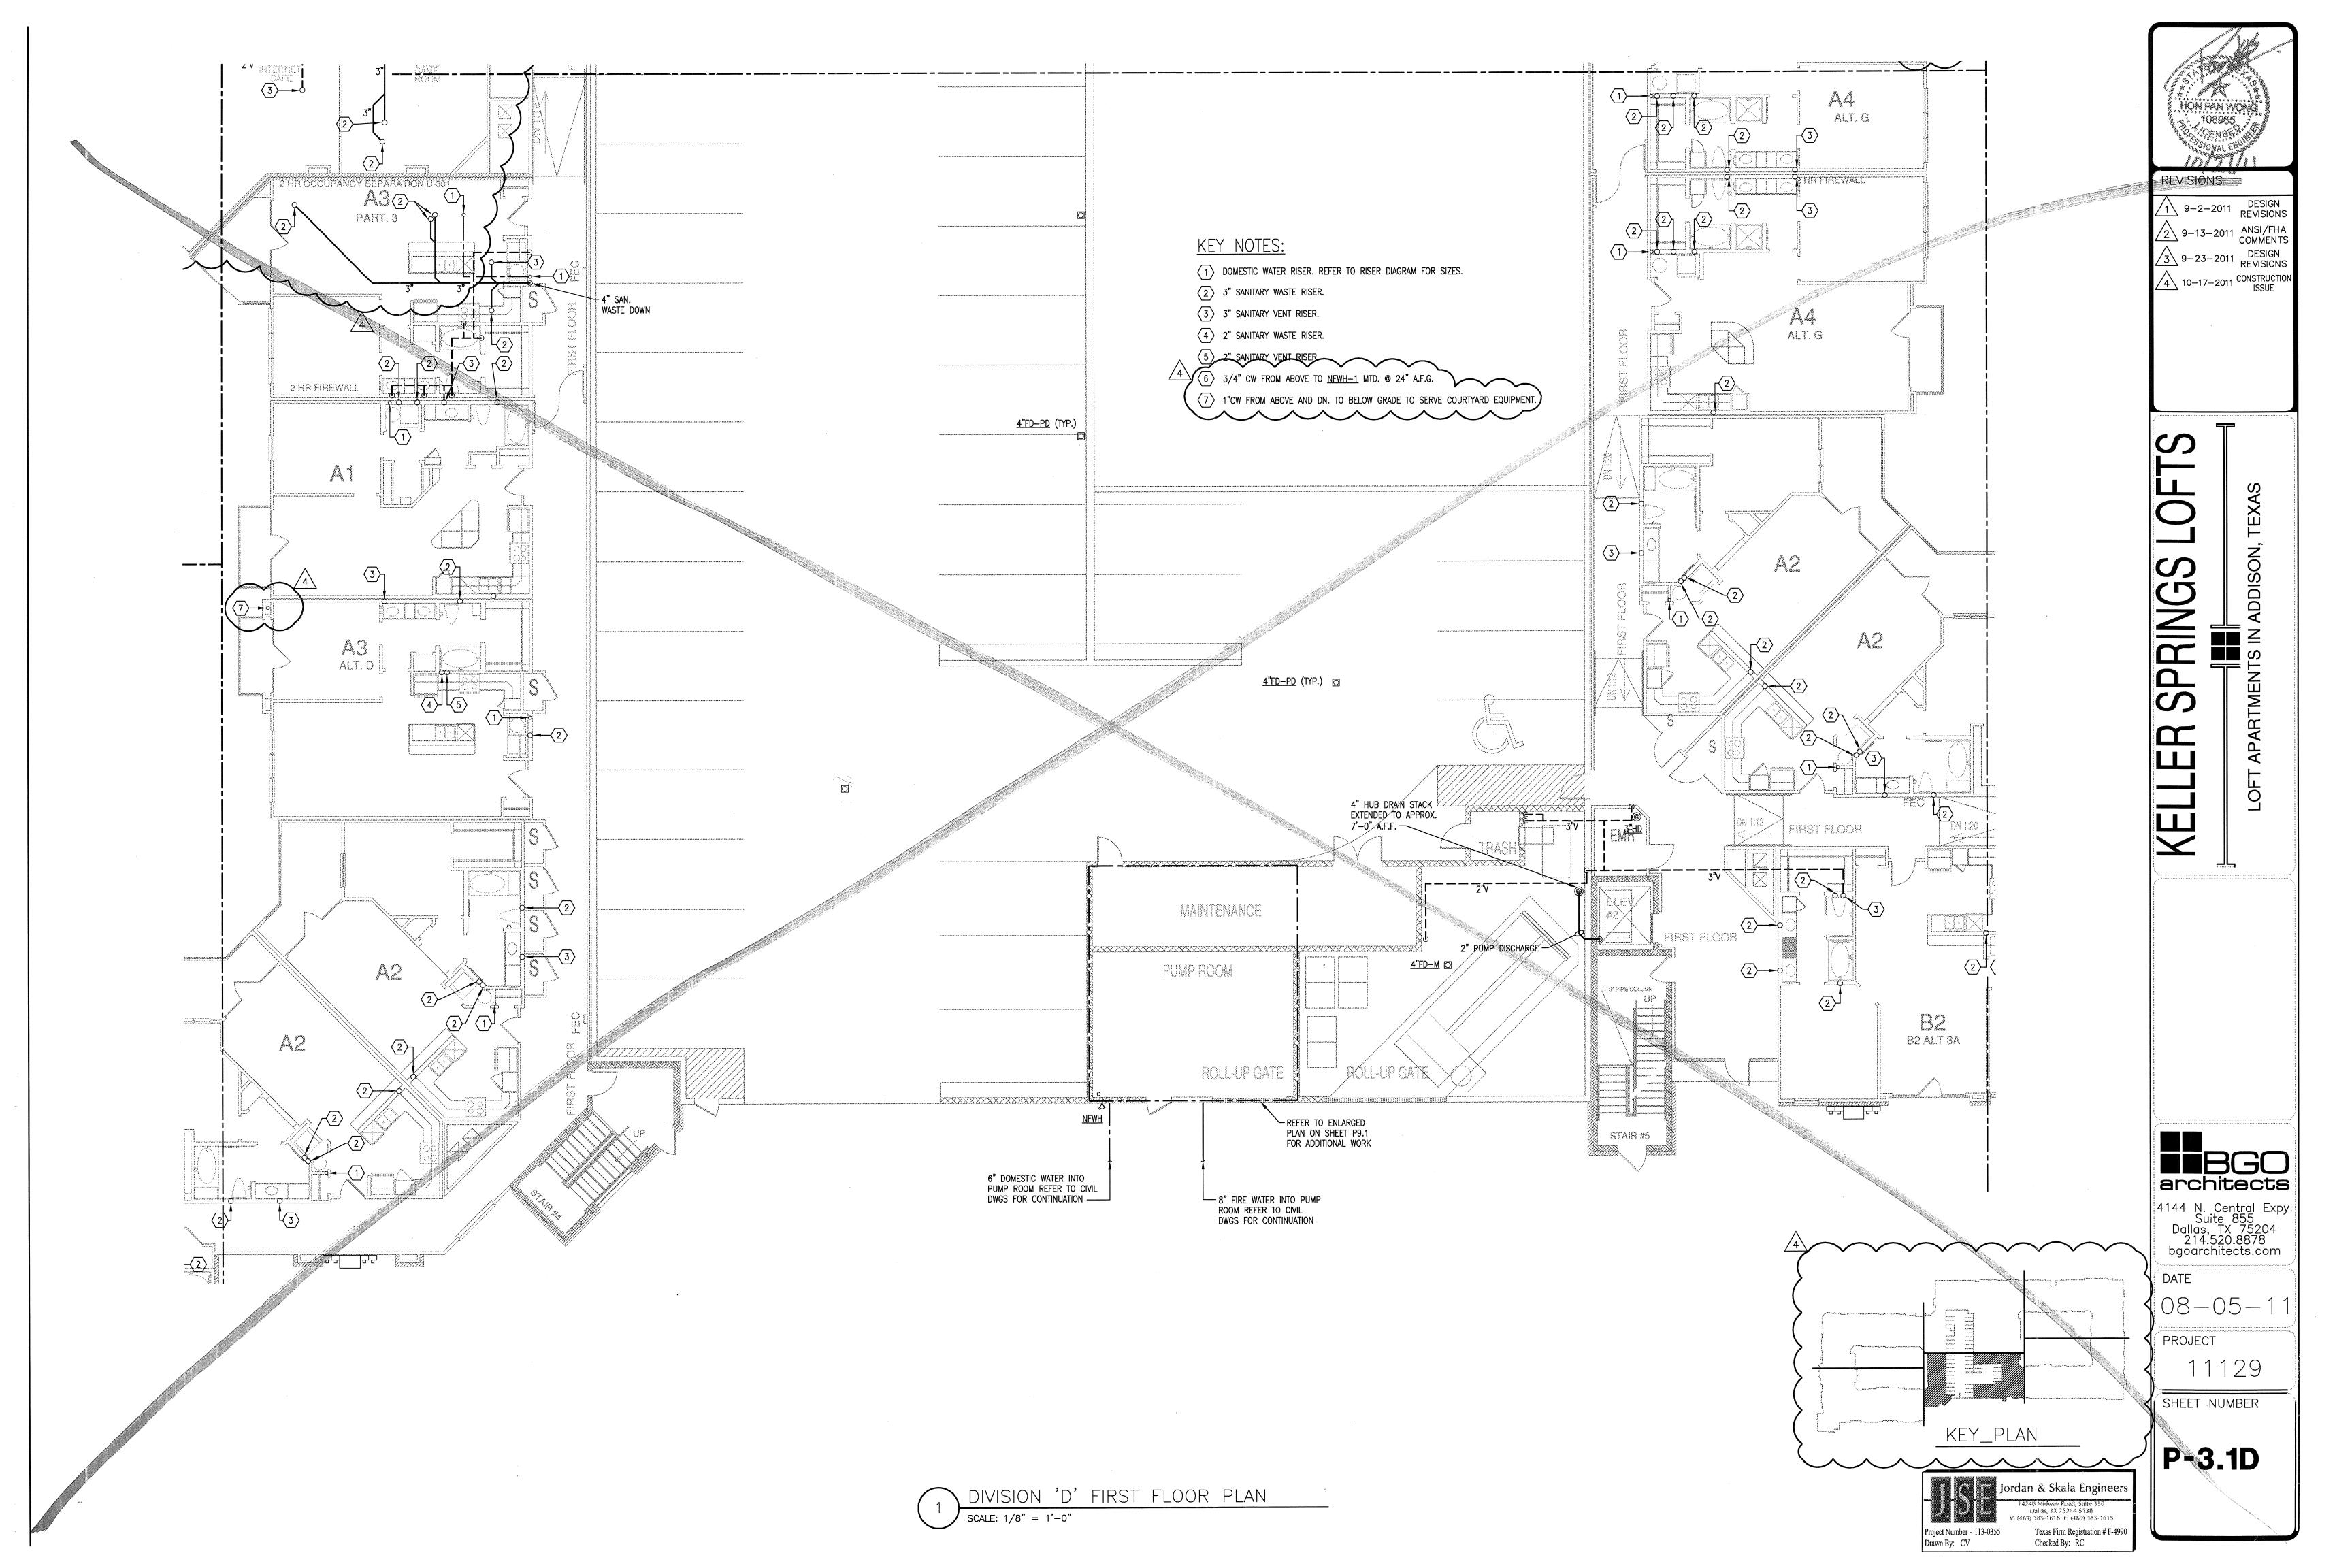

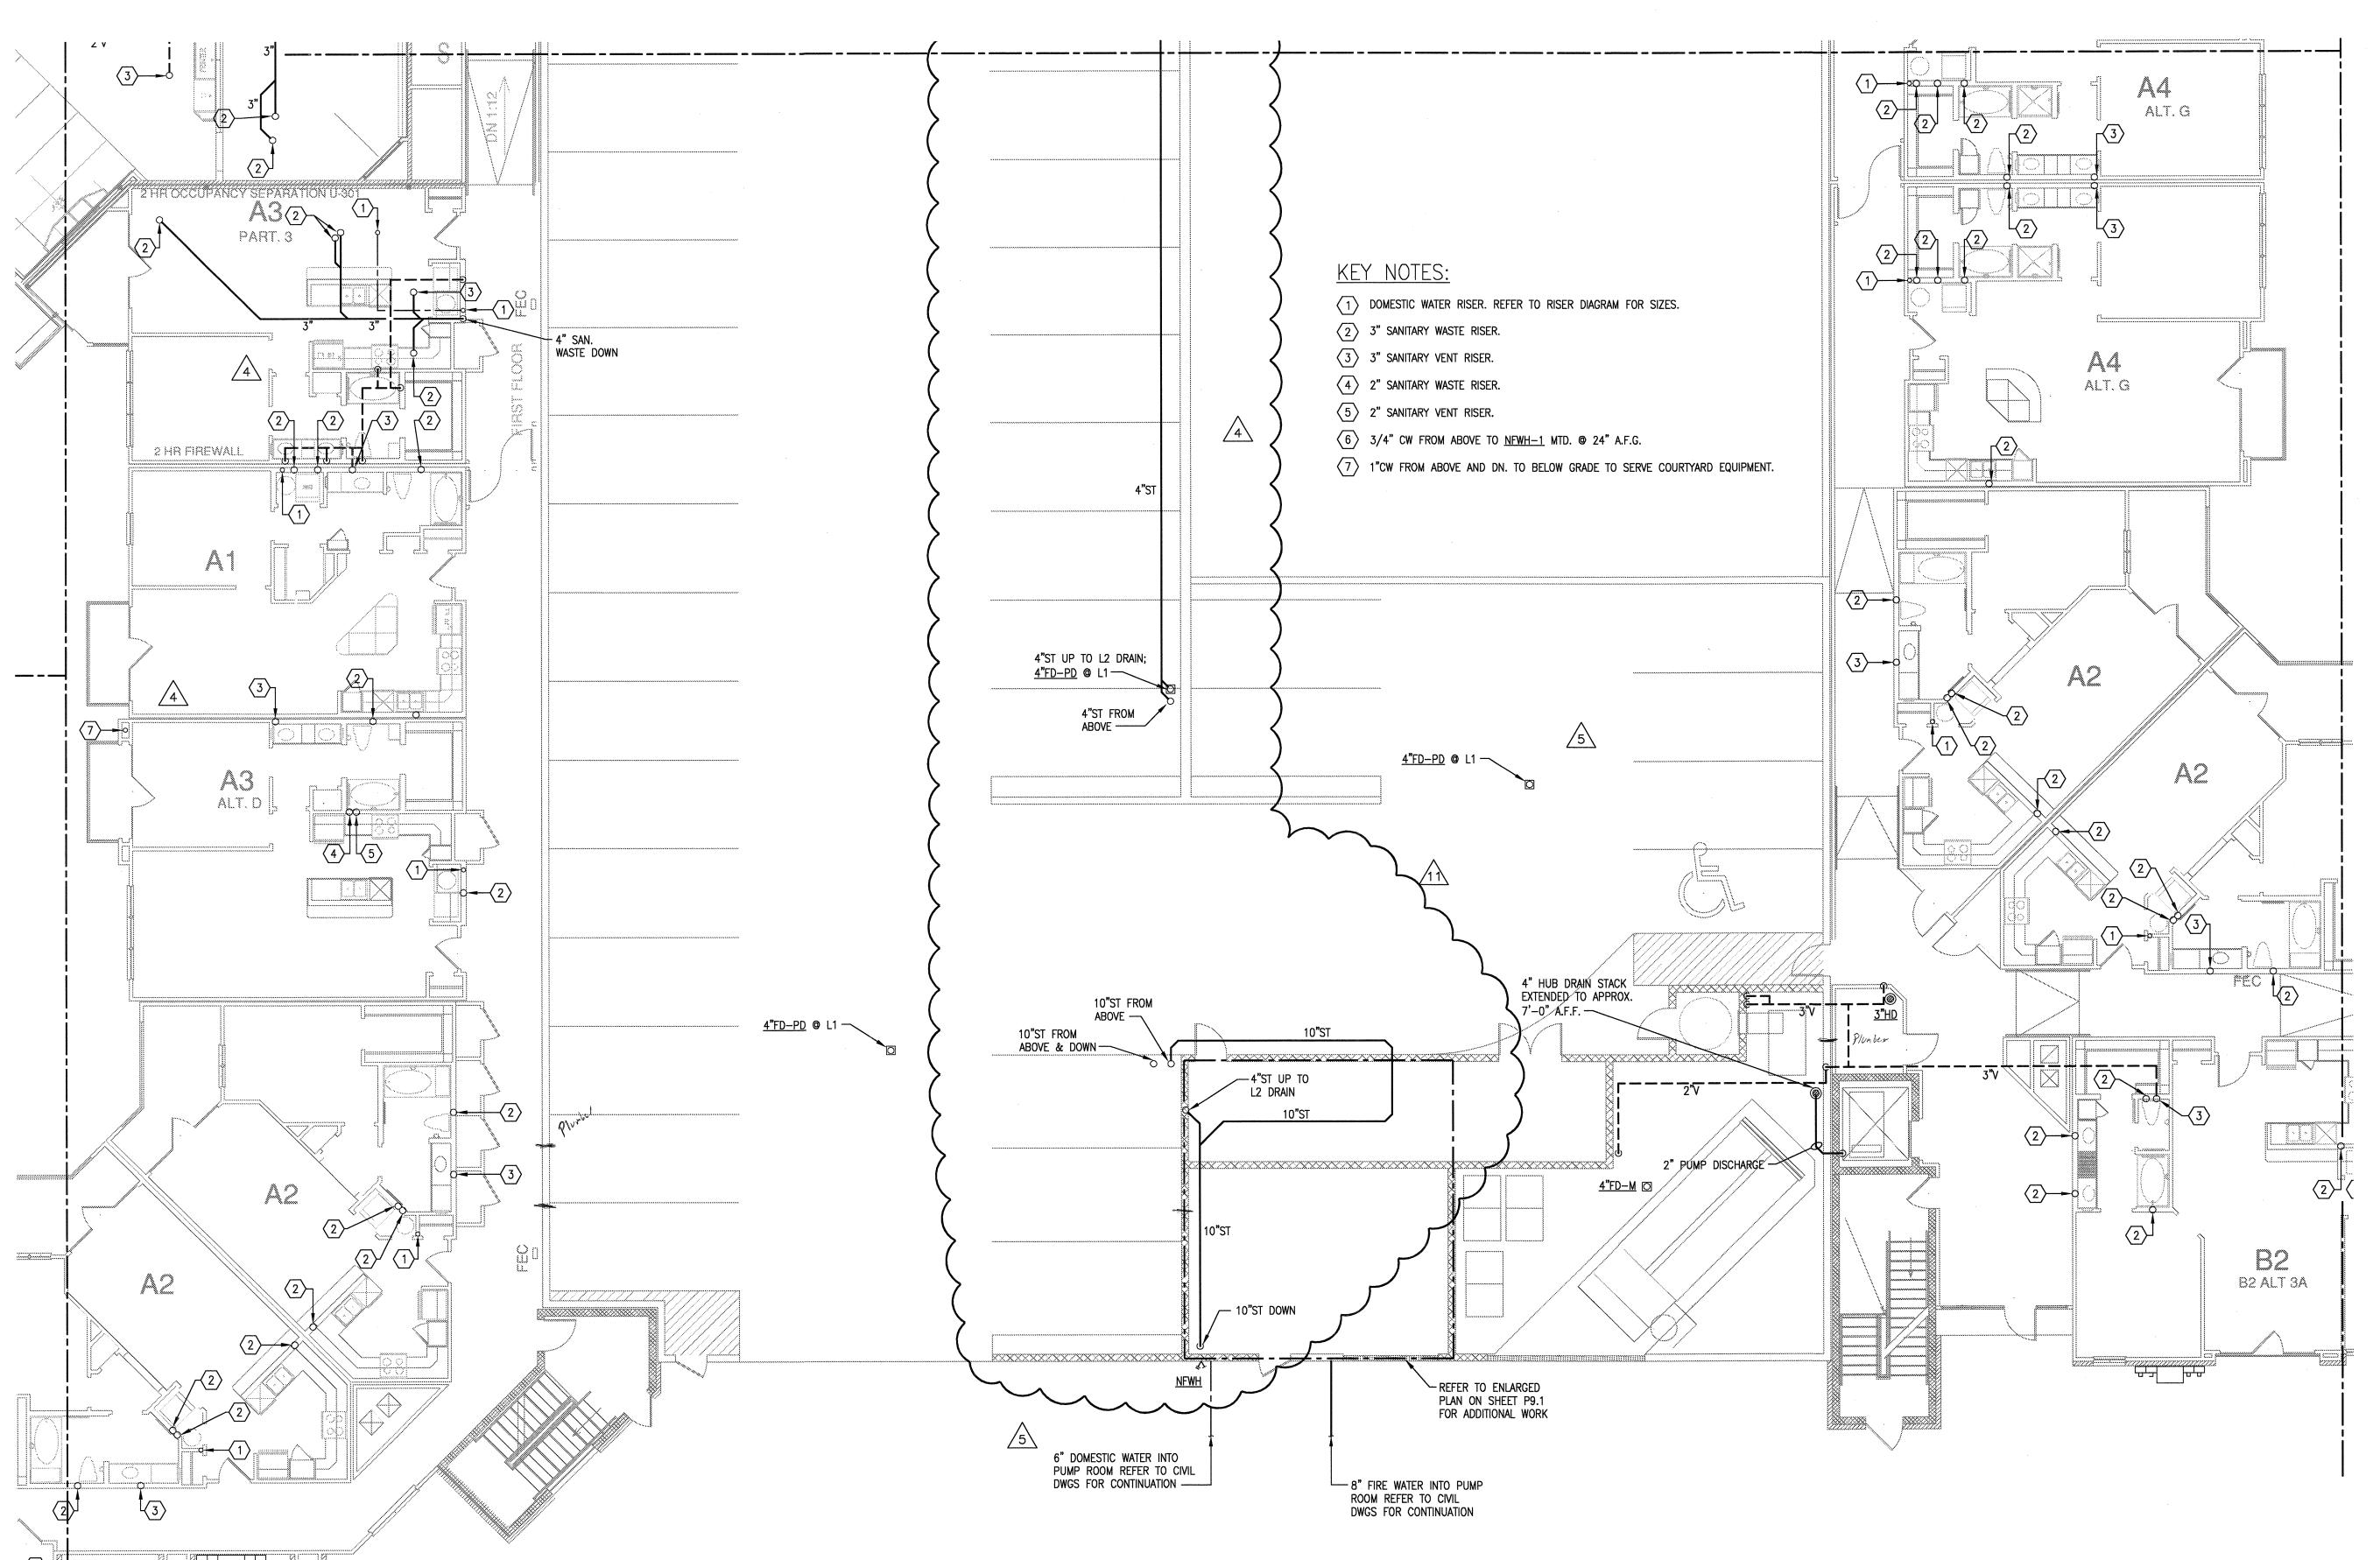

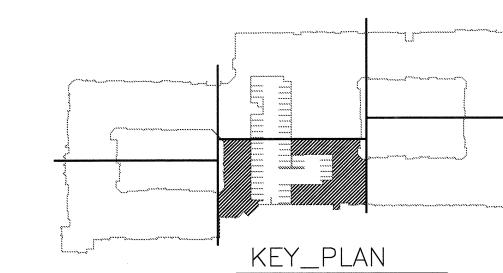





1 9-2-2011 DESIGN REVISIONS
2 9-13-2011 ANSI/FHA COMMENTS DESIGN REVISIONS
3 9-23-2011 CONSTRUCTION ISSUE
5 12-21-2011 DESIGN REVISIONS
6 1-17-2012 DESIGN REVISIONS
7 2-15-2012 REVISIONS
8 3-27-2012 CLUBHOUSE REVISIONS
9 4-17-2012 COORDINATION

5-15-2012 COORDINATION 5-30-2012 SITE COORDINATION

architects


4144 N. Central Expy.
Suite 855
Dallas, TX 75204
214.520.8878
bgoarchitects.com


DATE 08-05-1


PROJECT 1 1 1 2 9


SHEET NUMBER

P-3.1D

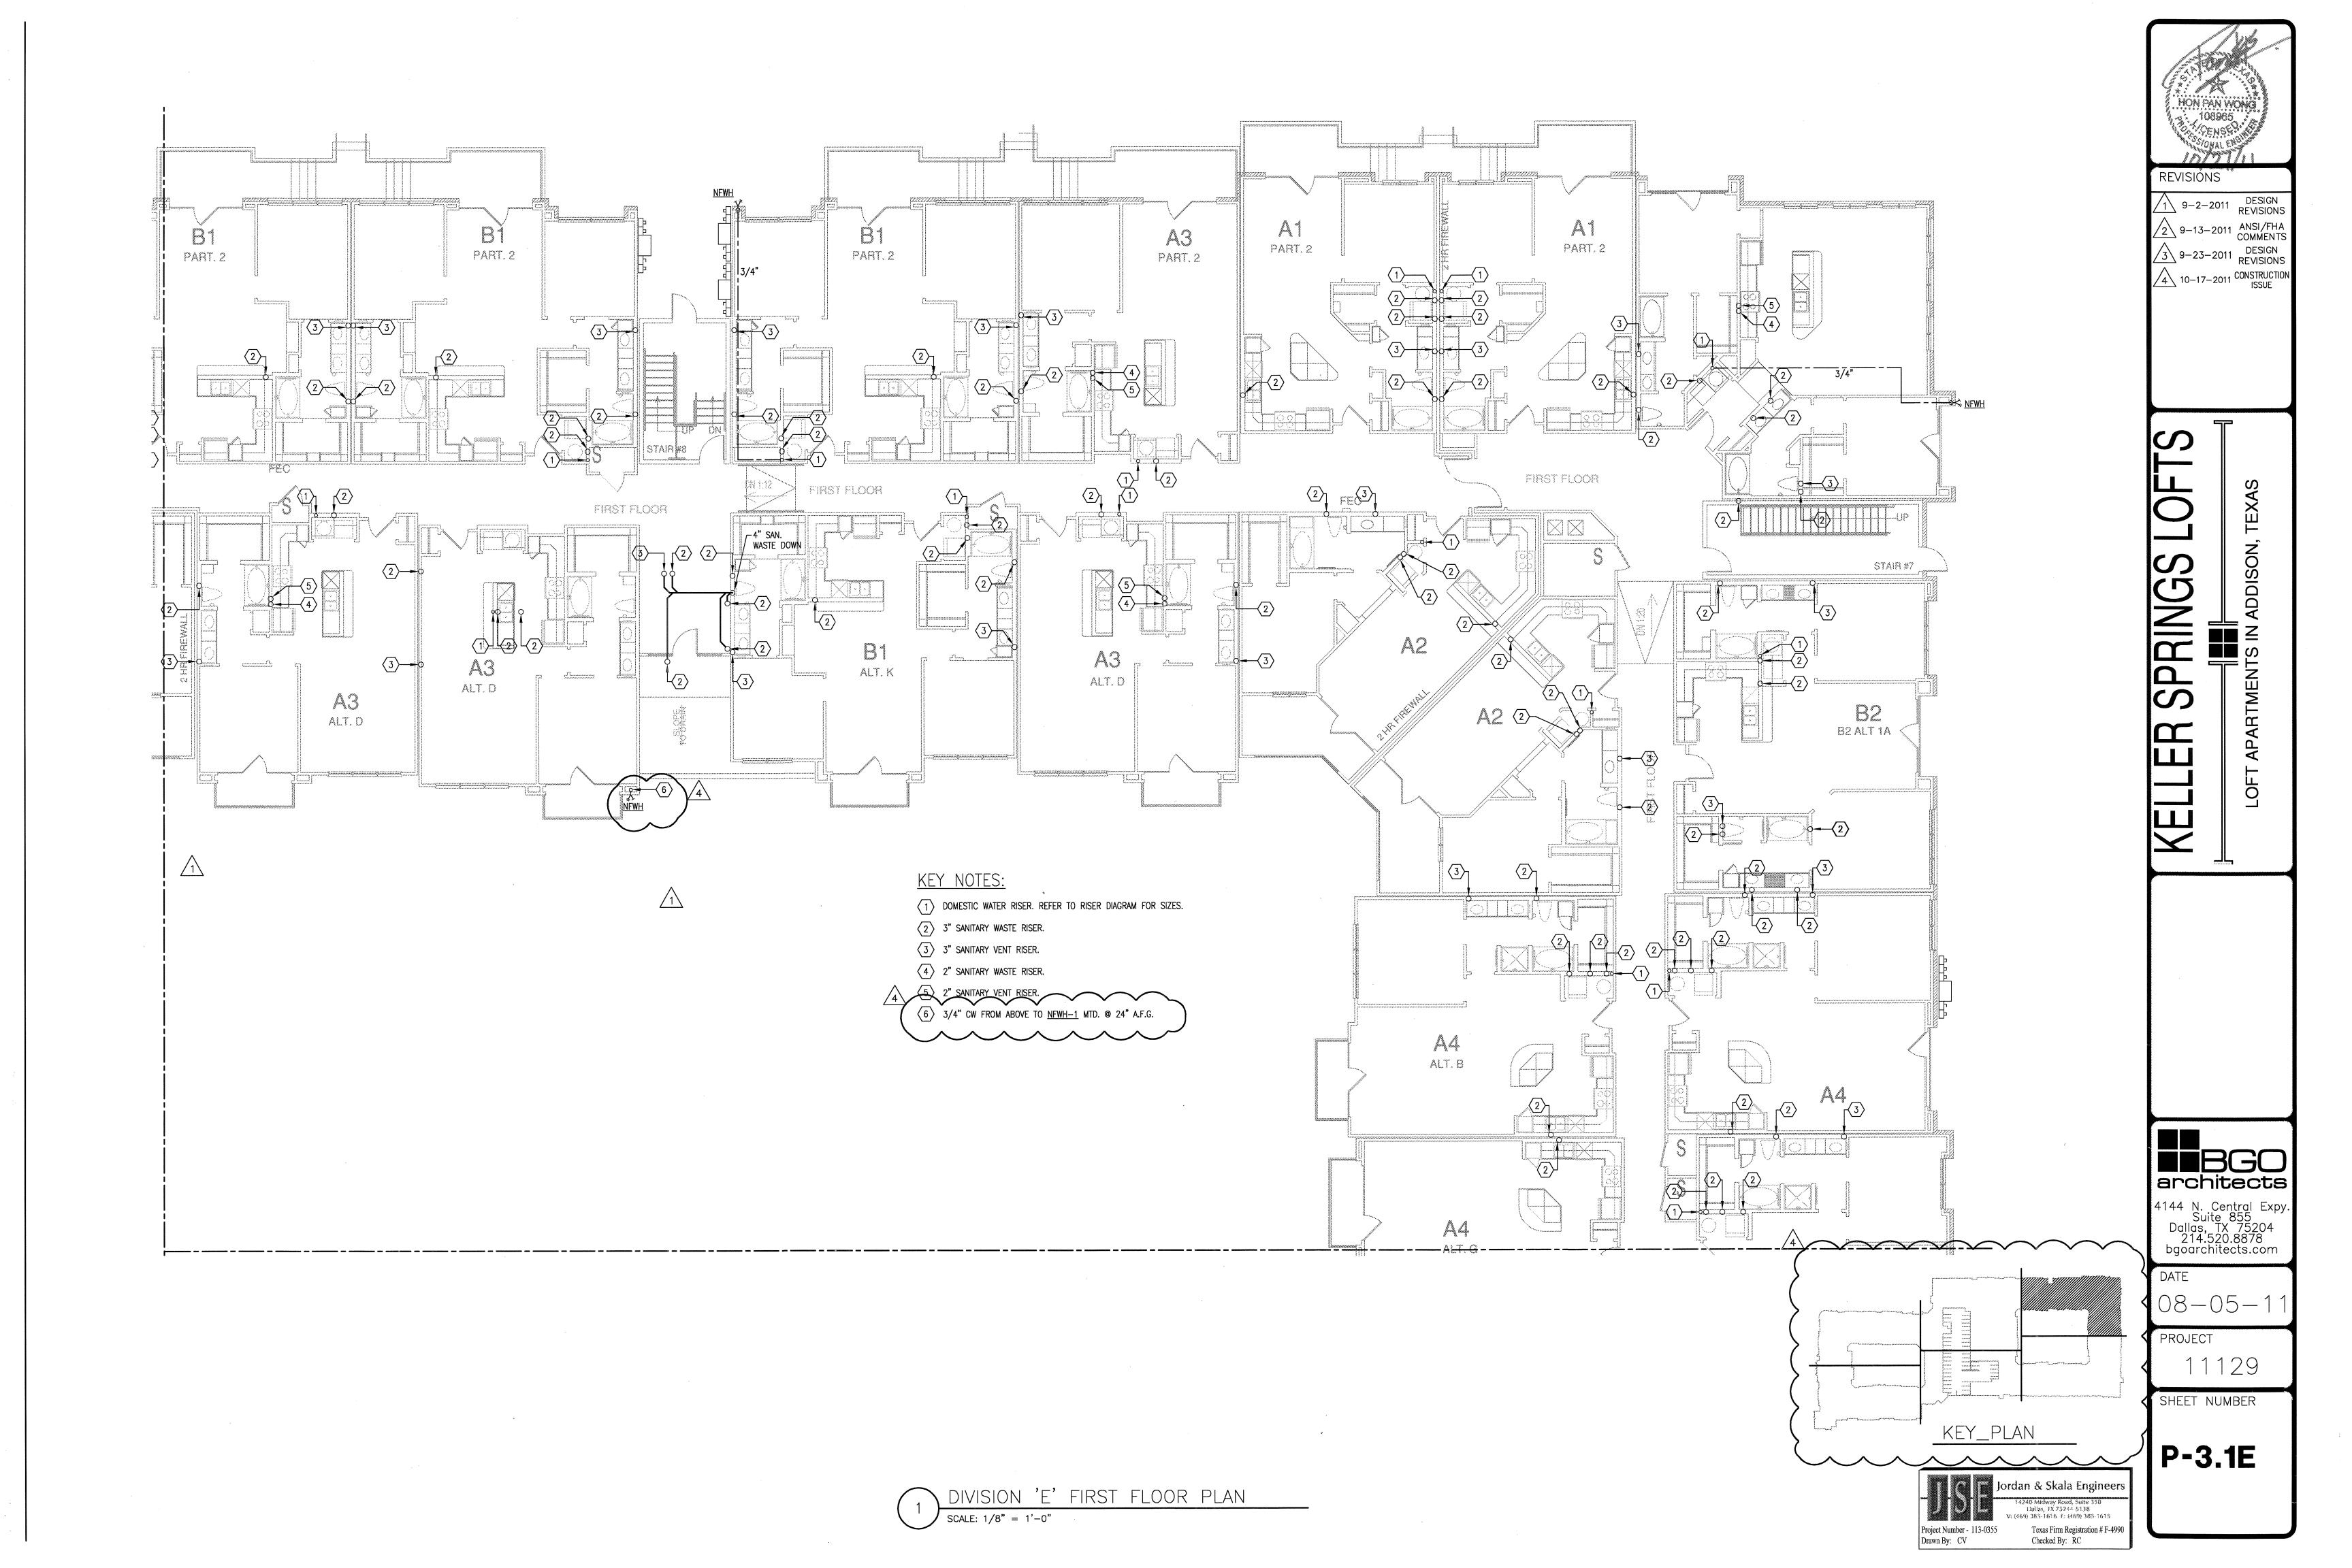

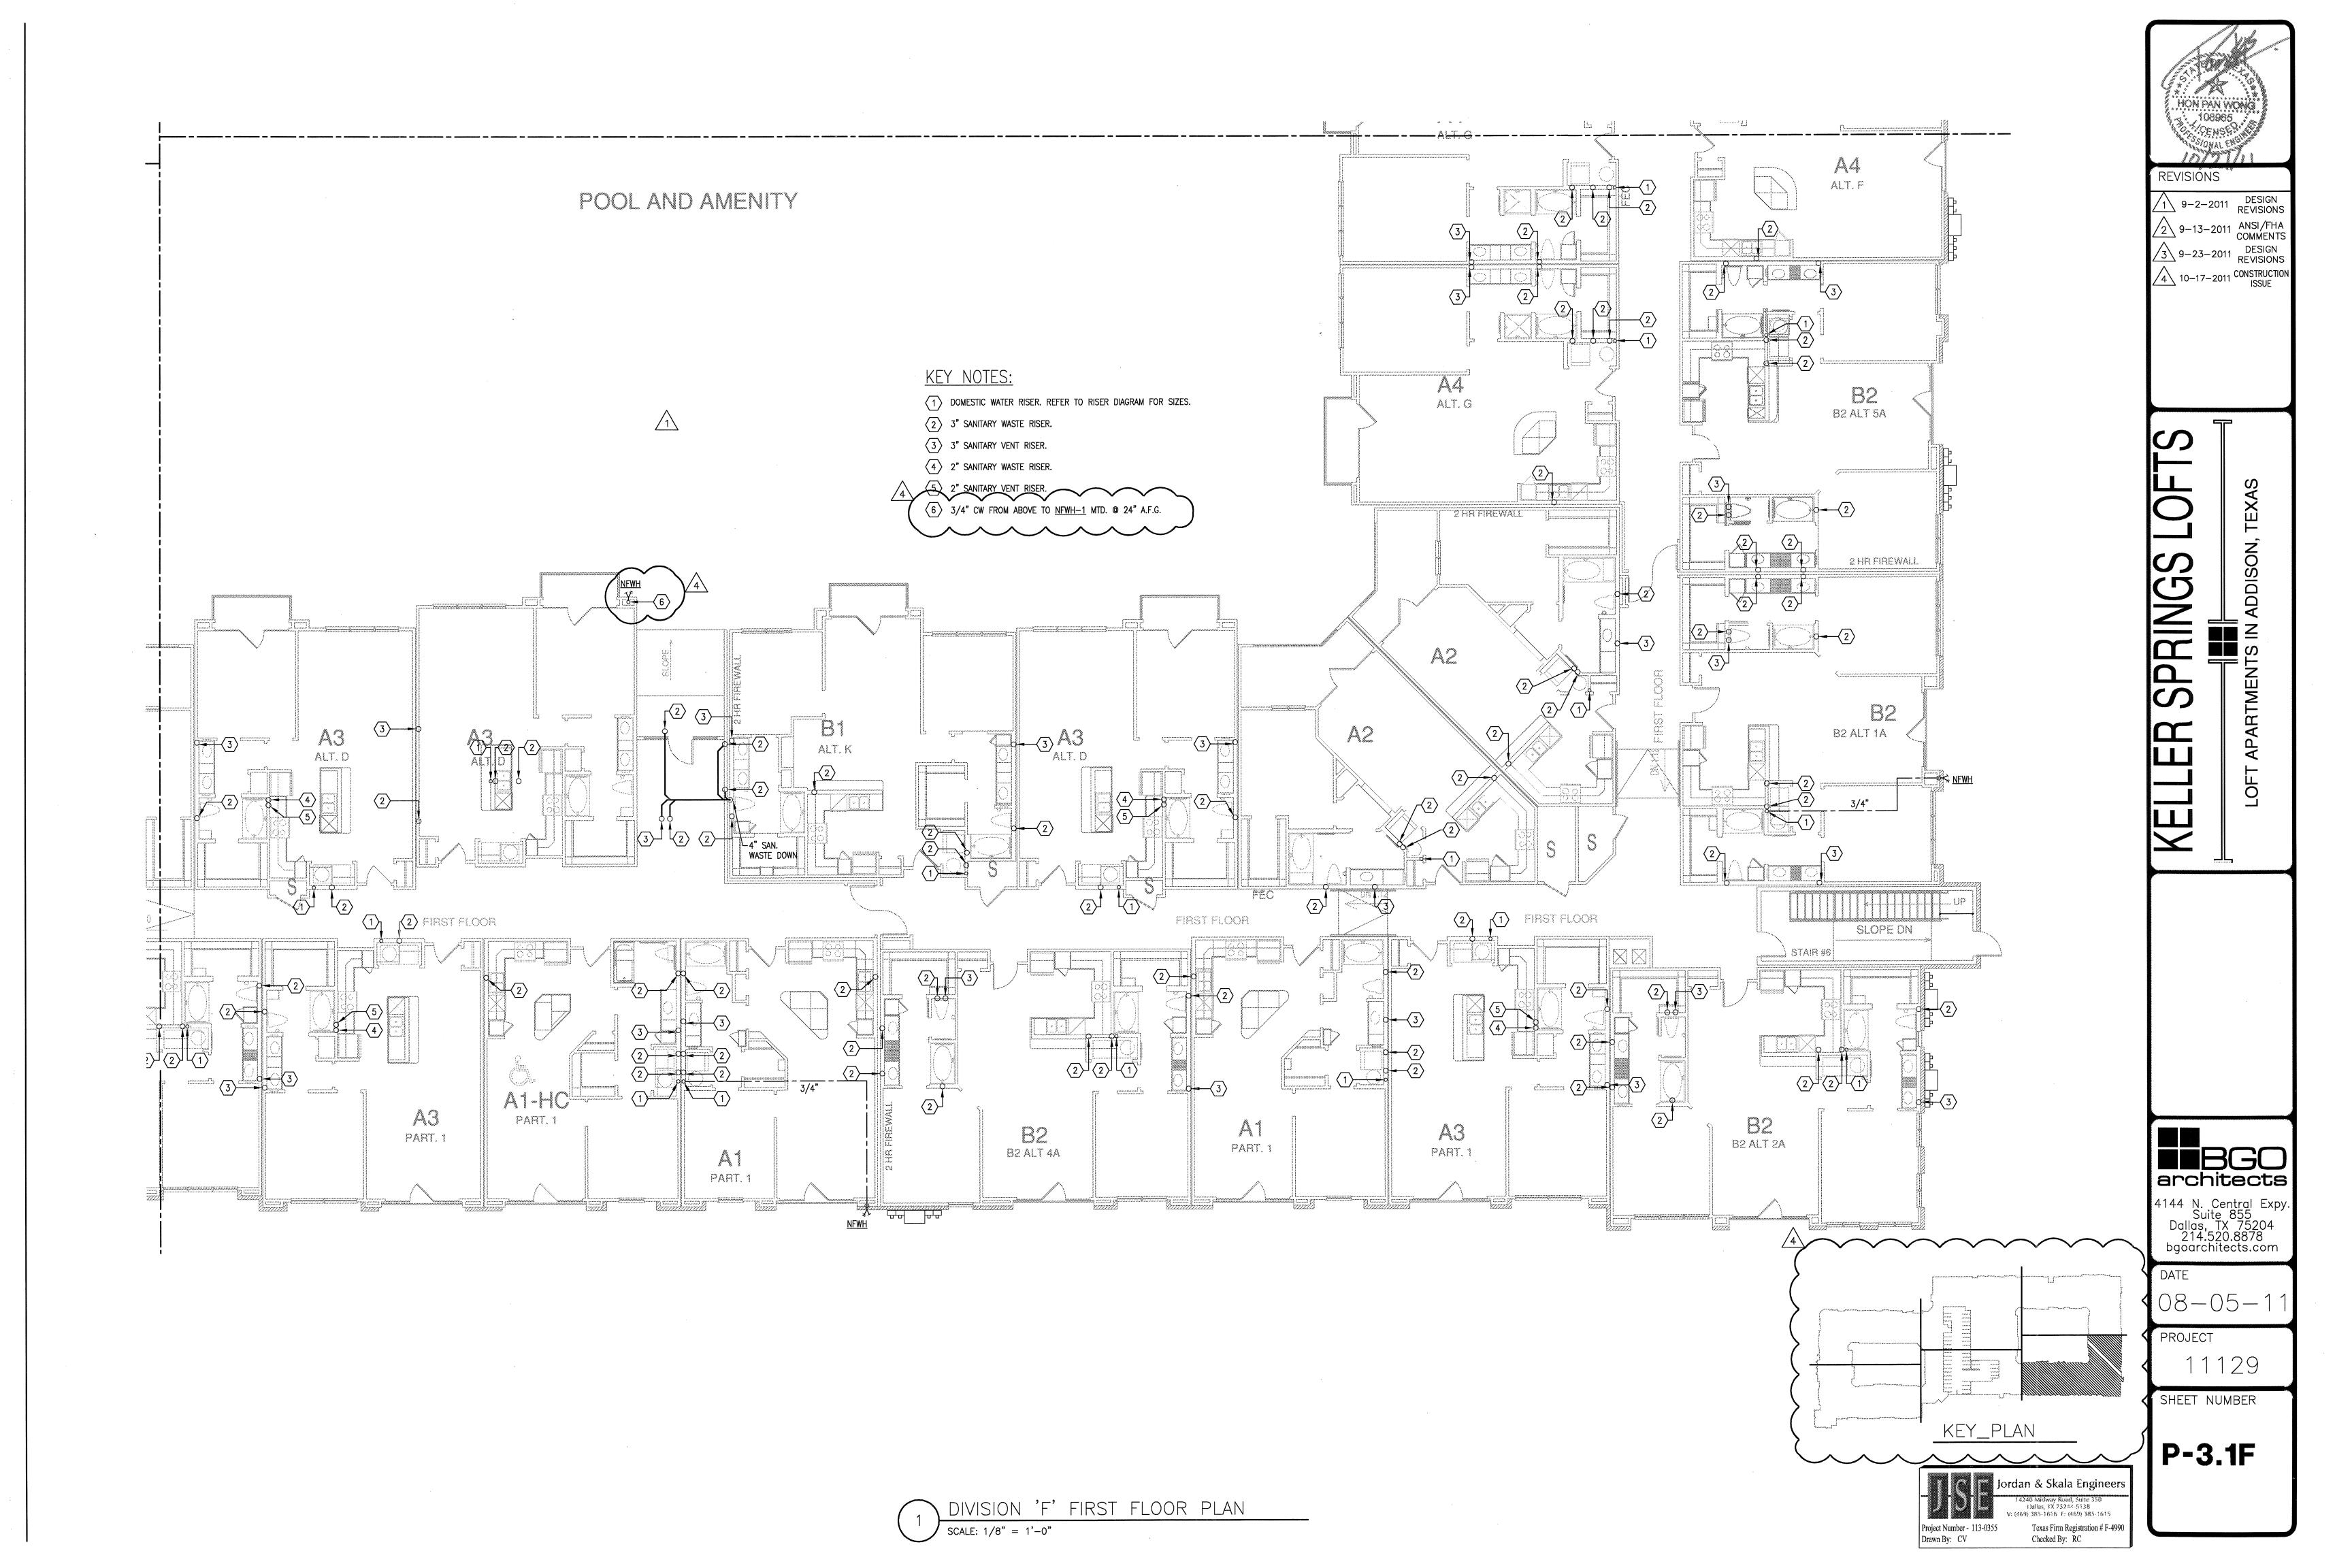

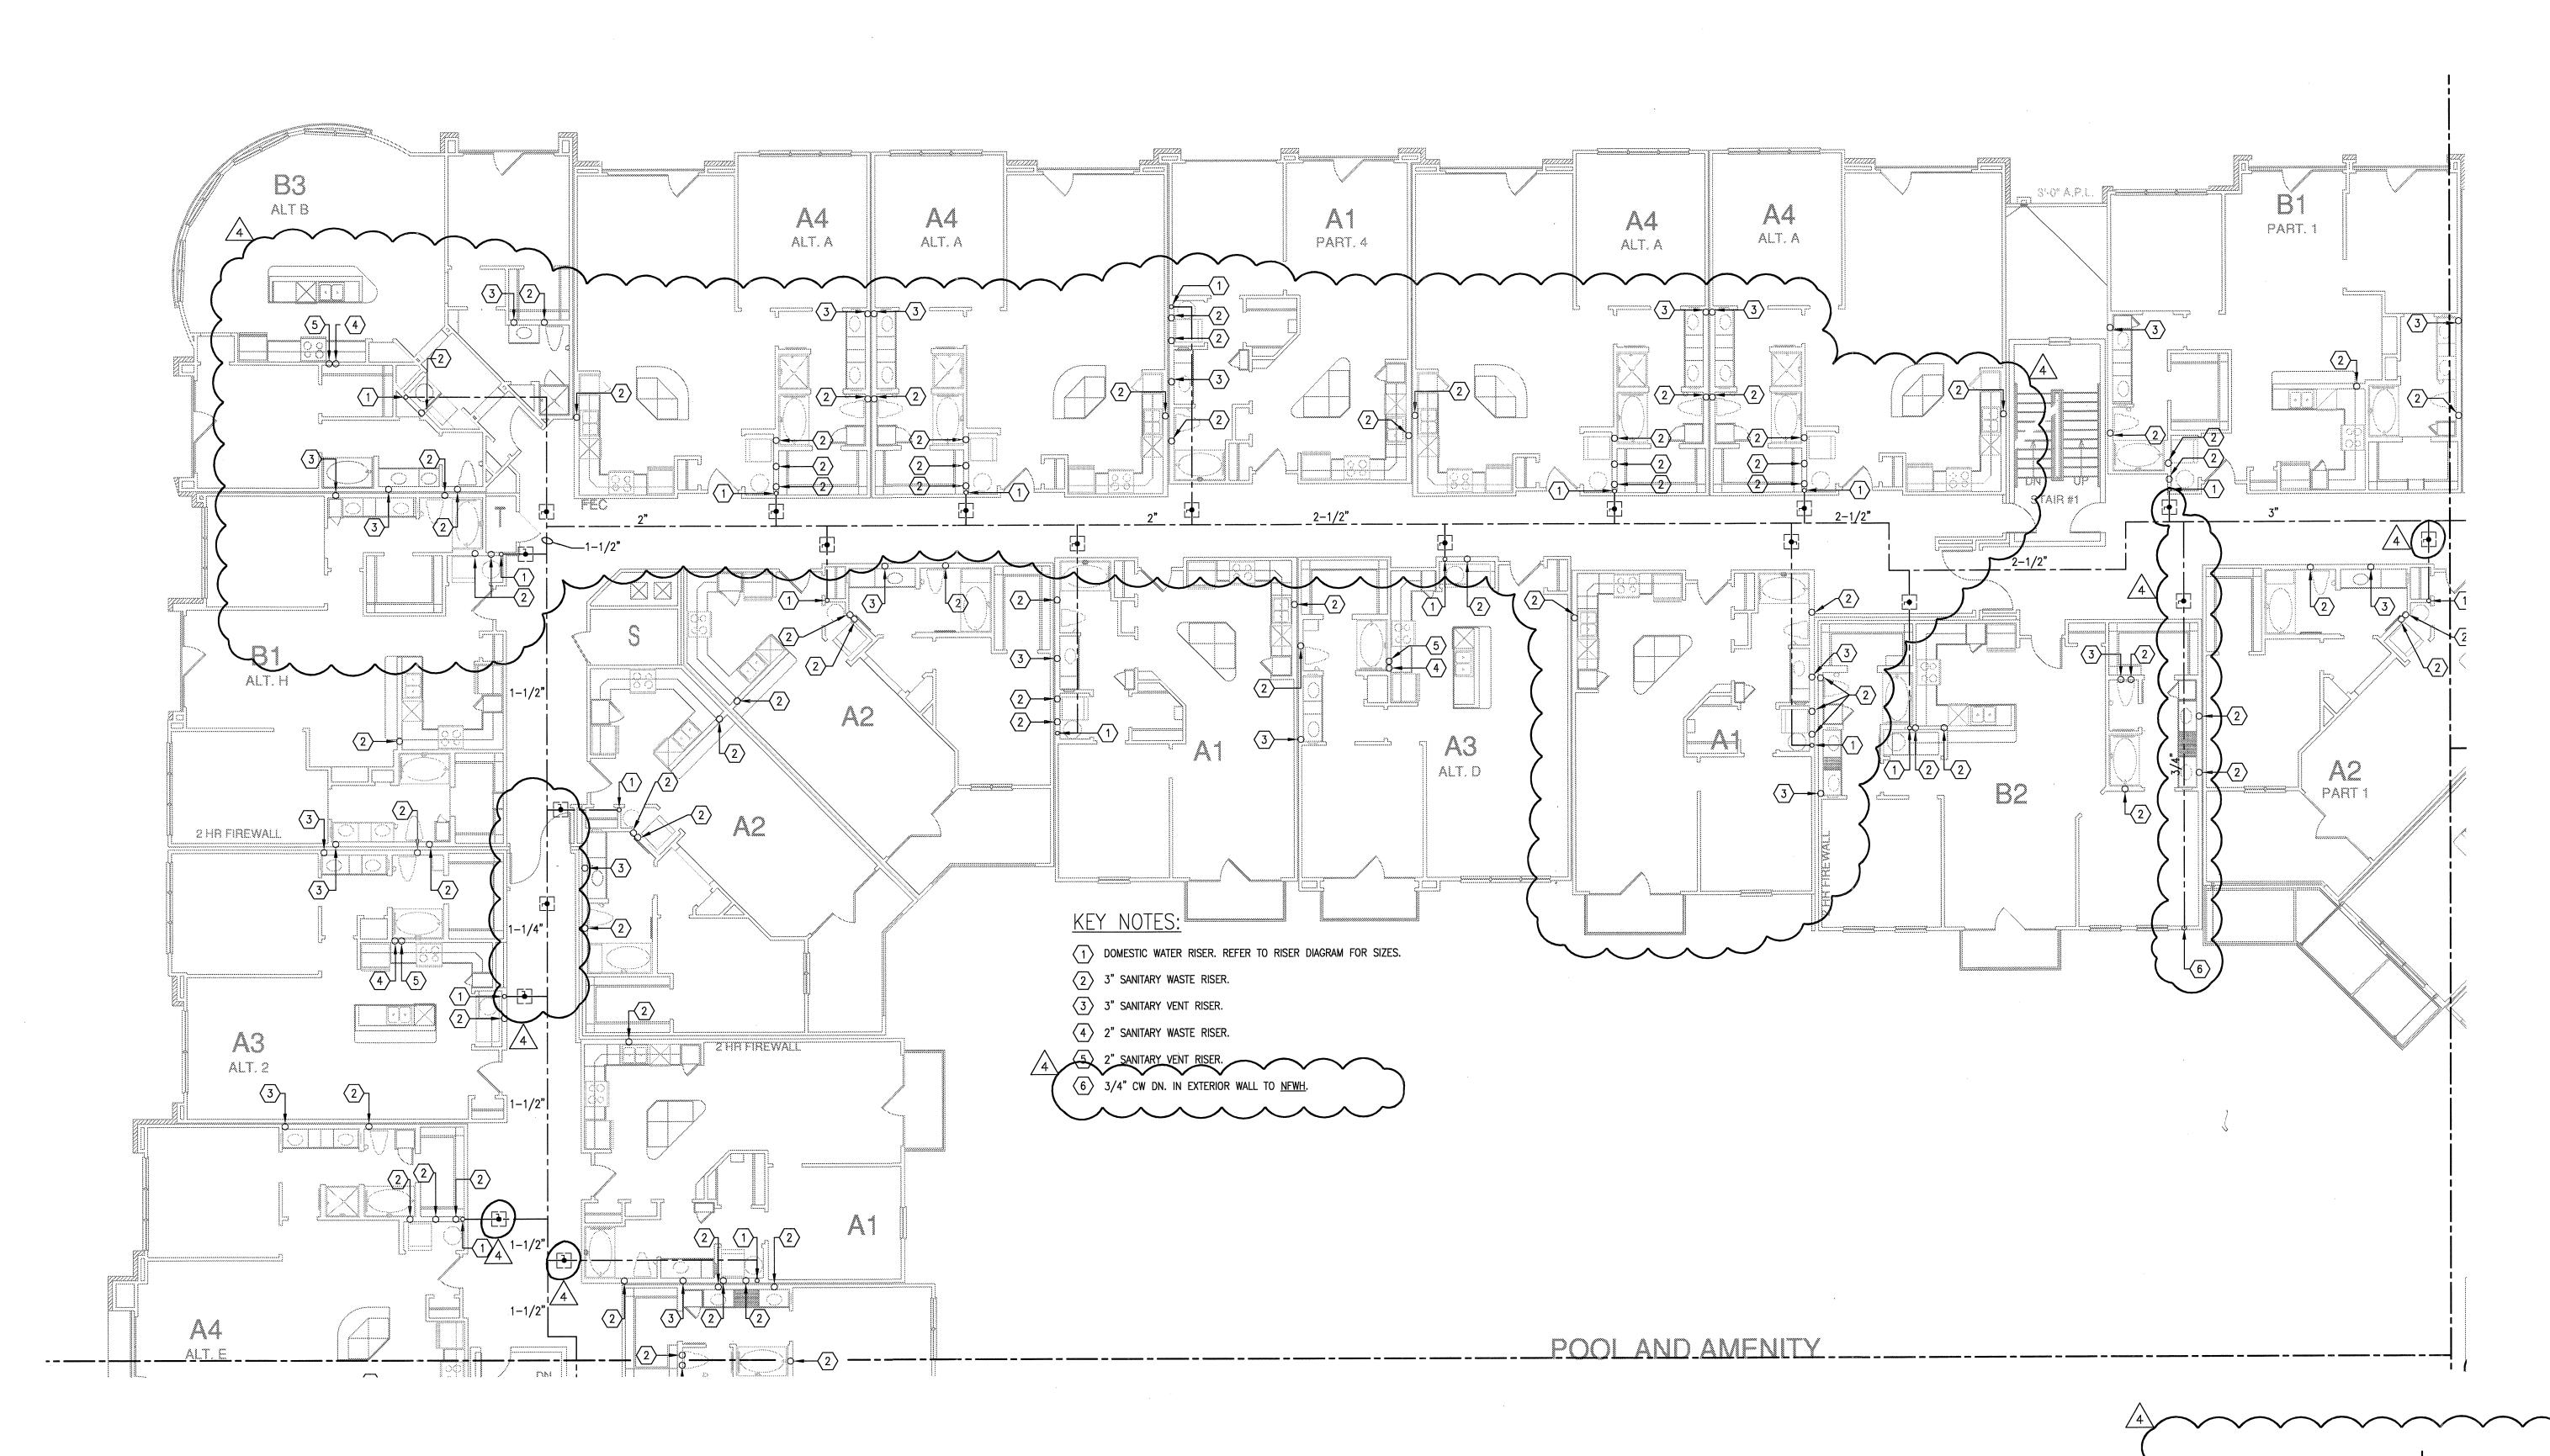

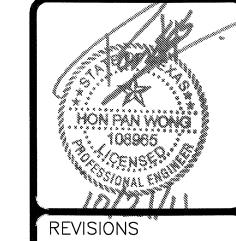

9-2-2011 DESIGN REVISIONS 9-13-2011 ANSI/FHA COMMENTS

3 9-23-2011 DESIGN REVISIONS 4 10-17-2011 CONSTRUCTION ISSUE

BGO architects 4144 N. Central Expy. Suite 855 Dallas, TX 75204 214.520.8878 bgoarchitects.com

DATE 08 - 05 - 1

PROJECT

SHEET NUMBER


P-3.2A


KEY\_PLAN

14240 Midway Road, Suite 350 Dallas, FX 73244-5138 V: (469) 383-1616 E: (469) 385-1615

Texas Firm Registration # F-4990 Checked By: RC

DIVISION 'A' SECOND FLOOR PLAN SCALE: 1/8" = 1'-0"

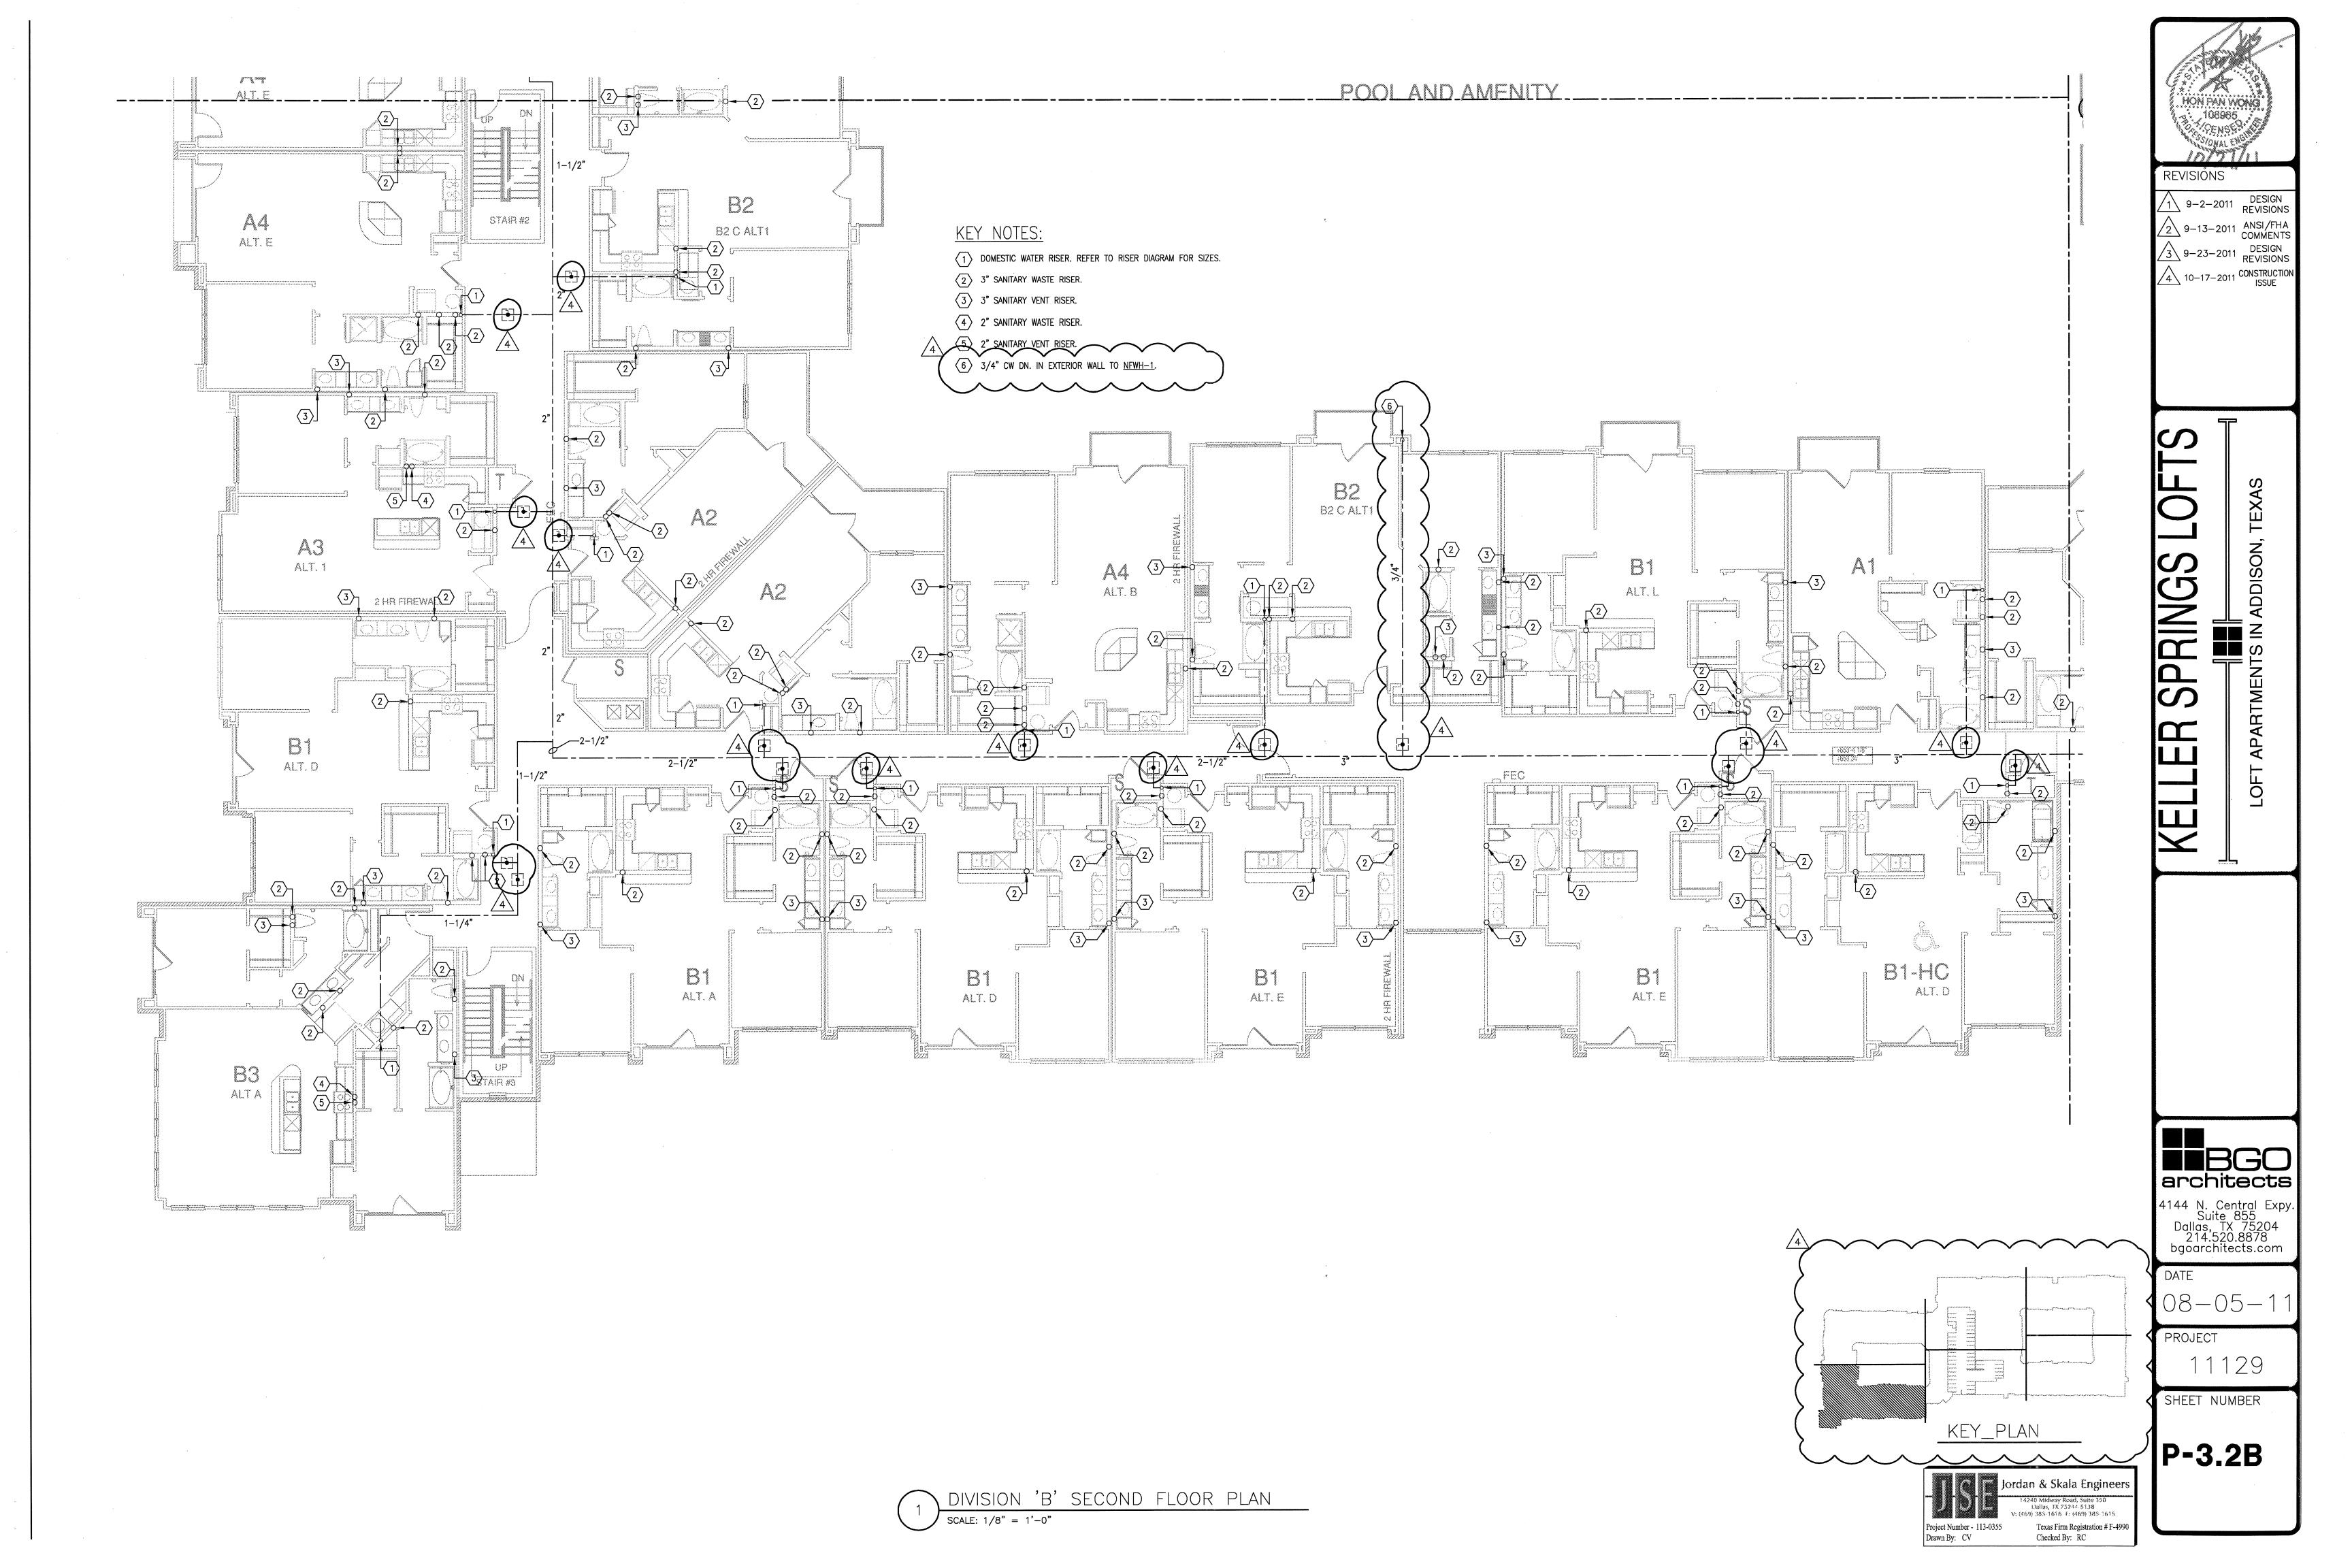

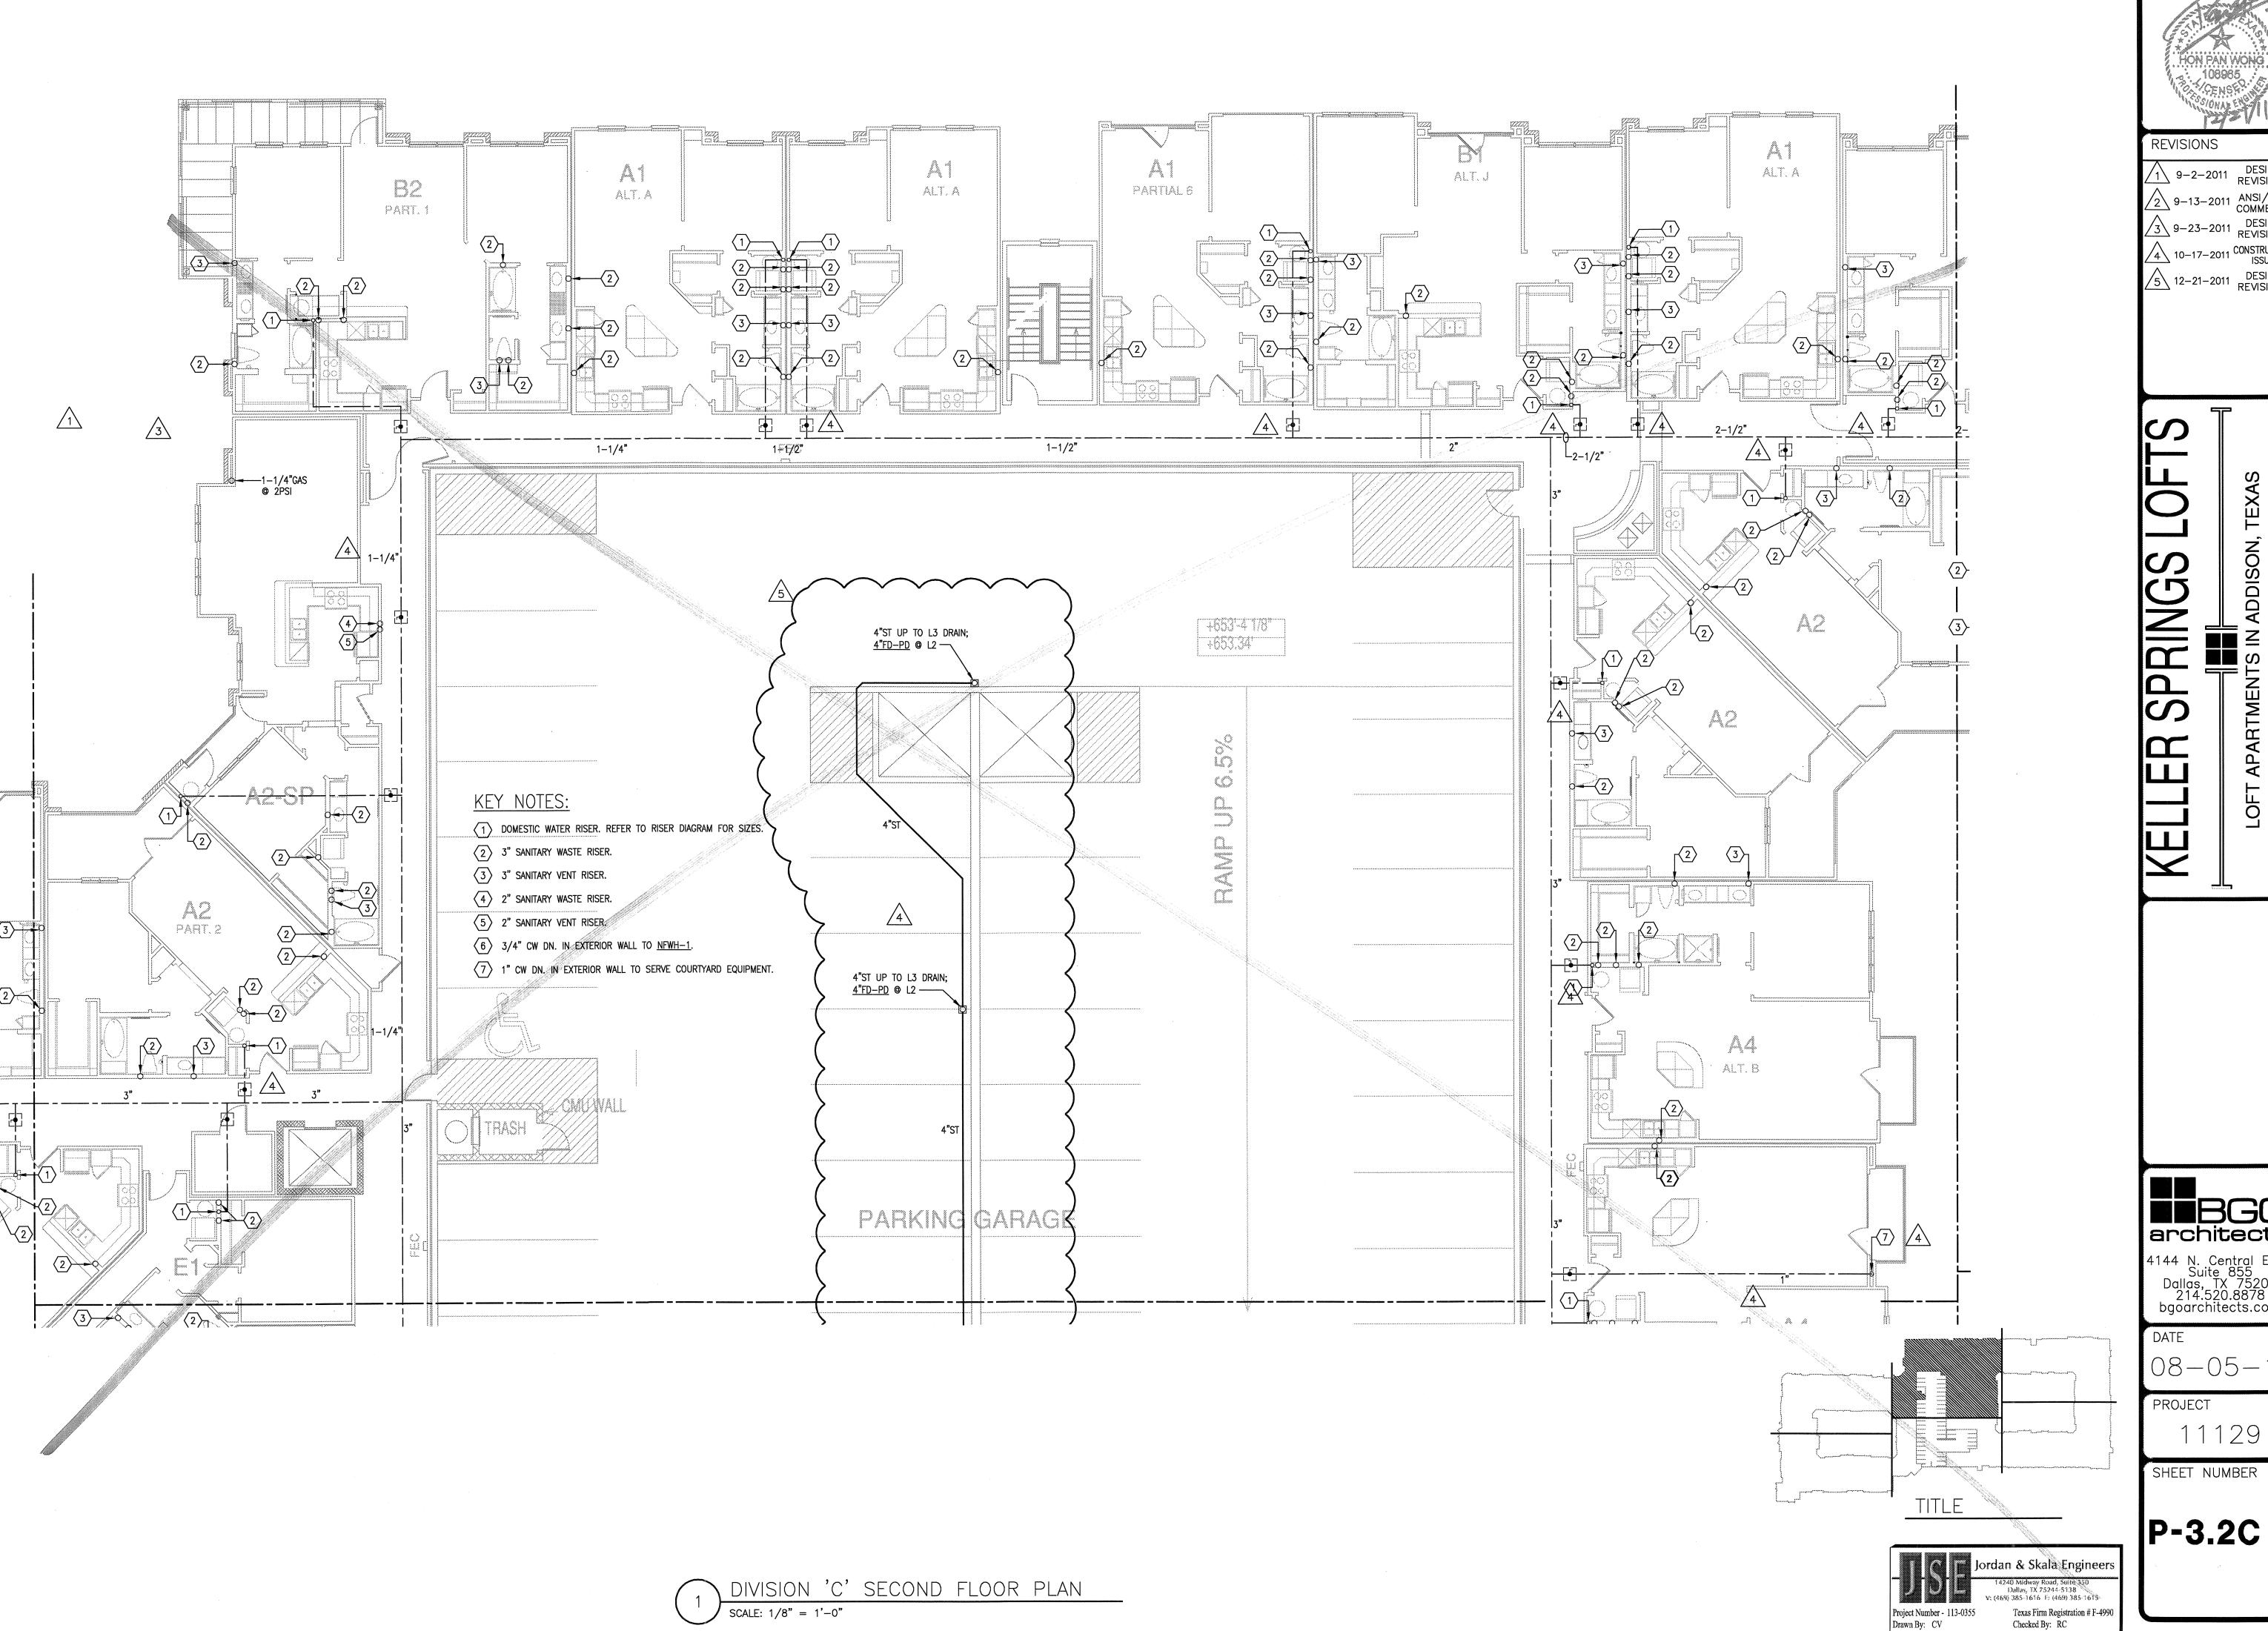

1 9-2-2011 DESIGN REVISIONS 2 9-13-2011 ANSI/FHA COMMENTS 3 9-23-2011 DESIGN REVISIONS 4 10-17-2011 CONSTRUCTION ISSUE 5 12-21-2011 DESIGN REVISIONS


BBGO architects 4144 N. Central Expy. Suite 855 Dallas, TX 75204 214.520.8878 bgoarchitects.com


08-05-11


PROJECT

SHEET NUMBER

P-3.2C

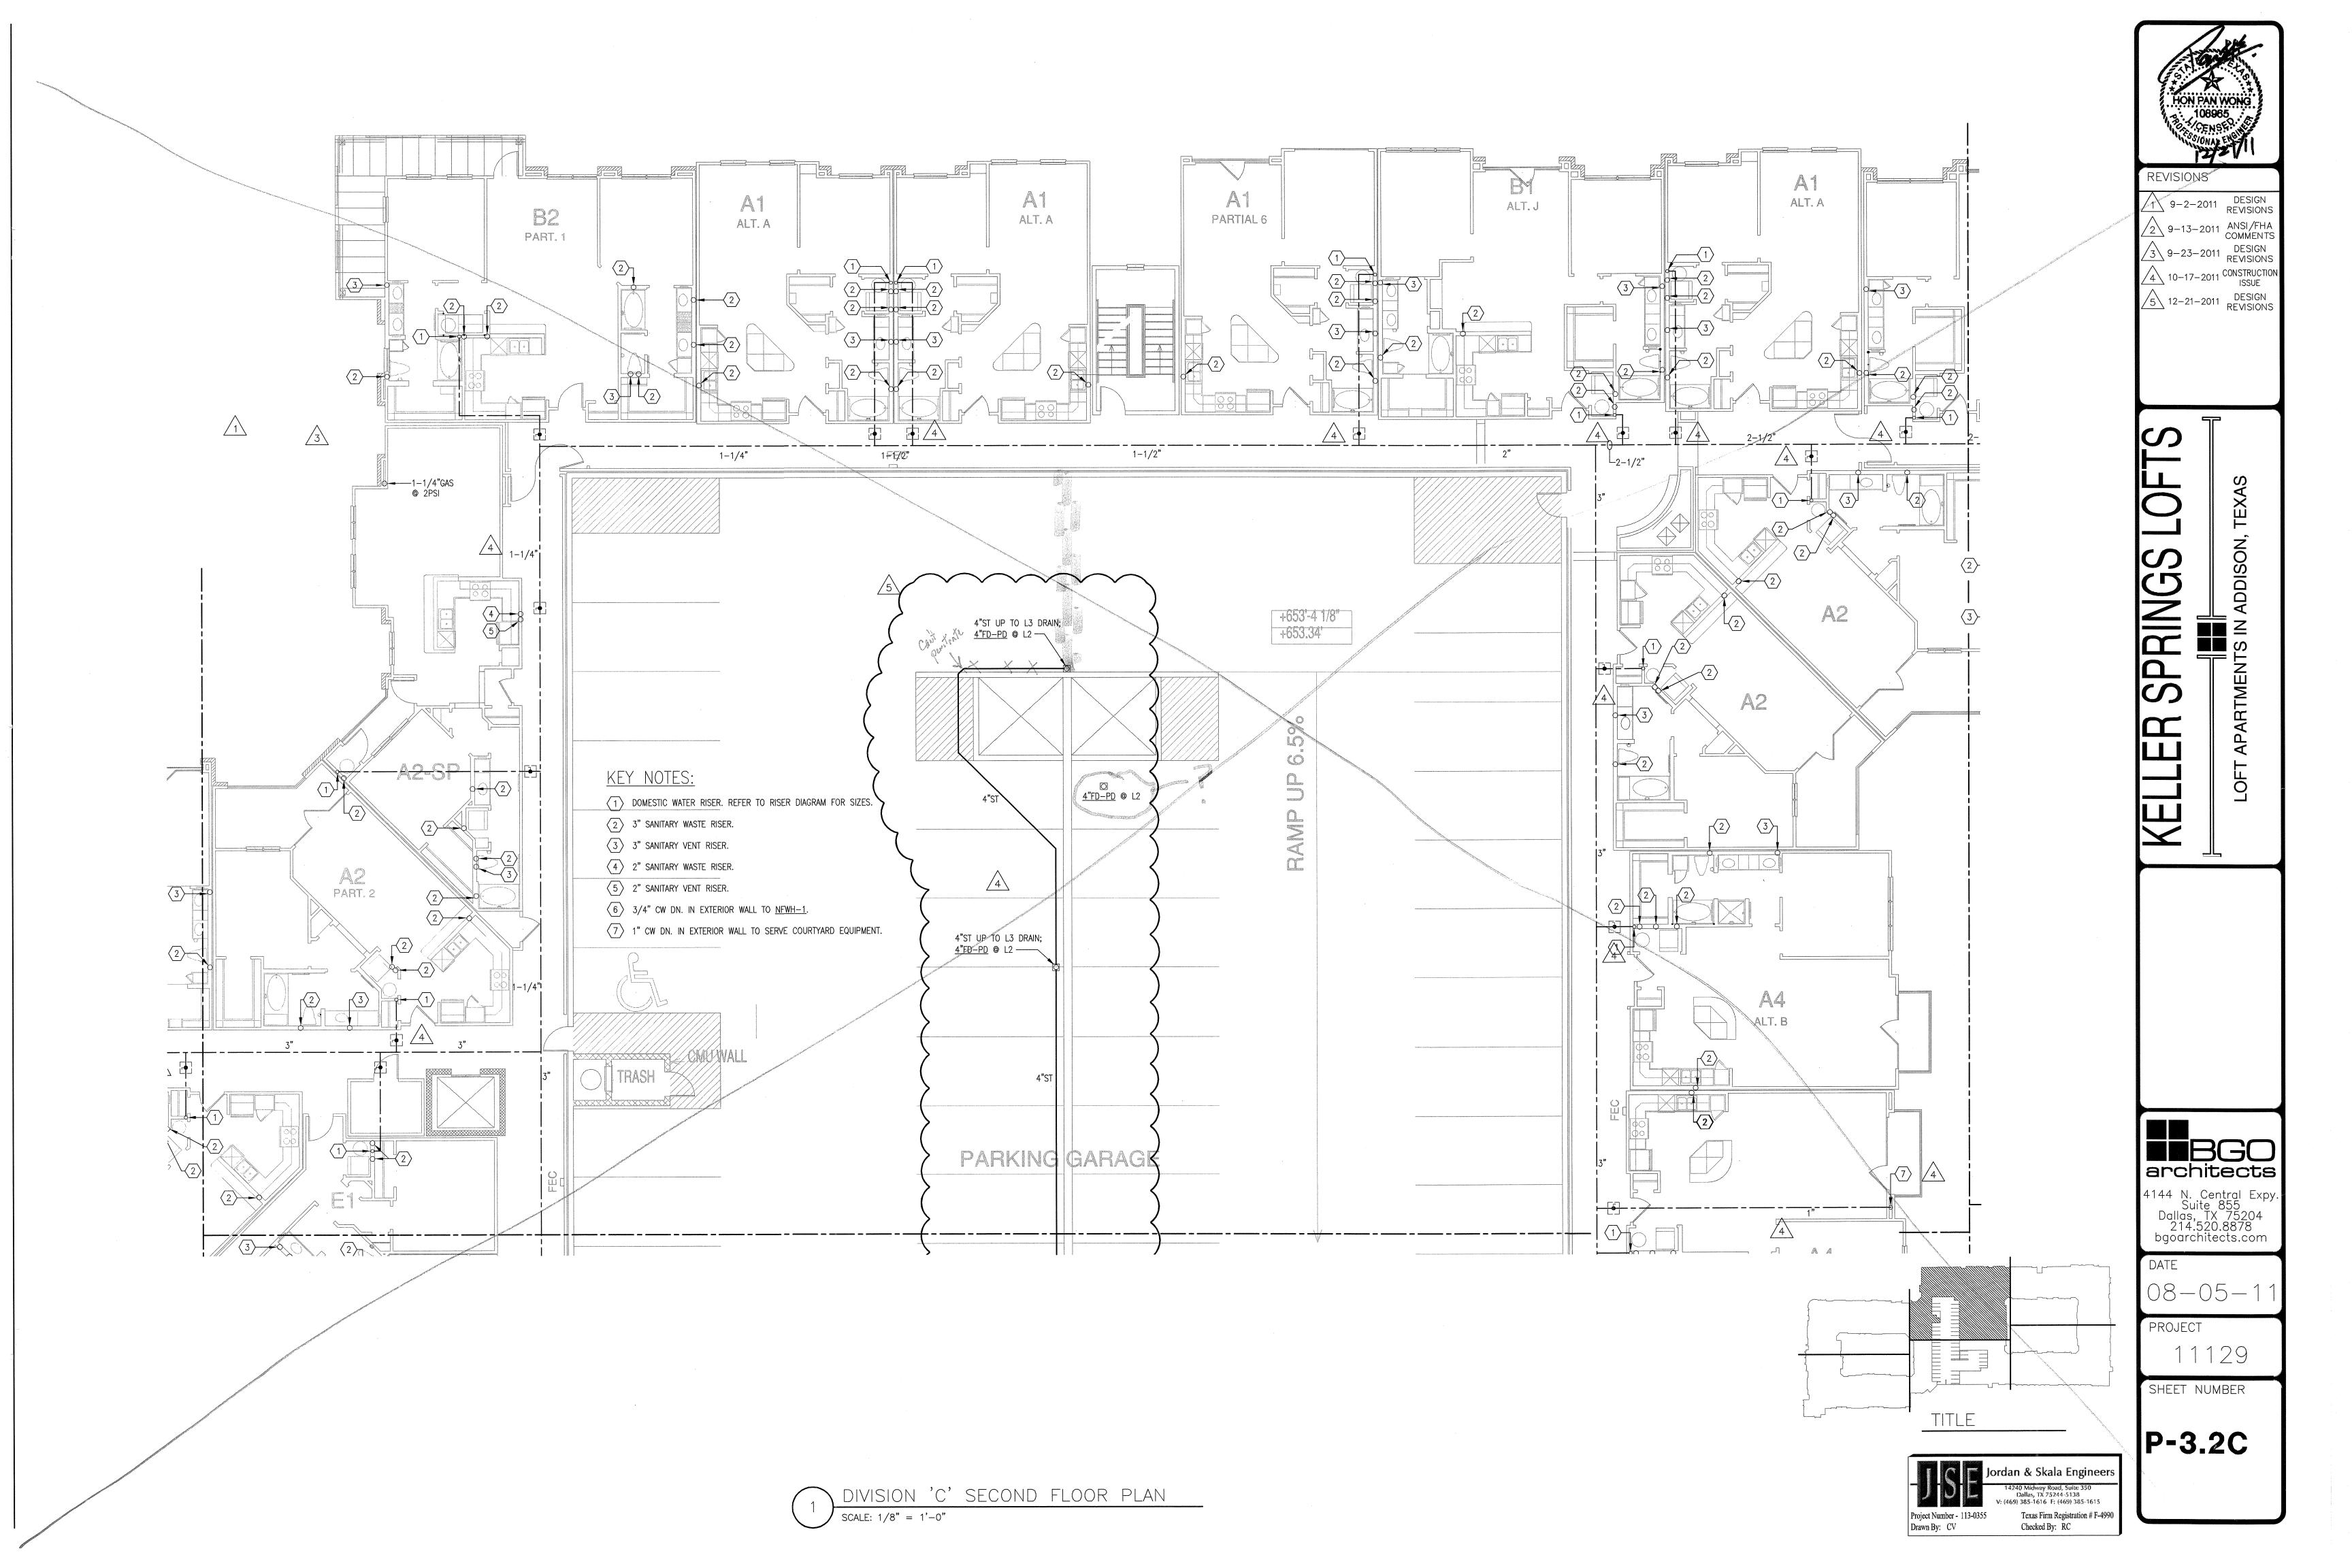

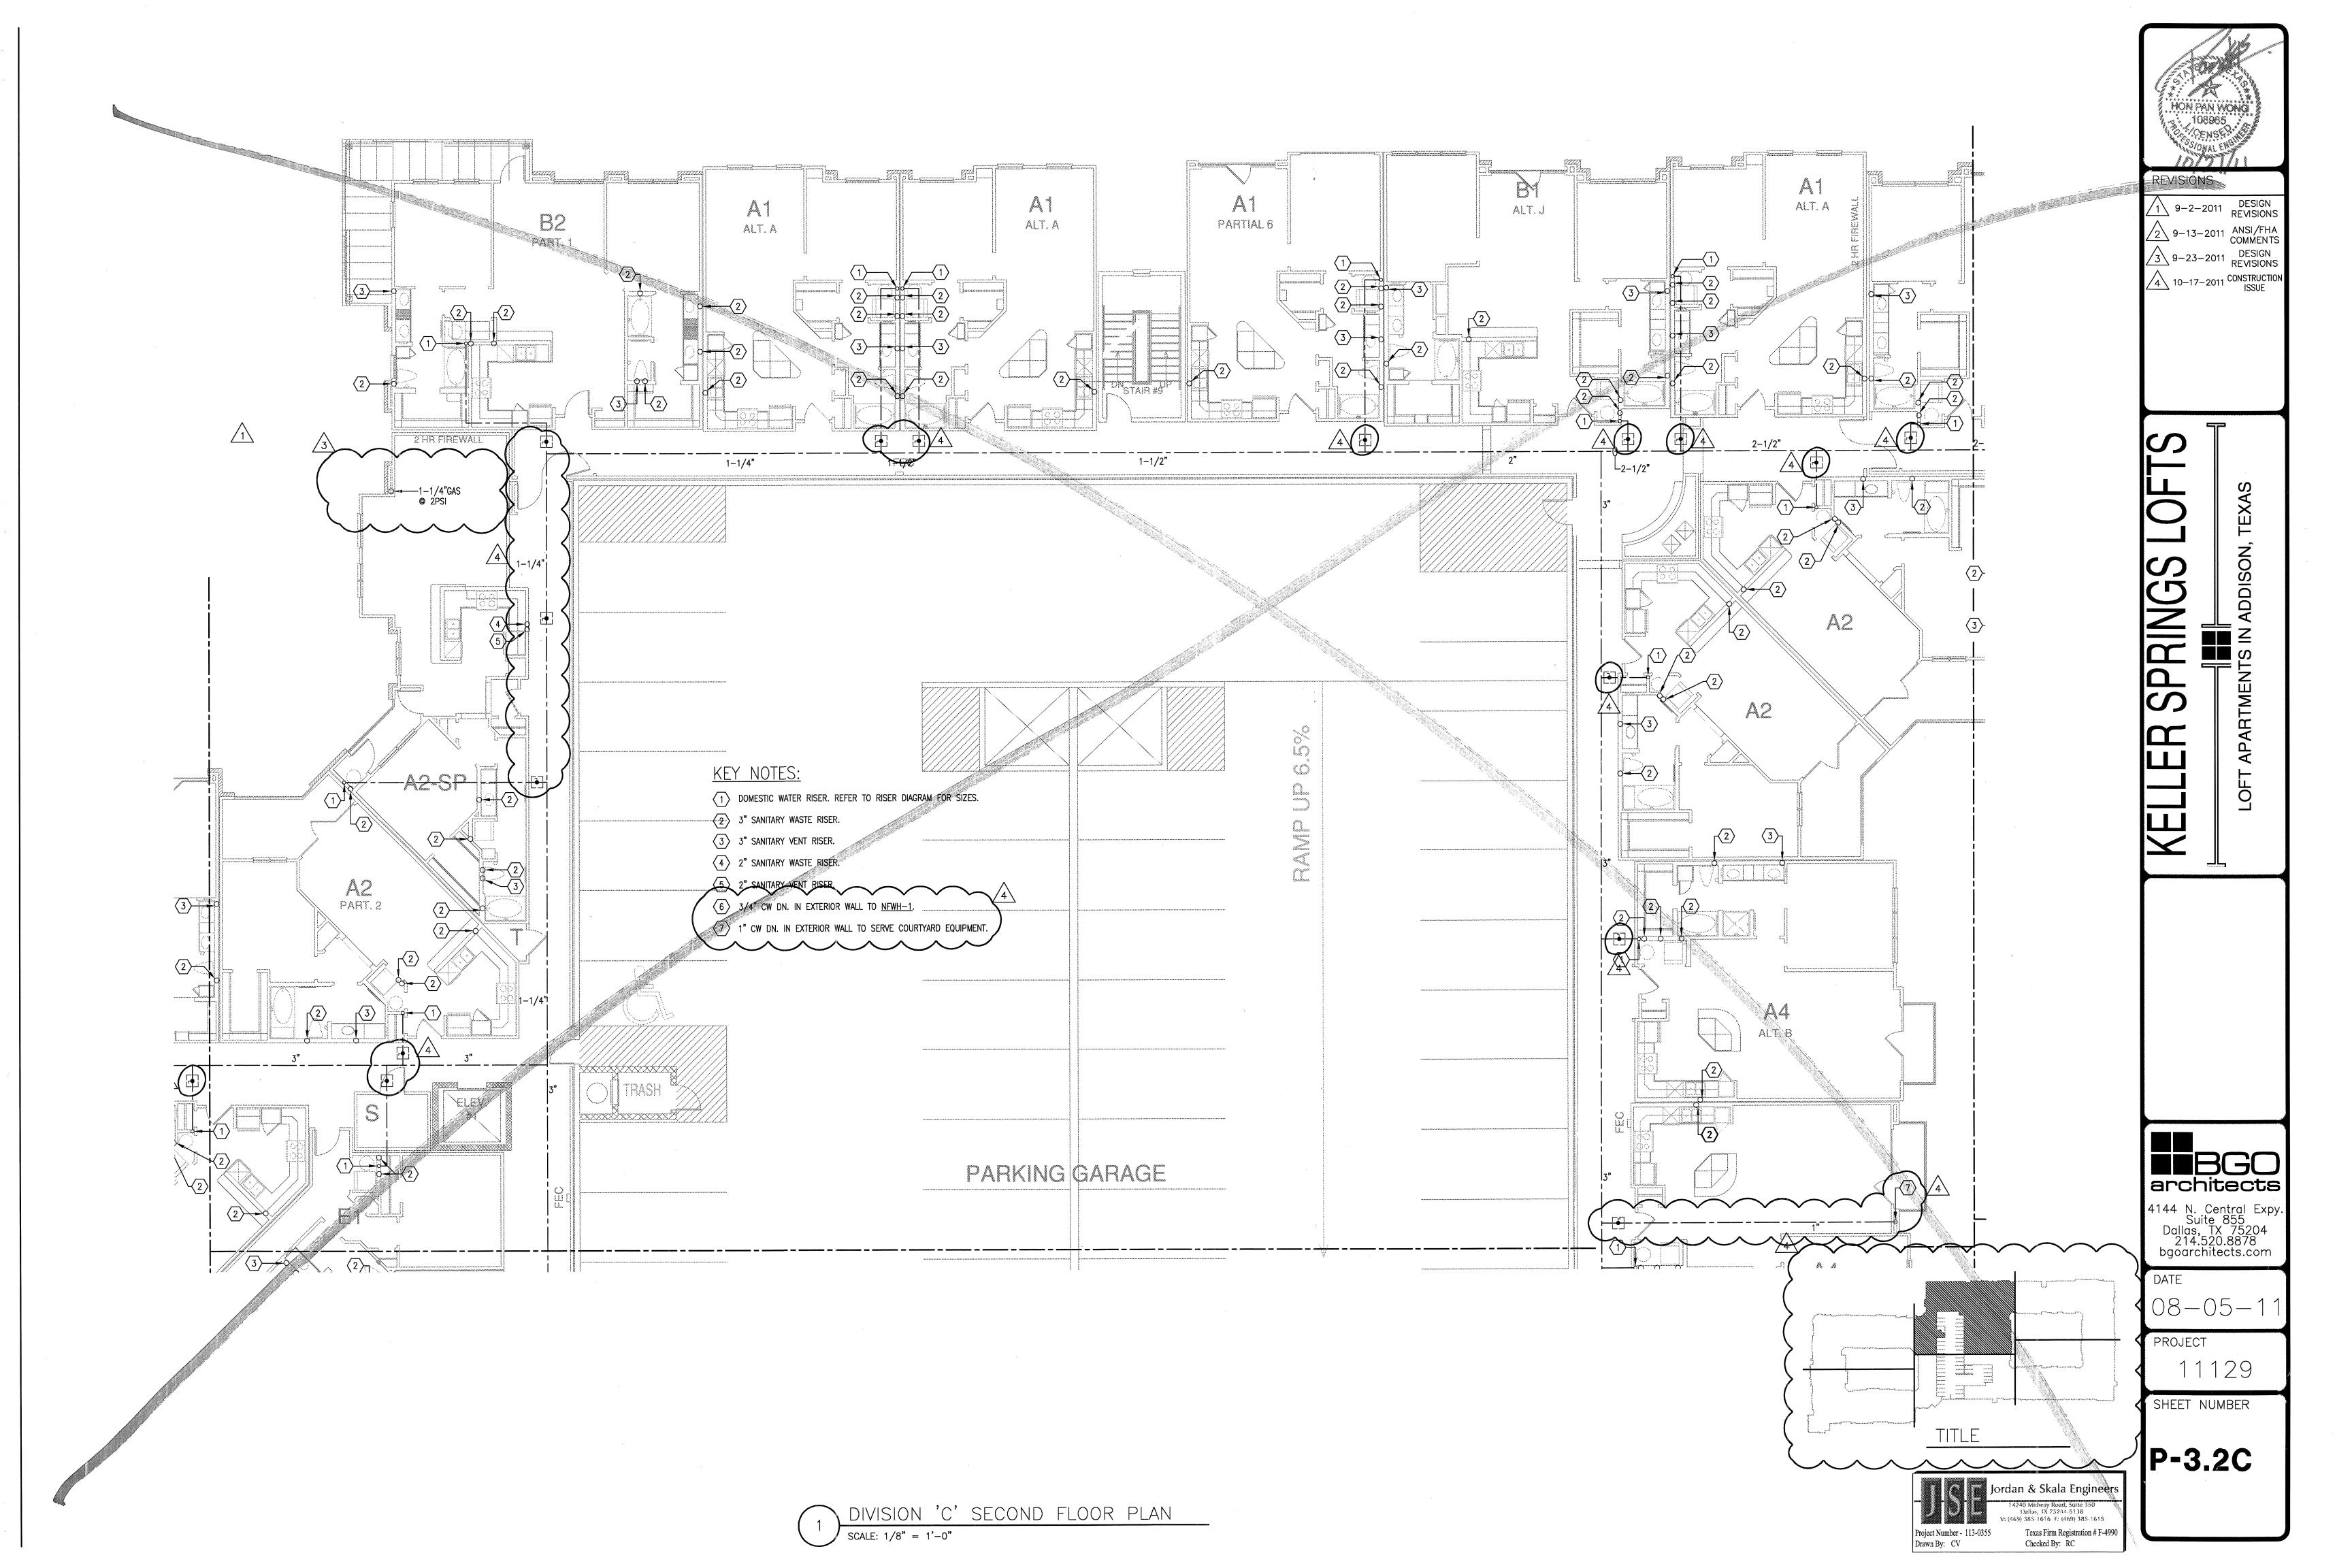

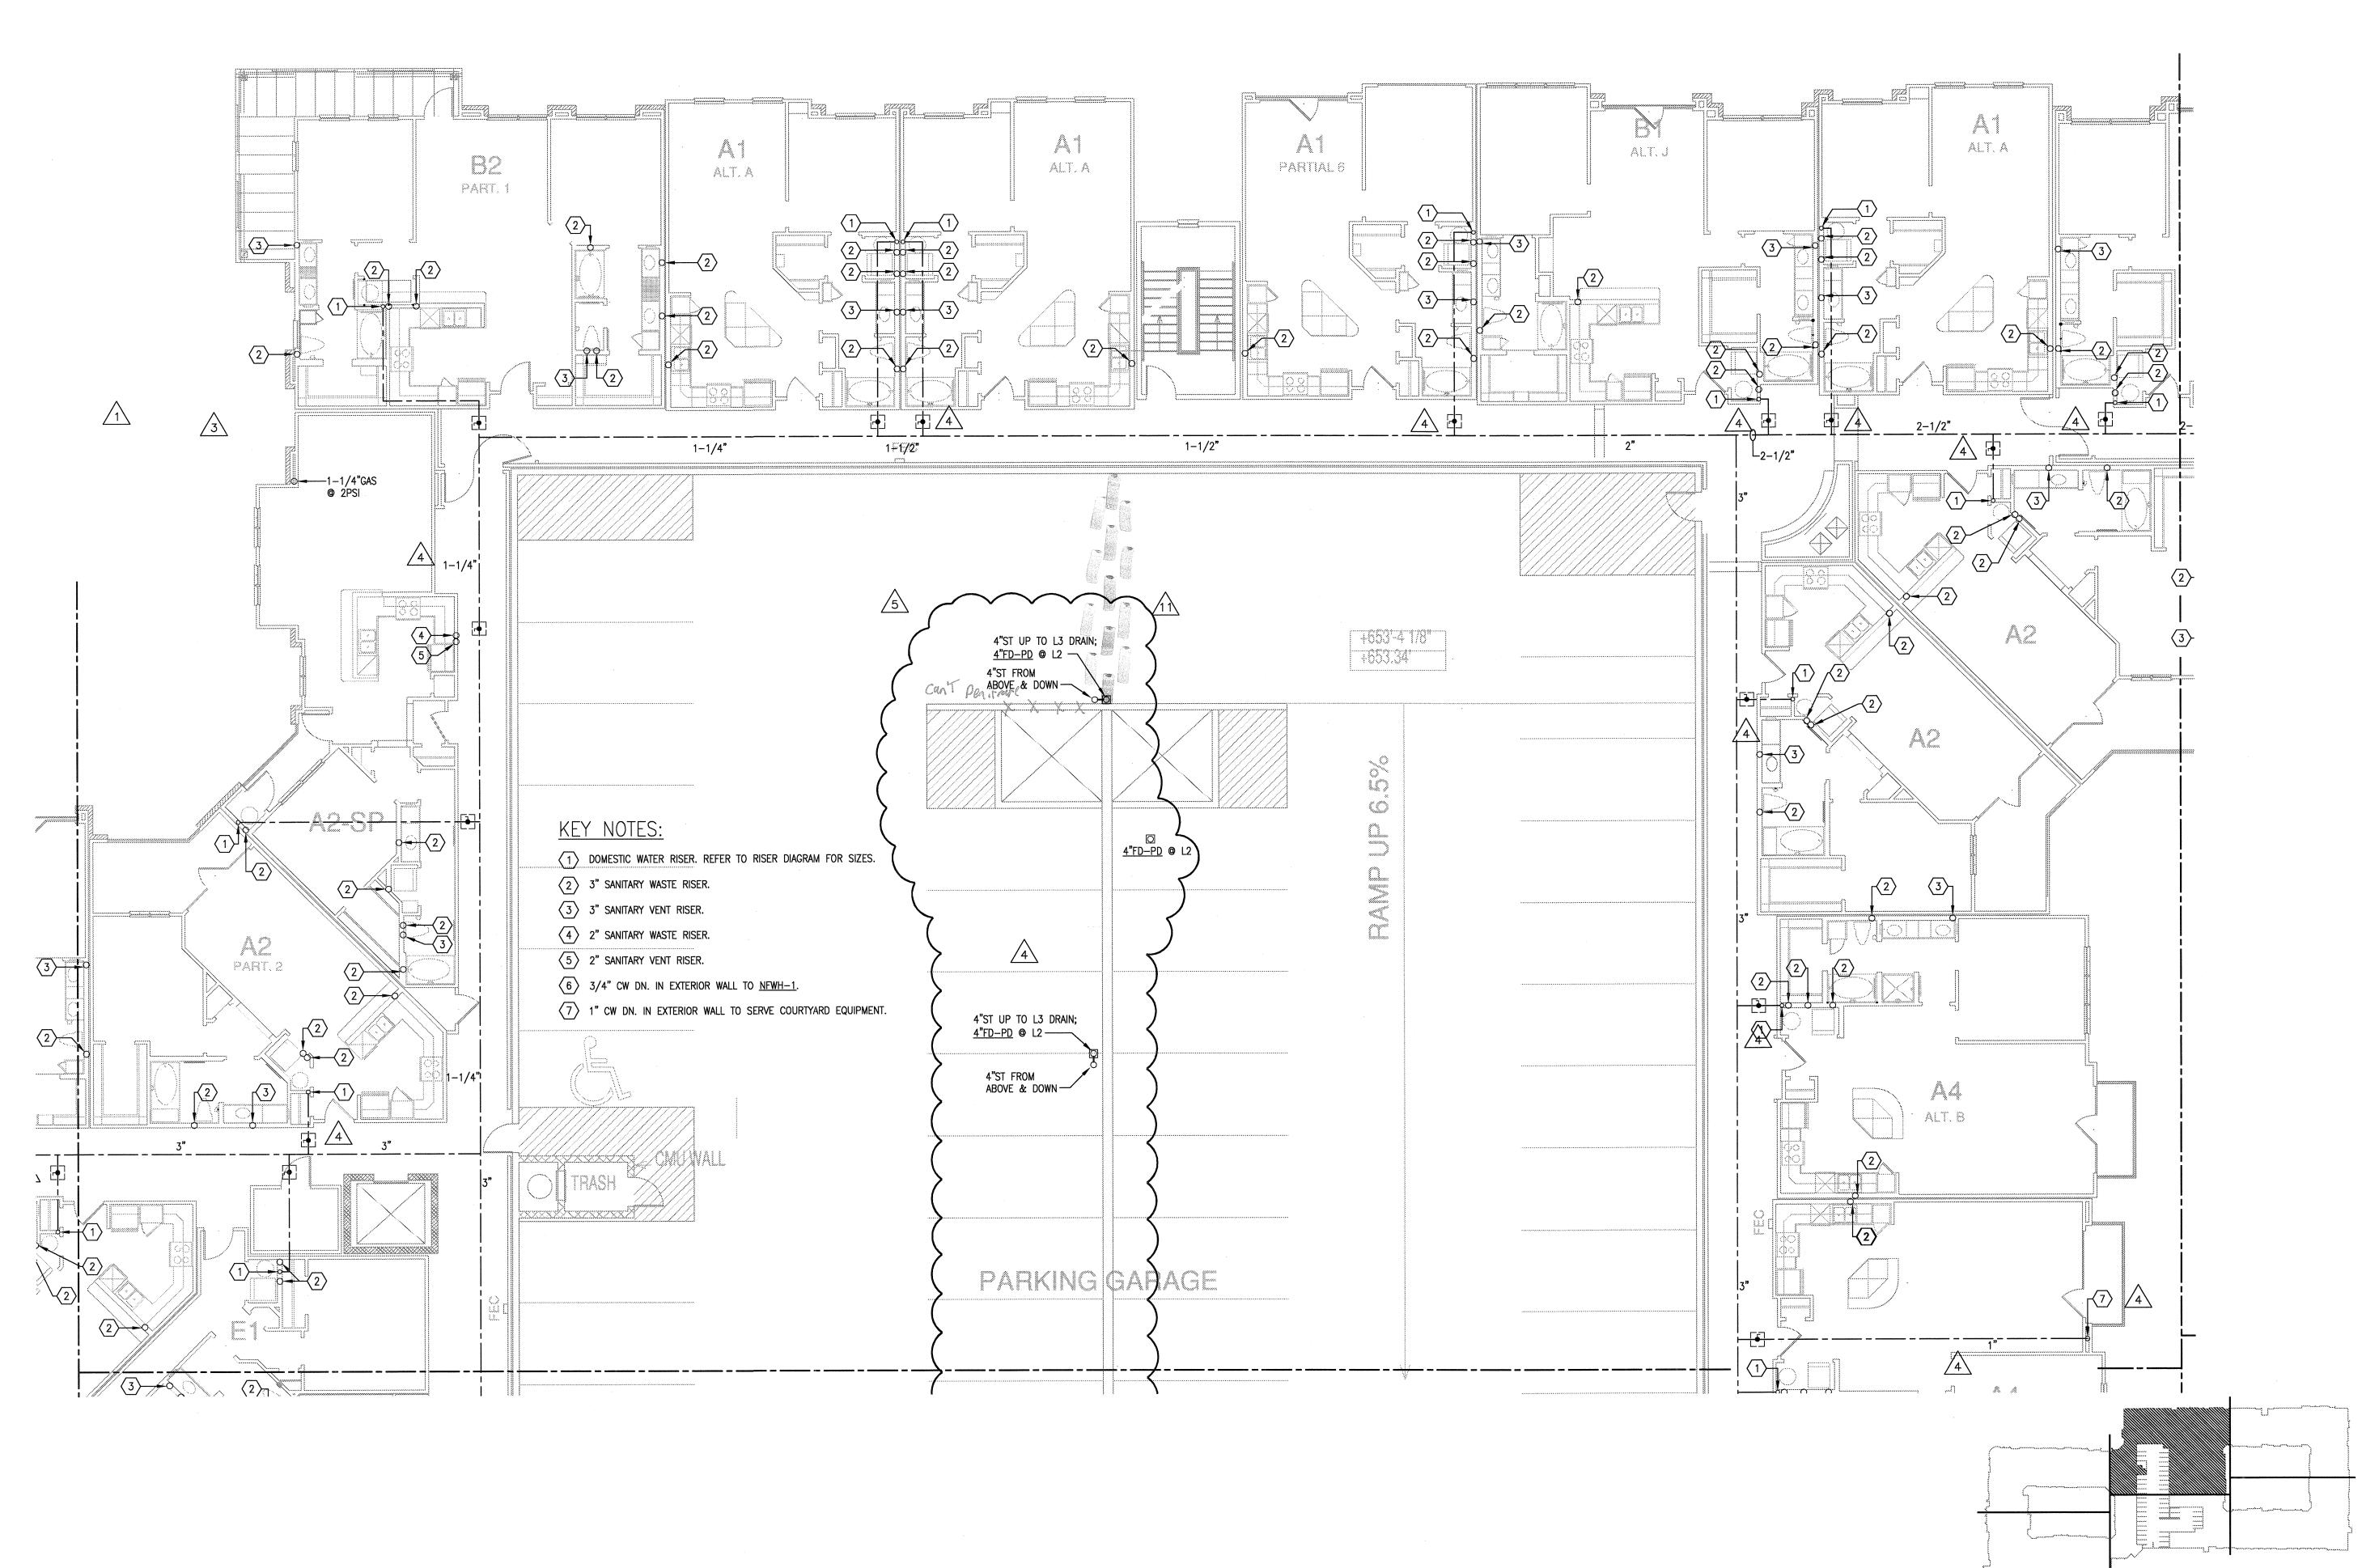

MON PAN WONG
108965
CENSE

SAVAS-S/12

REVISIONS

1 9-2-2011 DESIGN REVISIONS
2 9-13-2011 ANSI/FHA COMMENTS DESIGN REVISIONS
3 9-23-2011 REVISIONS
4 10-17-2011 CONSTRUCTION ISSUE DESIGN REVISIONS
5 12-21-2011 DESIGN REVISIONS
DESIGN REVISIONS
TRANSFORMER
7 2-15-2012 REVISIONS
8 3-27-2012 CLUBHOUSE REVISIONS

2-15-2012 REVIS

8 3-27-2012 CLUBH
REVIS

4-17-2012 COORDIN

5-15-2012 COORDINATION
5-30-2012 SITE COORDINATION

BBGO architects 4144 N. Central Expy.

4144 N. Central Expy. Suite 855 Dallas, TX 75204 214.520.8878 bgoarchitects.com

DATE 08-05-1

PROJECT

11129

SHEET NUMBER


P-3.2C


Jordan & Skala Engineers


Texas Firm Registration # F-4990


17855 N. Dallas Parkway., Suite 320 Dallas, TX 75287-6857 : (469) 385-1616 Webrww.jurdanskala.

Checked By: RC

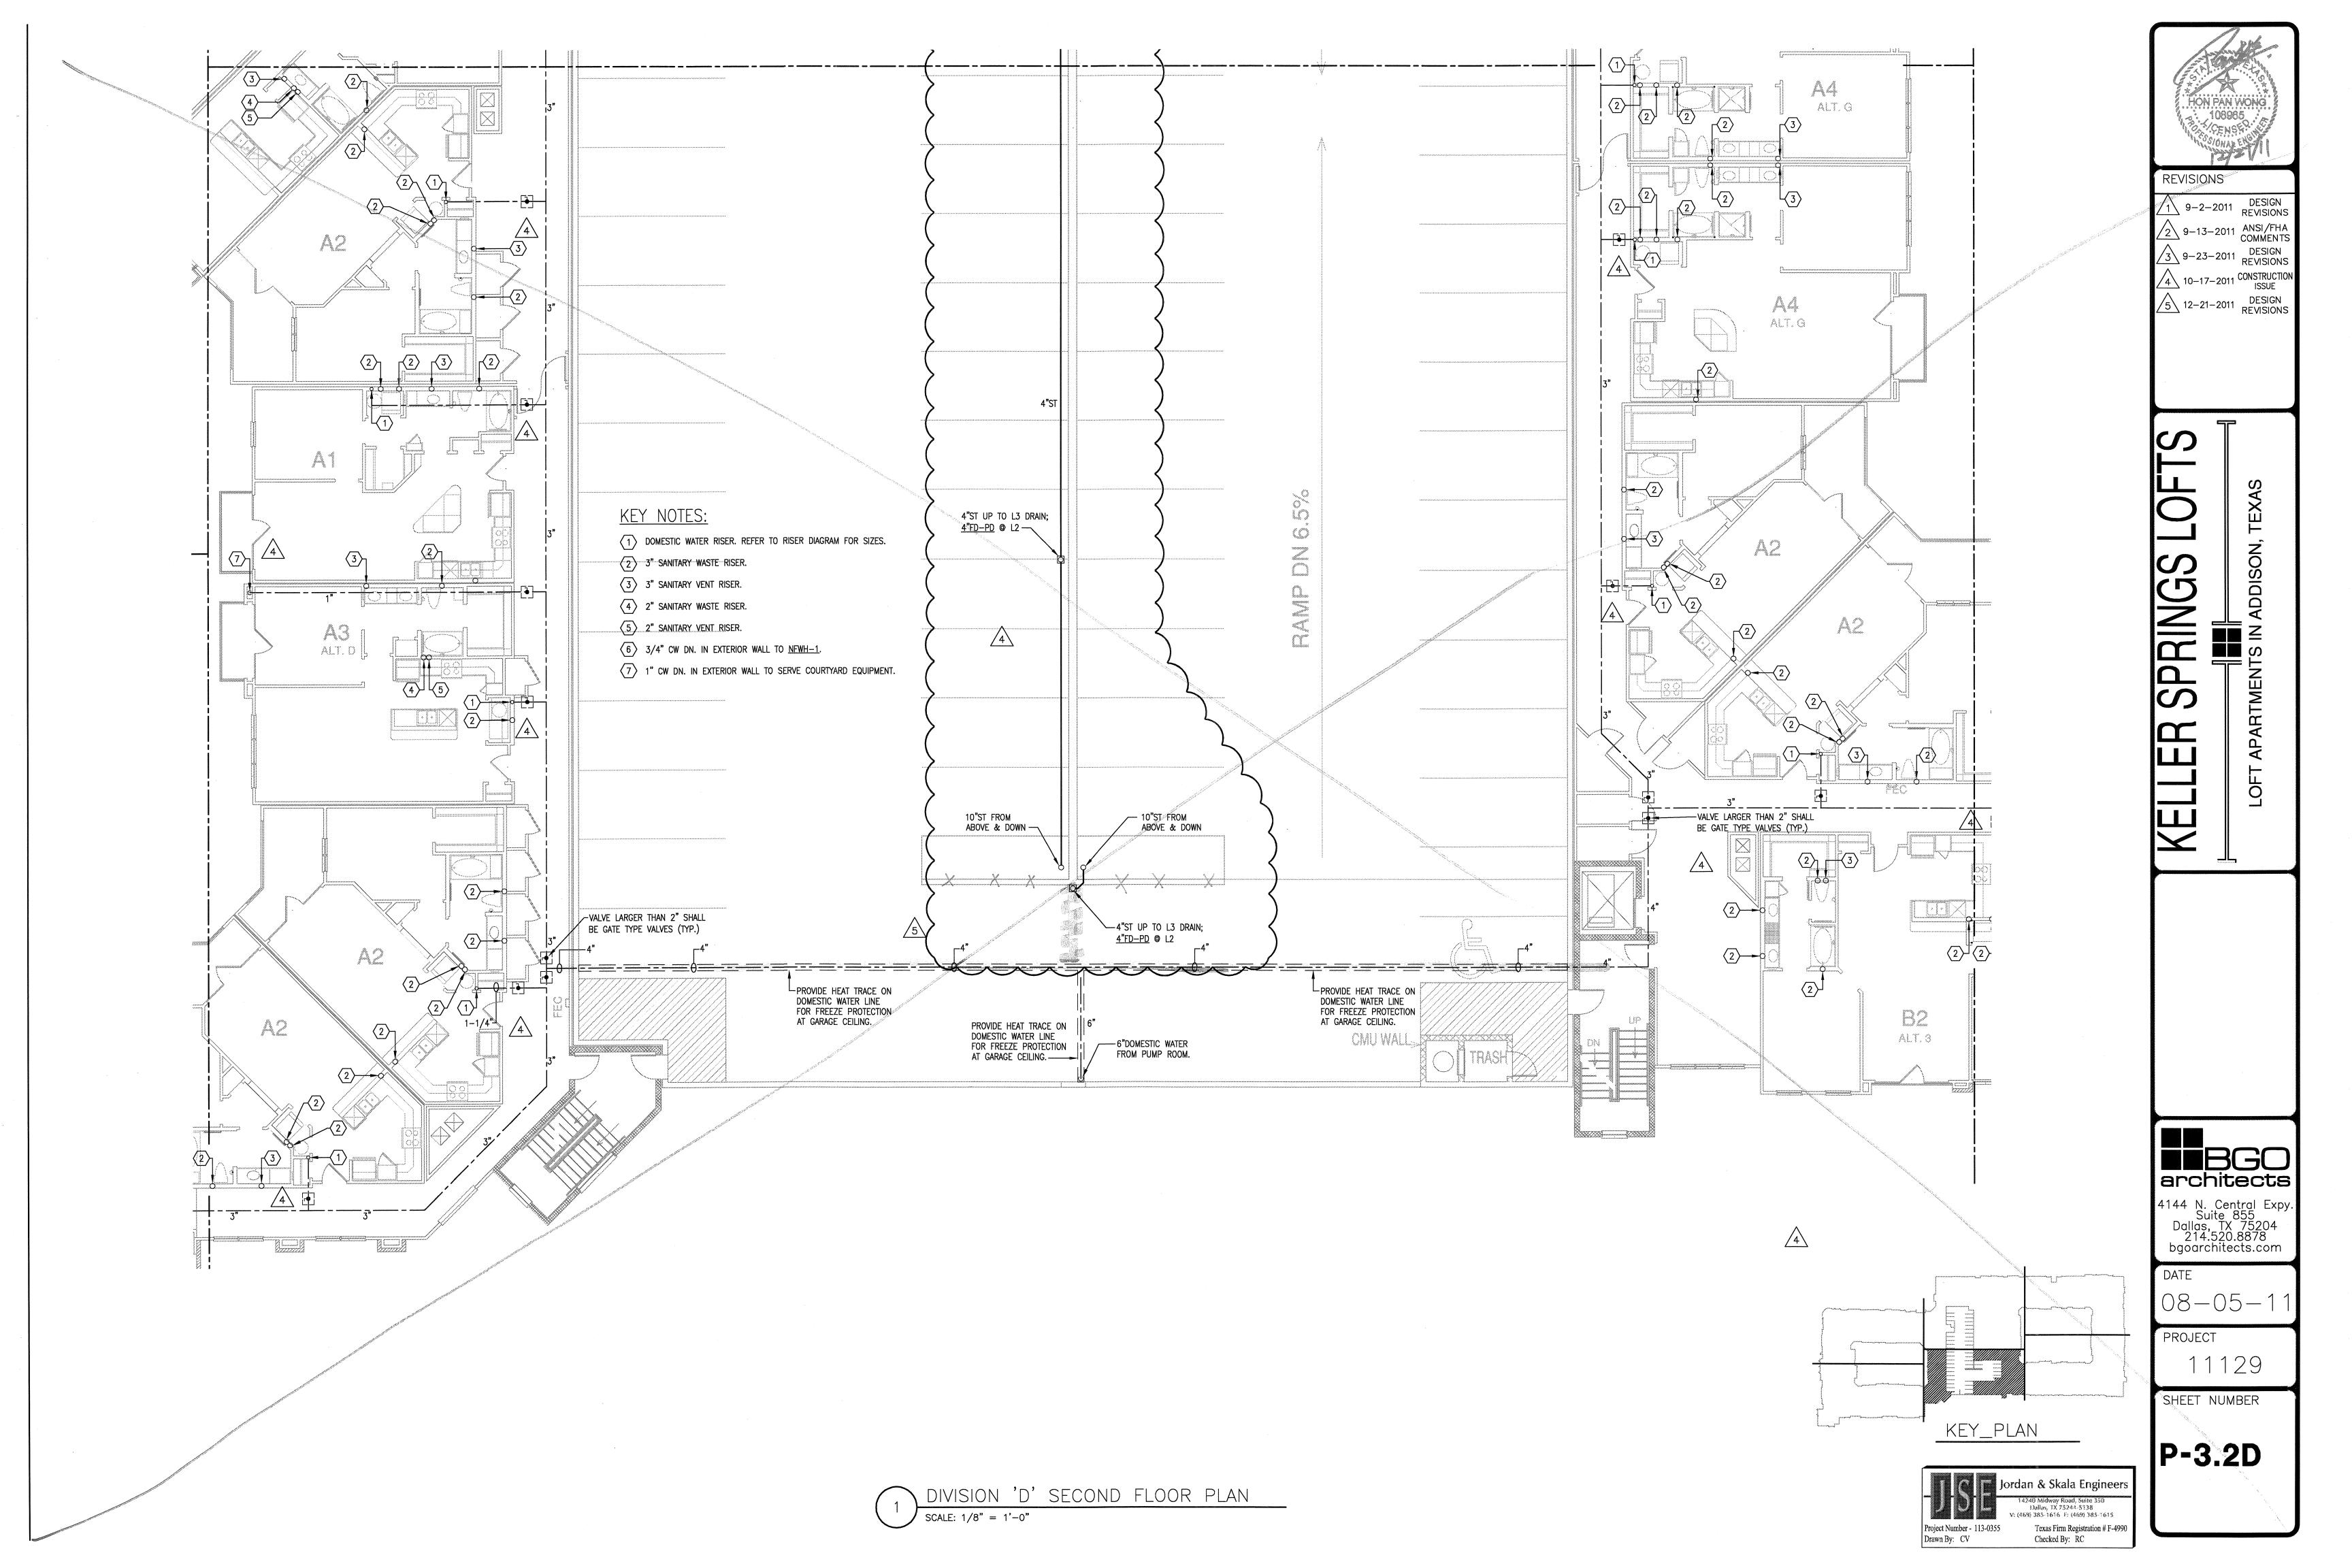

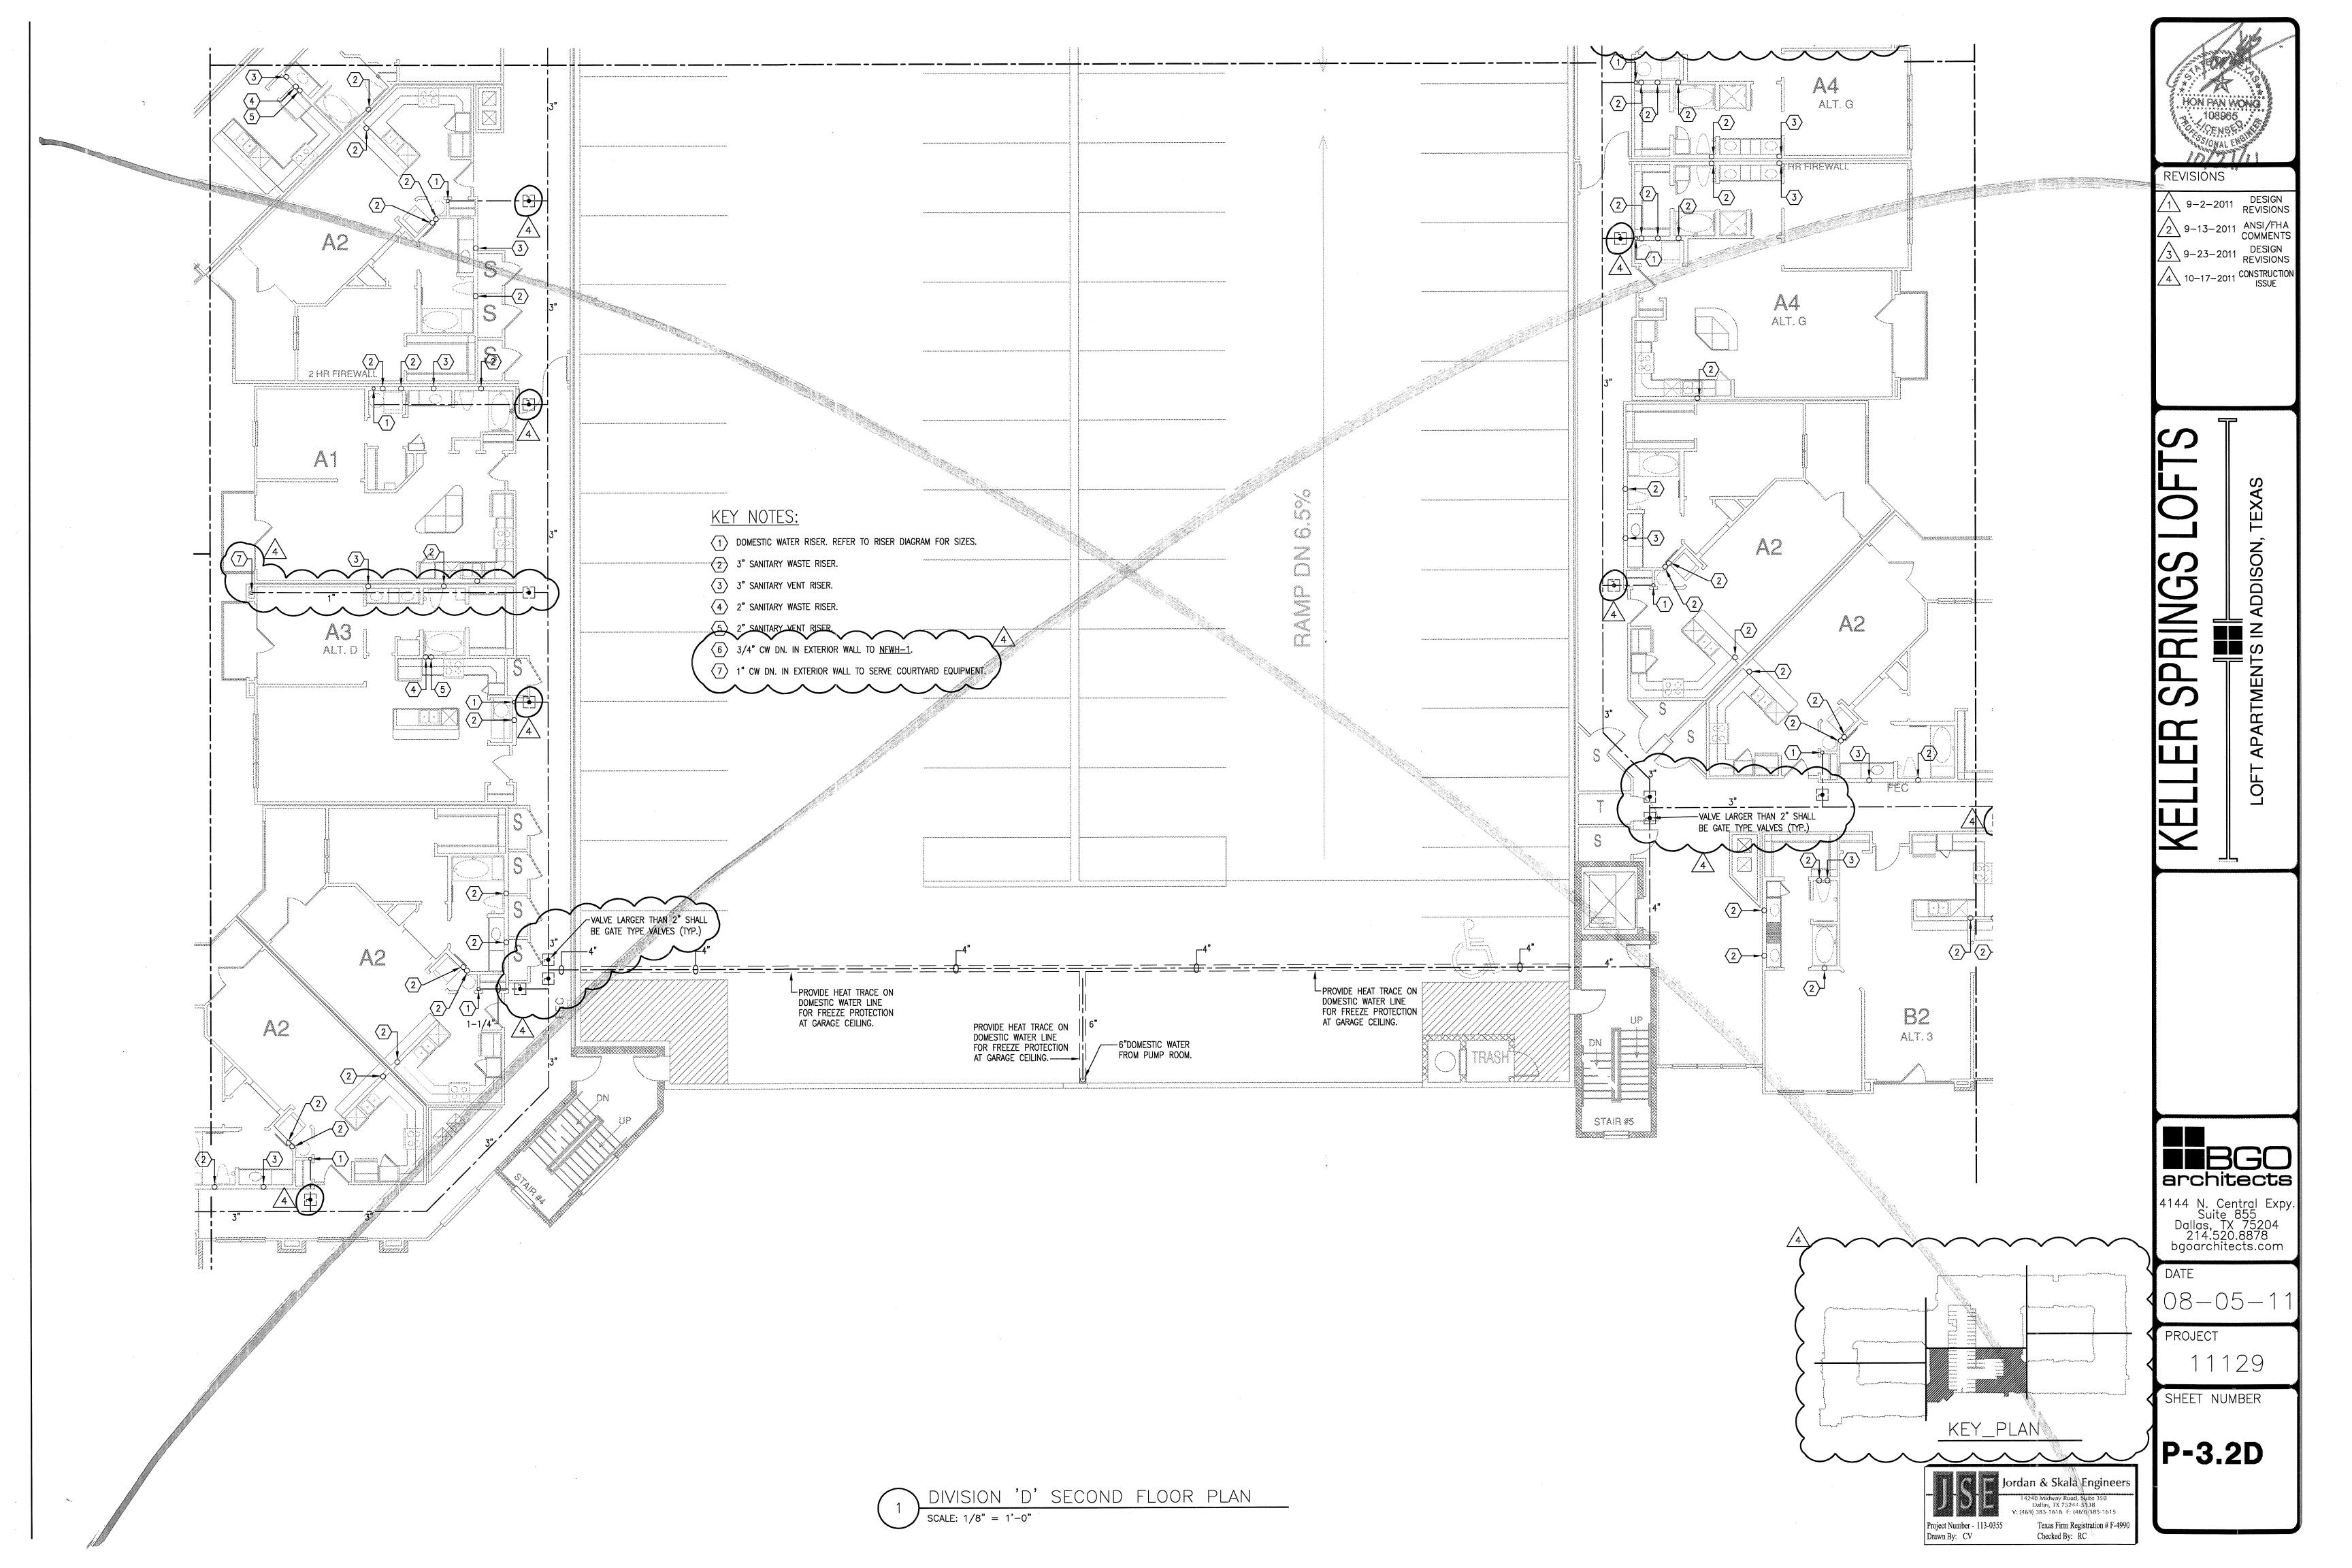

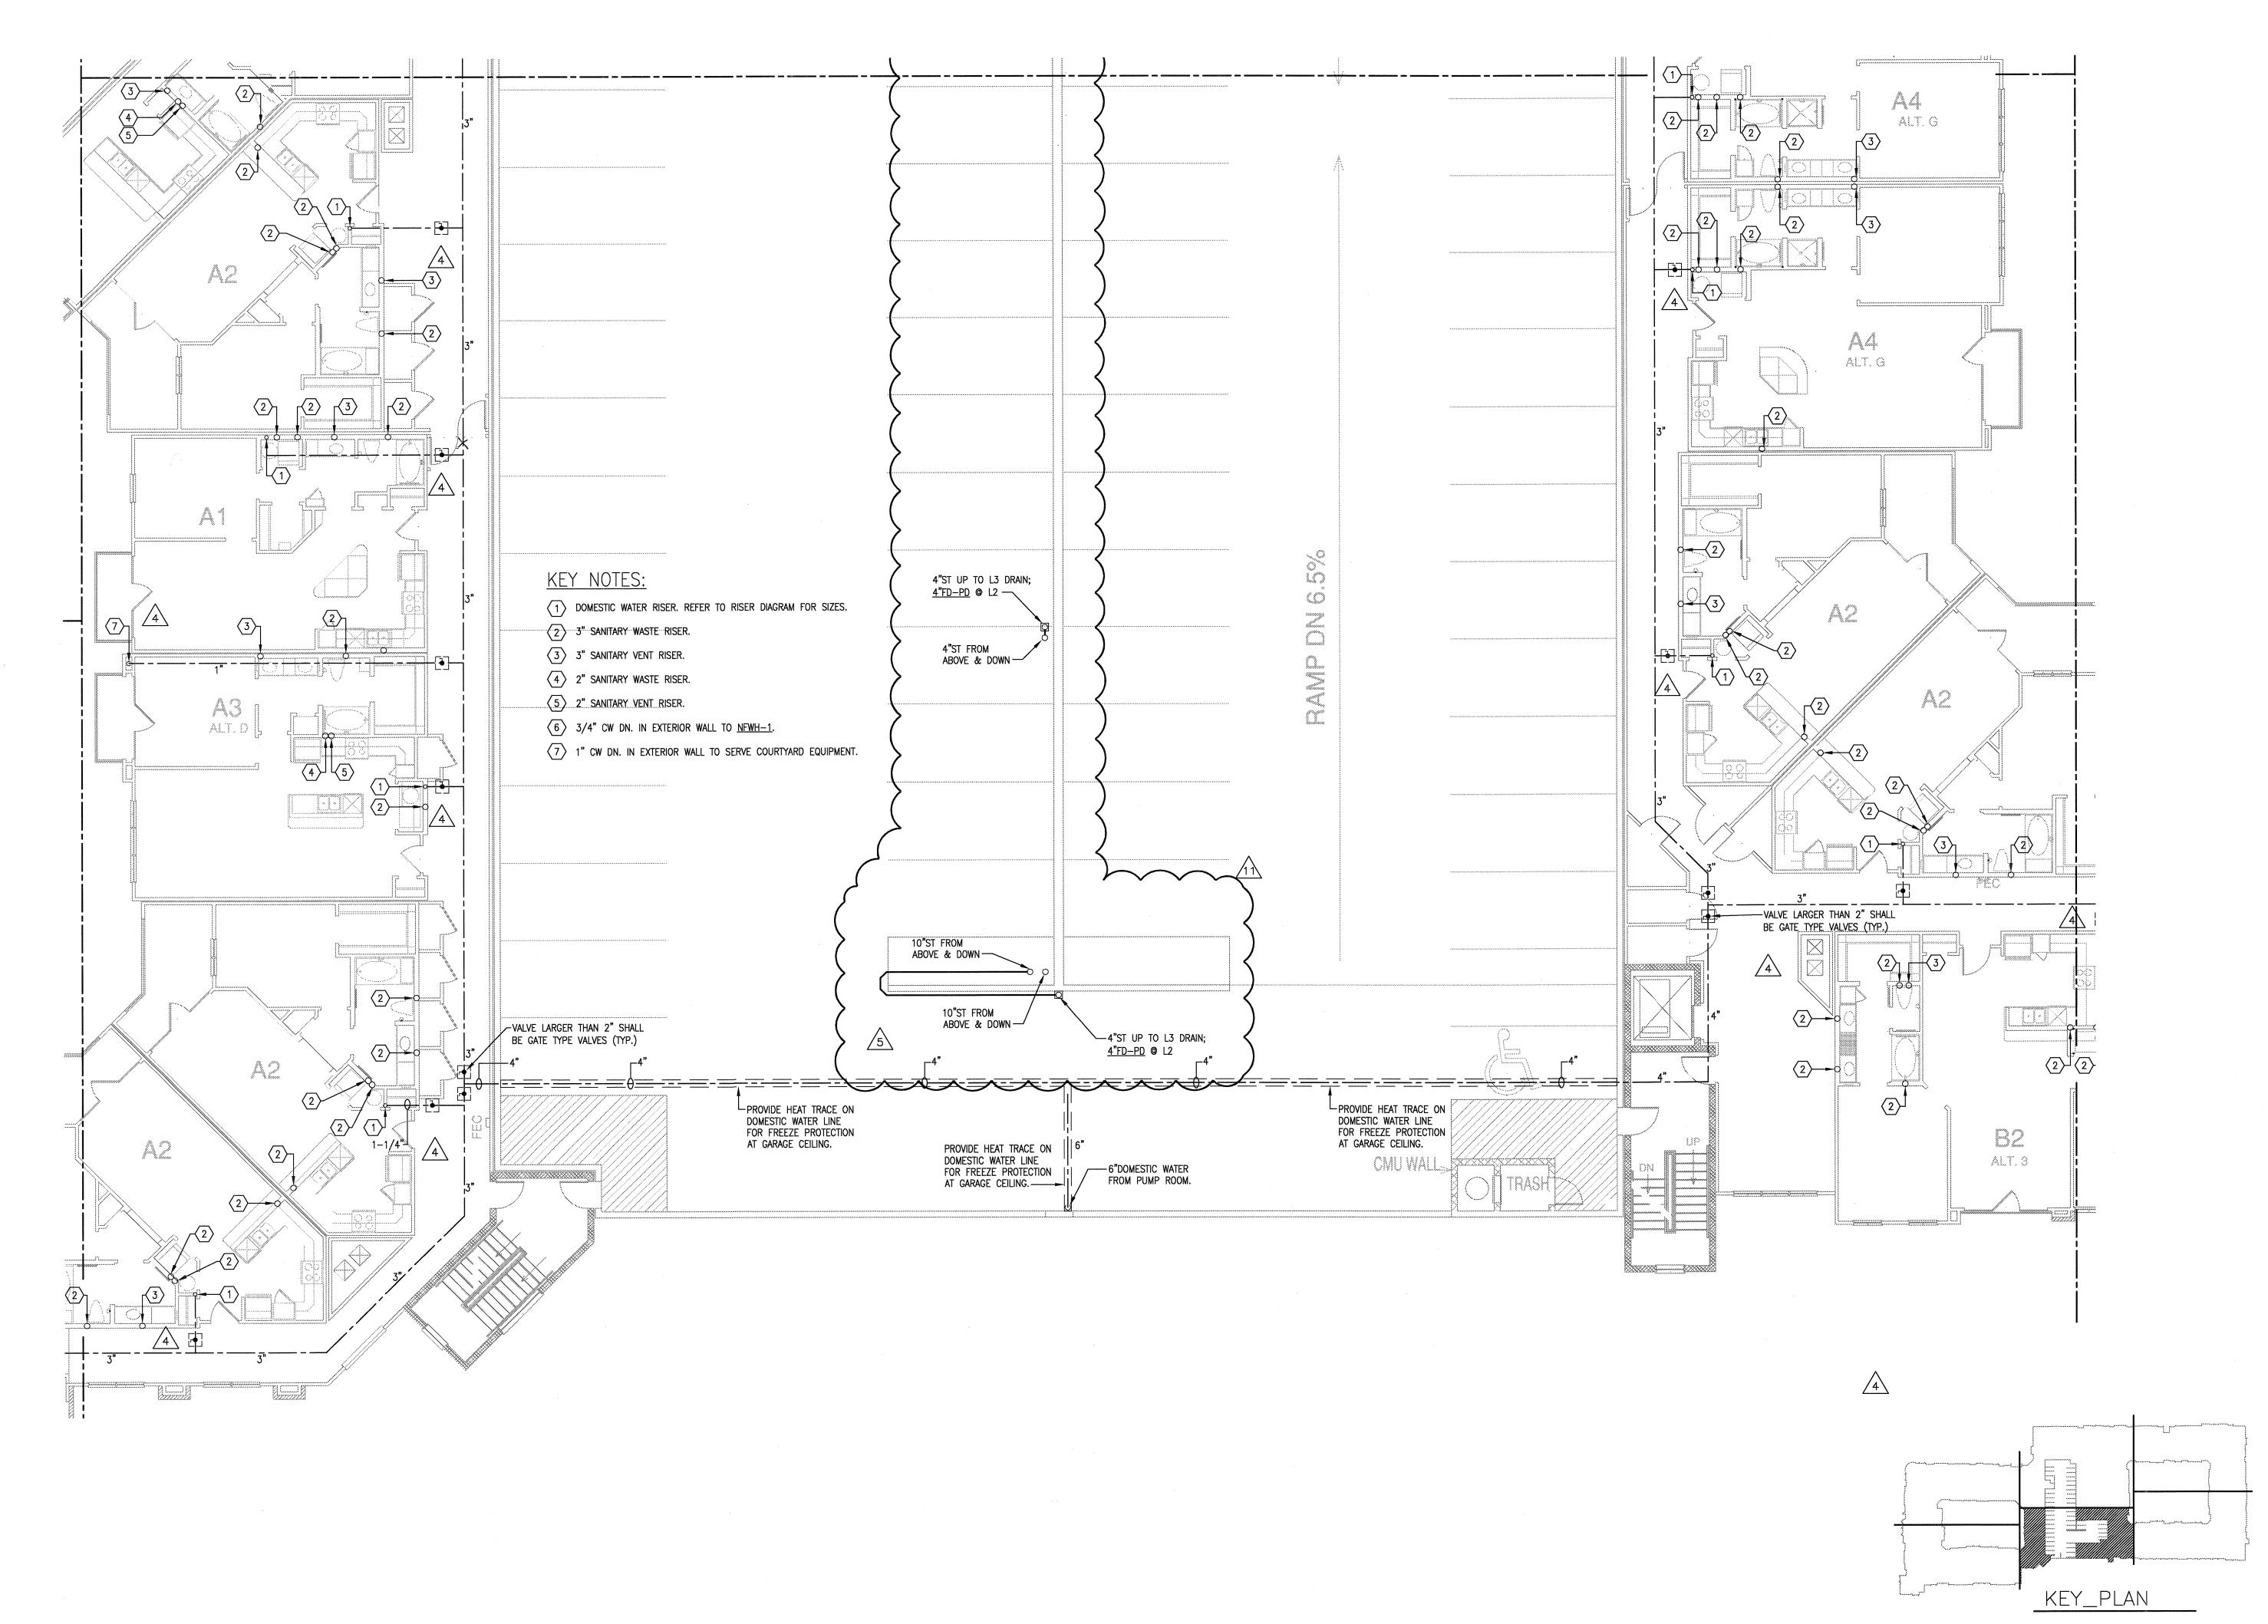

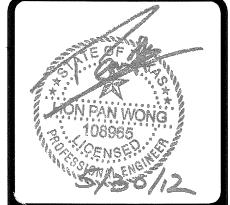

1 9-2-2011 DESIGN REVISIONS
2 9-13-2011 ANSI/FHA COMMENTS DESIGN REVISIONS
3 9-23-2011 REVISIONS
4 10-17-2011 CONSTRUCTION ISSUE DESIGN REVISIONS
6 1-17-2012 DESIGN REVISIONS
7 2-15-2012 REVISIONS
8 3-27-2012 REVISIONS
REVISIONS
REVISIONS
REVISIONS
REVISIONS
REVISIONS
REVISIONS

2 COORDINATION ON, TEXAS

コクワミアルのアコココン

5-15-2012 COORDINATION 5-30-2012 SITE COORDINATION

BGO architects

4144 N. Central Expy.

4144 N. Central Expy. Suite 855 Dallas, TX 75204 214.520.8878 bgoarchitects.com

08-05-

PROJECT 11129

SHEET NUMBER

P-3.2D

Jordan & Skala Engineers

Texas Firm Registration # F-4990


17855 N. Dallas Parkway, Suite 320 Dallas, FX 75287-6857 ; (469) 385-1616 Webryow, jordanskala, c


Checked By: RC


Project Number - 113-0355 Drawn By: CV

DIVISION 'D' SECOND FLOOR PLAN

SCALE: 1/8" = 1'-0"

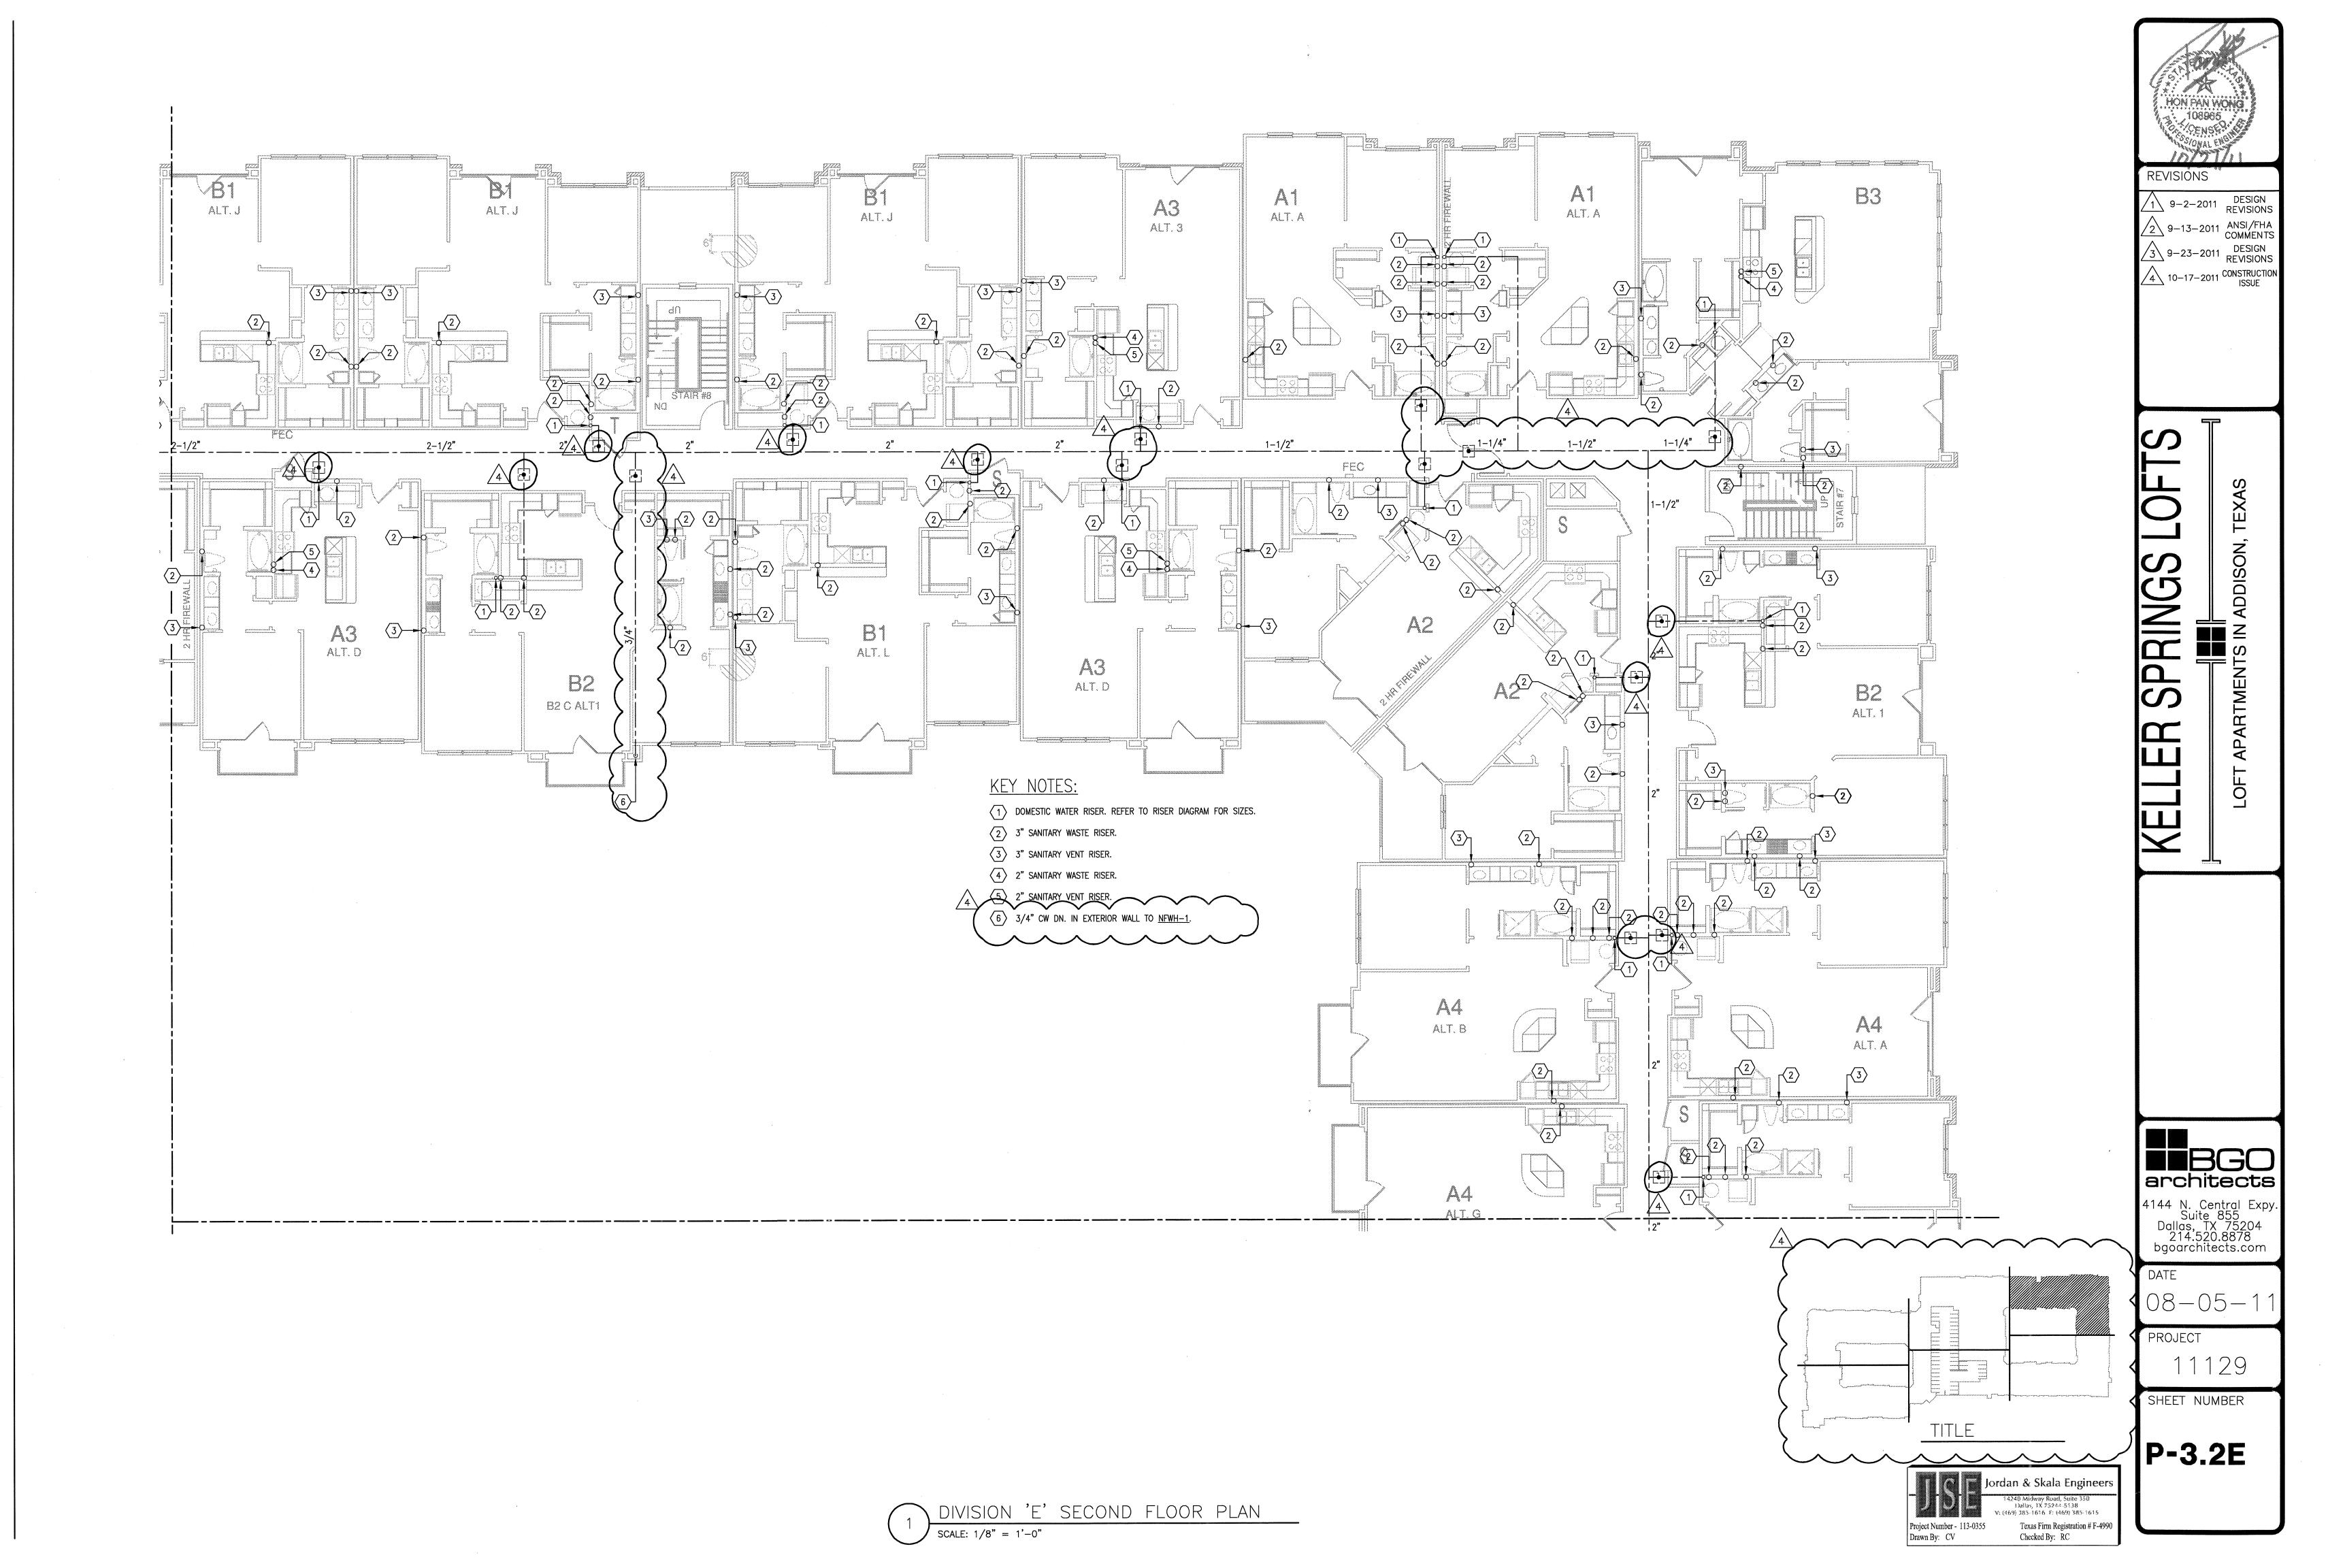


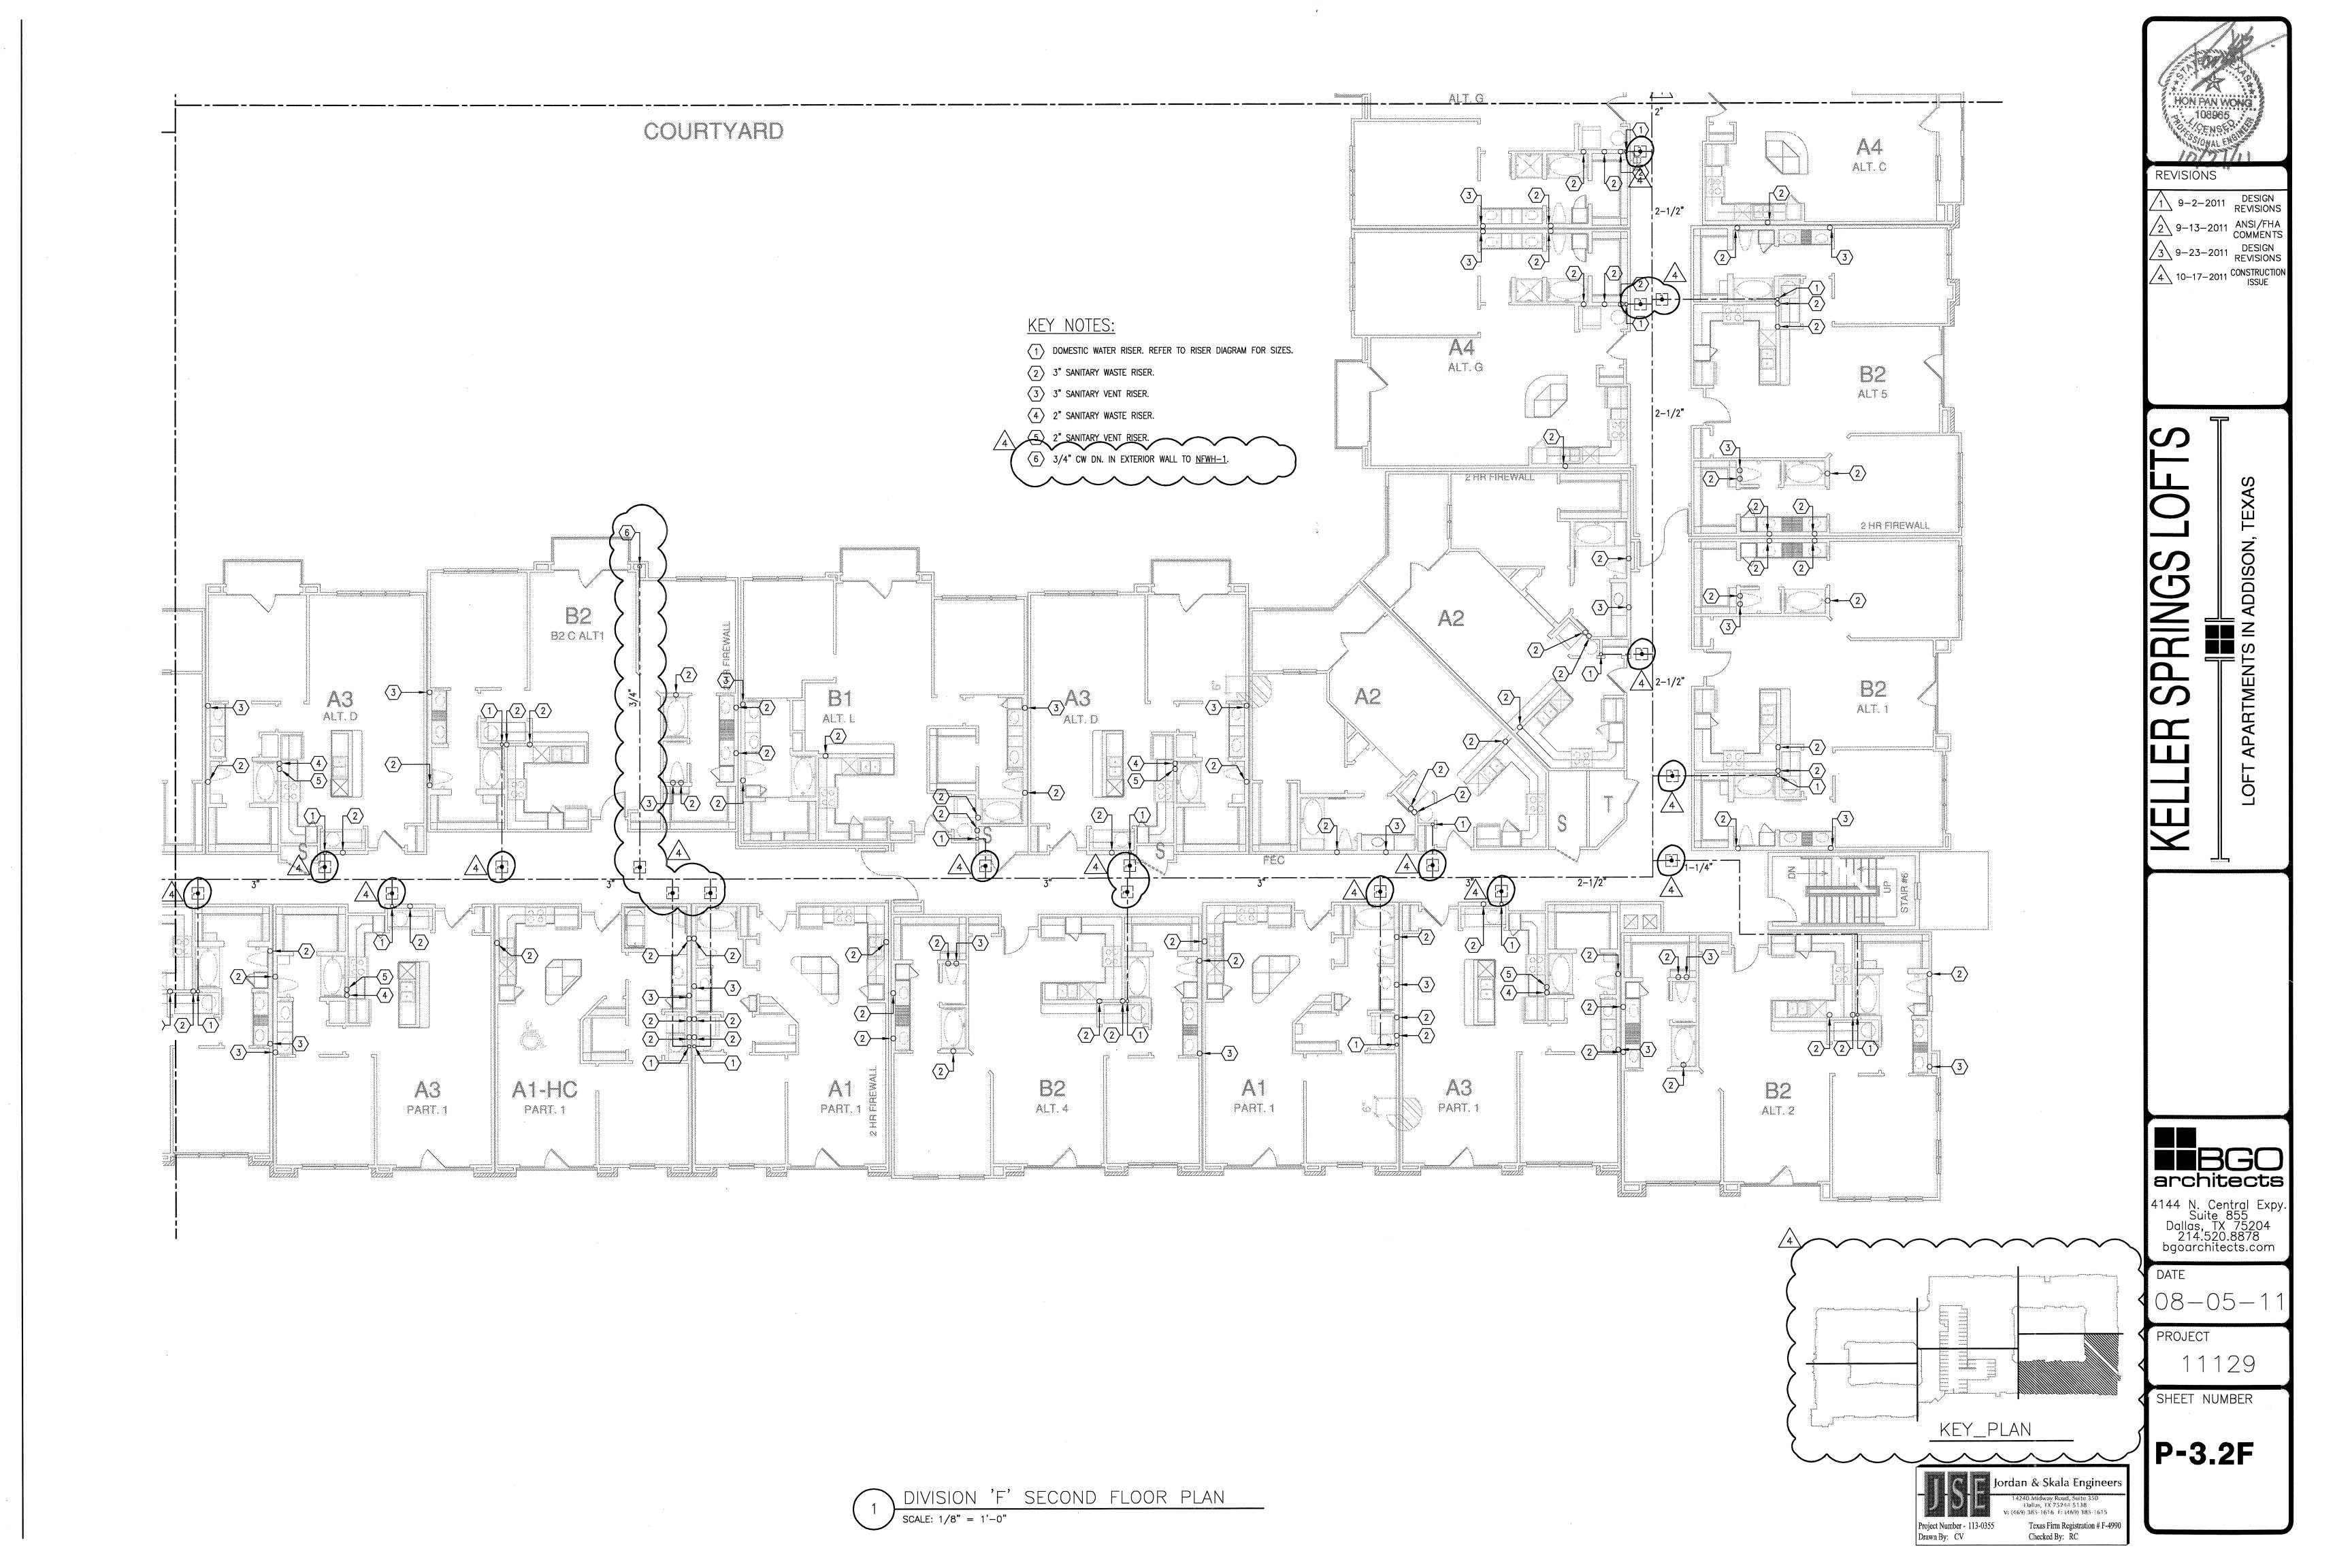


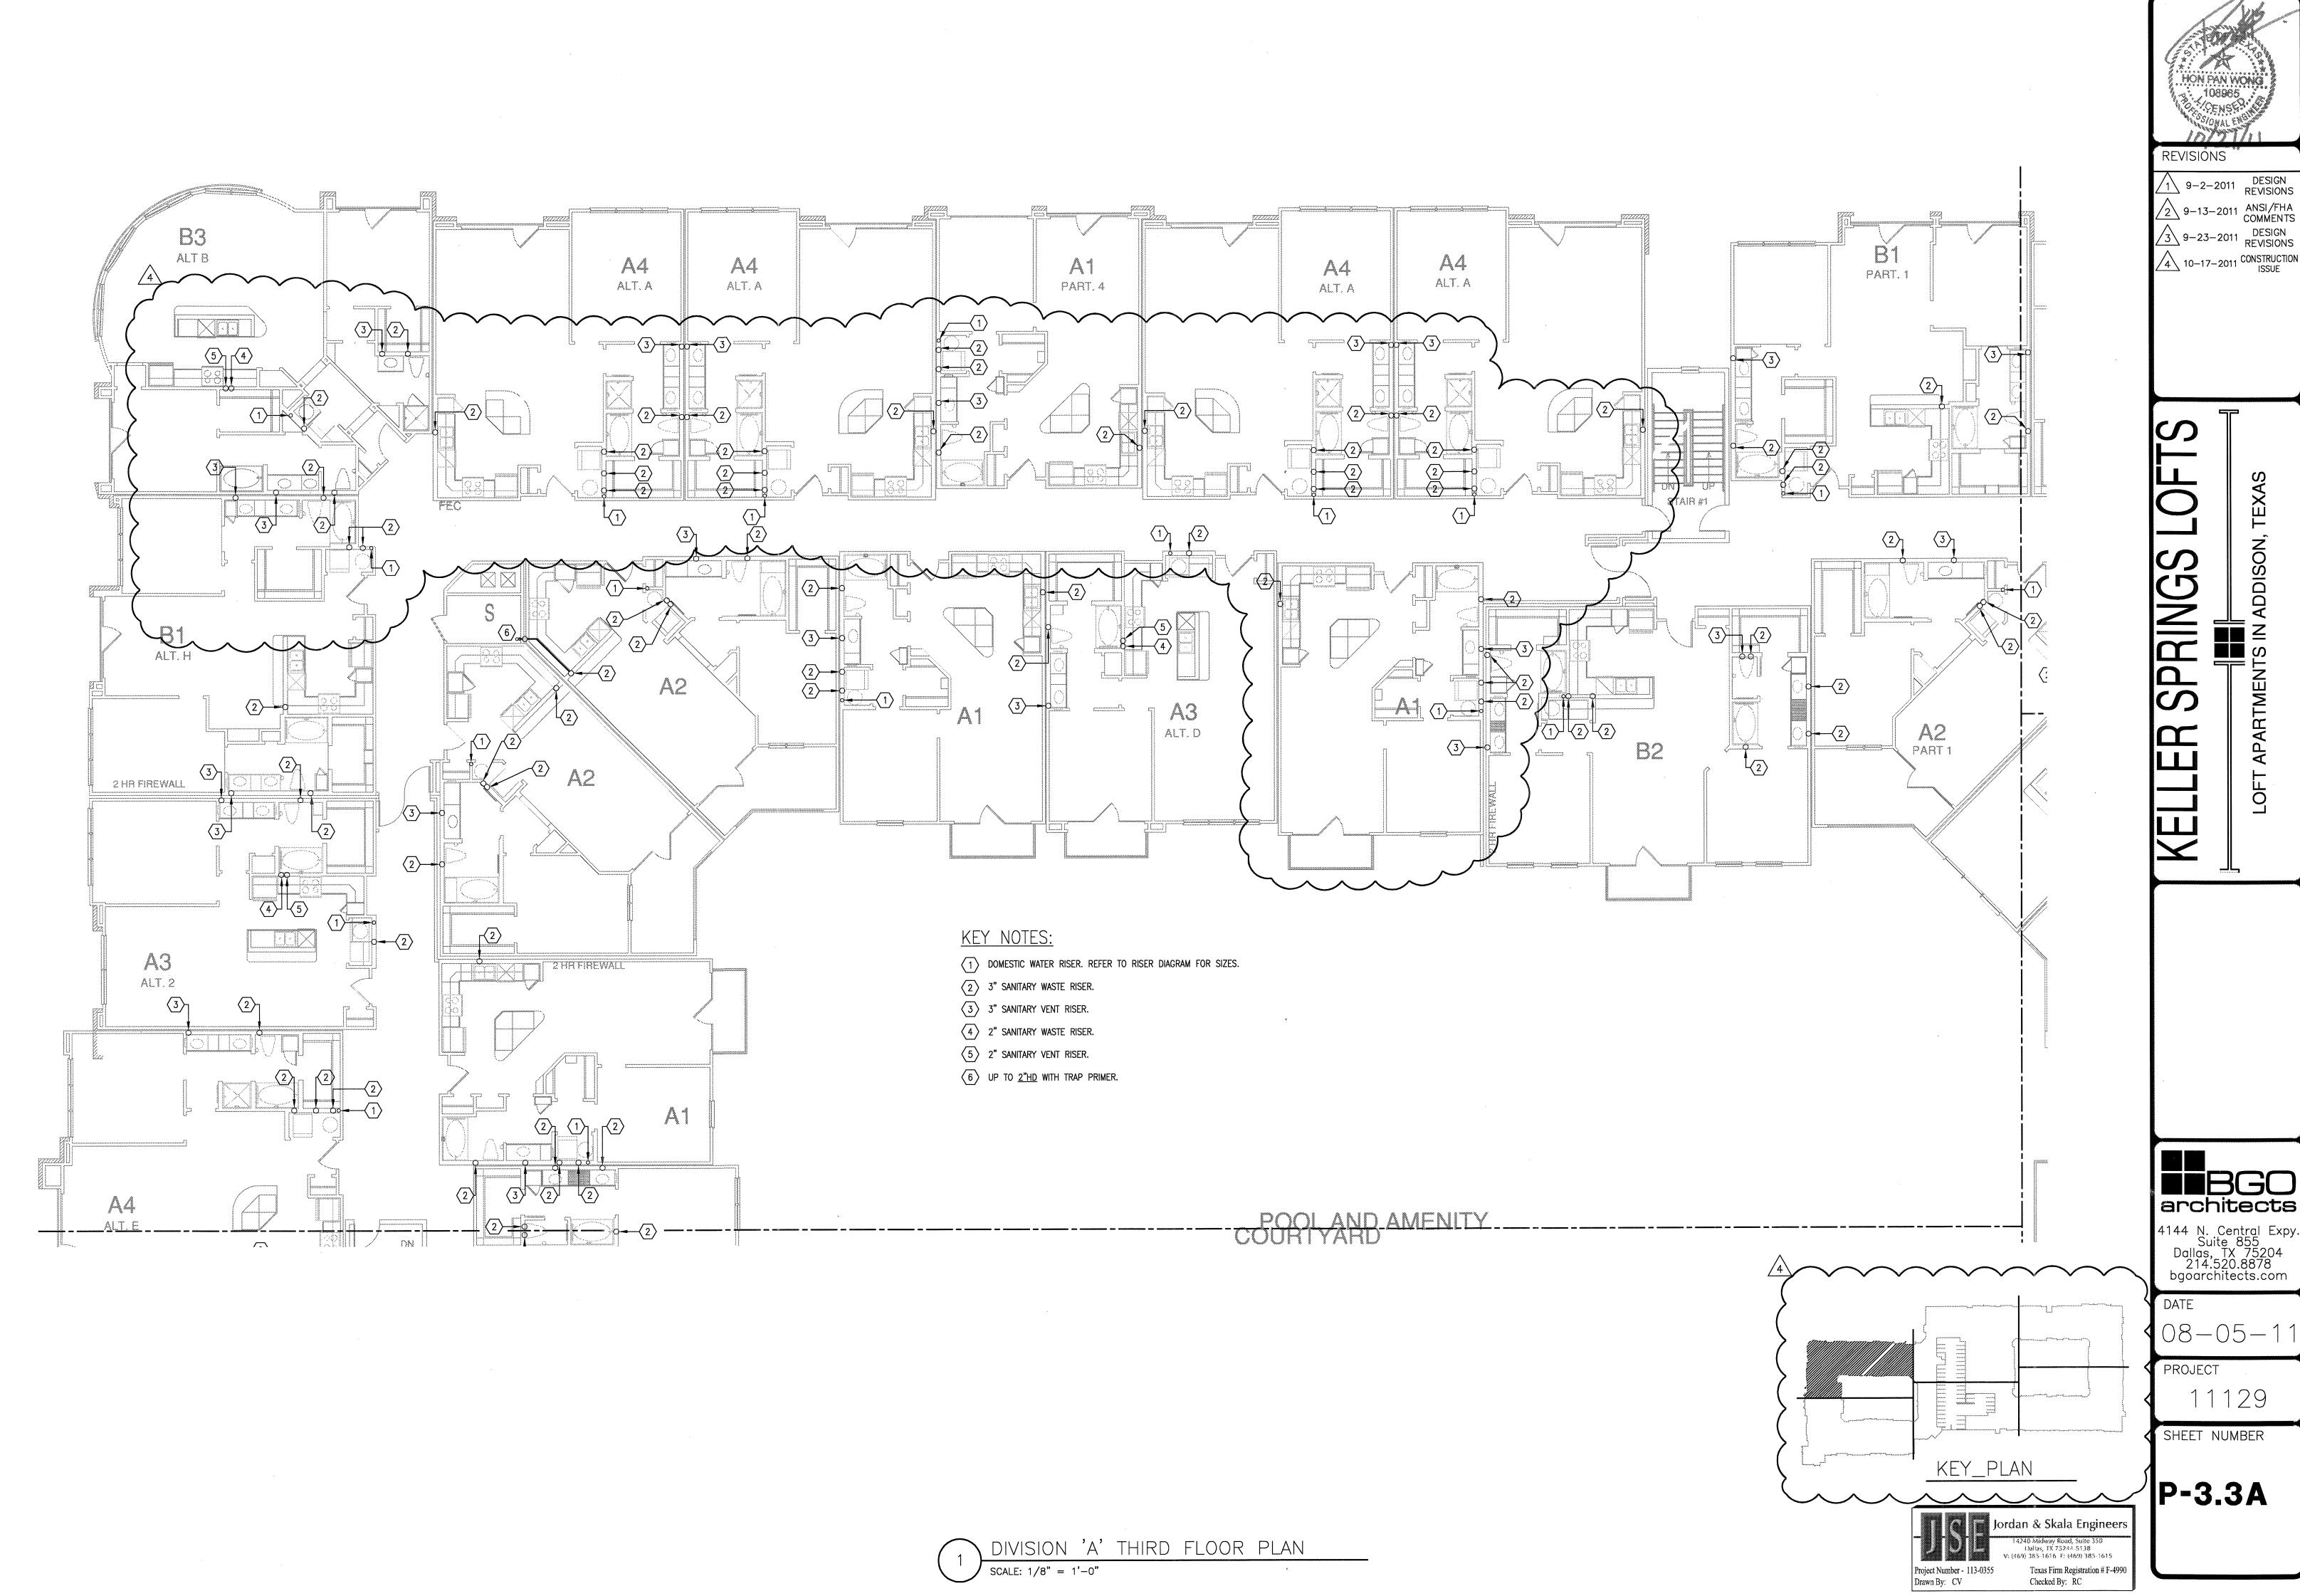



BBGO architects


4144 N. Central Expy. Suite 855 Dallas, TX 75204 214.520.8878 bgoarchitects.com

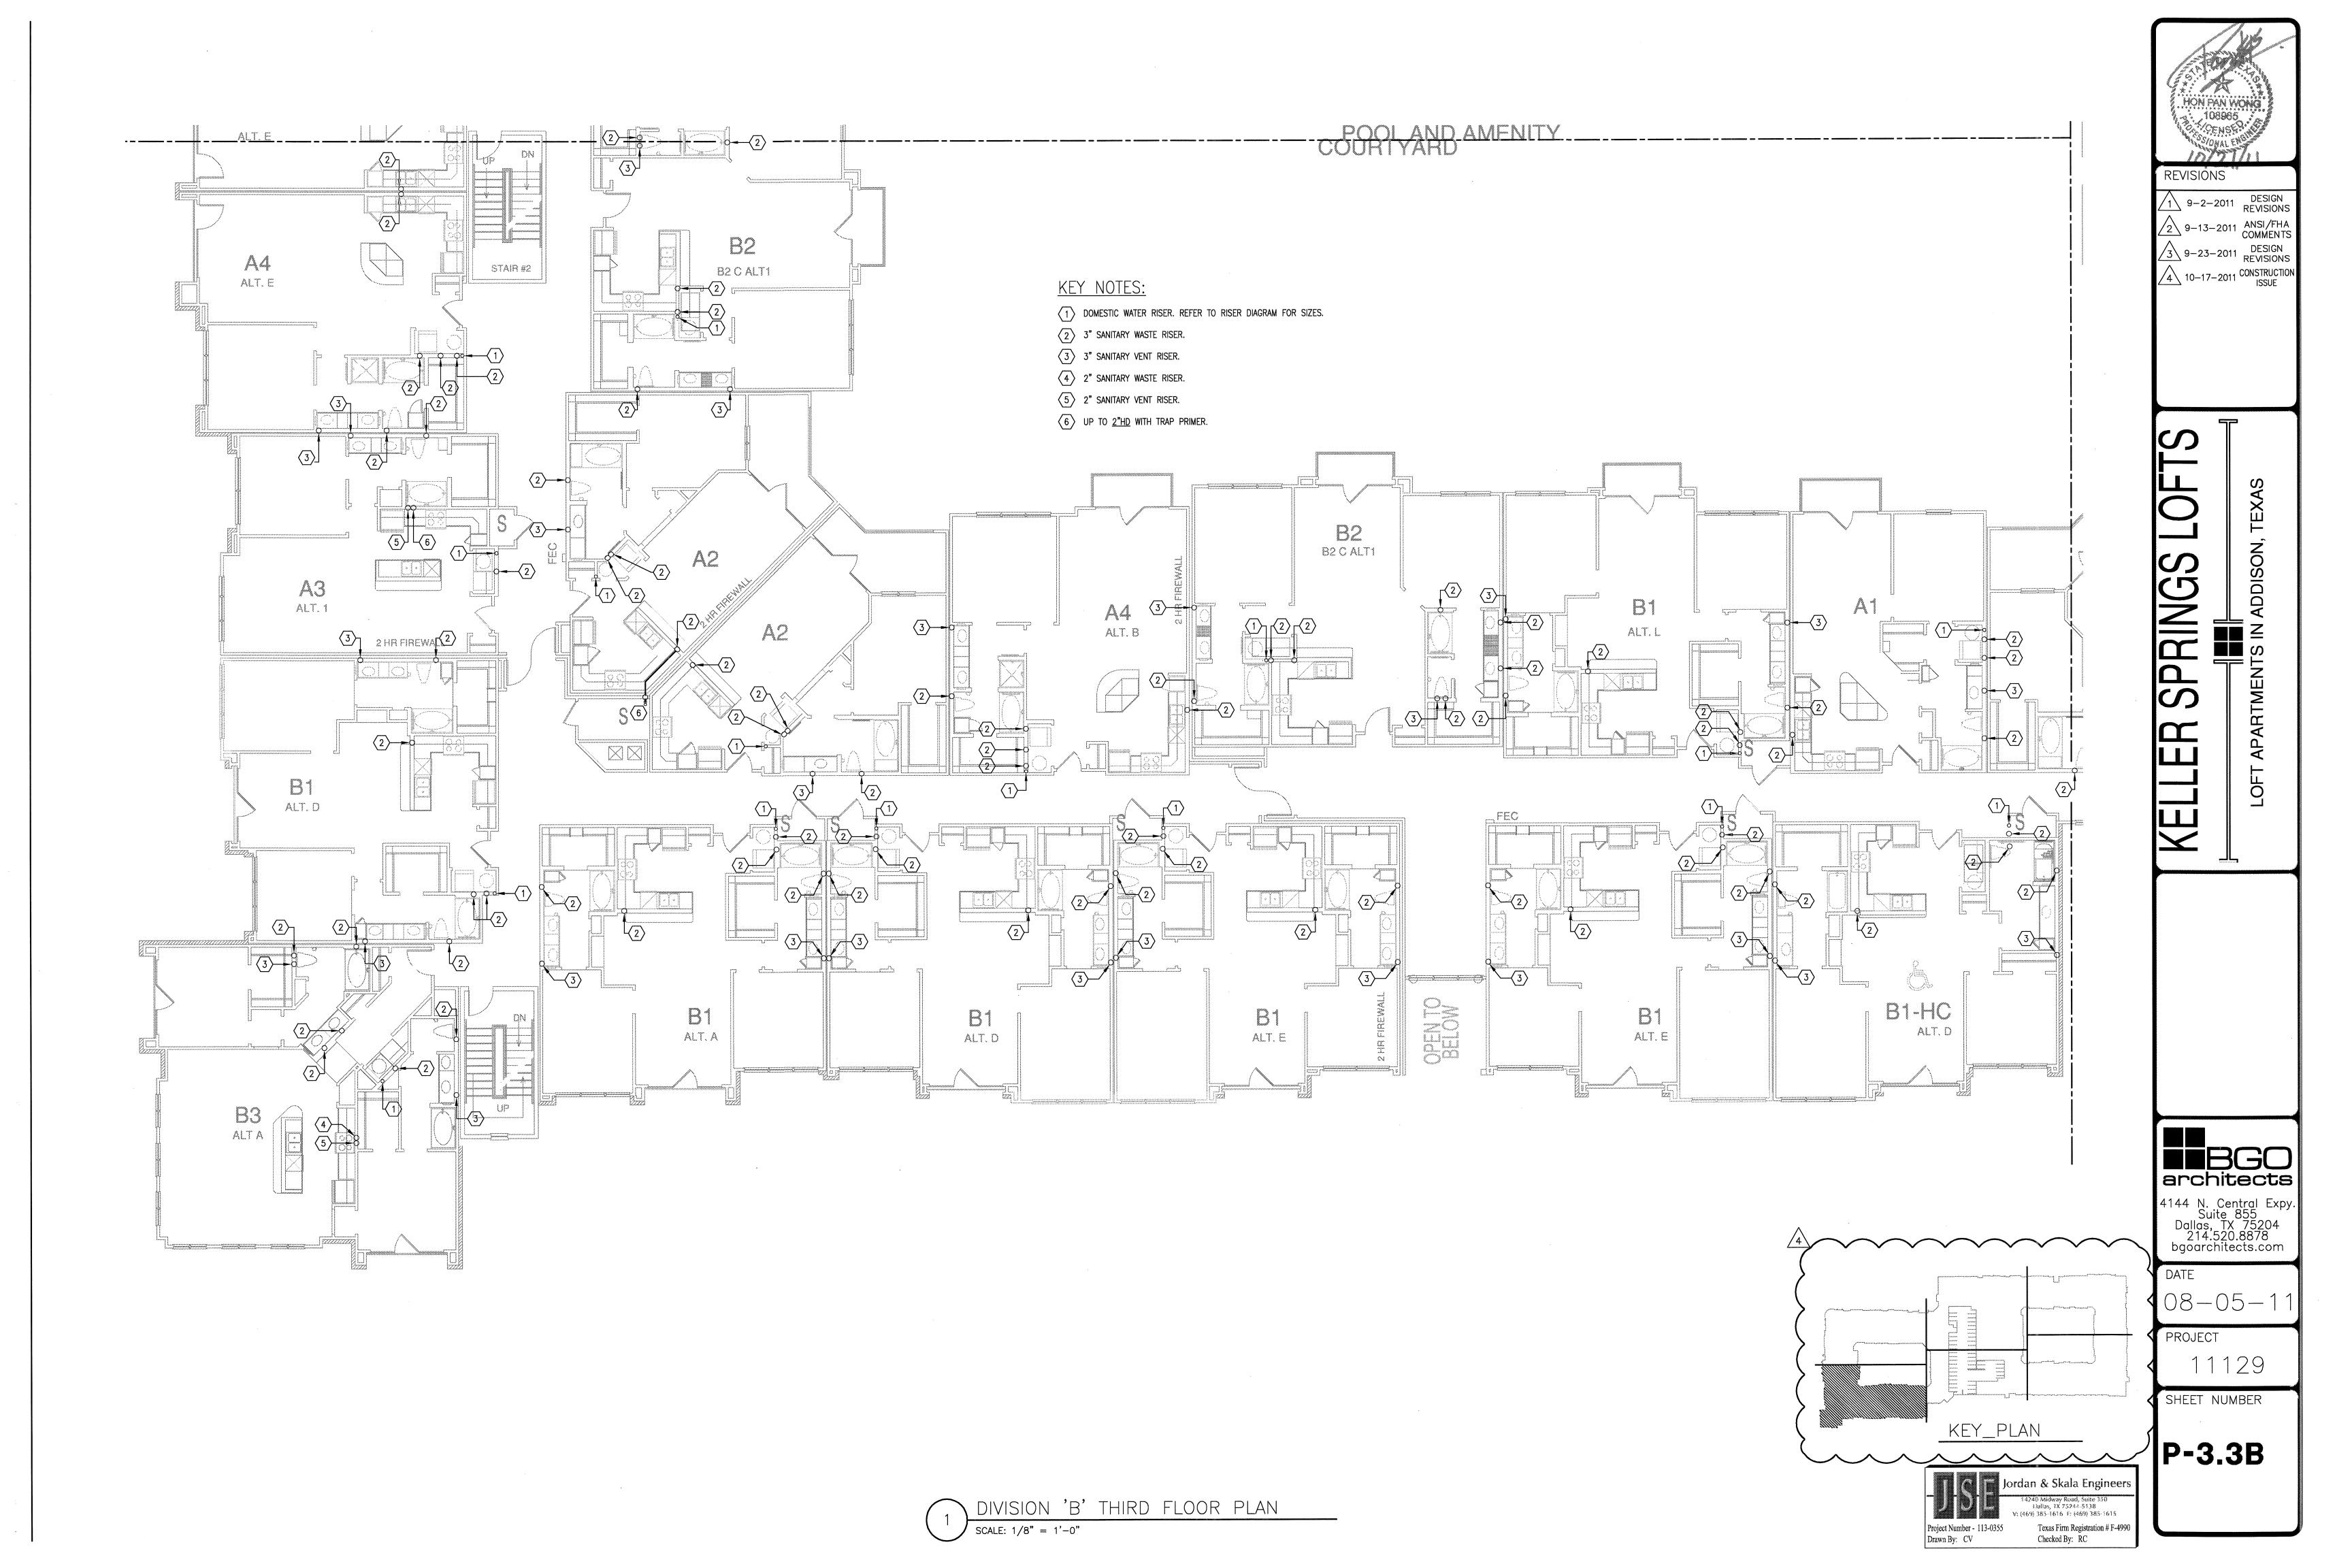

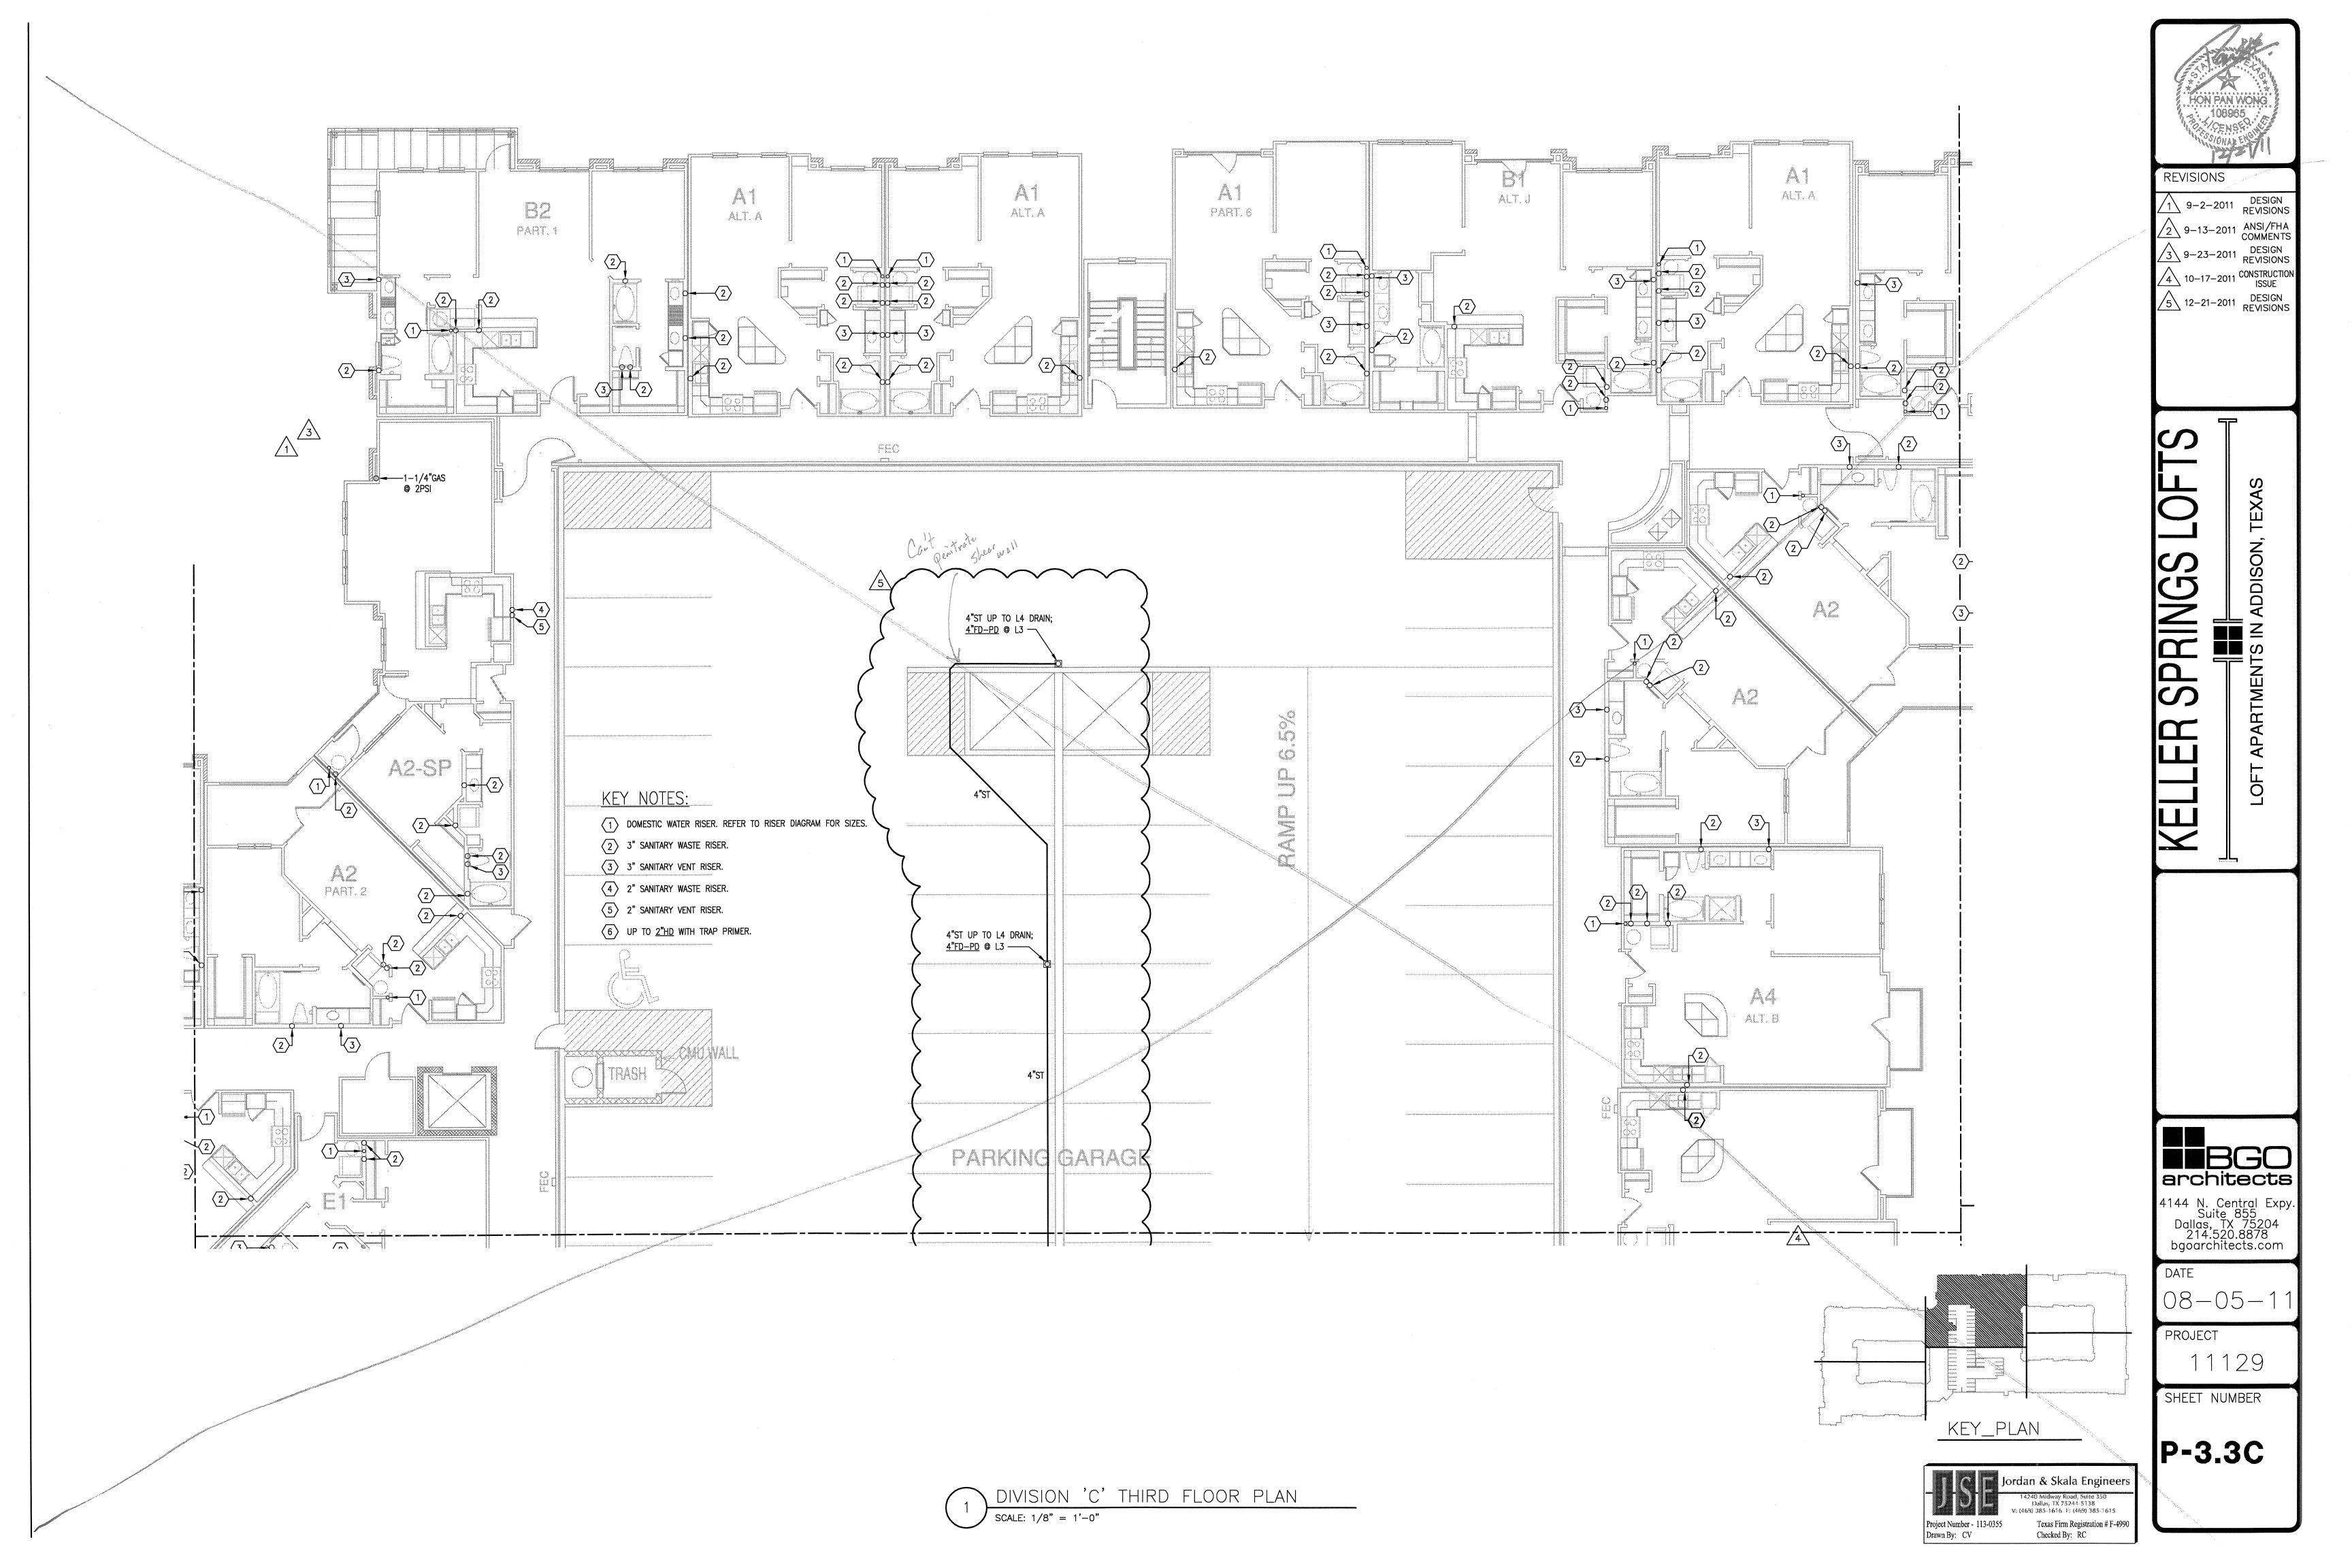


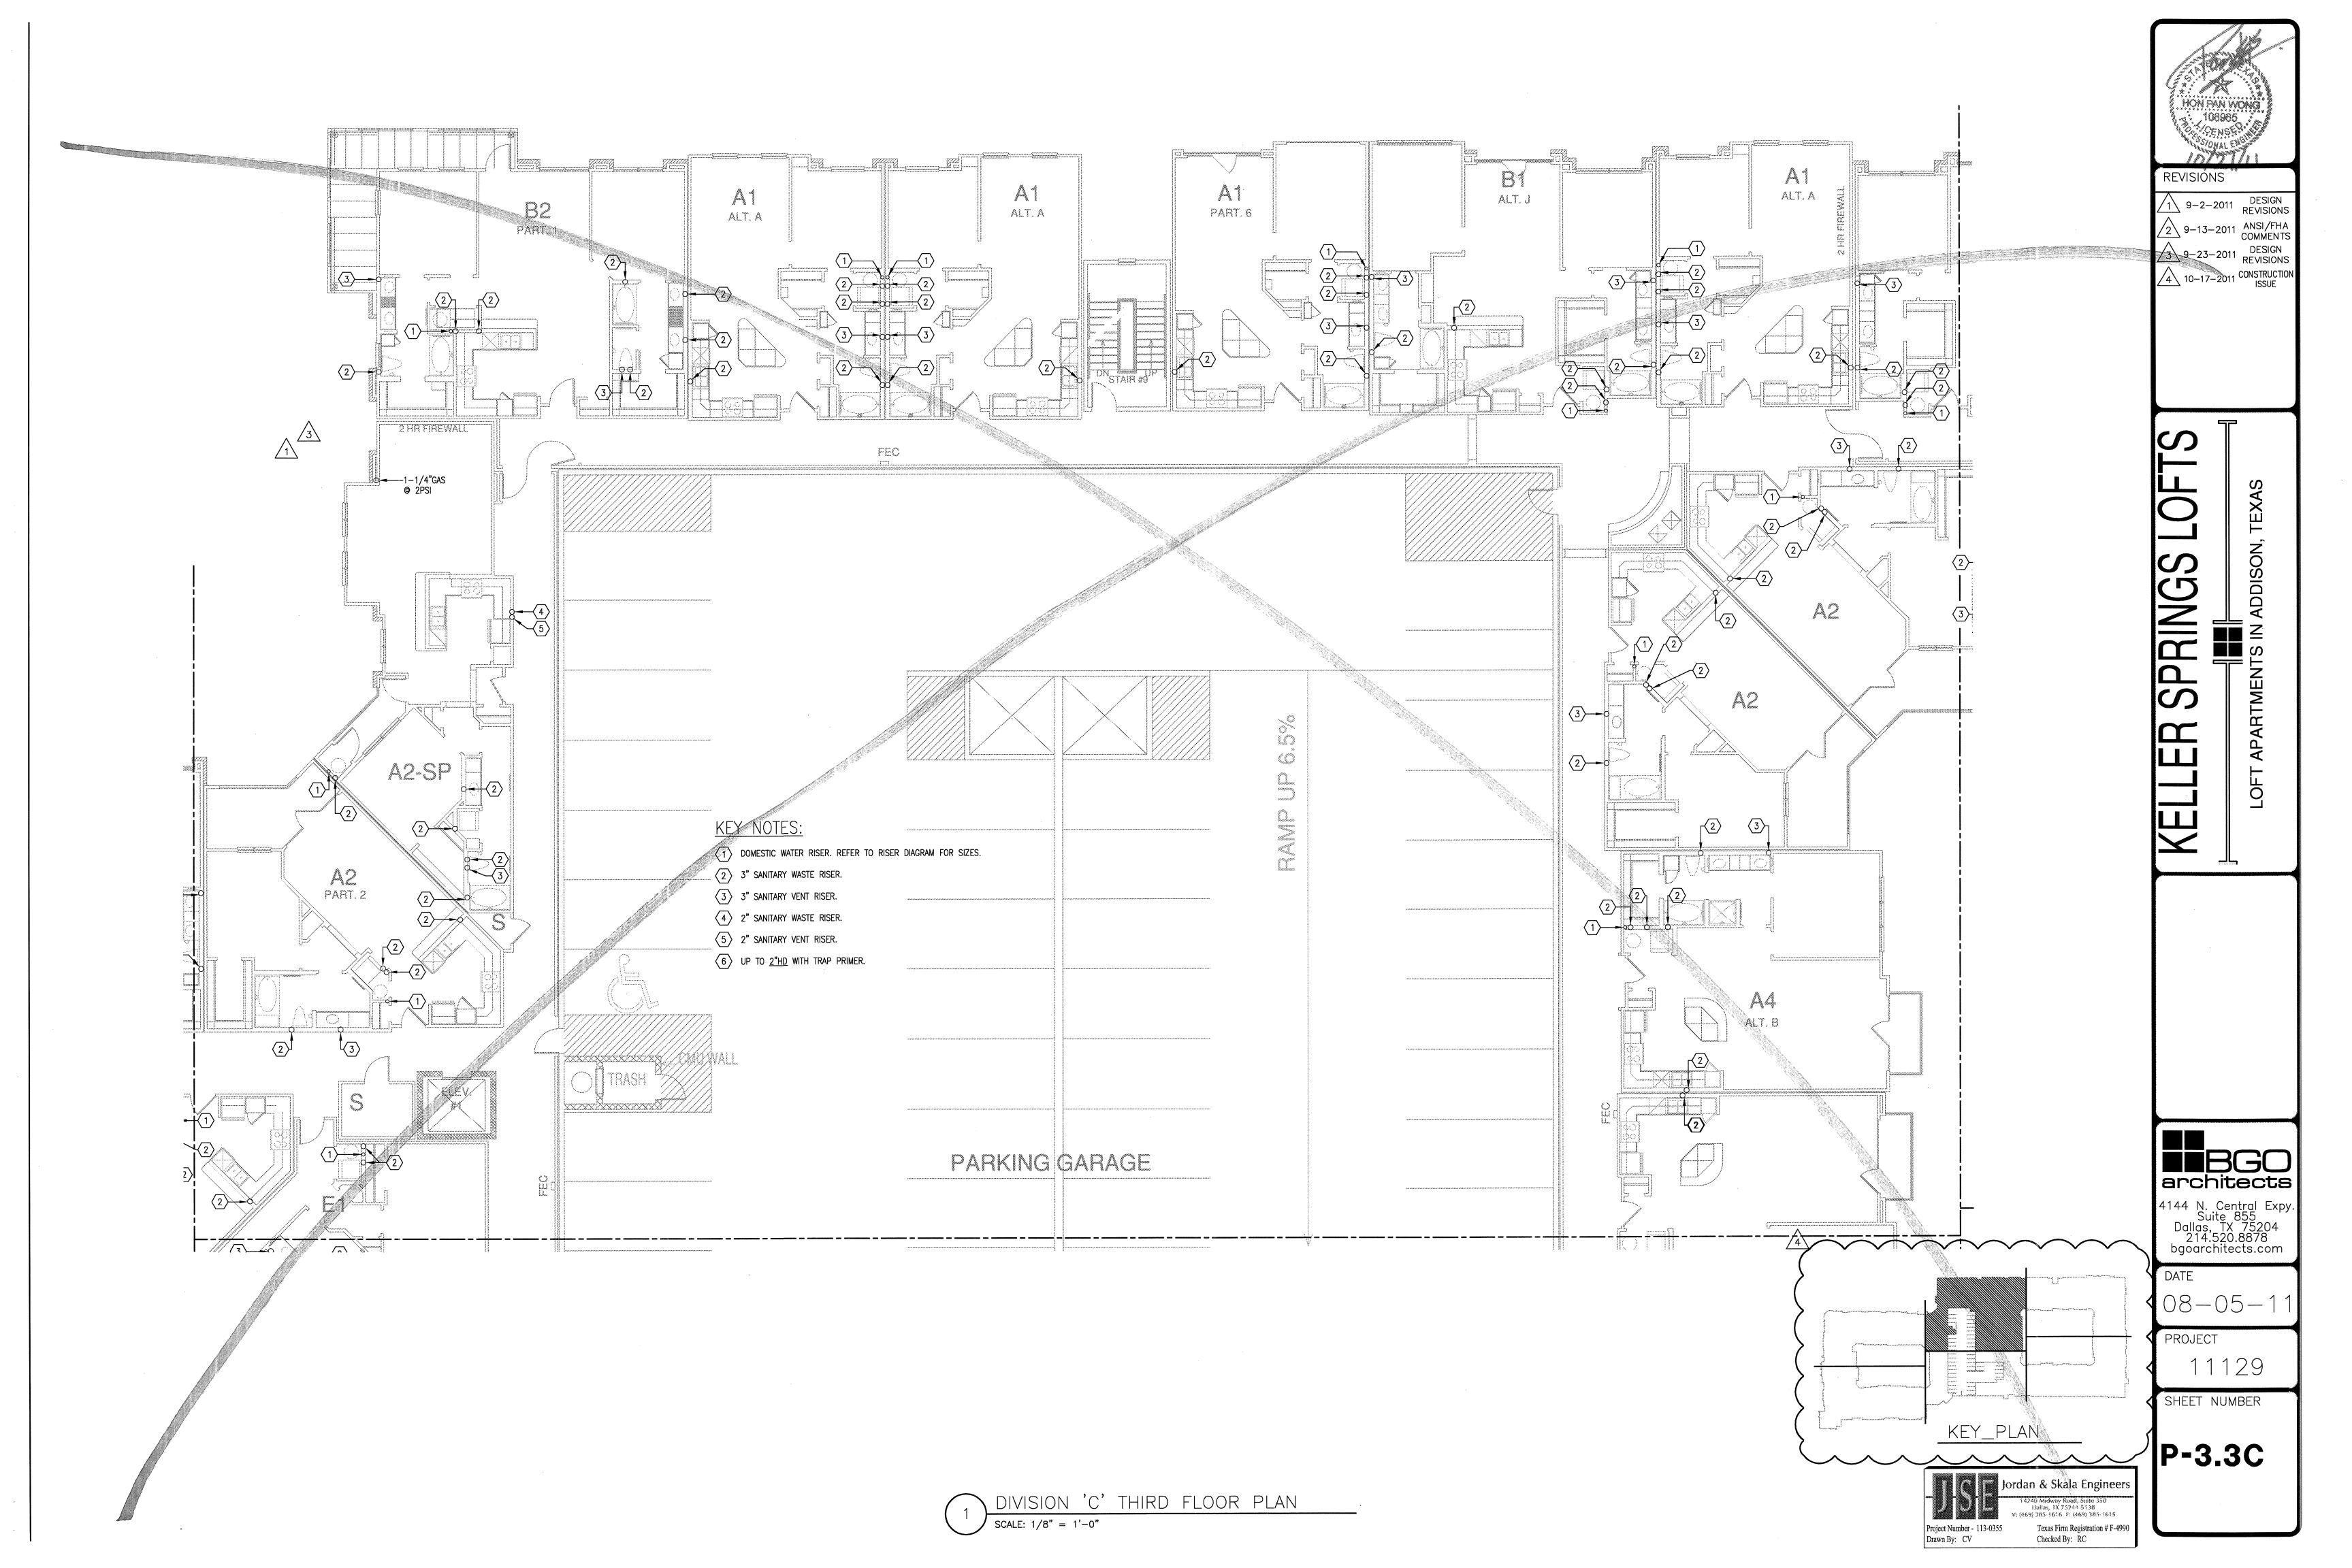

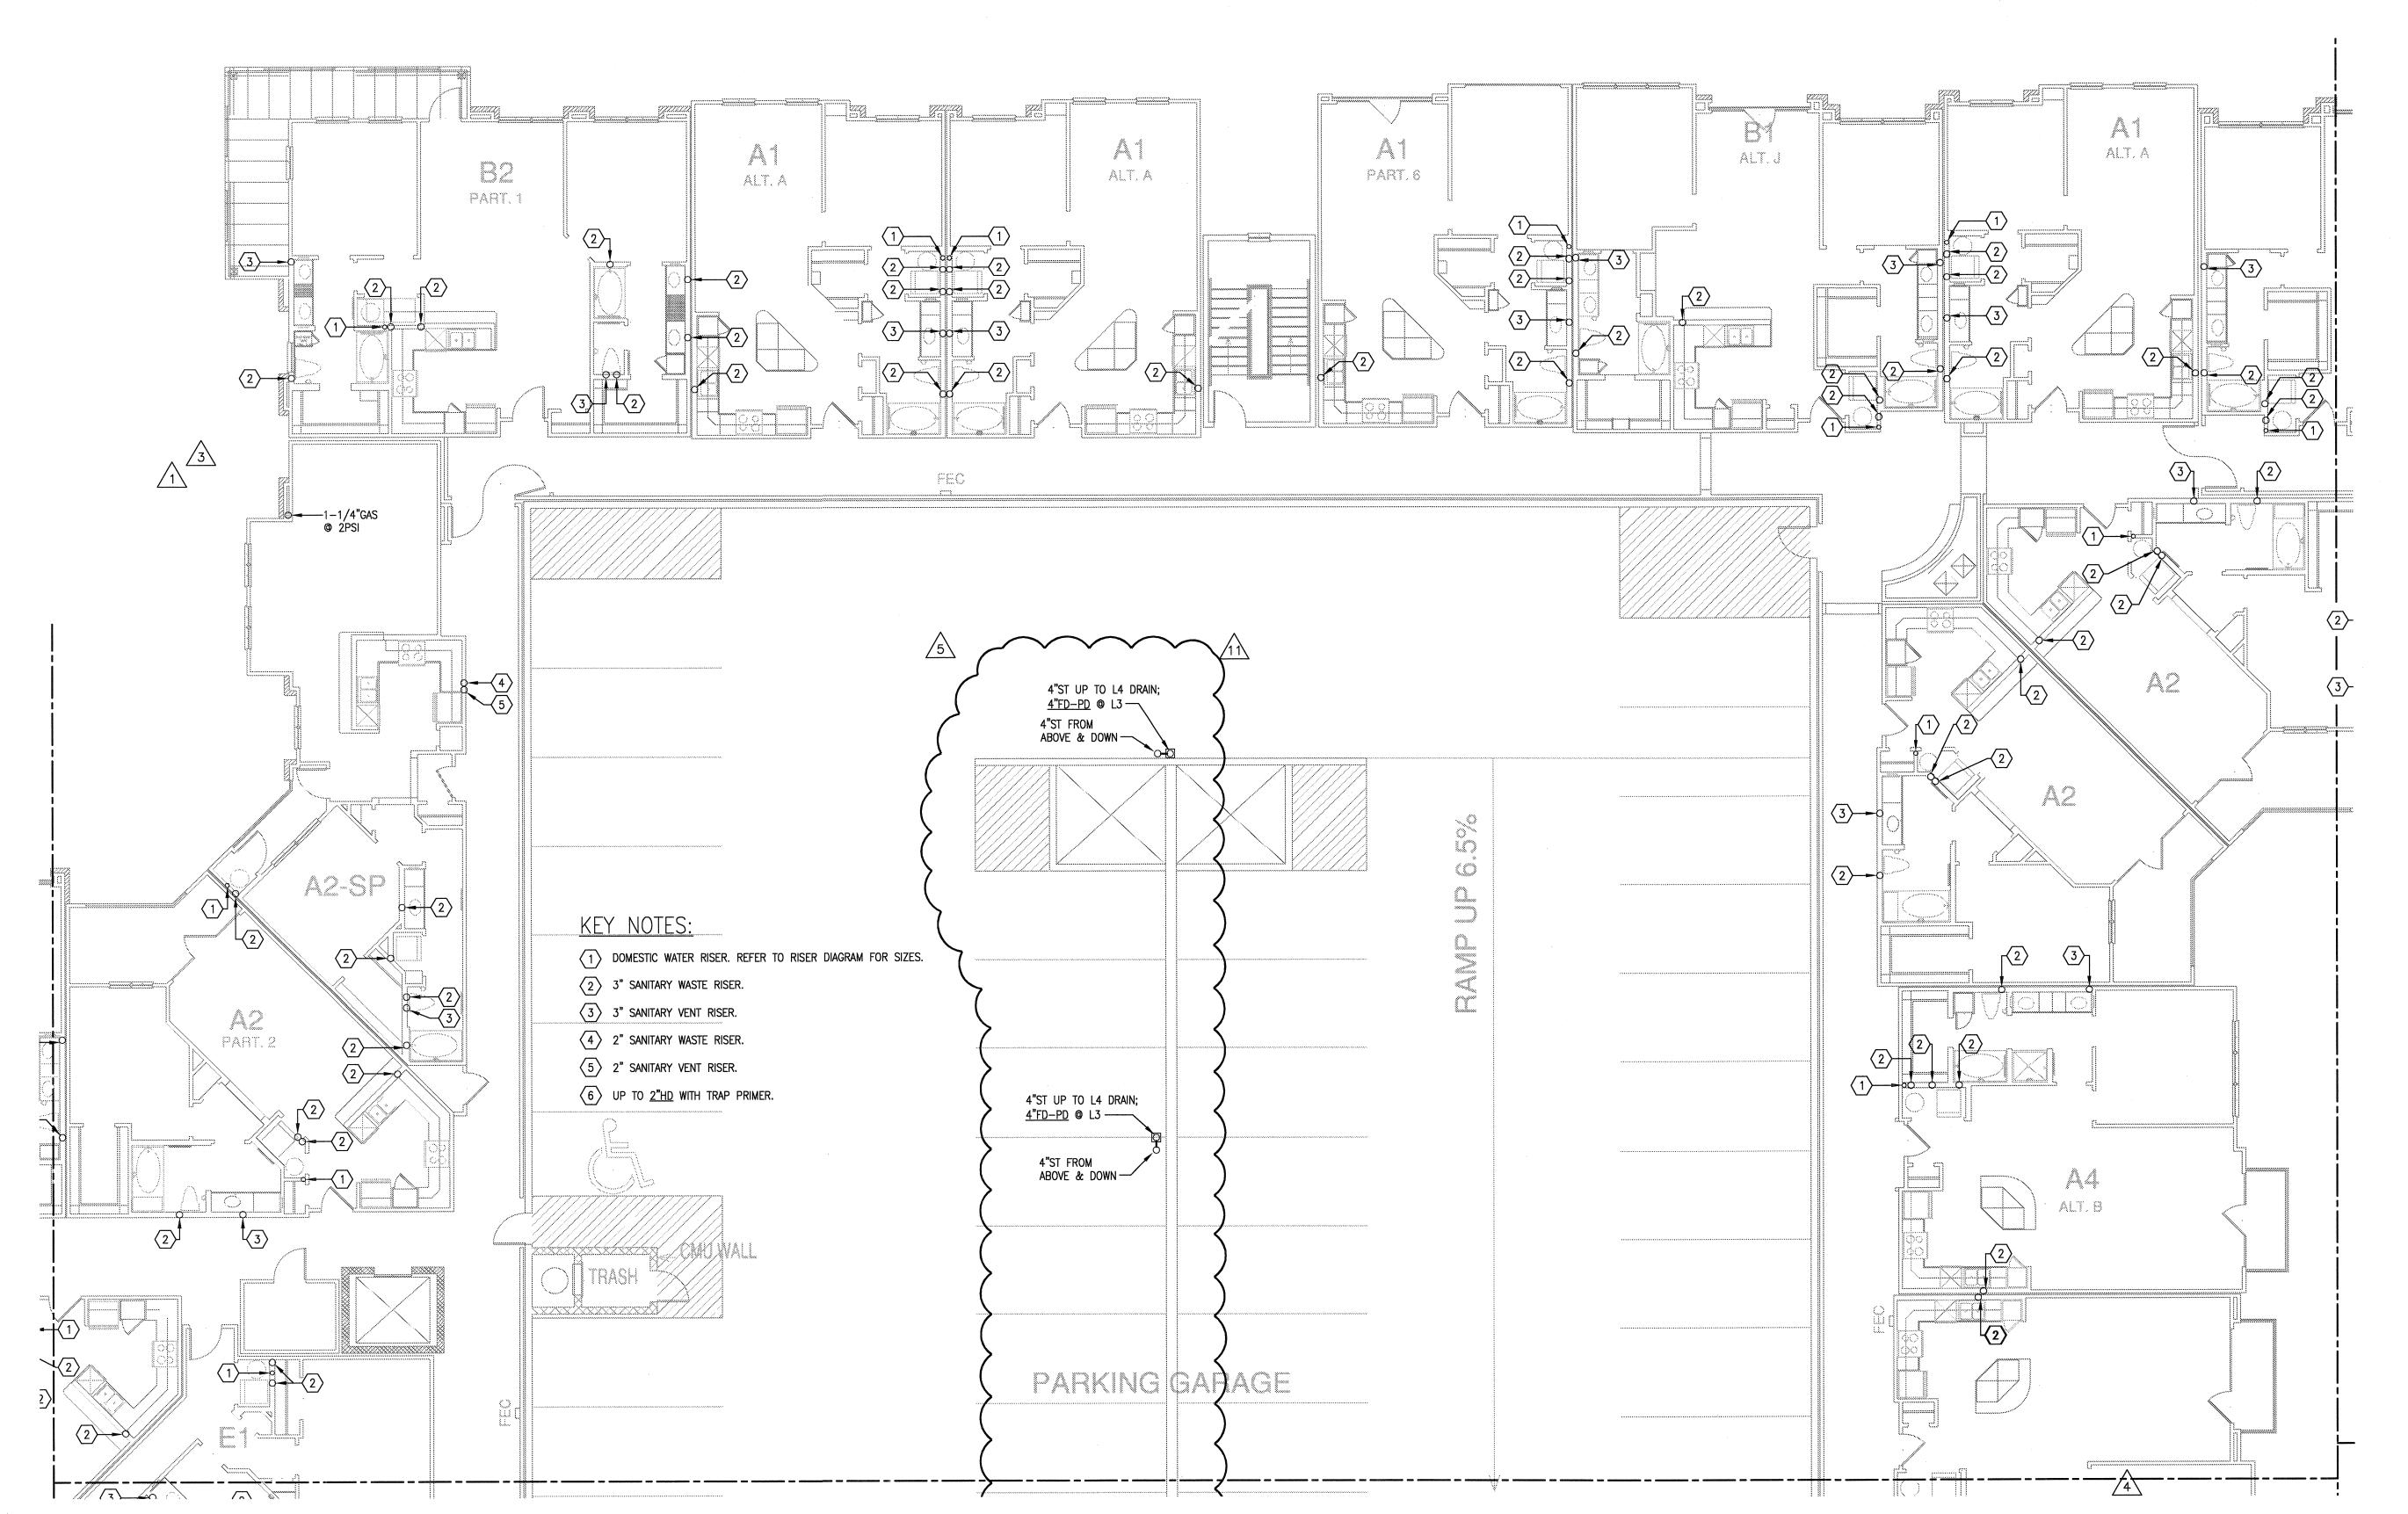

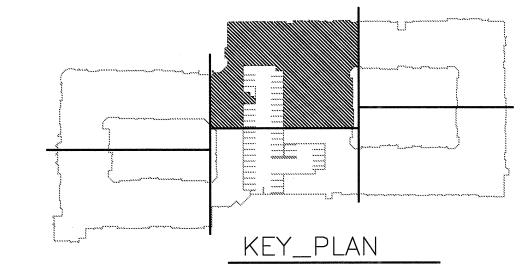



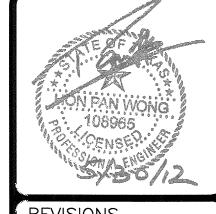

9-2-2011 DESIGN REVISIONS

9-13-2011 ANSI/FHA COMMENTS
DESIGN REVISIONS

10-17-2011 CONSTRUCTION ISSUE
DESIGN REVISIONS

12-21-2011 DESIGN REVISIONS

12-21-2011 DESIGN REVISIONS
TRANSFORMER
2-15-2012 REVISIONS

3-27-2012 CLUBHOUSE REVISIONS
4-17-2012 COORDINATION

T SPAINGS LOFIN

5-15-2012 COORDINATION 5-30-2012 SITE COORDINATION

BGO architects


4144 N. Central Expy. Suite 855 Dallas, TX 75204 214.520.8878 bgoarchitects.com


DATE 08-05-11


PROJECT 1112


SHEET NUMBER

P-3.3C

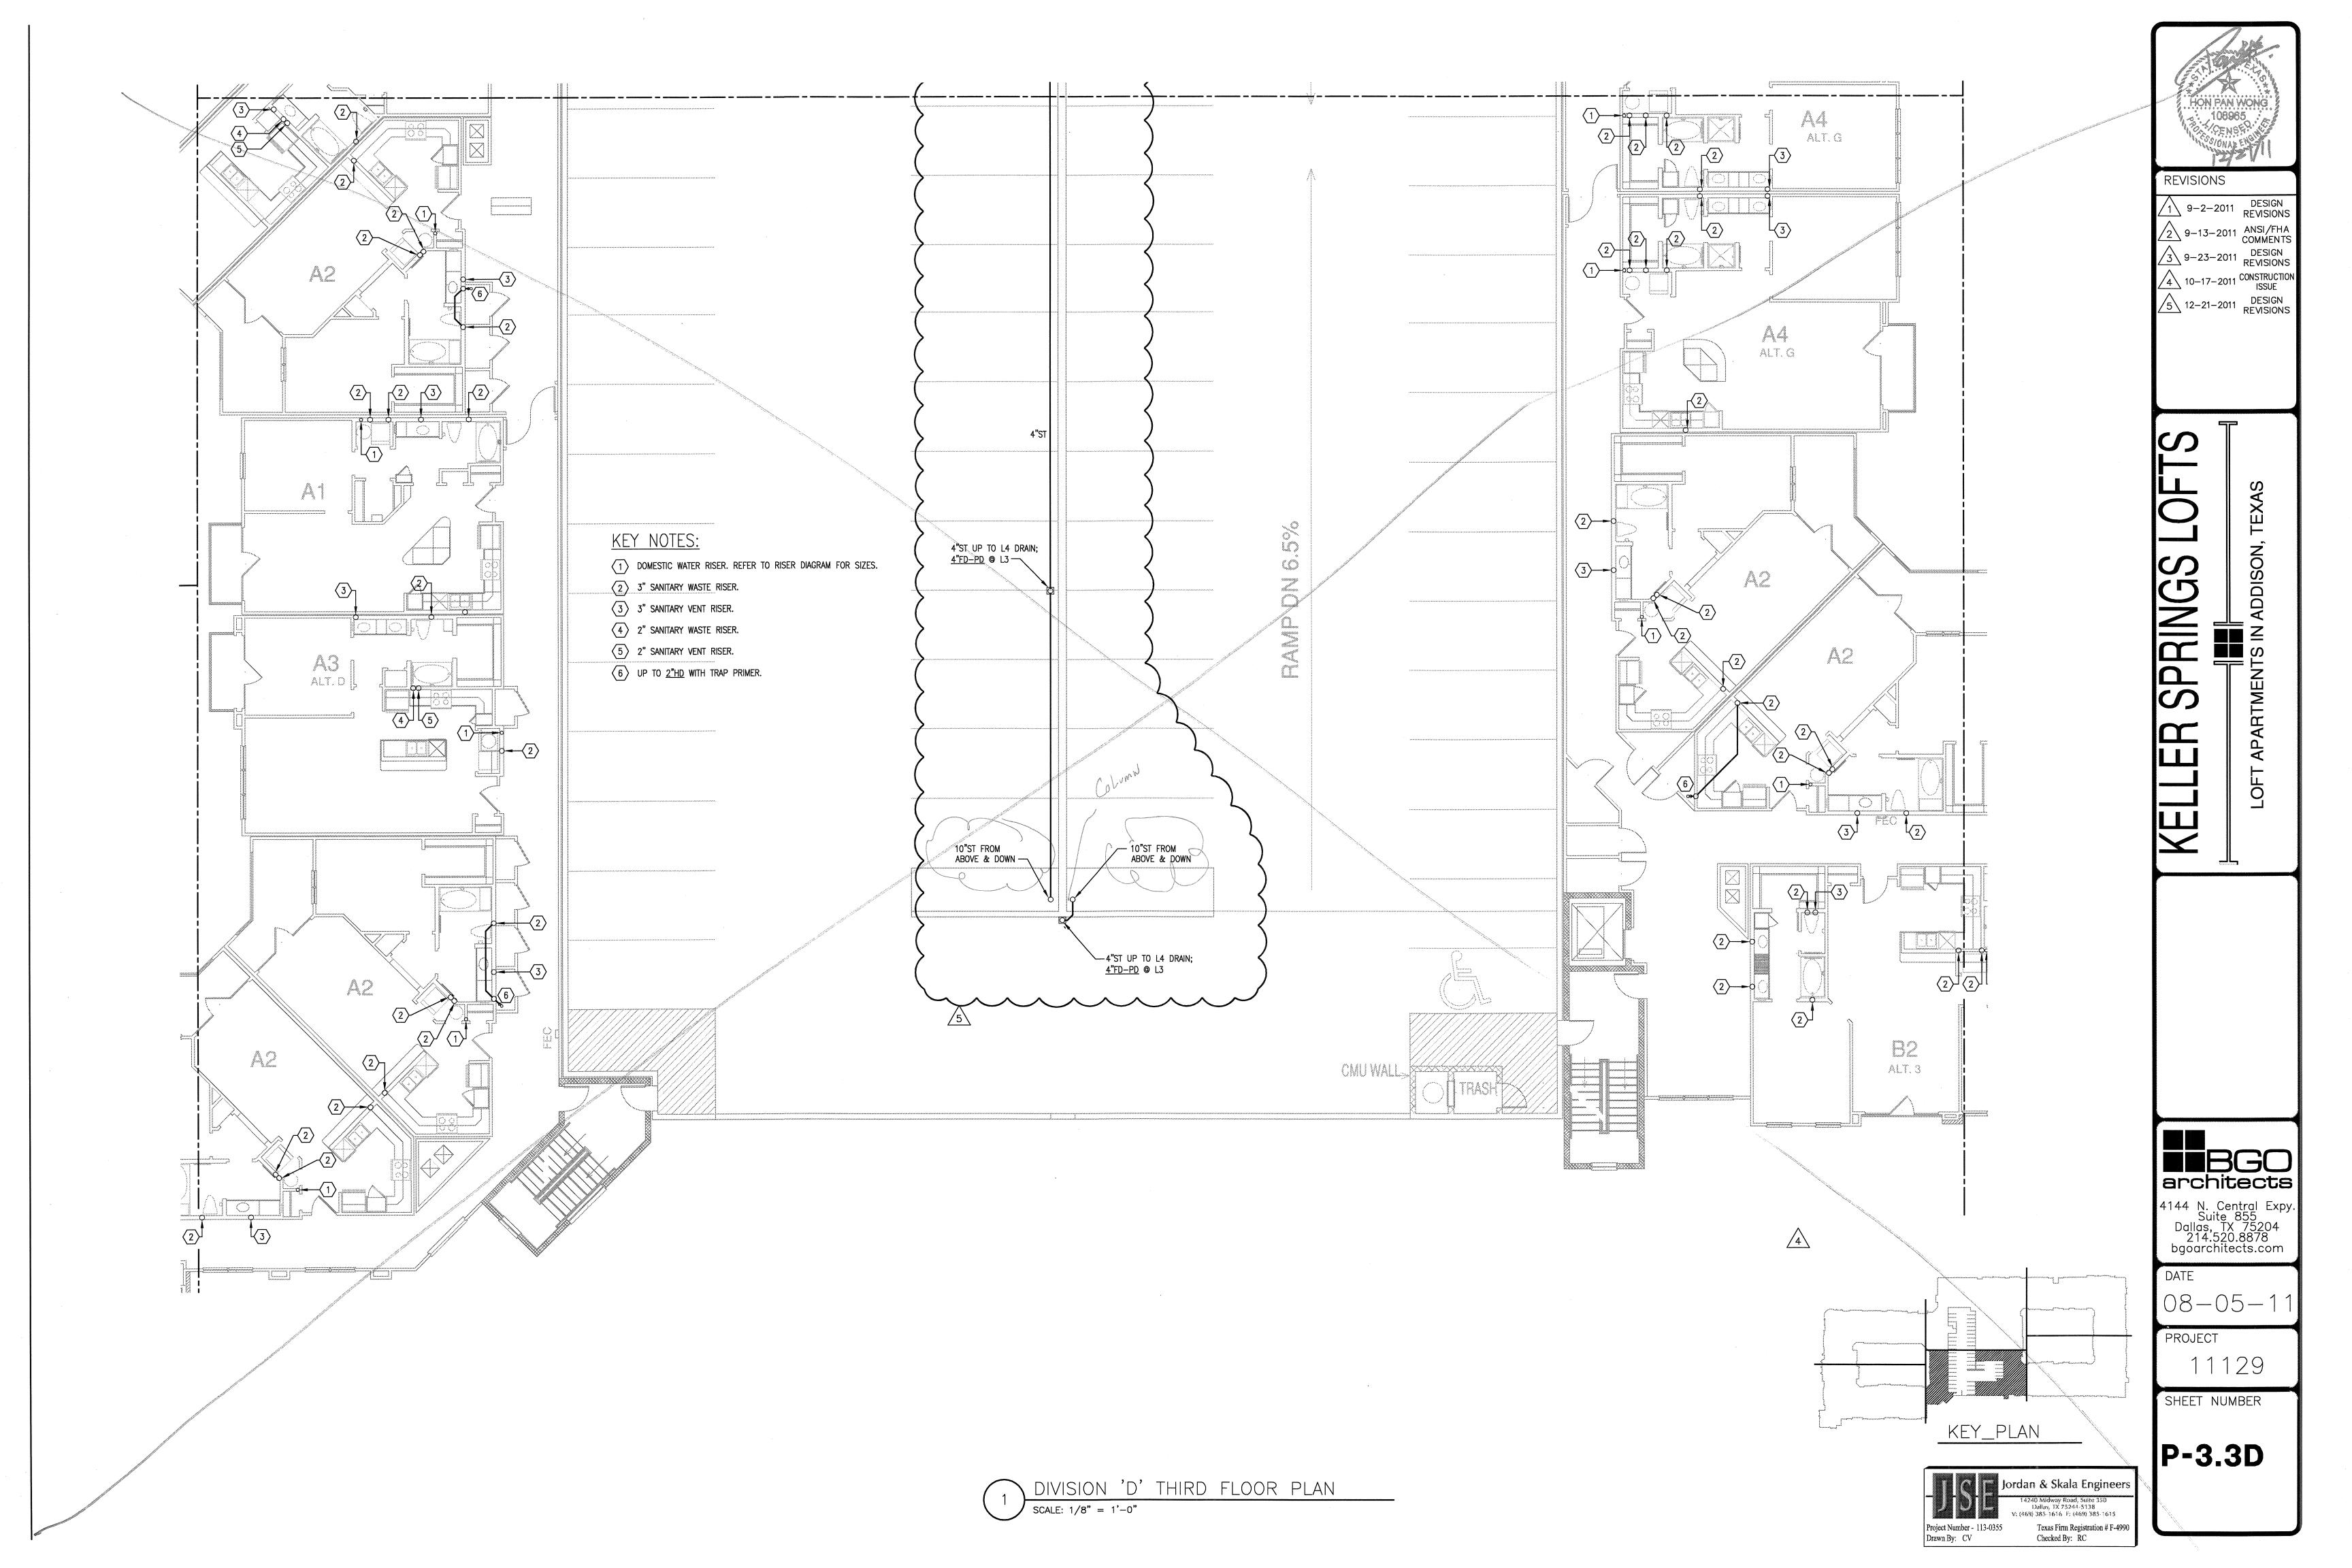

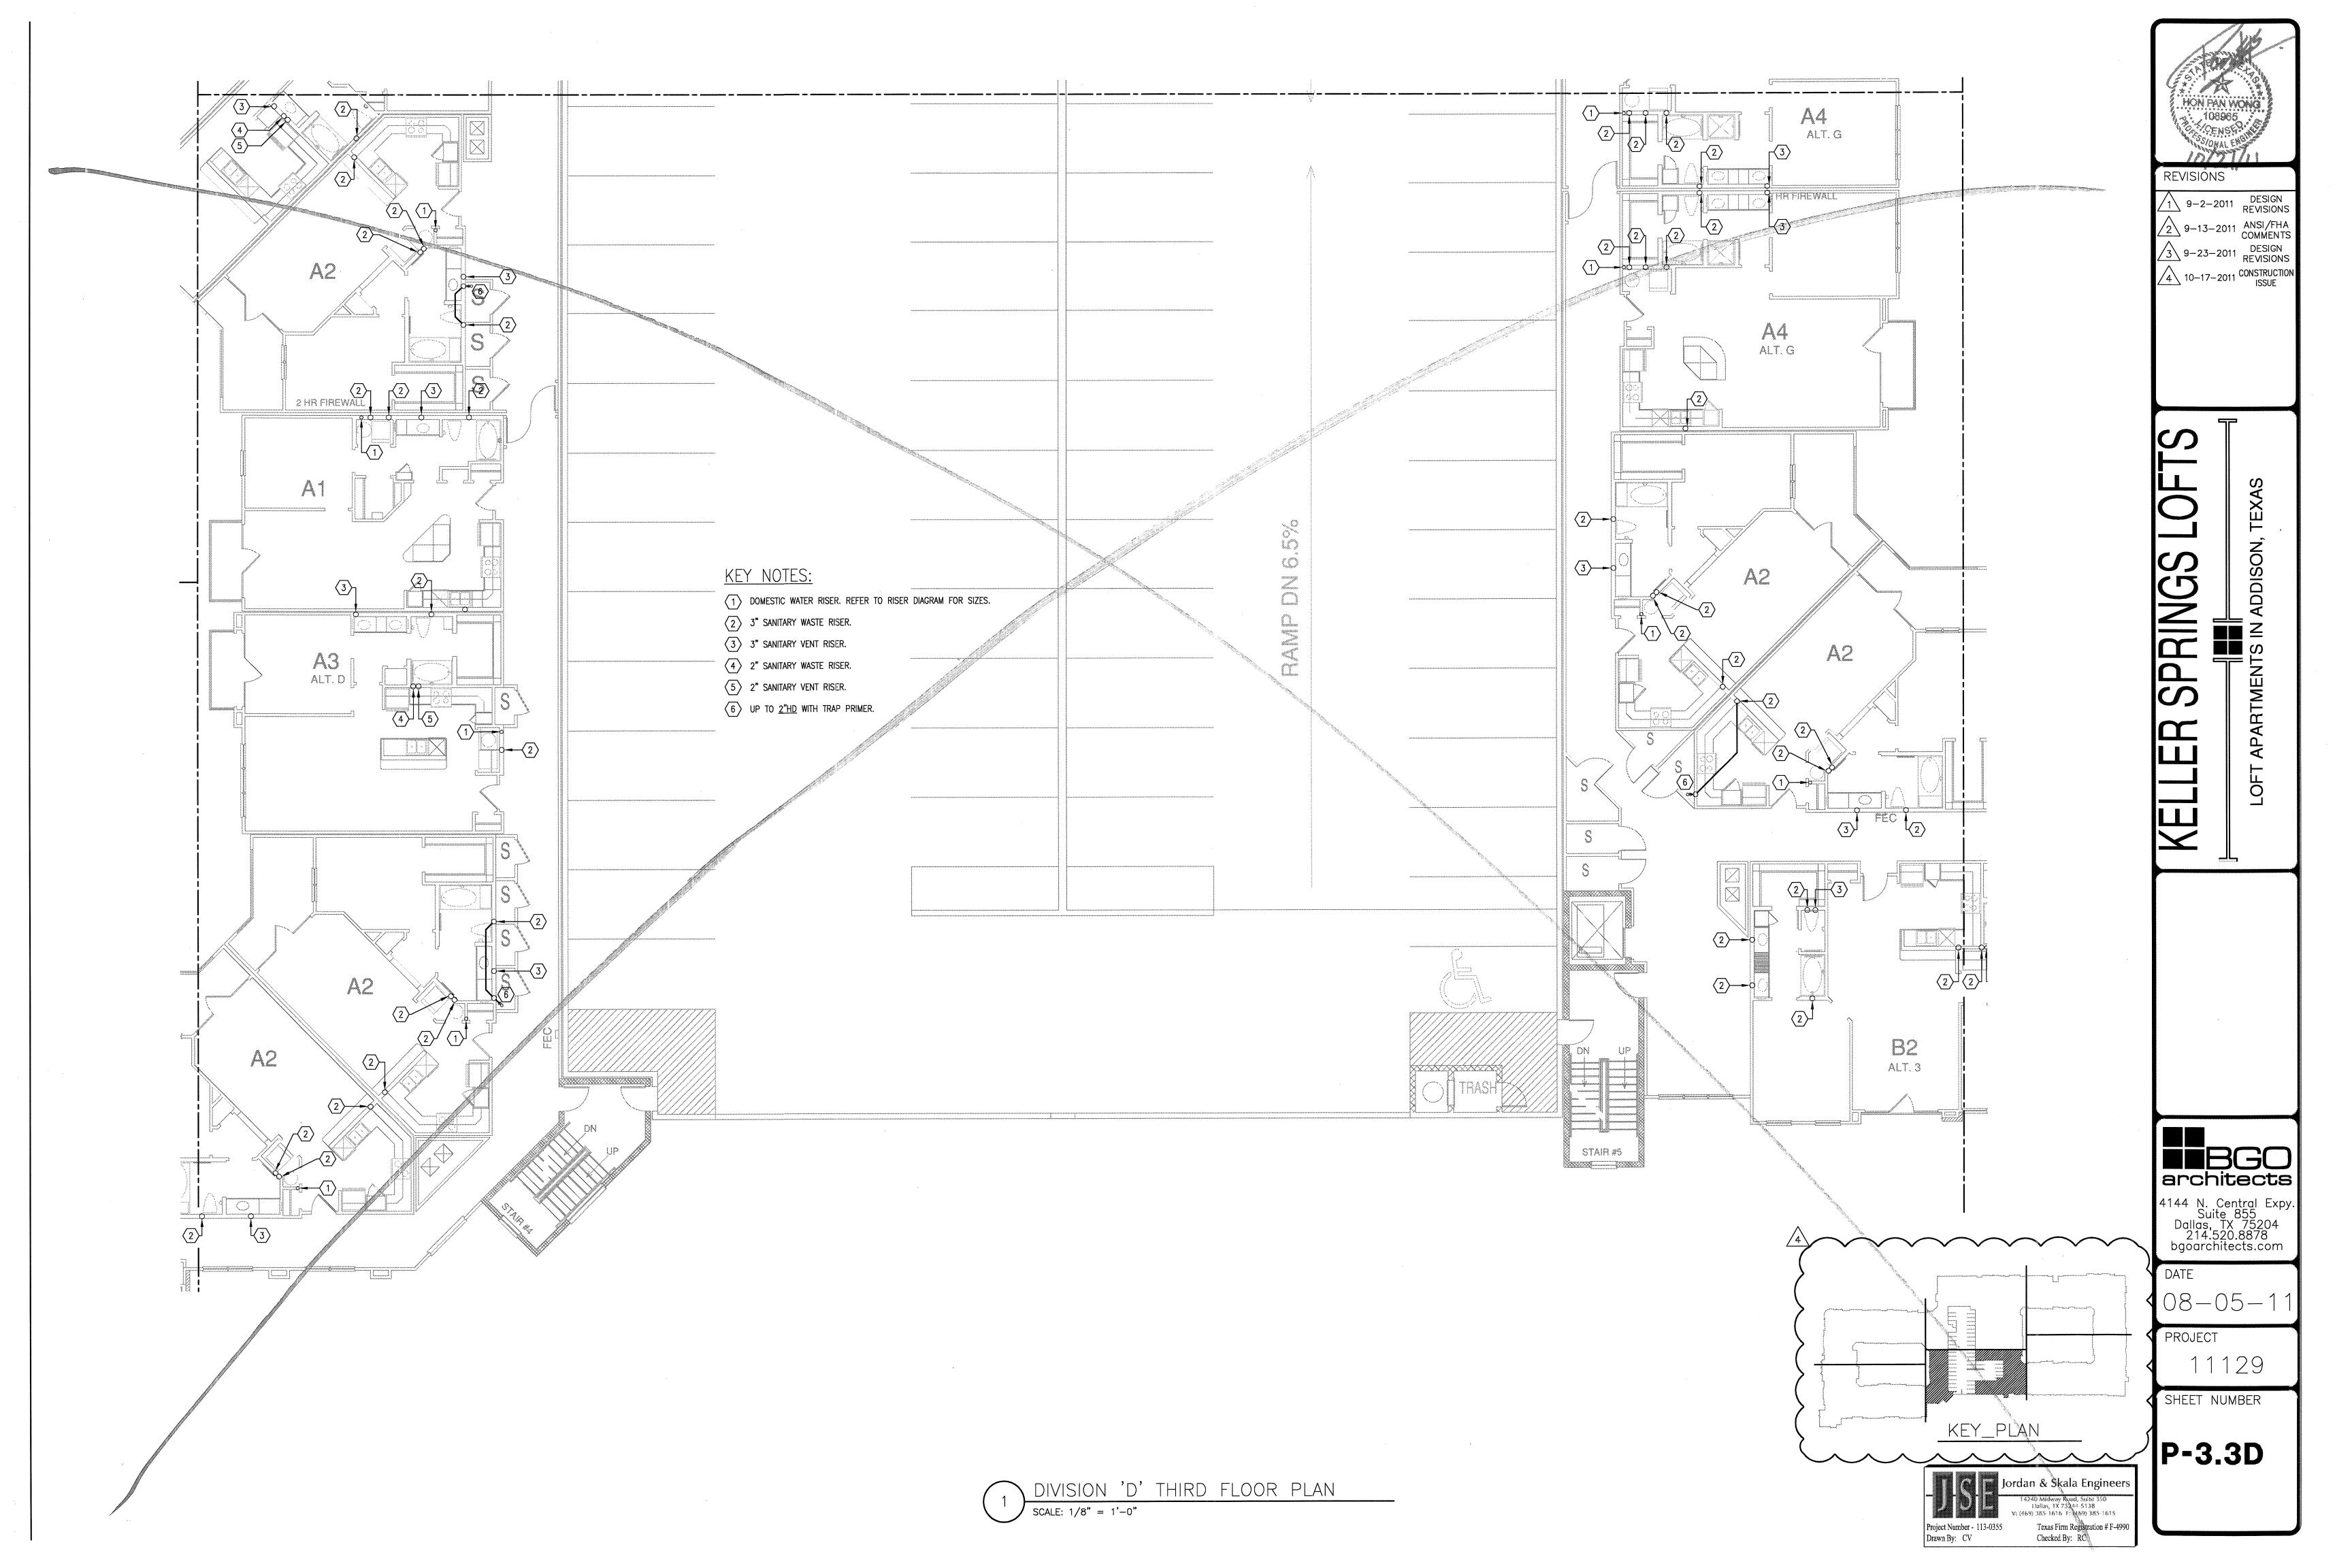

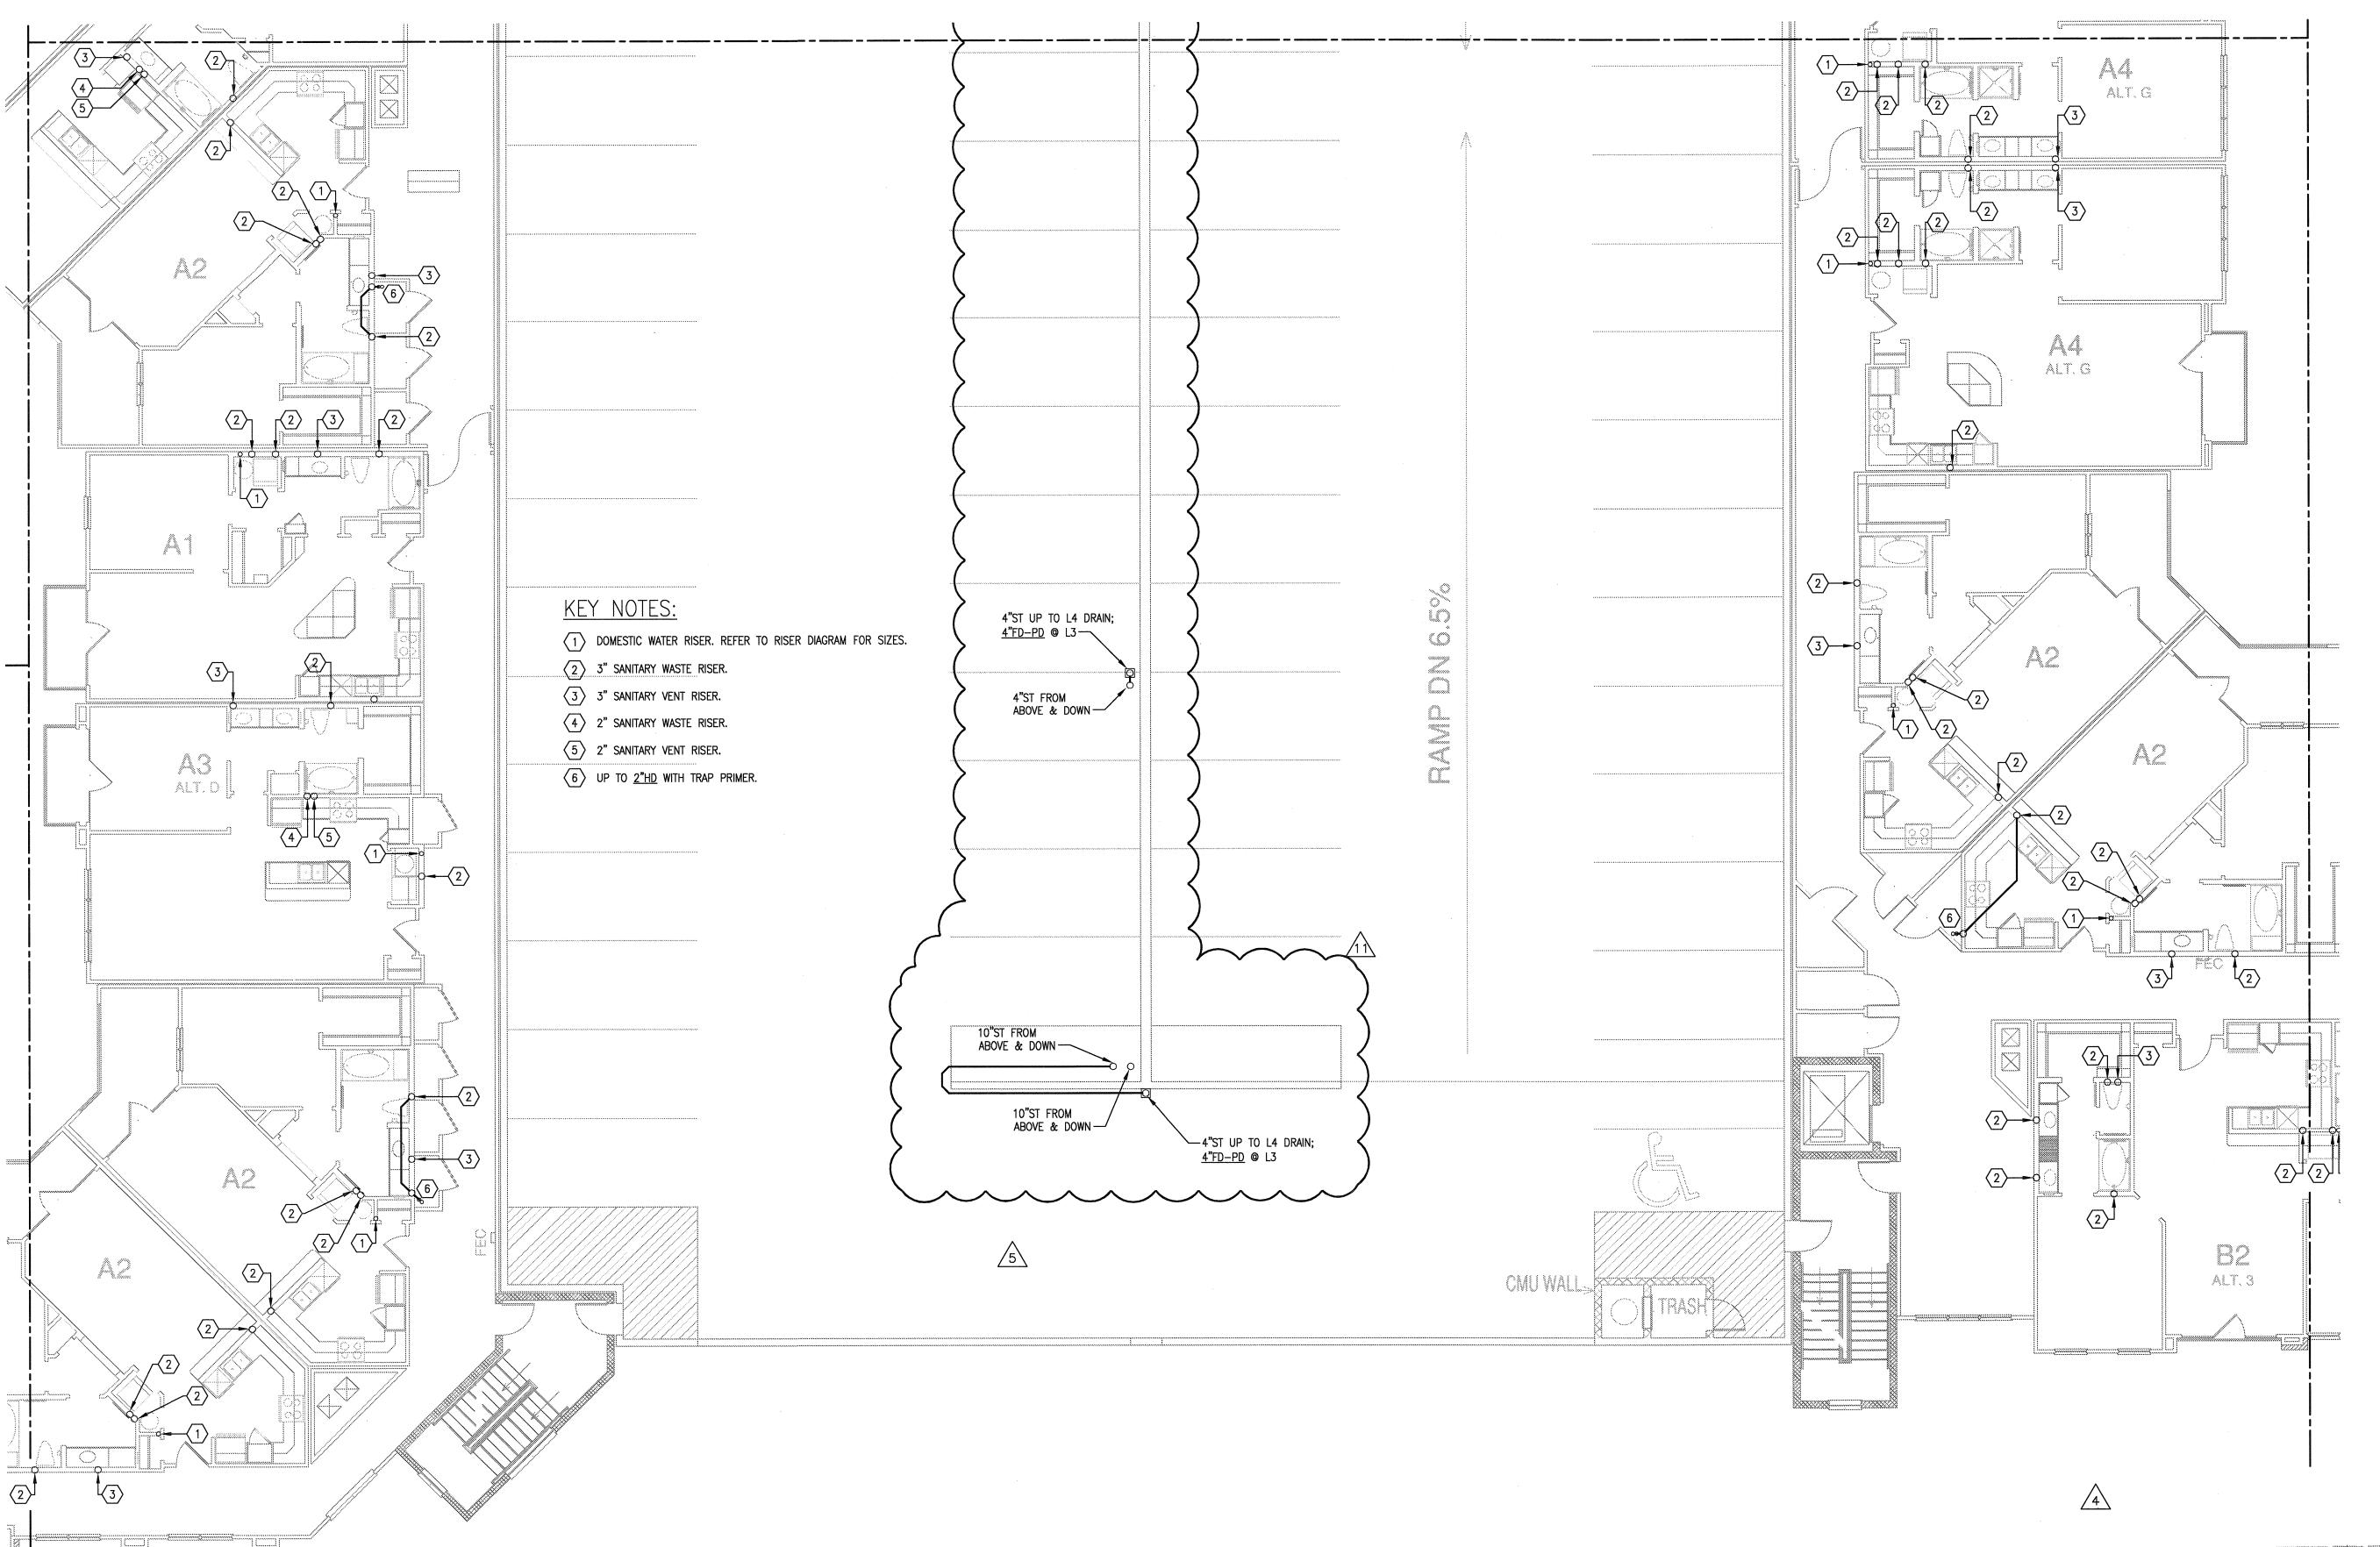

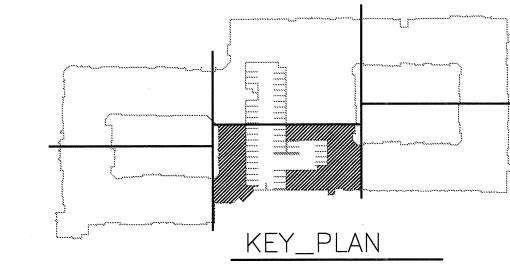





9-2-2011 DESIGN REVISIONS
2 9-13-2011 ANSI/FHA COMMENTS DESIGN REVISIONS
3 9-23-2011 REVISIONS
4 10-17-2011 DESIGN REVISIONS
5 12-21-2011 REVISIONS
6 1-17-2012 DESIGN REVISIONS
TRANSFORMER
2-15-2012 REVISIONS
8 3-27-2012 CLUBHOUSE REVISIONS
4-17-2012 COORDINATION

LEK SPRINGS LOFIS

5-15-2012 COORDINATION 5-30-2012 SITE COORDINATION

BBGO architects
4144 N. Central Expy.


4144 N. Central Expy.
Suite 855
Dallas, TX 75204
214.520.8878
bgoarchitects.com


DATE 08-05-11


PROJECT 11129


SHEET NUMBER


P-3.3D

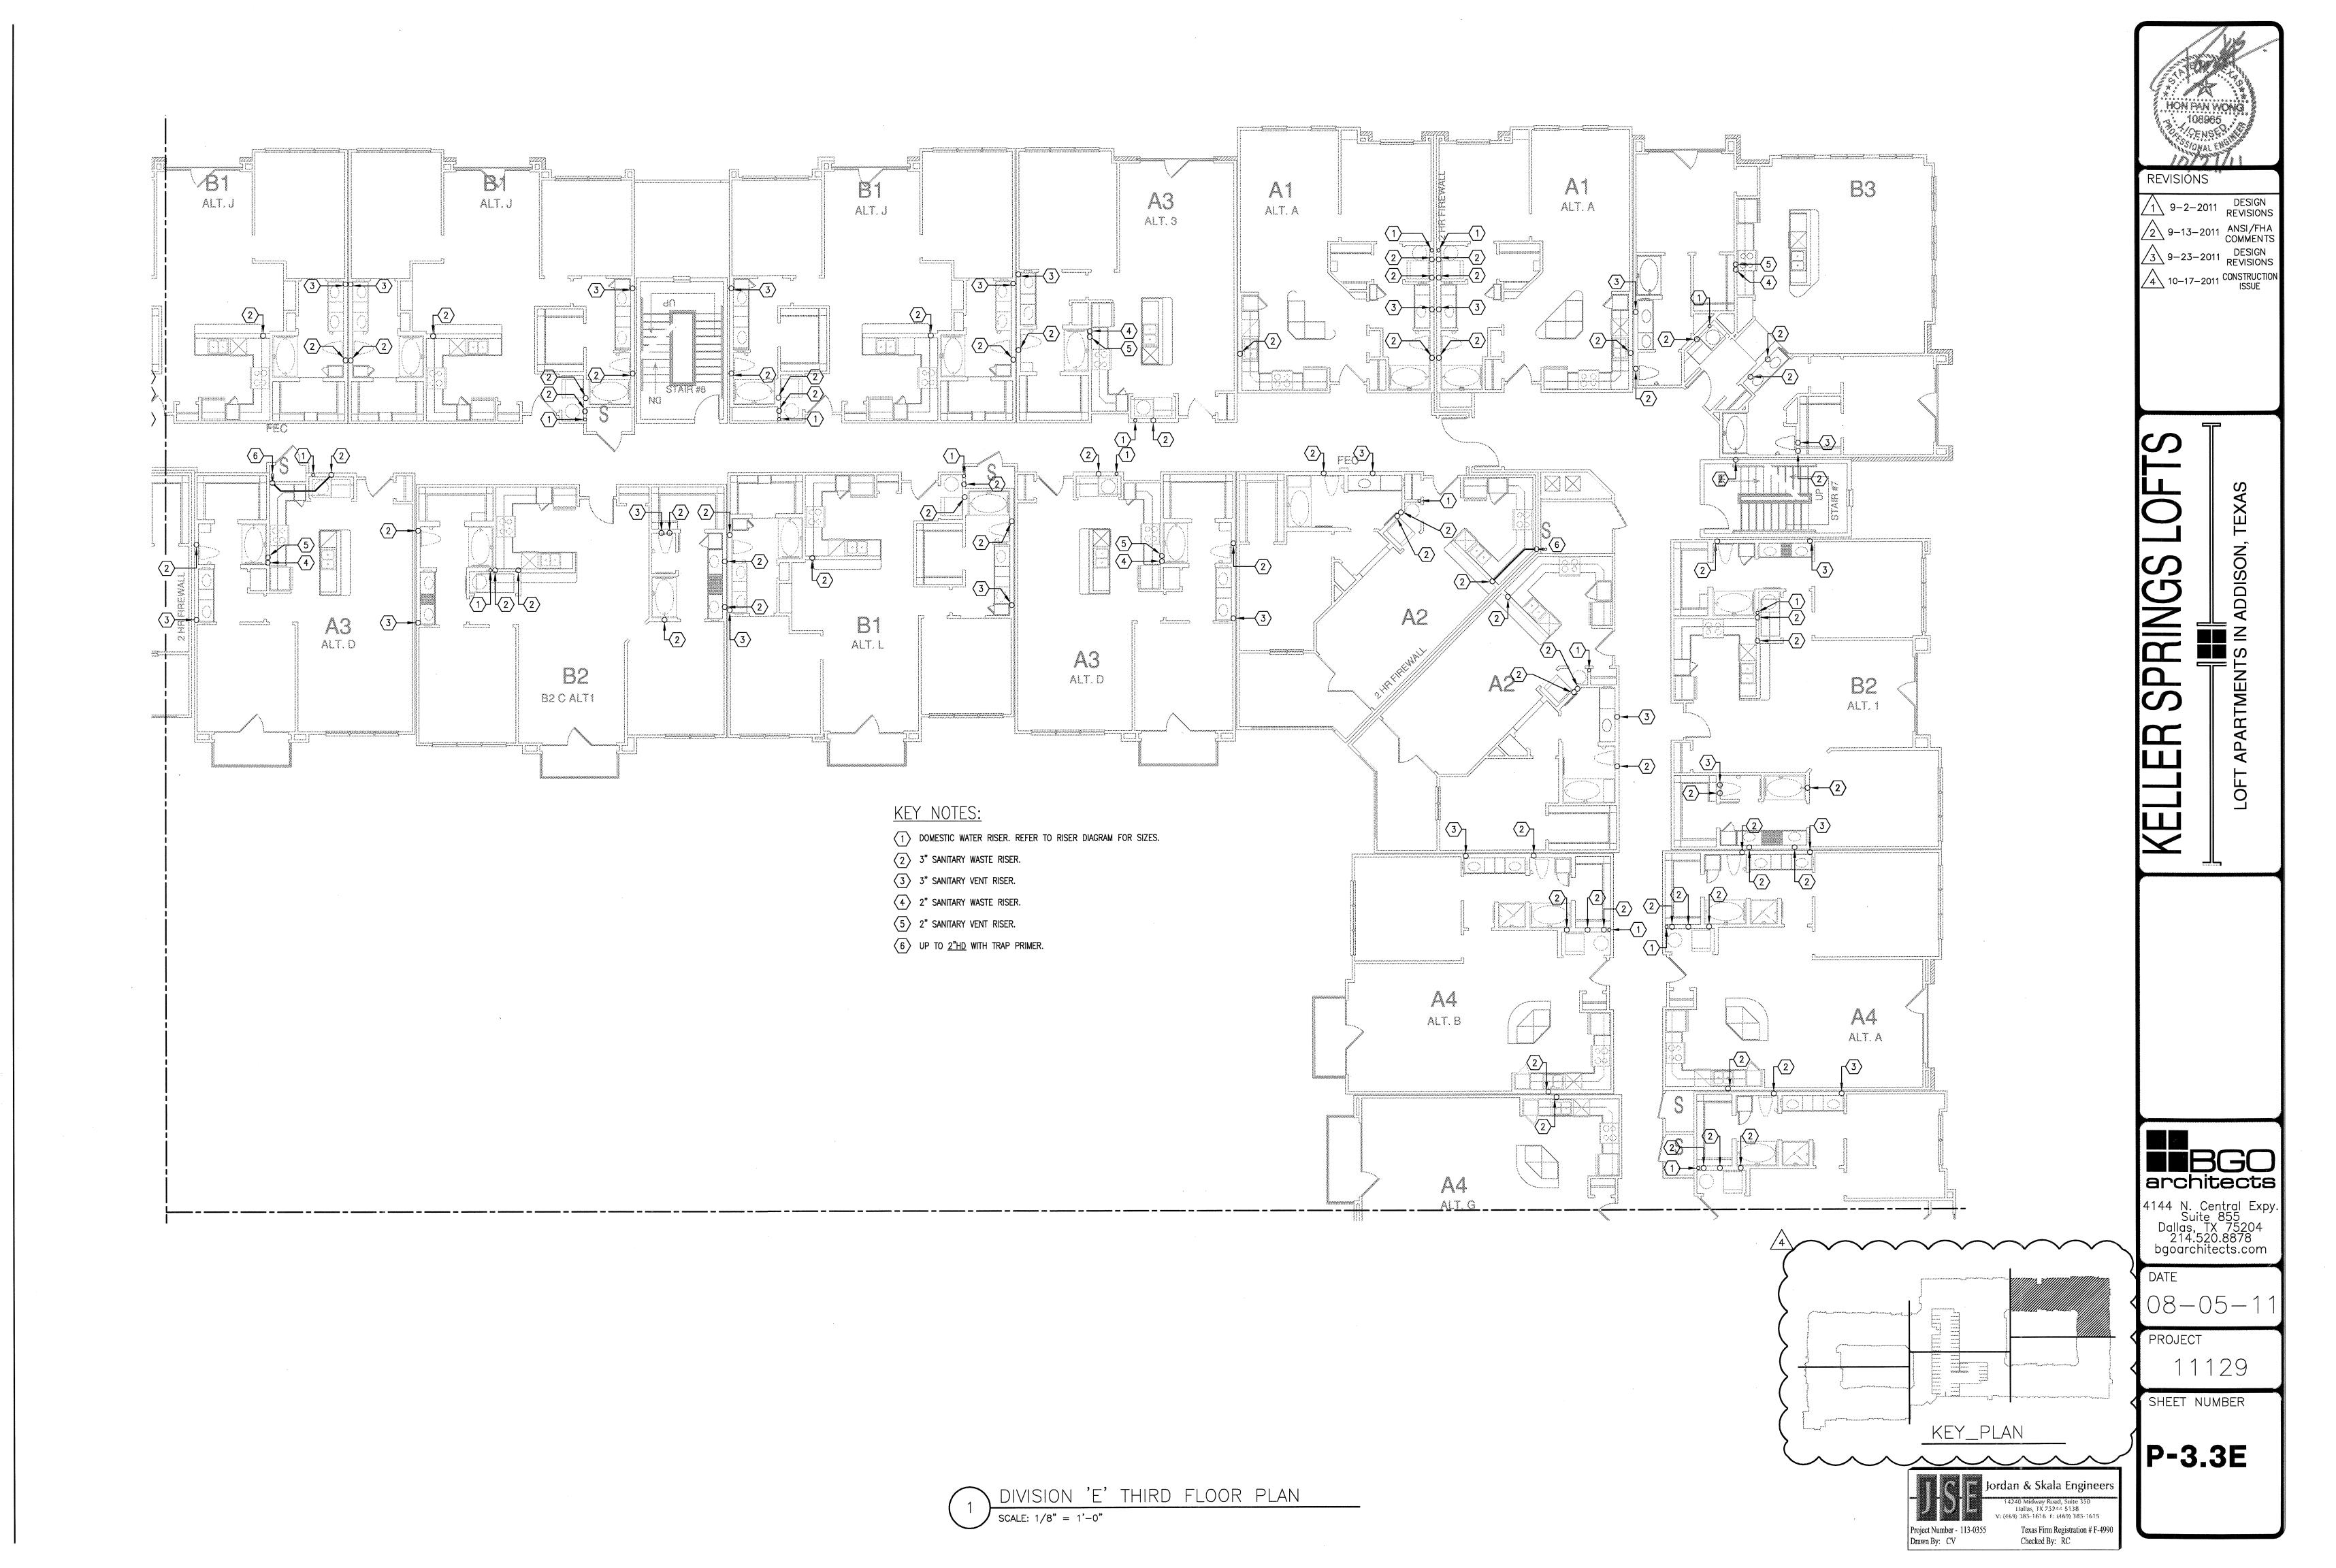


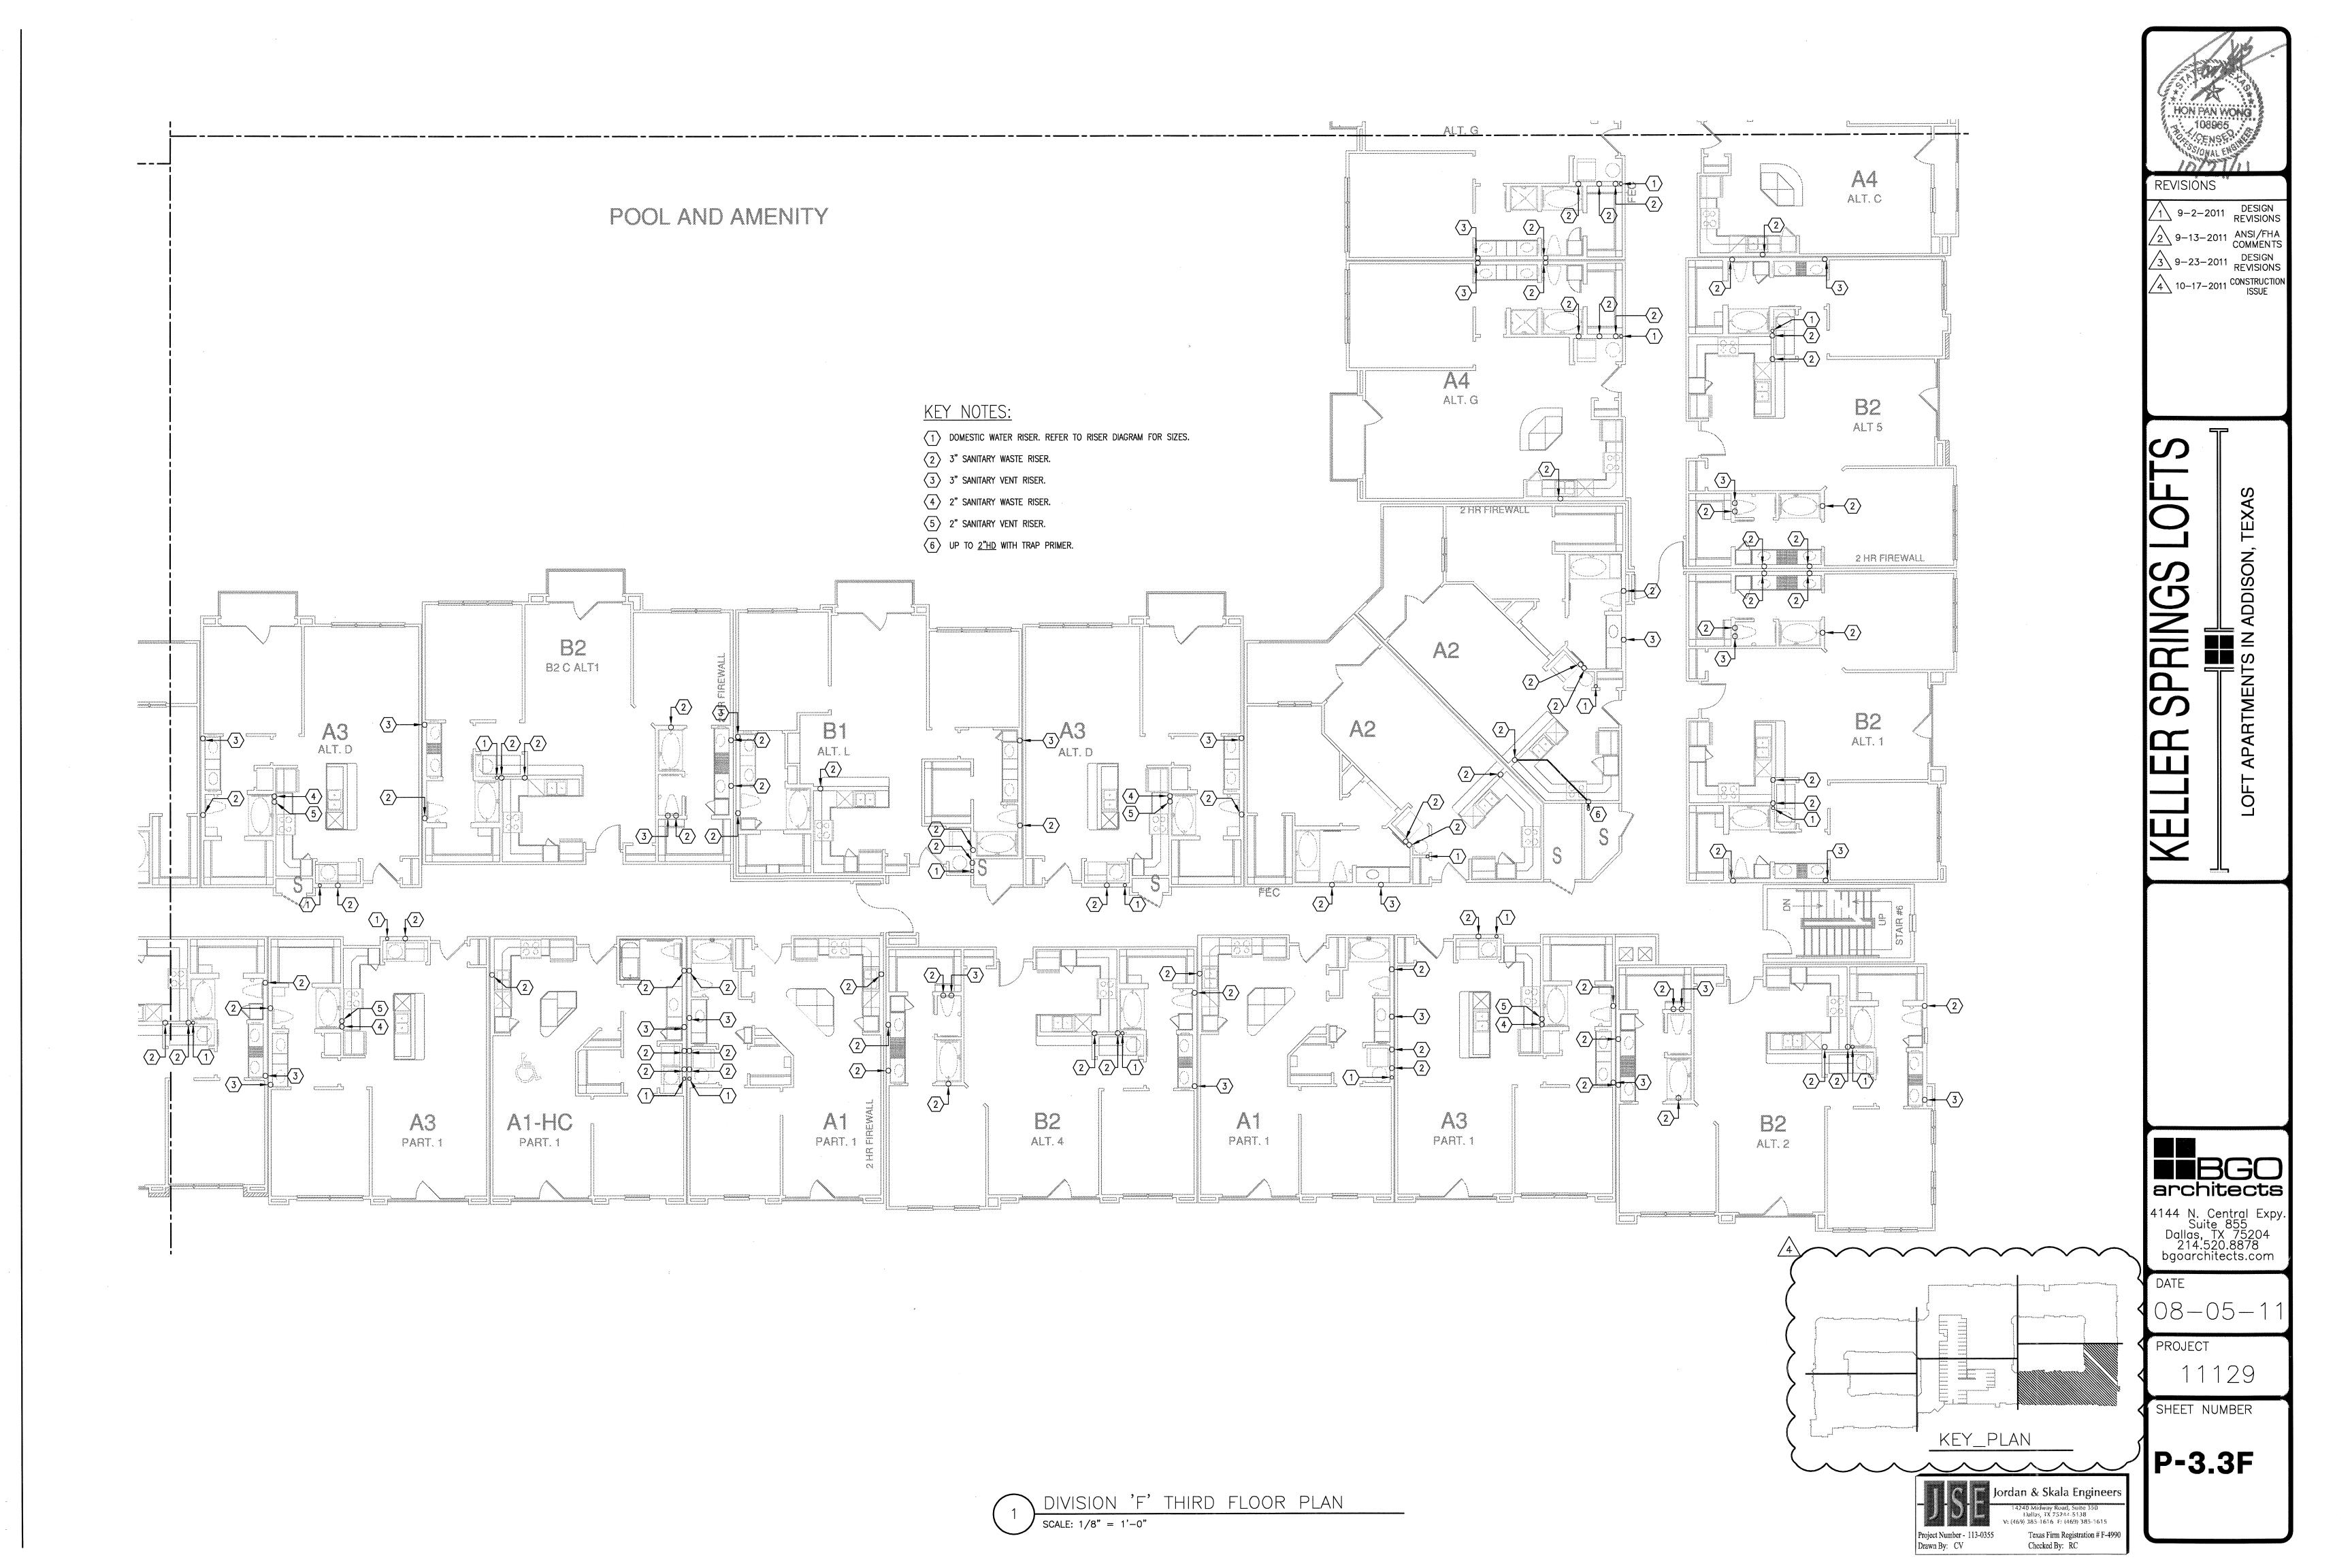

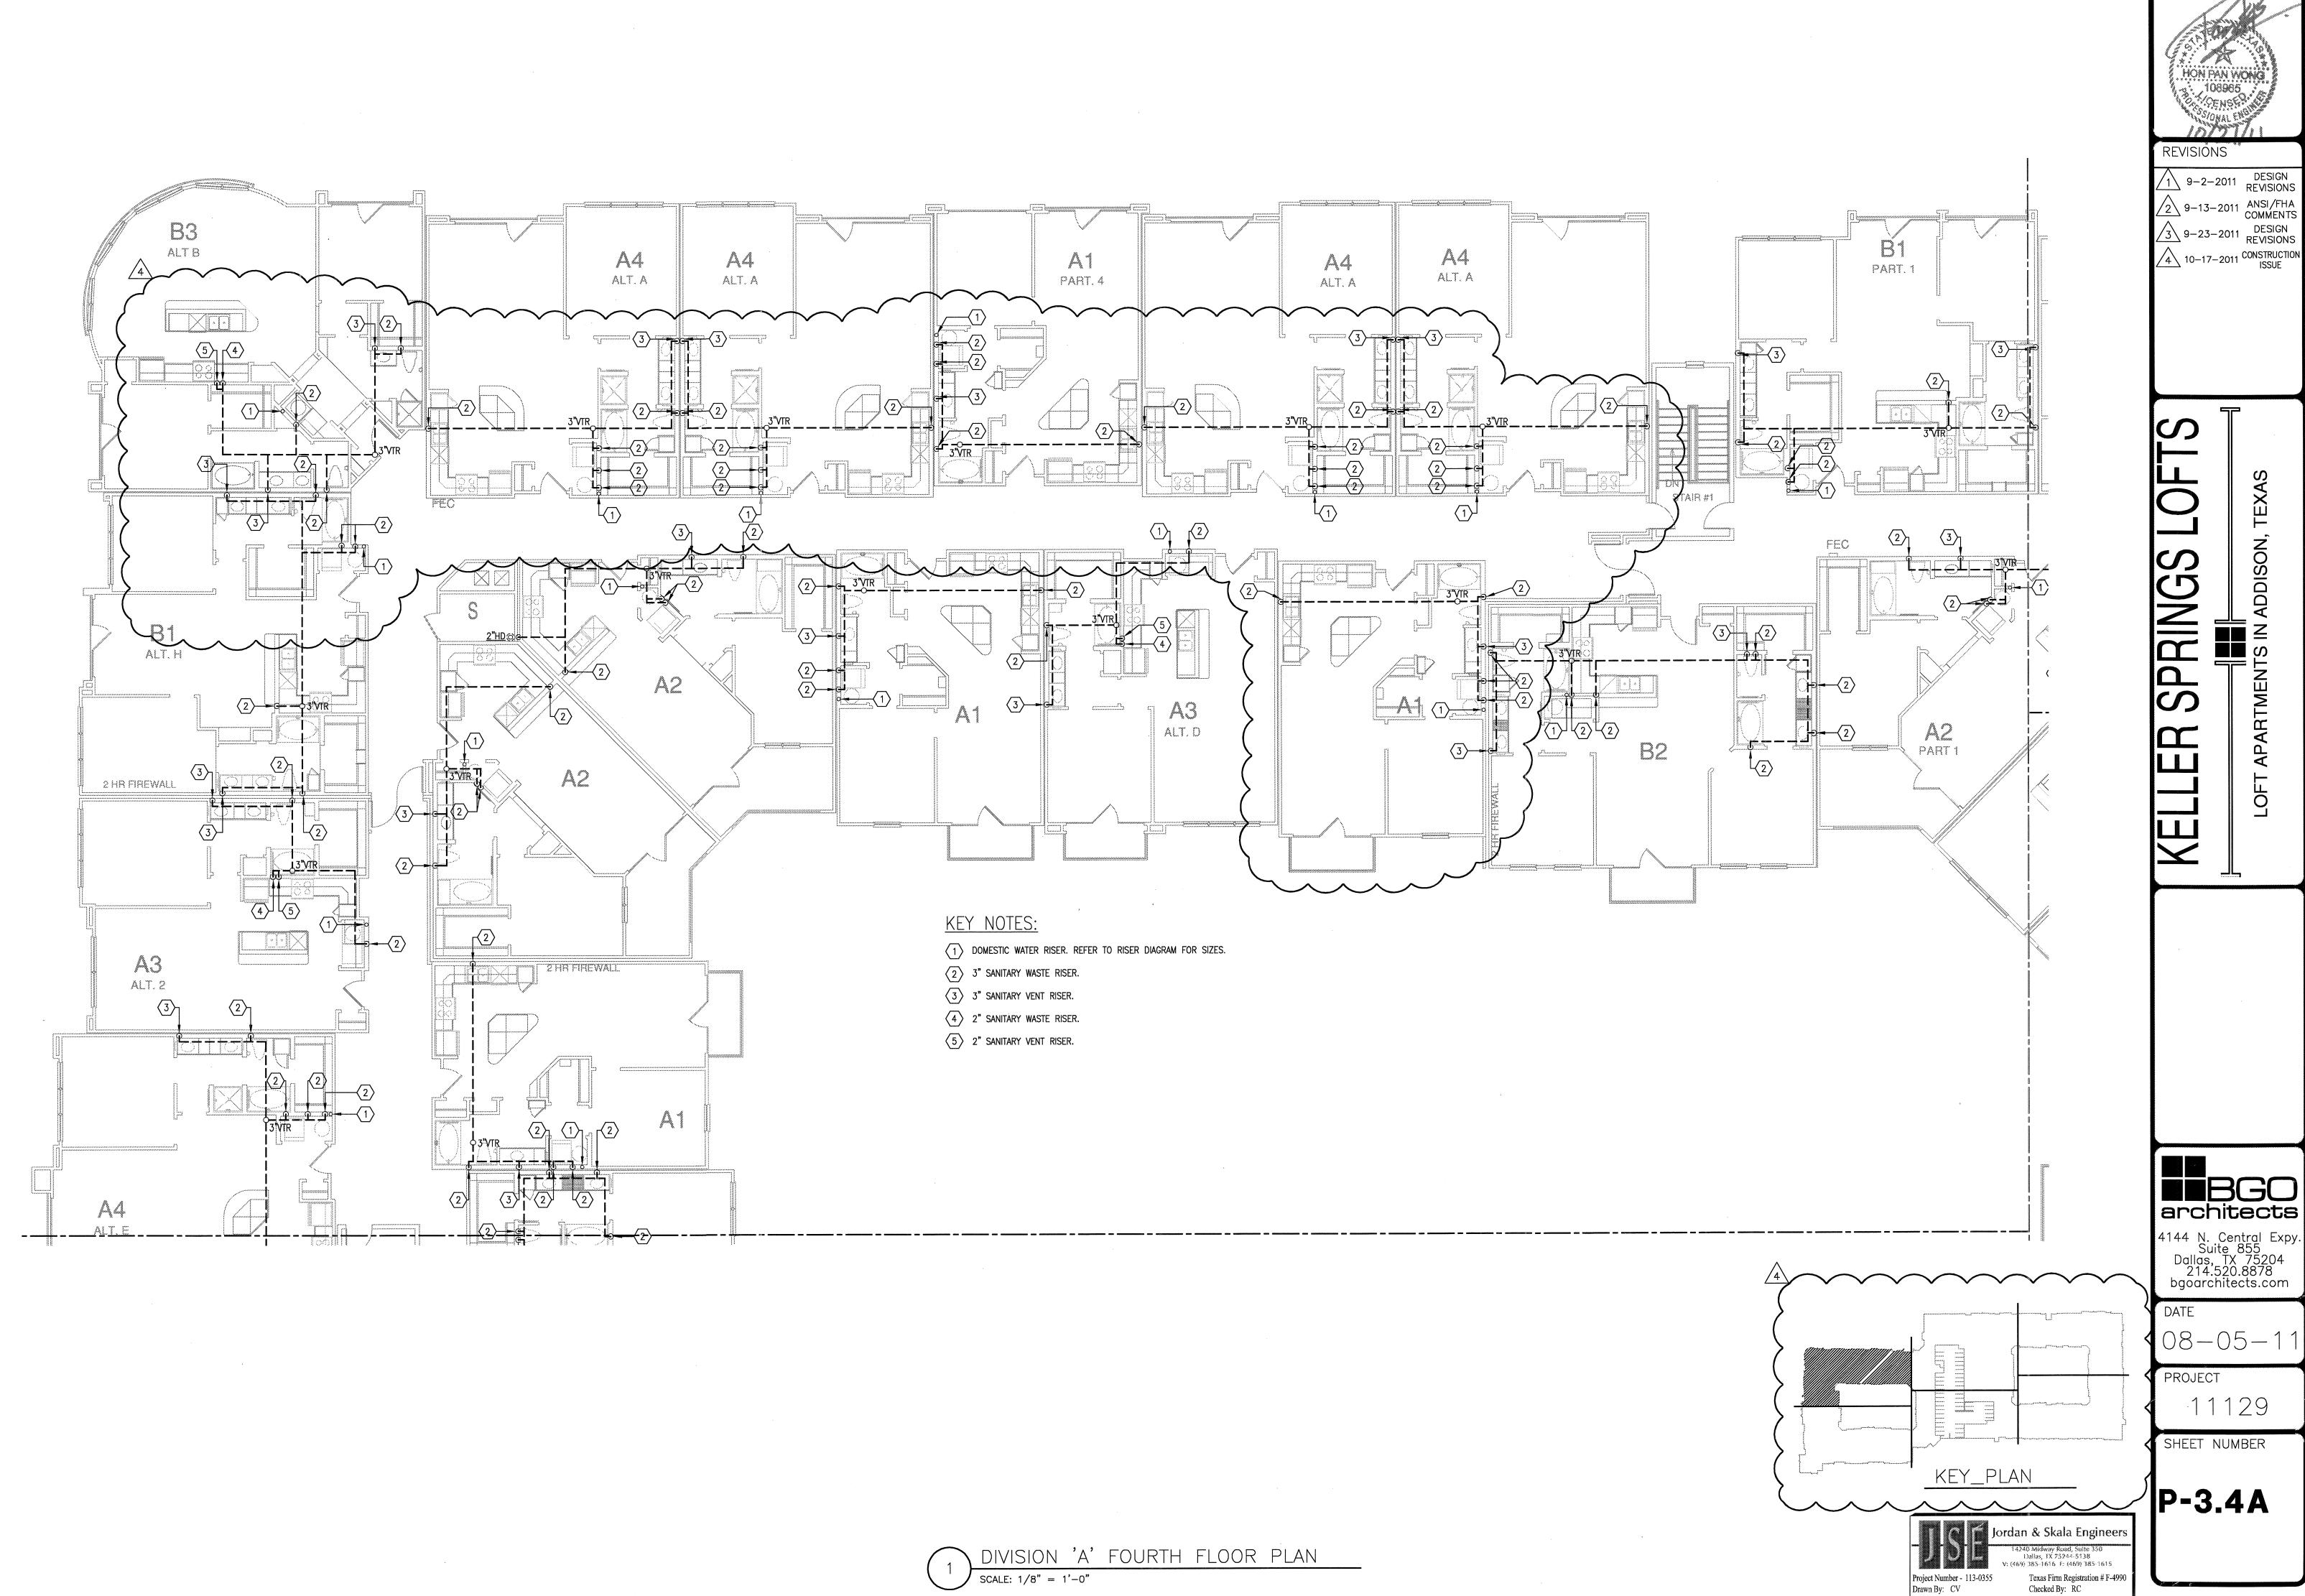

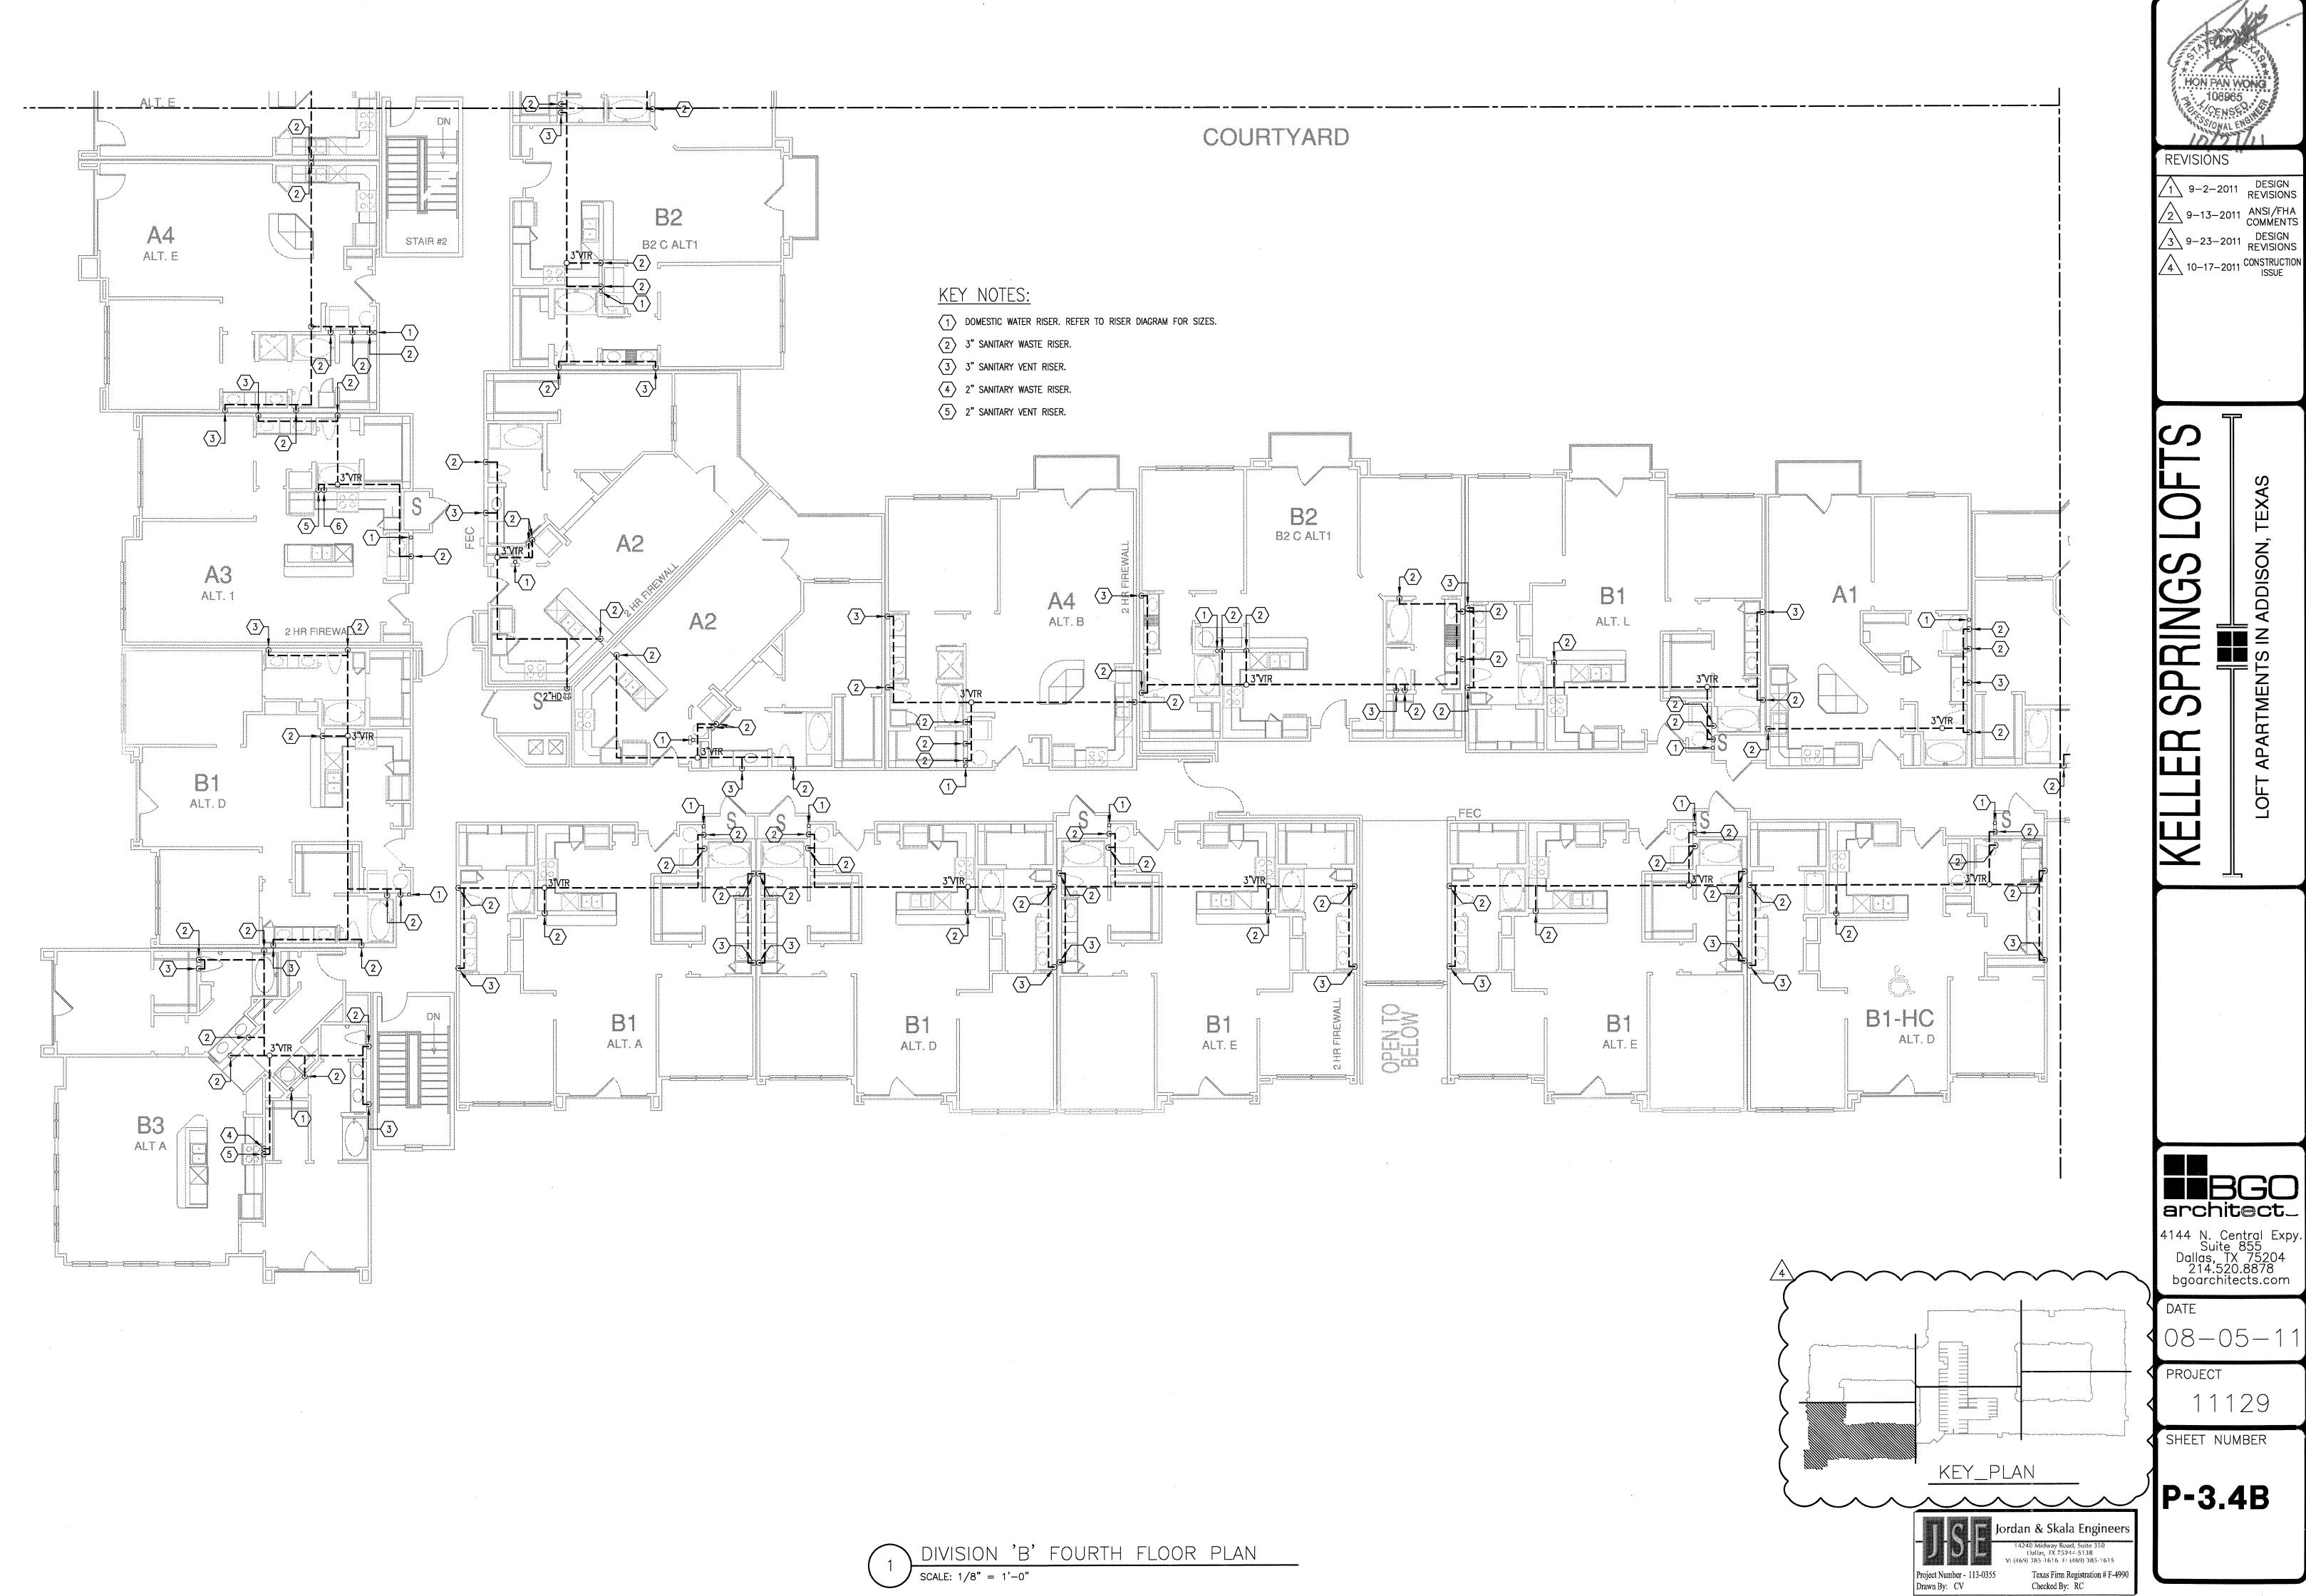

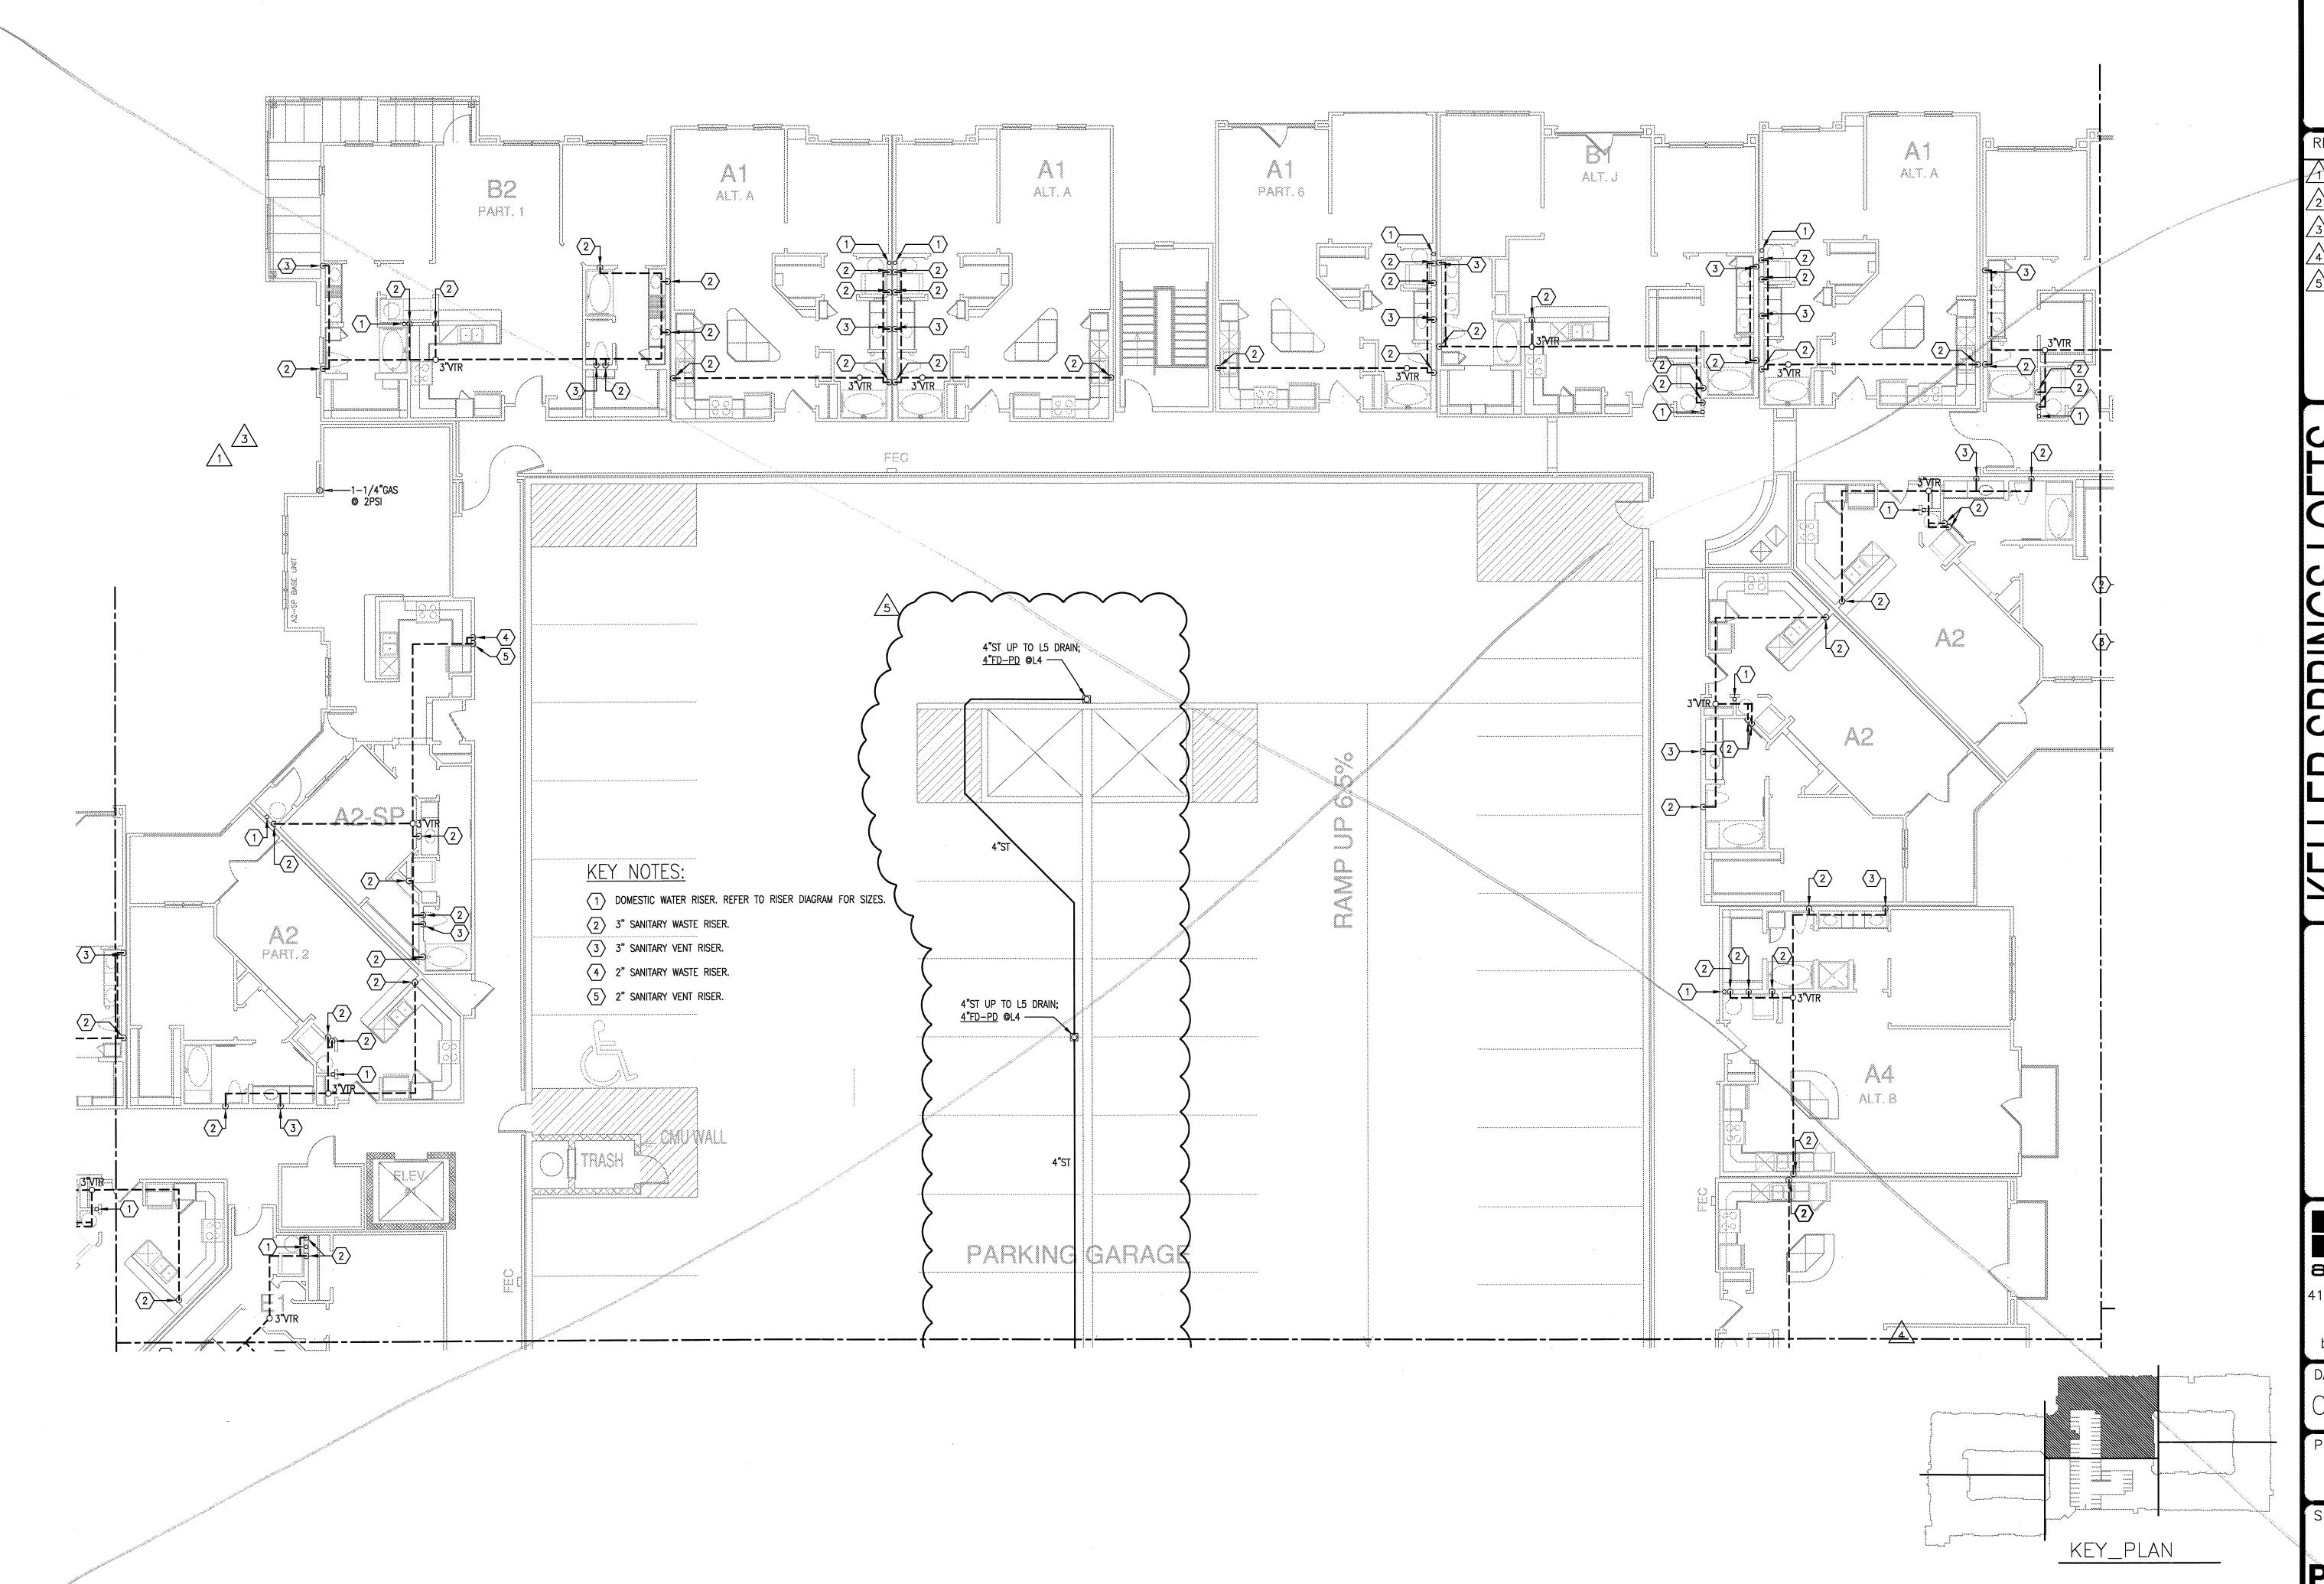

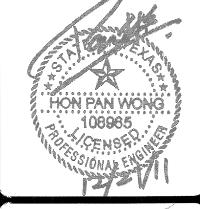

9-2-2011 DESIGN REVISIONS 2 9-13-2011 ANSI/FHA COMMENTS 3 9-23-2011 DESIGN REVISIONS 4 10-17-2011 CONSTRUCTION ISSUE 5 12-21-2011 DESIGN REVISIONS

BBGO architects 4144 N. Central Expy. Suite 855 Dallas, TX 75204 214.520.8878 bgoarchitects.com

DATE

08-05-11


PROJECT


11129 SHEET NUMBER


P-3.4C

DIVISION 'C' FOURTH FLOOR PLAN SCALE: 1/8" = 1'-0"



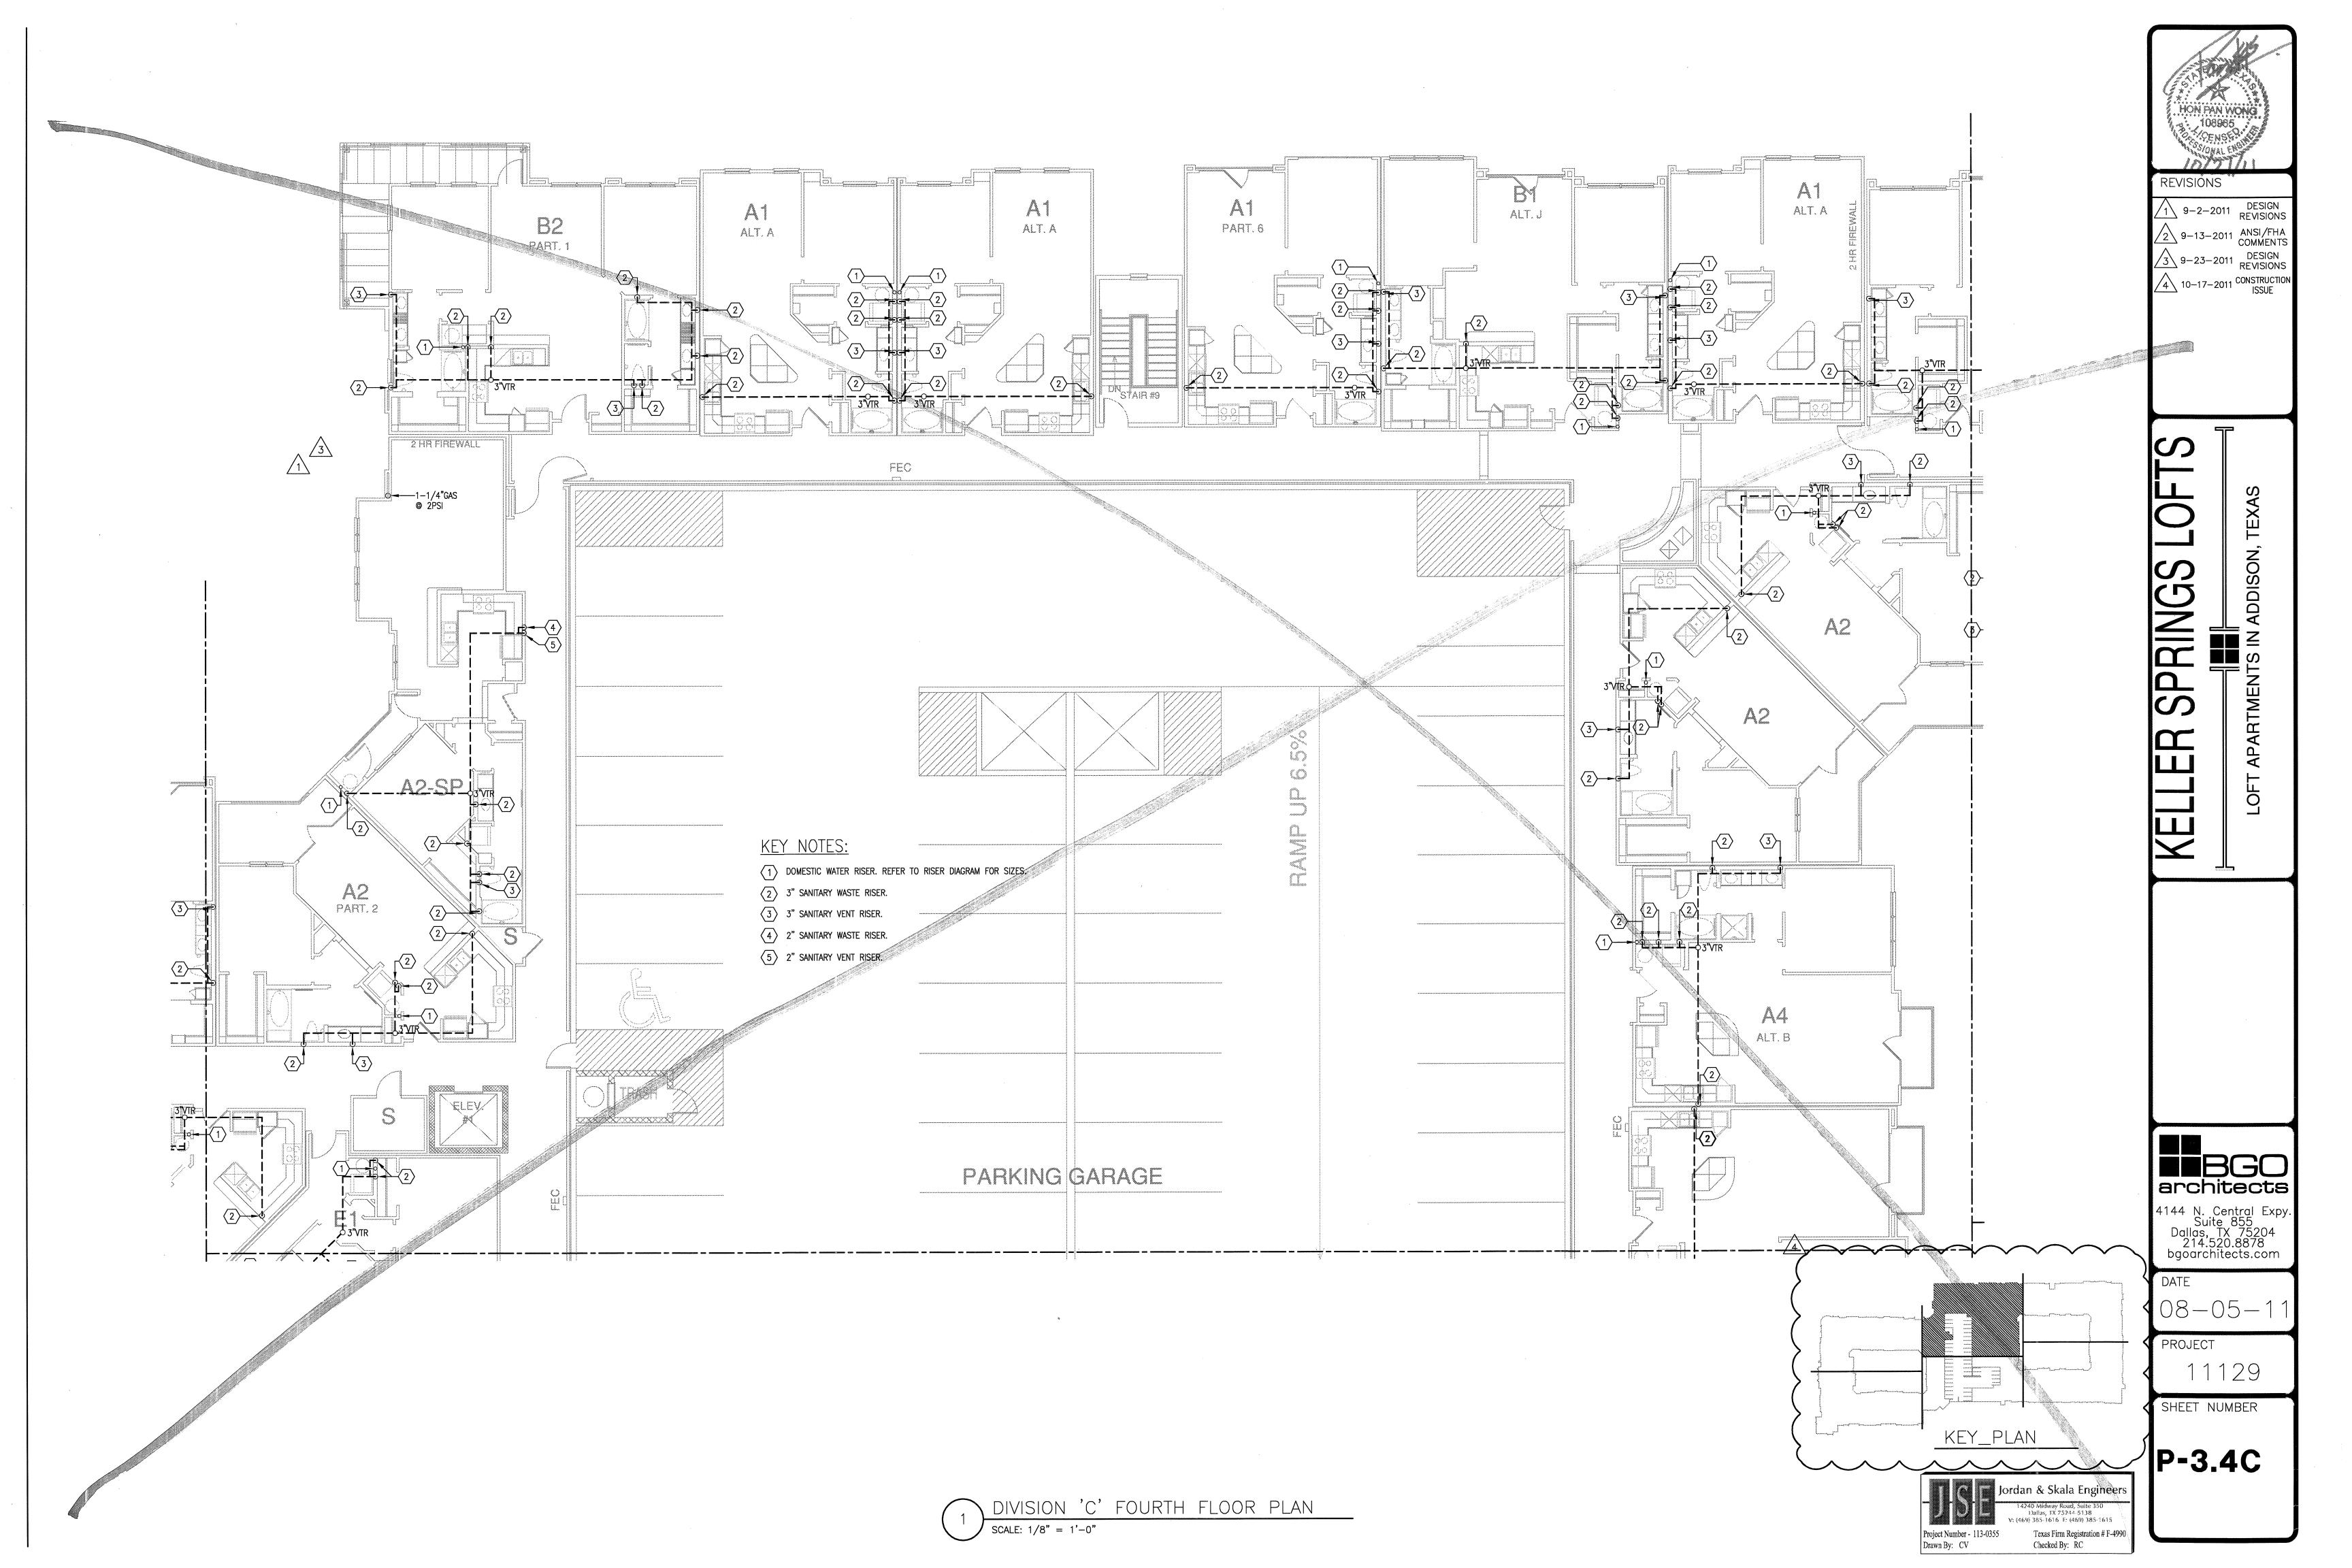

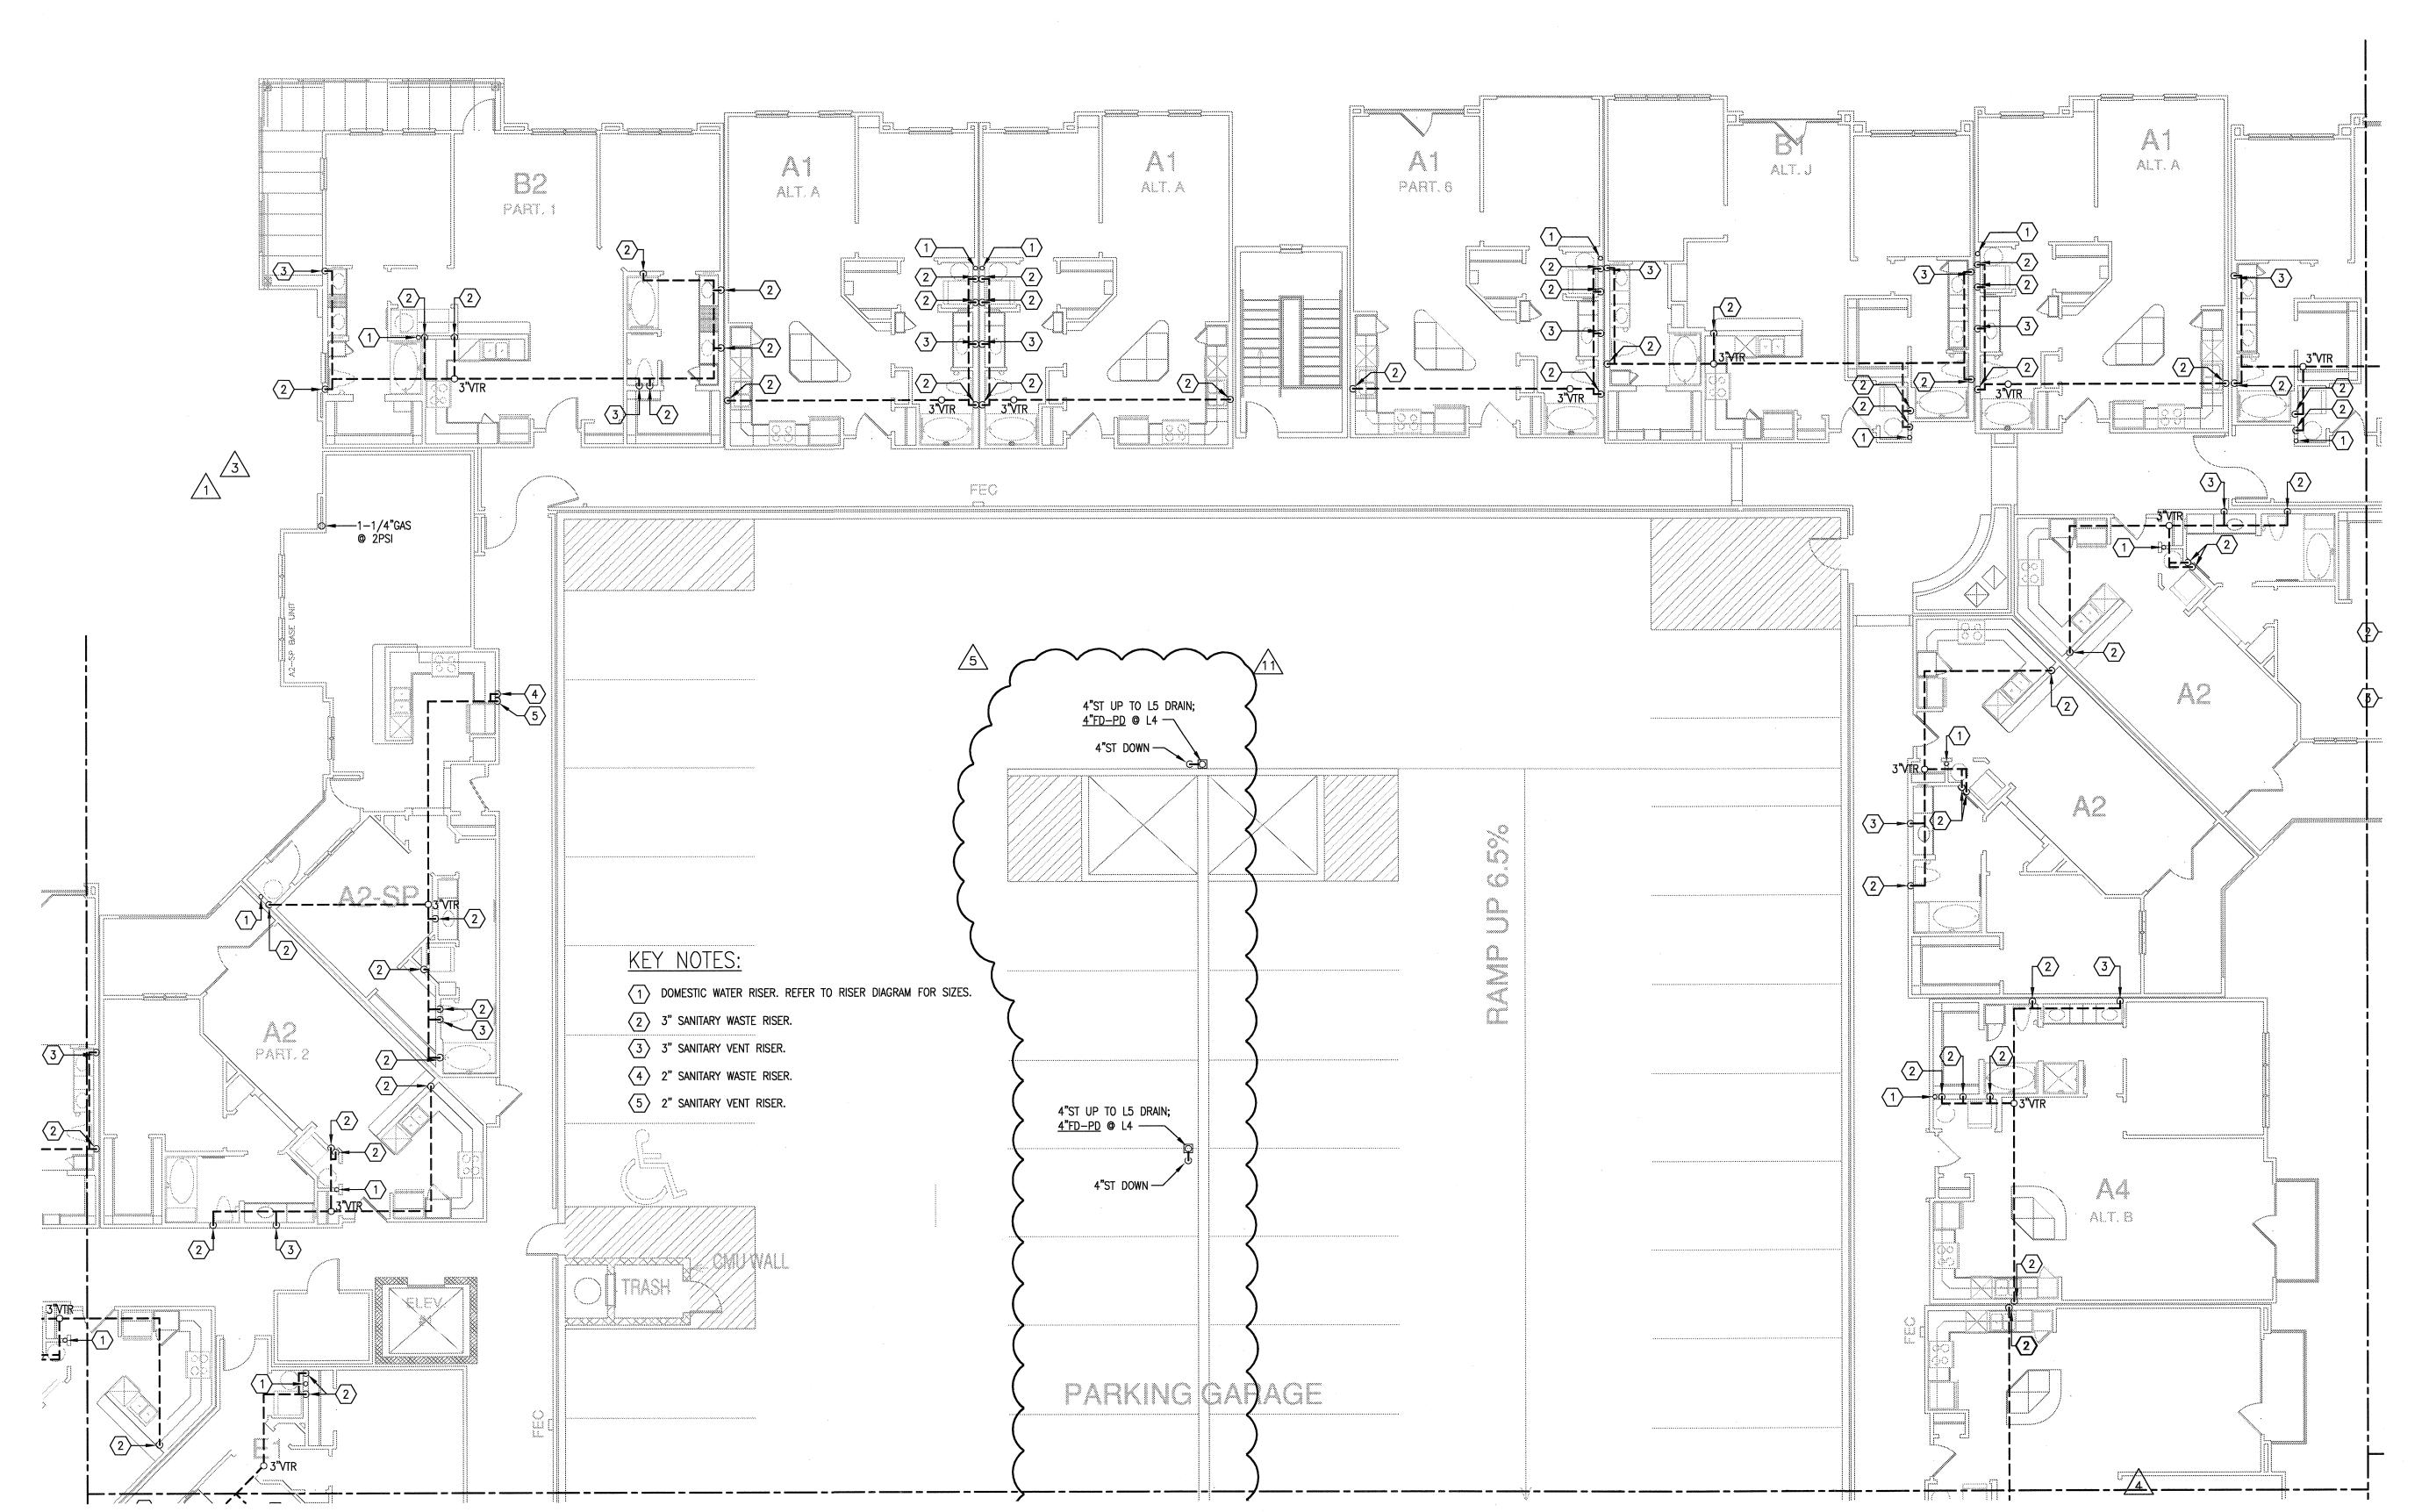

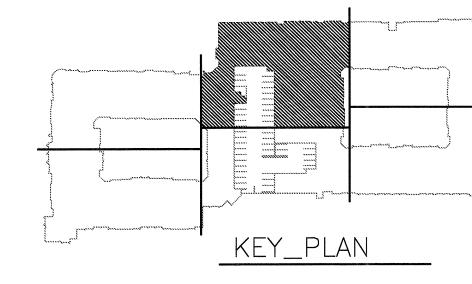





9-2-2011 DESIGN REVISIONS
2 9-13-2011 ANSI/FHA COMMENTS DESIGN REVISIONS
3 9-23-2011 REVISIONS
4 10-17-2011 DESIGN REVISIONS
5 12-21-2011 DESIGN REVISIONS
6 1-17-2012 DESIGN REVISIONS
7 2-15-2012 REVISIONS
8 3-27-2012 CLUBHOUSE REVISIONS
9 COORDINATION

ひしているのにつてしている。

5-15-2012 COORDINATION 5-30-2012 SITE COORDINATION

**BBGO** architects

4144 N. Central Expy. Suite 855 Dallas, TX 75204 214.520.8878 bgoarchitects.com

DATE 08-05-11


PROJECT


SHEET NUMBER


P-3.4C

DIVISION 'C' FOURTH FLOOR PLAN

SCALE: 1/8" = 1'-0"

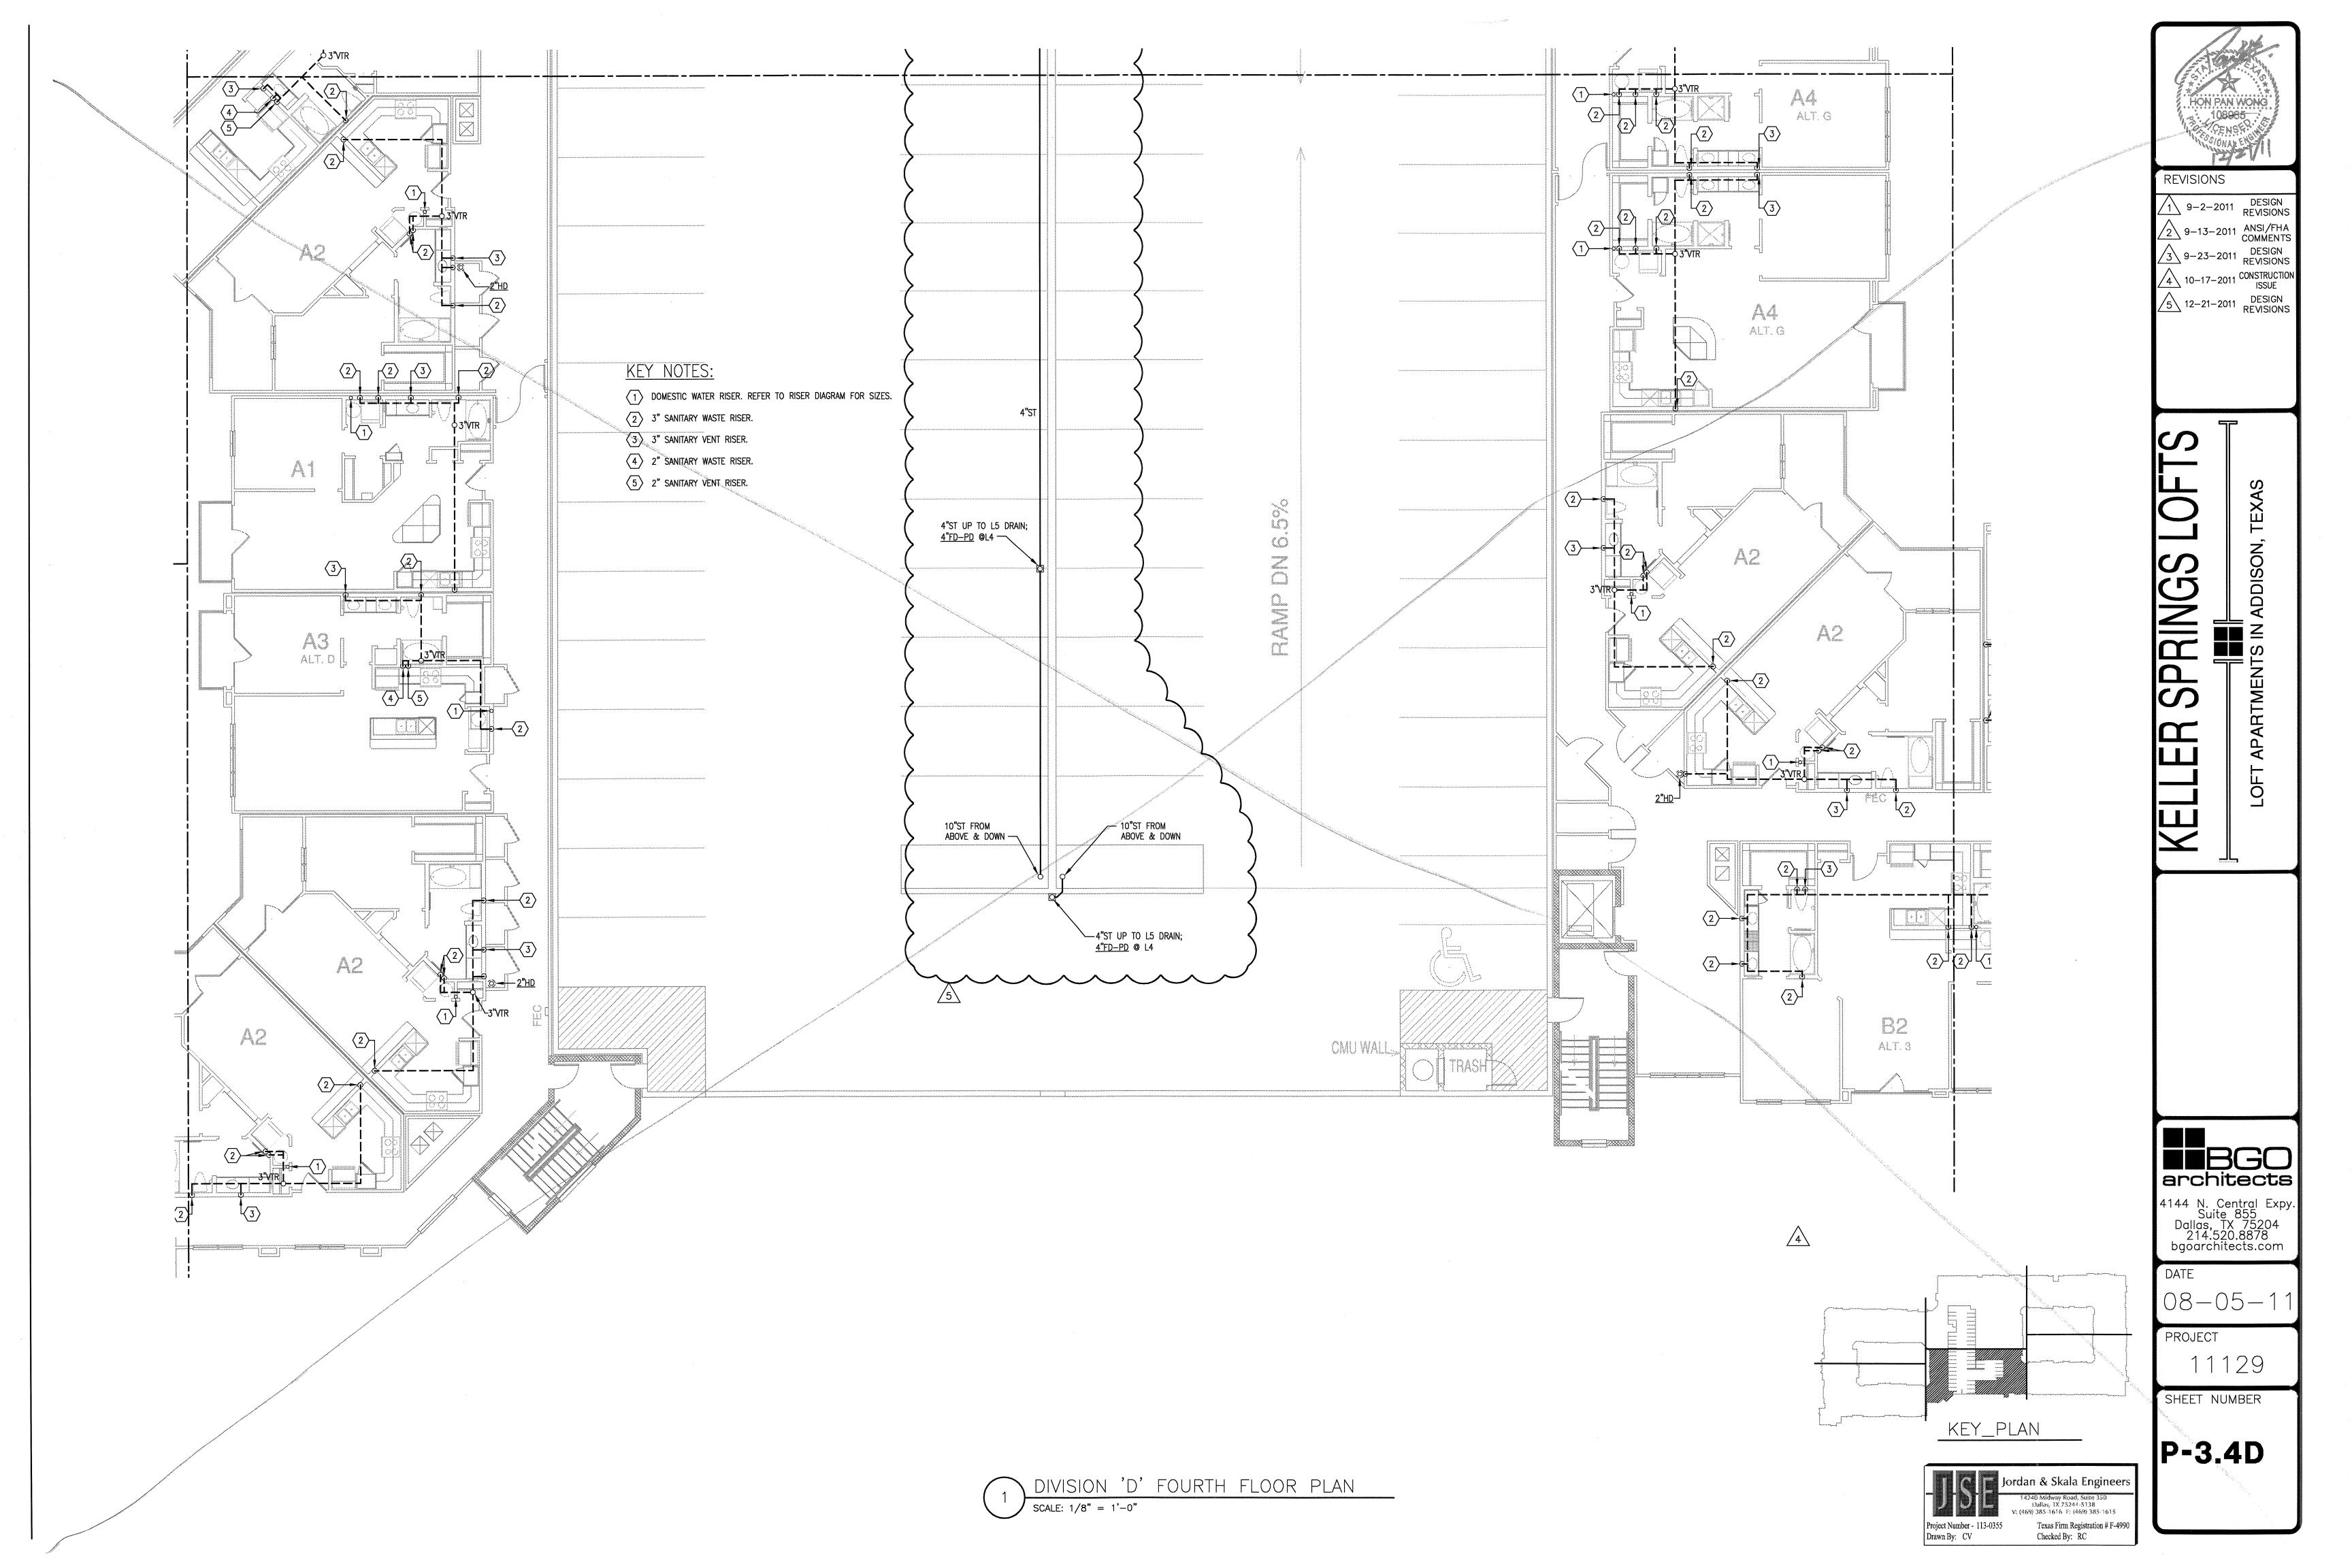

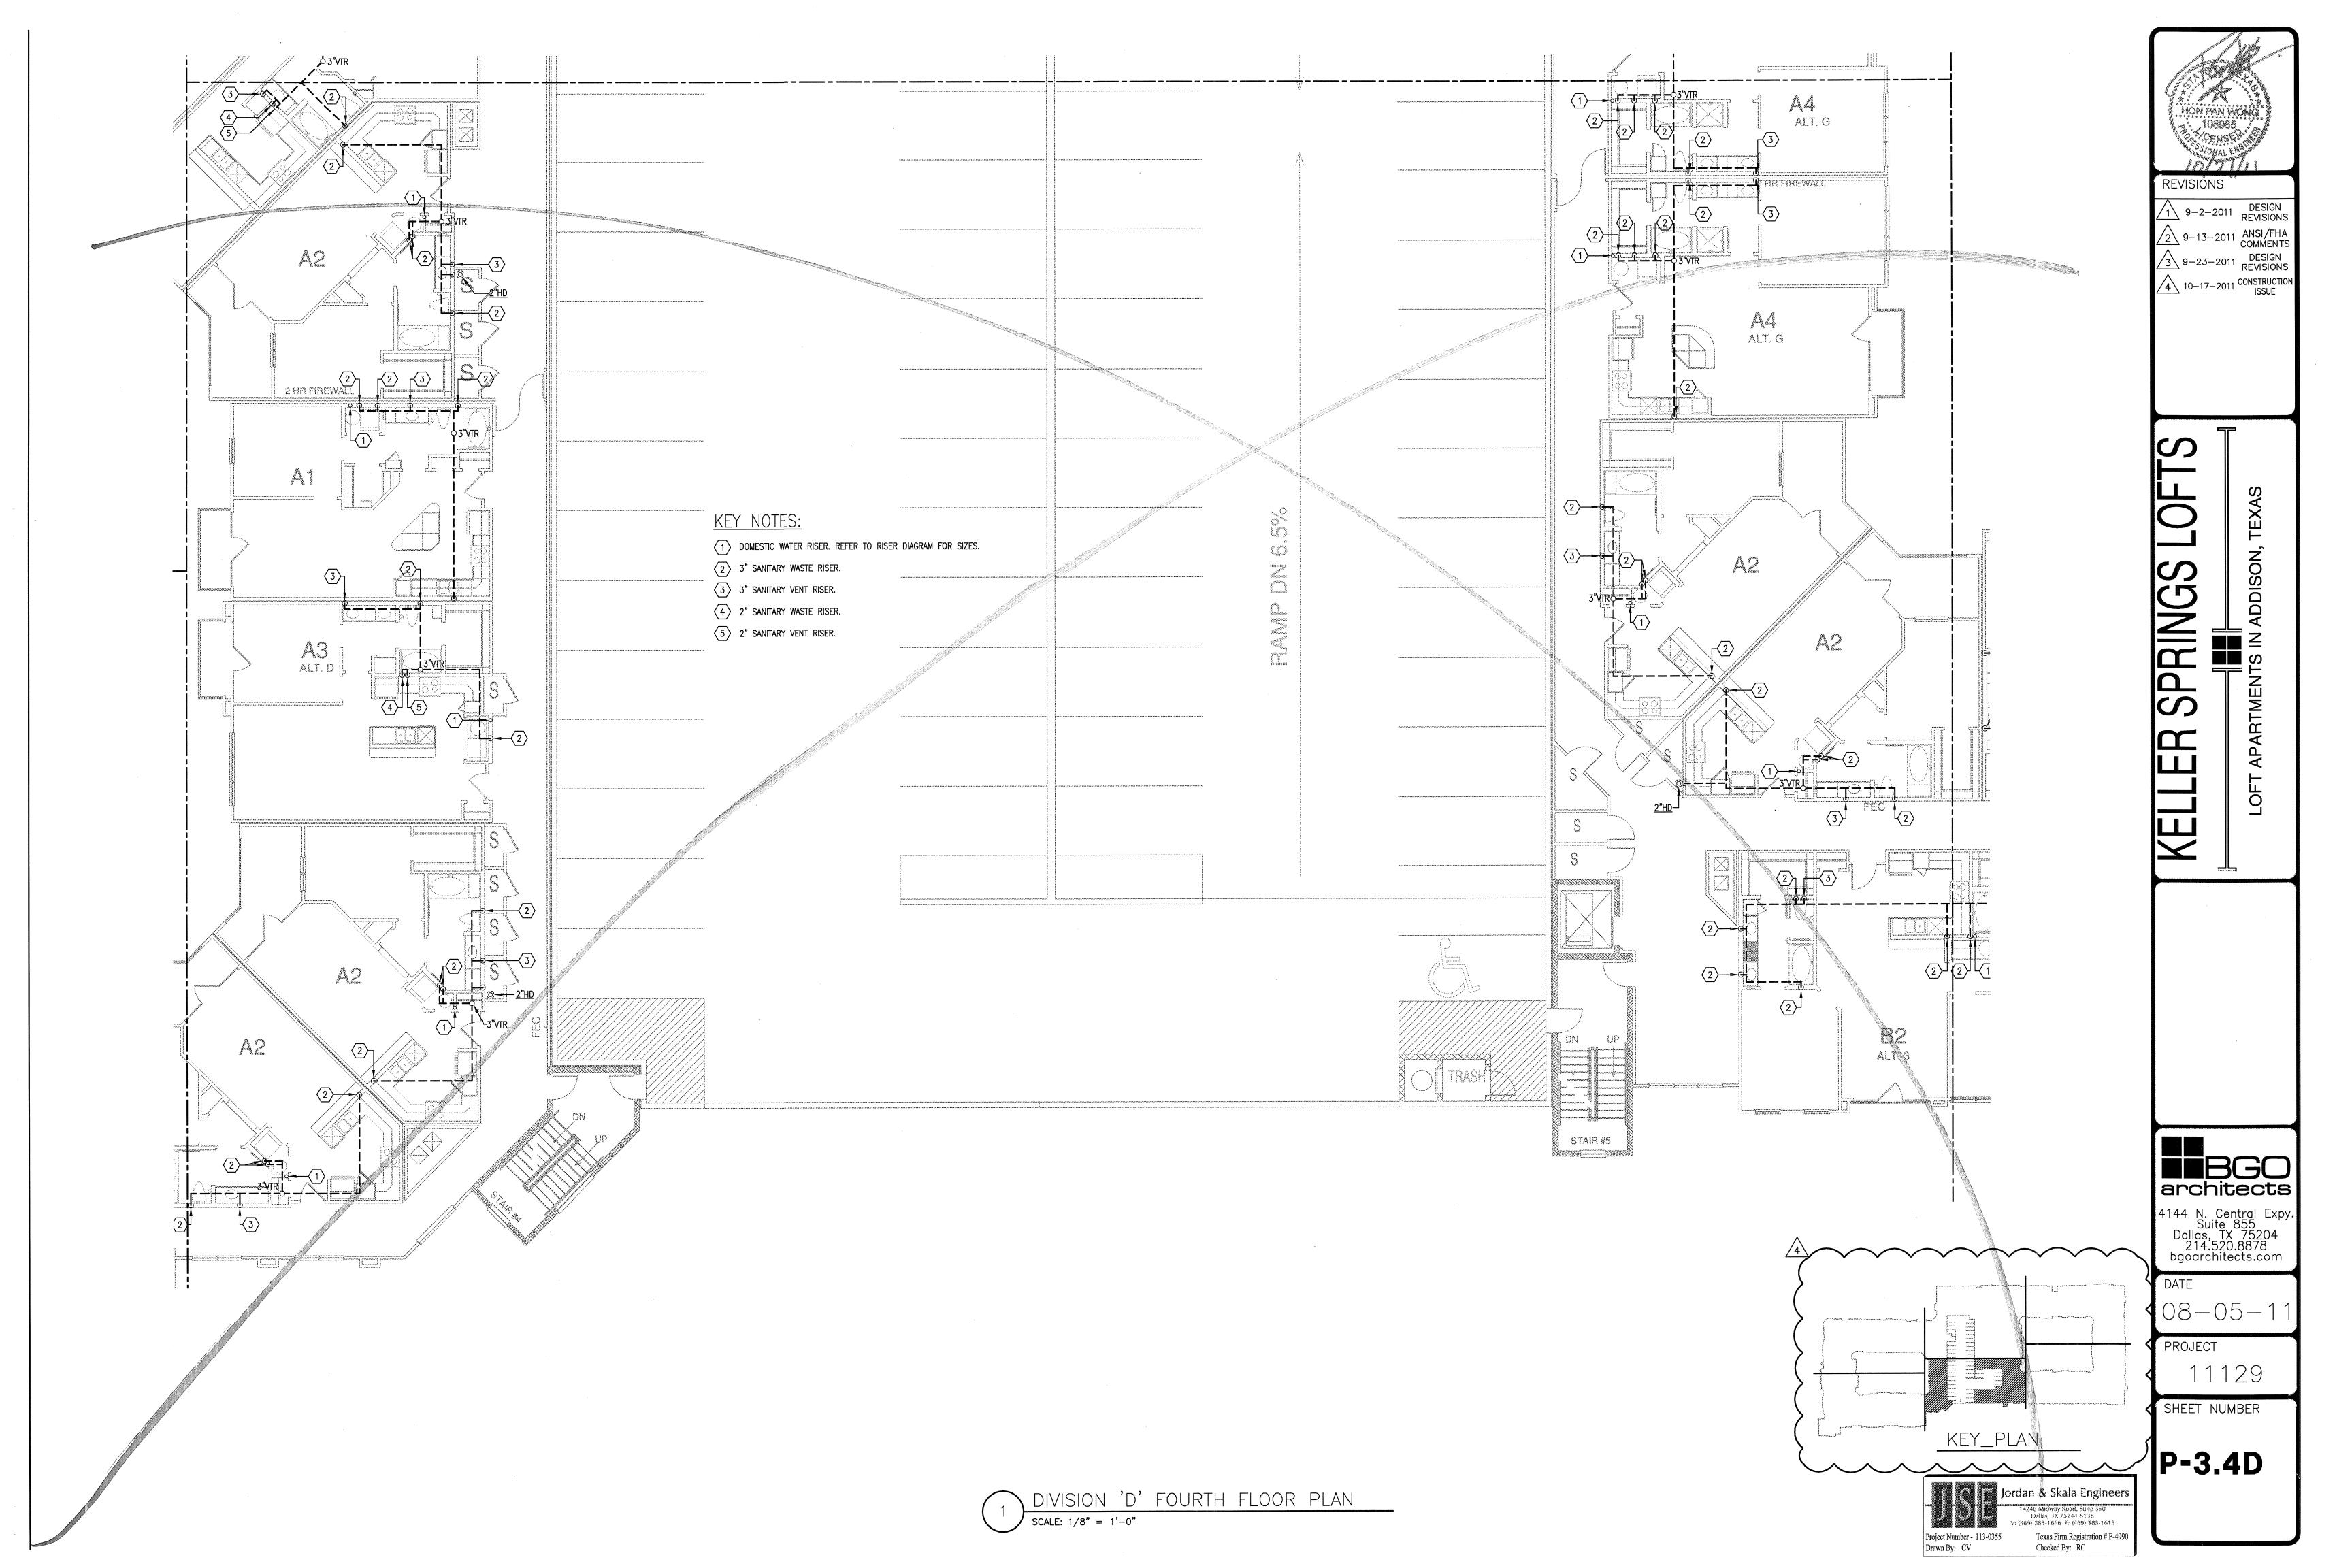

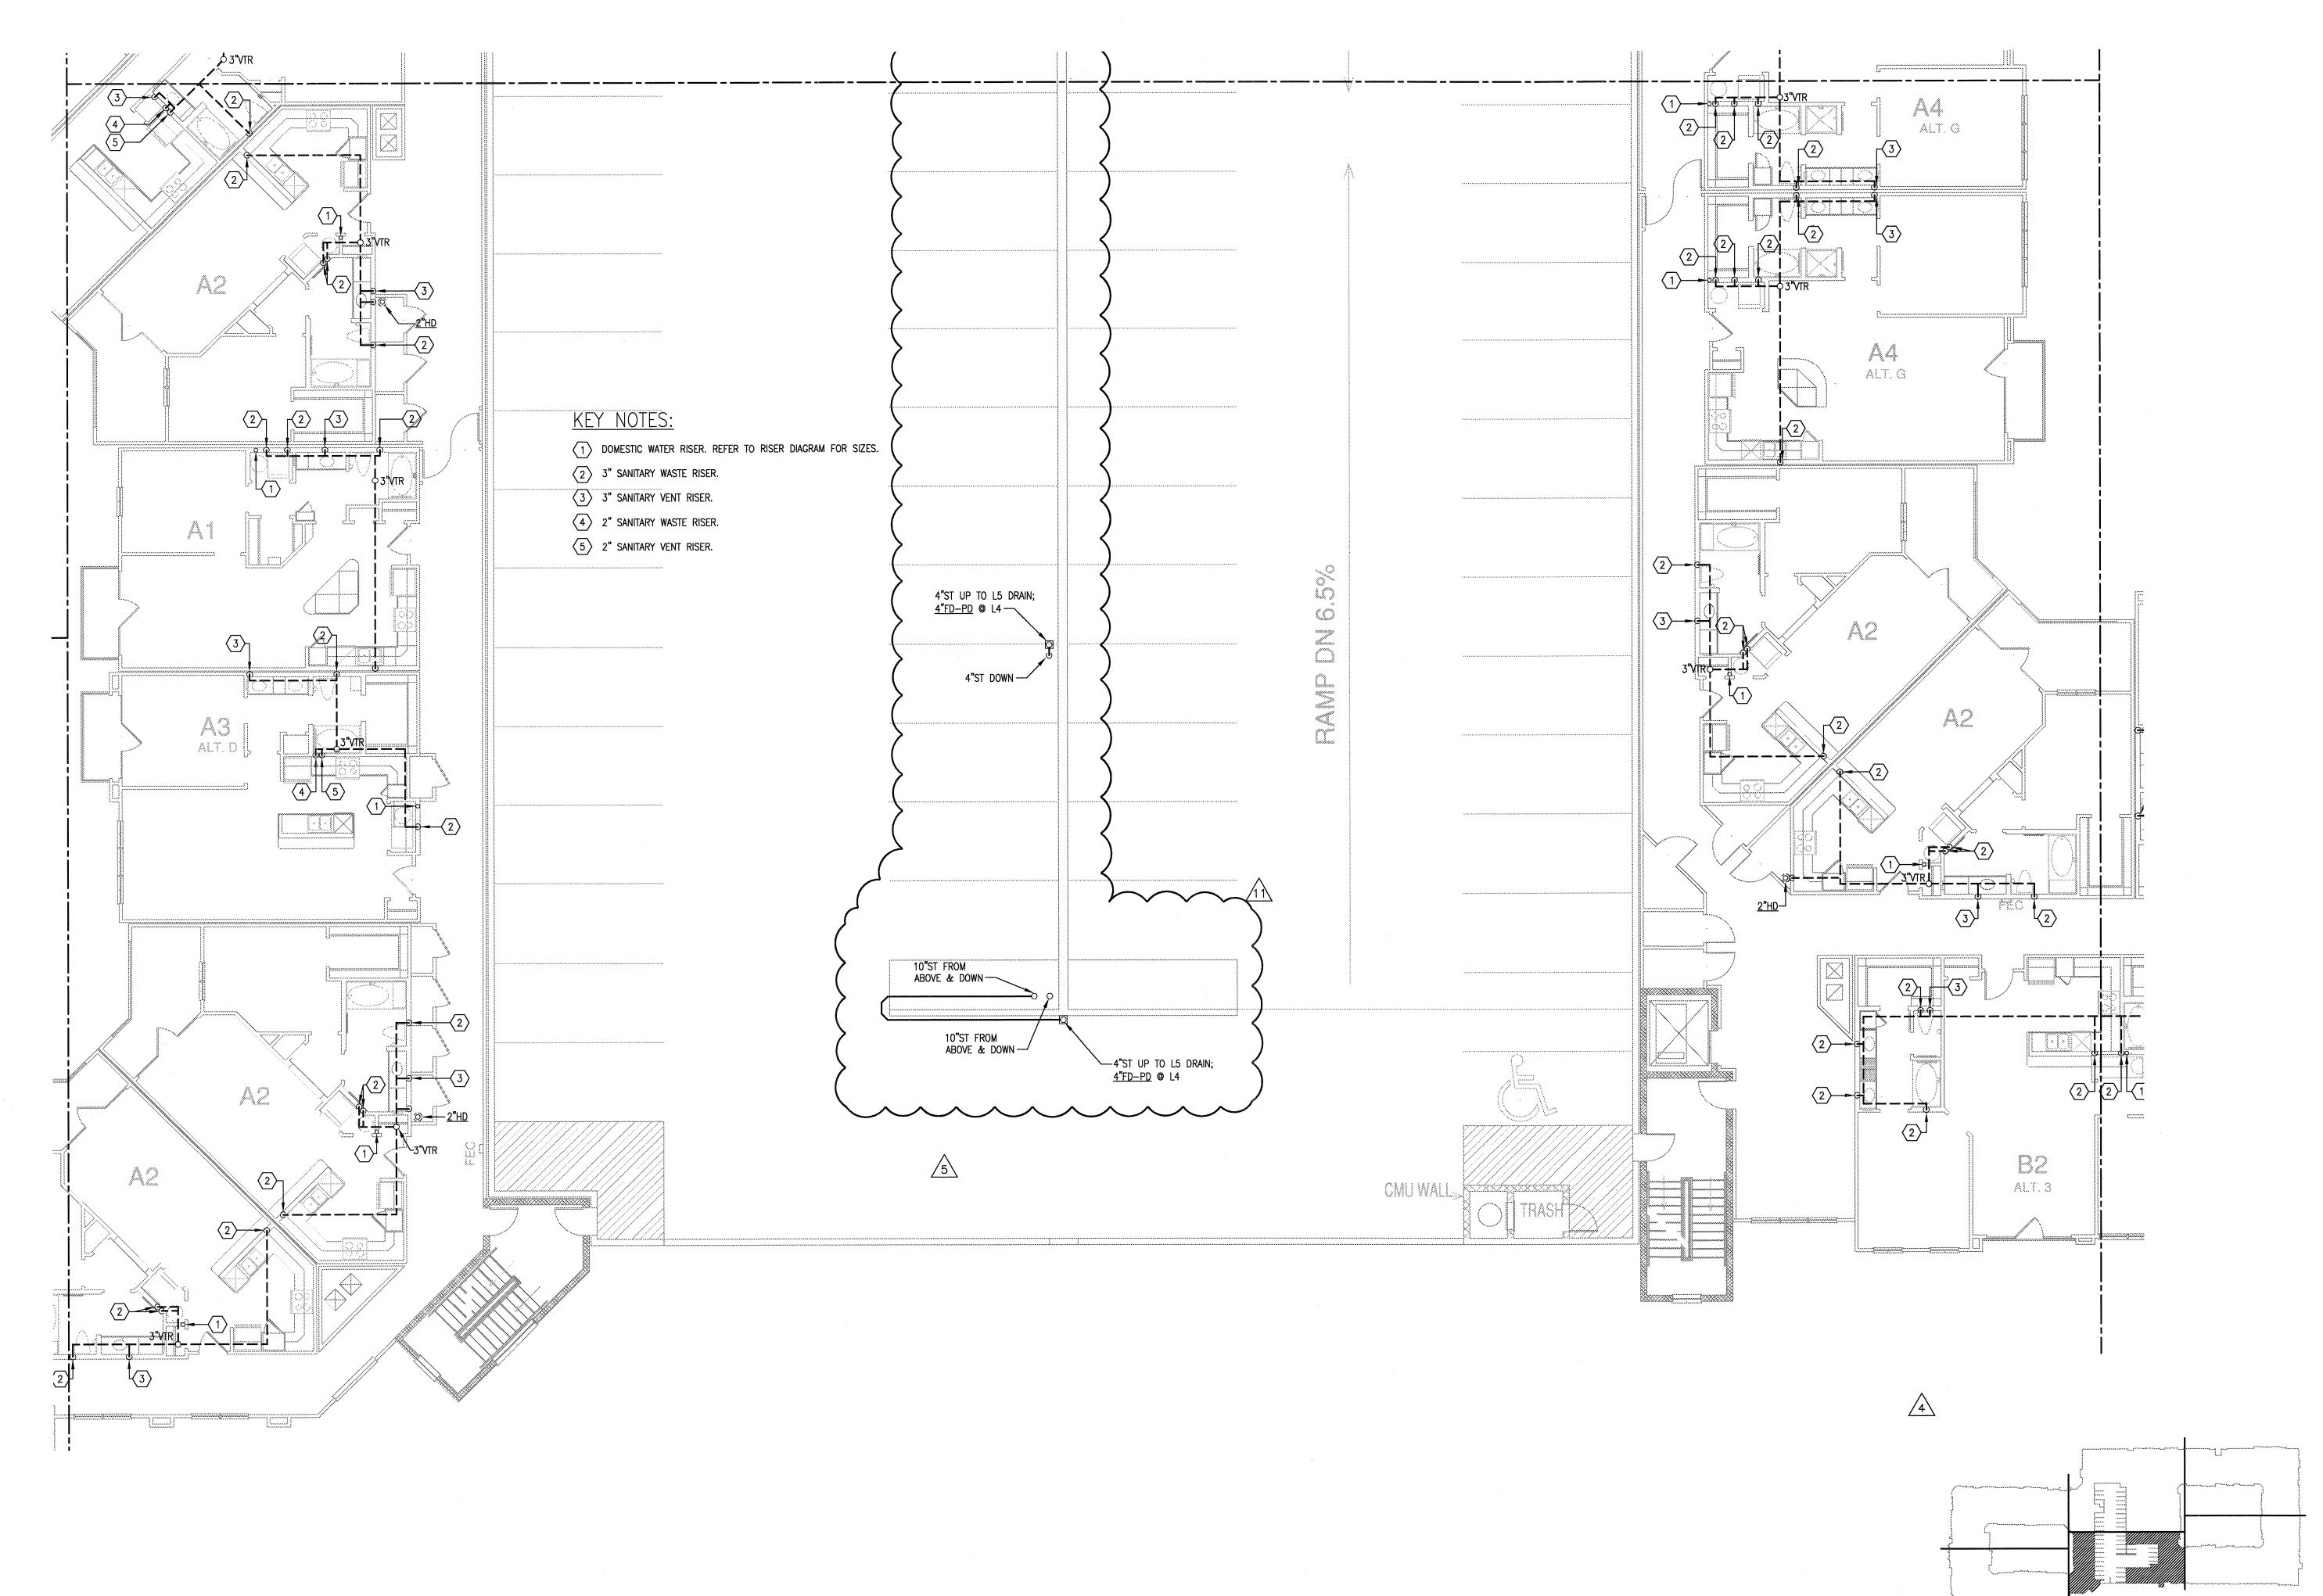

HON PAN WONG 108965 STV35-87/2

REVISIONS

9-2-2011 DESIGN REVISIONS
2 9-13-2011 ANSI/FHA COMMENTS DESIGN REVISIONS
3 9-23-2011 CONSTRUCTION ISSUE
5 12-21-2011 DESIGN REVISIONS
6 1-17-2012 DESIGN REVISIONS
7 DESIGN REVISIONS
7 TRANSFORMER
2-15-2012 REVISIONS
8 3-27-2012 CLUBHOUSE REVISIONS
4-17-2012

3-27-2012 REVISIONS
4-17-2012 COORDINATION

SYMPTOTIC SET IN THE PROPERTY OF T

5-15-2012 COORDINATION 5-30-2012 SITE COORDINATION

BGO architects

4144 N. Central Expy. Suite 855 Dallas, TX 75204 214.520.8878 bgoarchitects.com

DATE 08-05-1

PROJECT 11129

SHEET NUMBER


P-3.4D

KEY\_PLAN

Jordan & Skala Engineers

<sup>2</sup>855 N. Dallas Parkway., Suite 320 Dallas, TX 75287-6857

Texas Firm Registration # F-4990 Checked By: RC

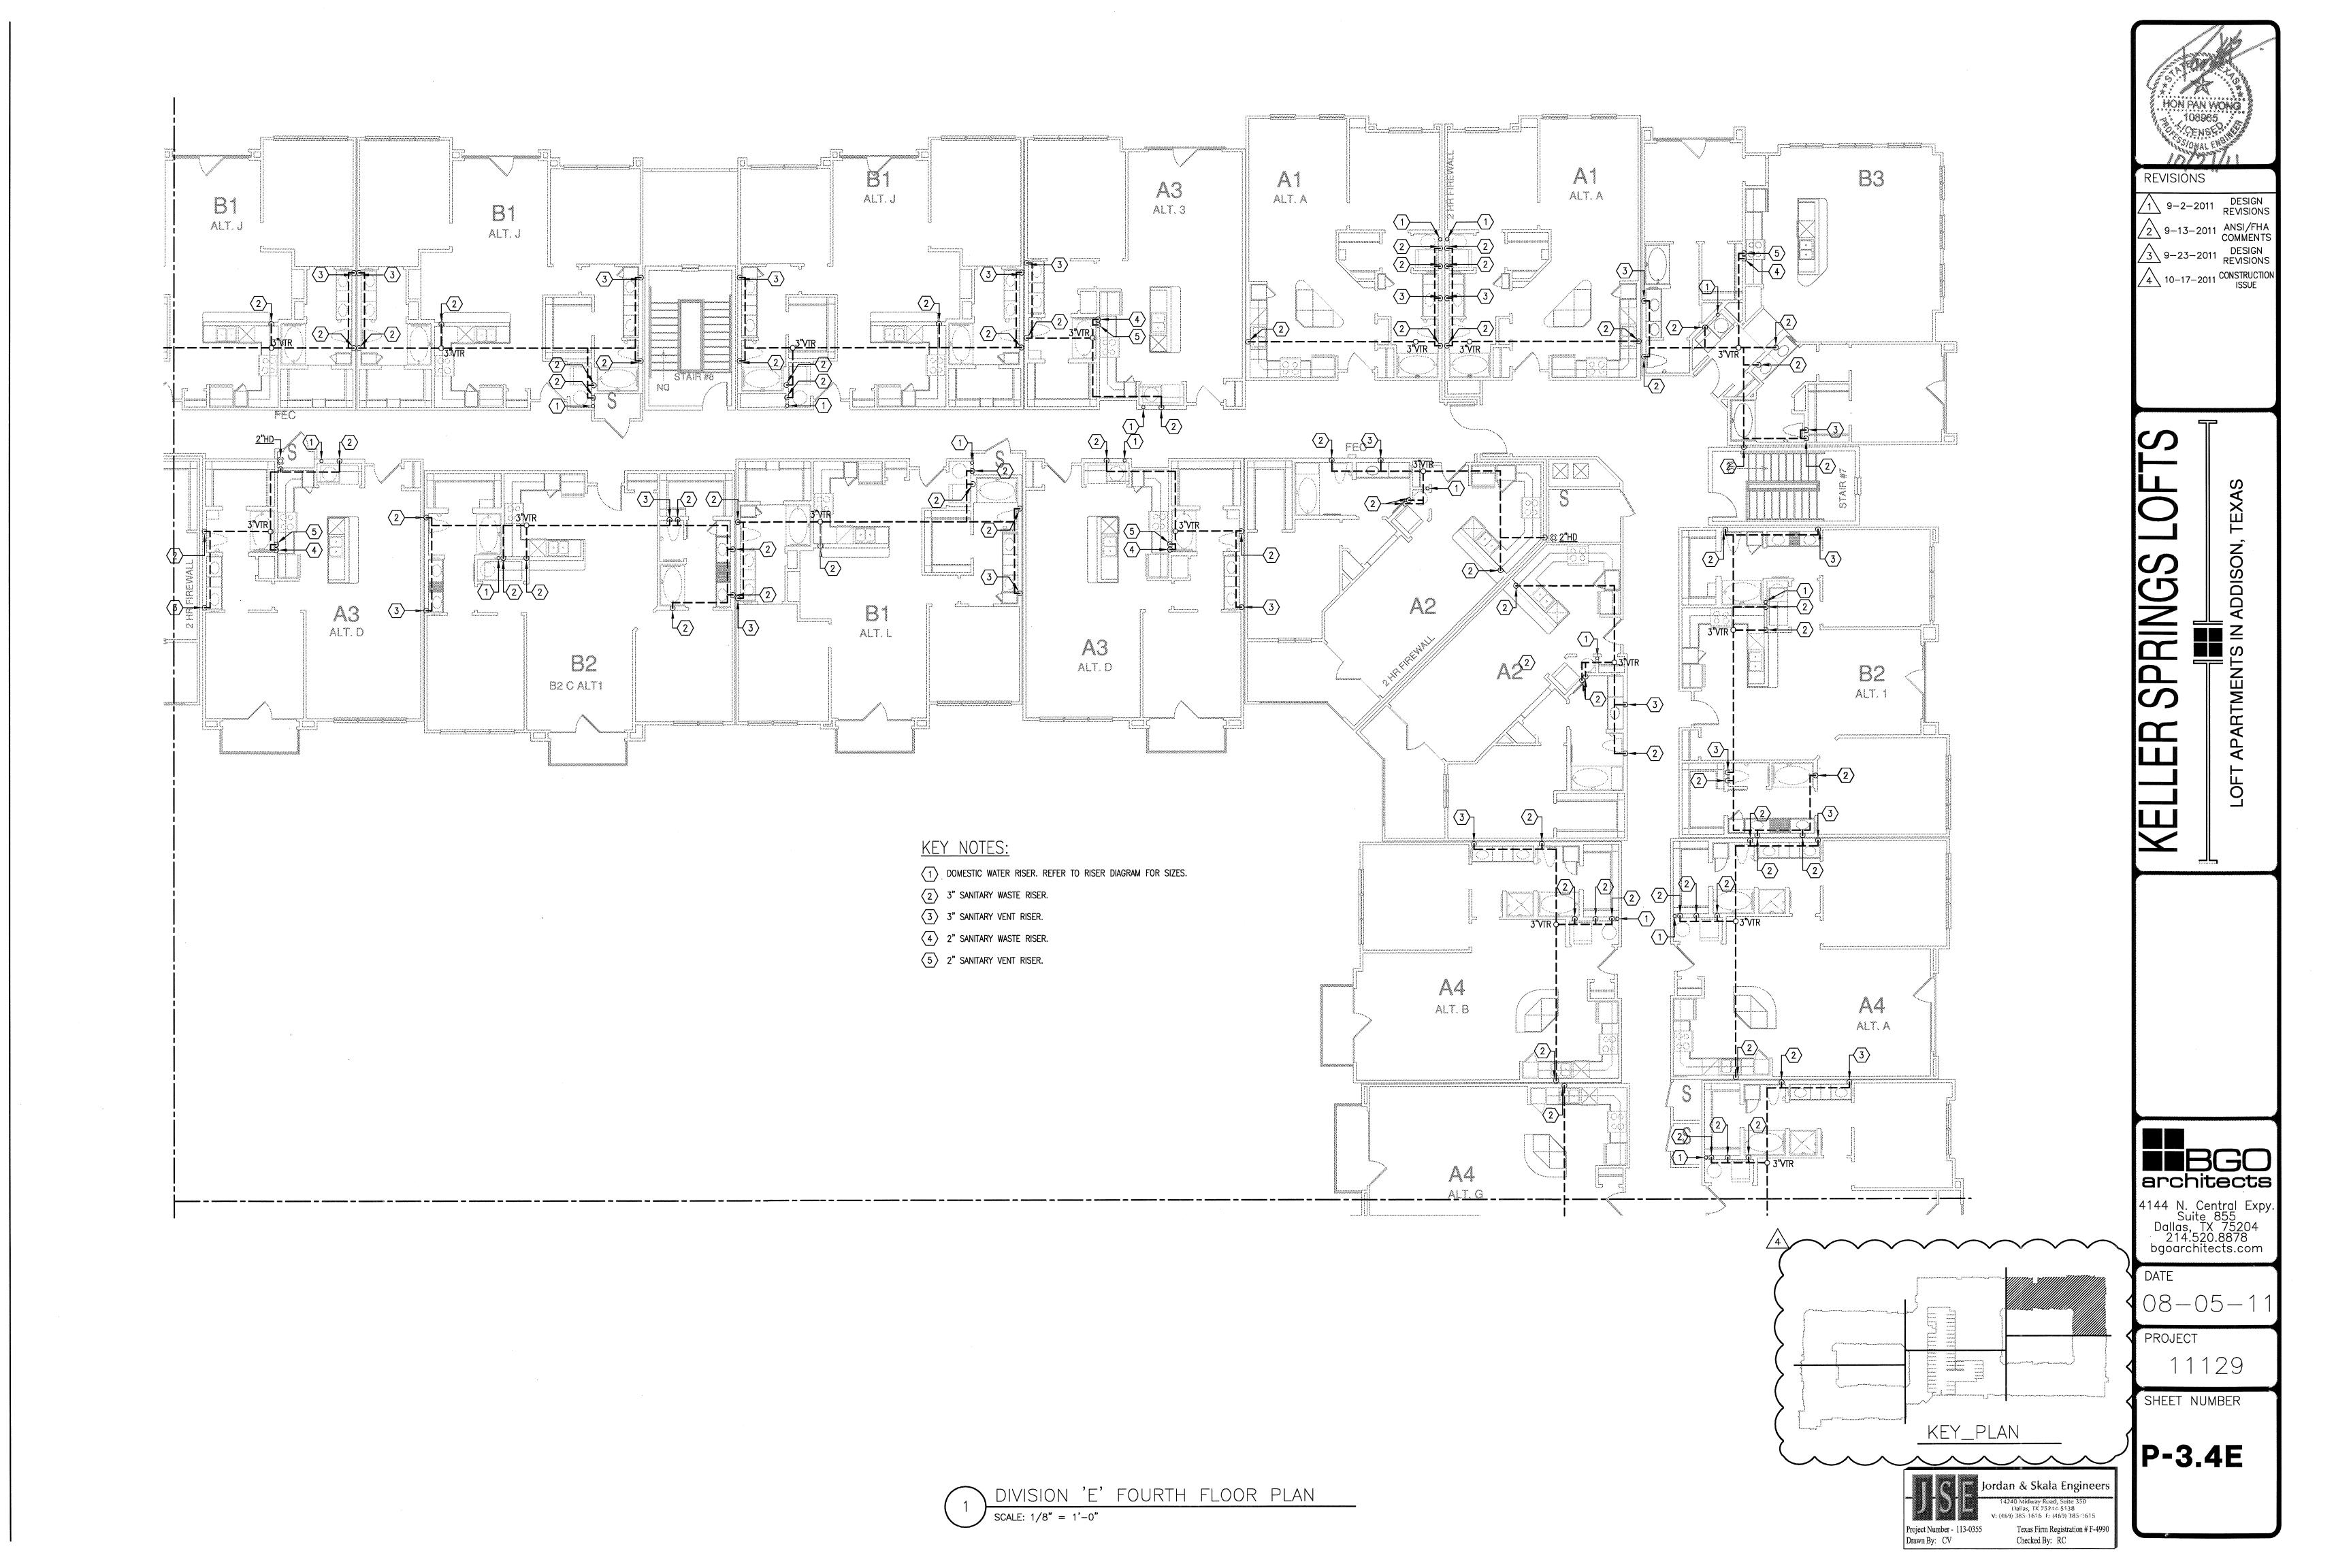

Embrey Builders, LLC 1020 N. E. Loop 410, Suite 700 San Antonio, TX 78209 Ph : (210) 824-6044 Fax: (210) 824-7656

RFI

To: Heath Parnell

Jordan & Skala Engineers, Inc. 14240 Midway Road, Suite 350 Dallas, TX 75244 Ph: 469/385-1616 Fax: 469/385-1615

RFI#: 201 Date: 10/23/2012 Job: EB-02 Keller Springs Lofts Phone: 877-777-5115

cc: Walter Kilroy (BGO)

Subject: Roof drains for the radius tower

Drawing: P3.5A, 3.5A

Spec Section: Schedule Impact: None

Cost Impact: None

Date Required: 10/26/2012 During an on-site meeting with Walter Kilroy and Ryan Faulds of BGO Architect it was determined that we would use a drain and overflow on top of the radius located on the northwest corner of the west building. The plans showed (2) scuppers with downspouts which would not work because of the exterior angle on the radius feature. It was decided that the drain line would be located inside the radius tower until it penetrated the side of the radius tower just about the stucco receiver and drain onto the main roof. We will properly slope the roof and build crickets for the water to enter the drain. Please size and detail the drain and drain lines Jordan & Skala deems appropriate for this task. Request:


Requested by: Bryan Pickler Embrey Partners, Ltd.


it is recommended that 4" drains and drian lines be used for the tower. Roof drain shall be Jay R. Smith #1015 or equal and overflow drain shall be Jay R. Smith #1080 or equal. provide downspout nozzle Jay R Smith #1770 or equal at discharge point.


Answered by: Heath Parnell Jordan & Skala Engineers, Inc.


Answered date: October 24, 2012


Page 1 of 1

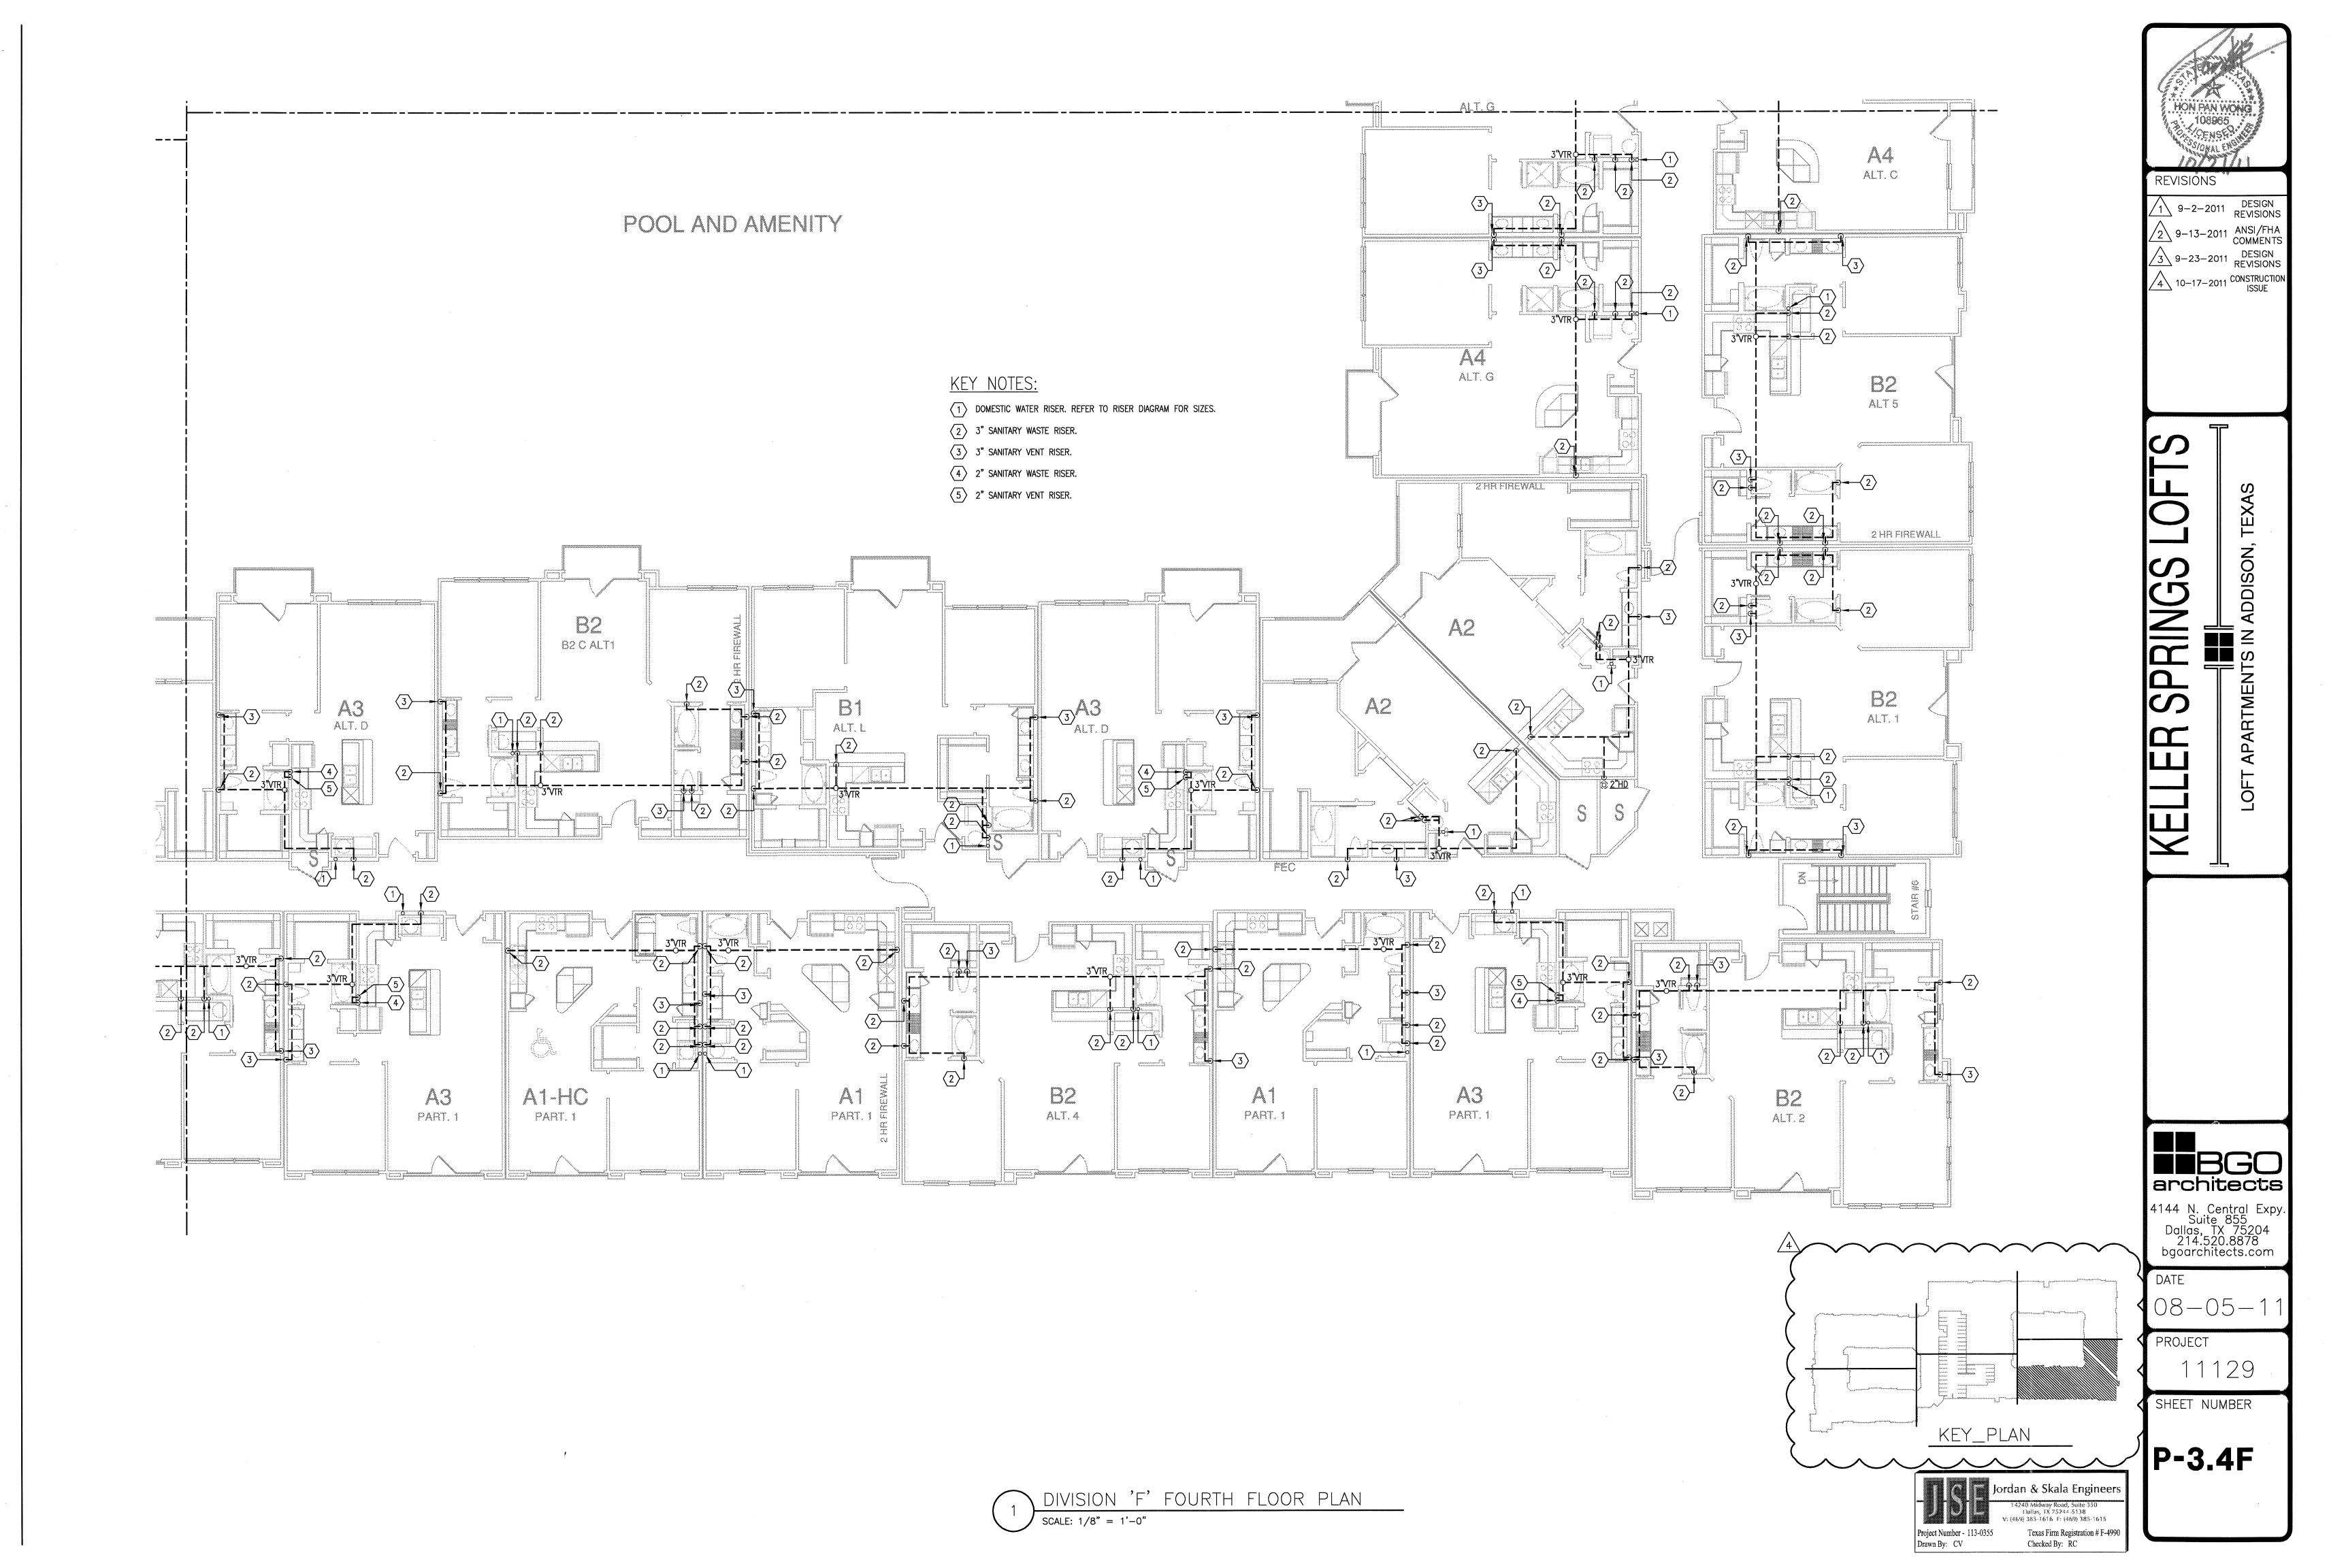


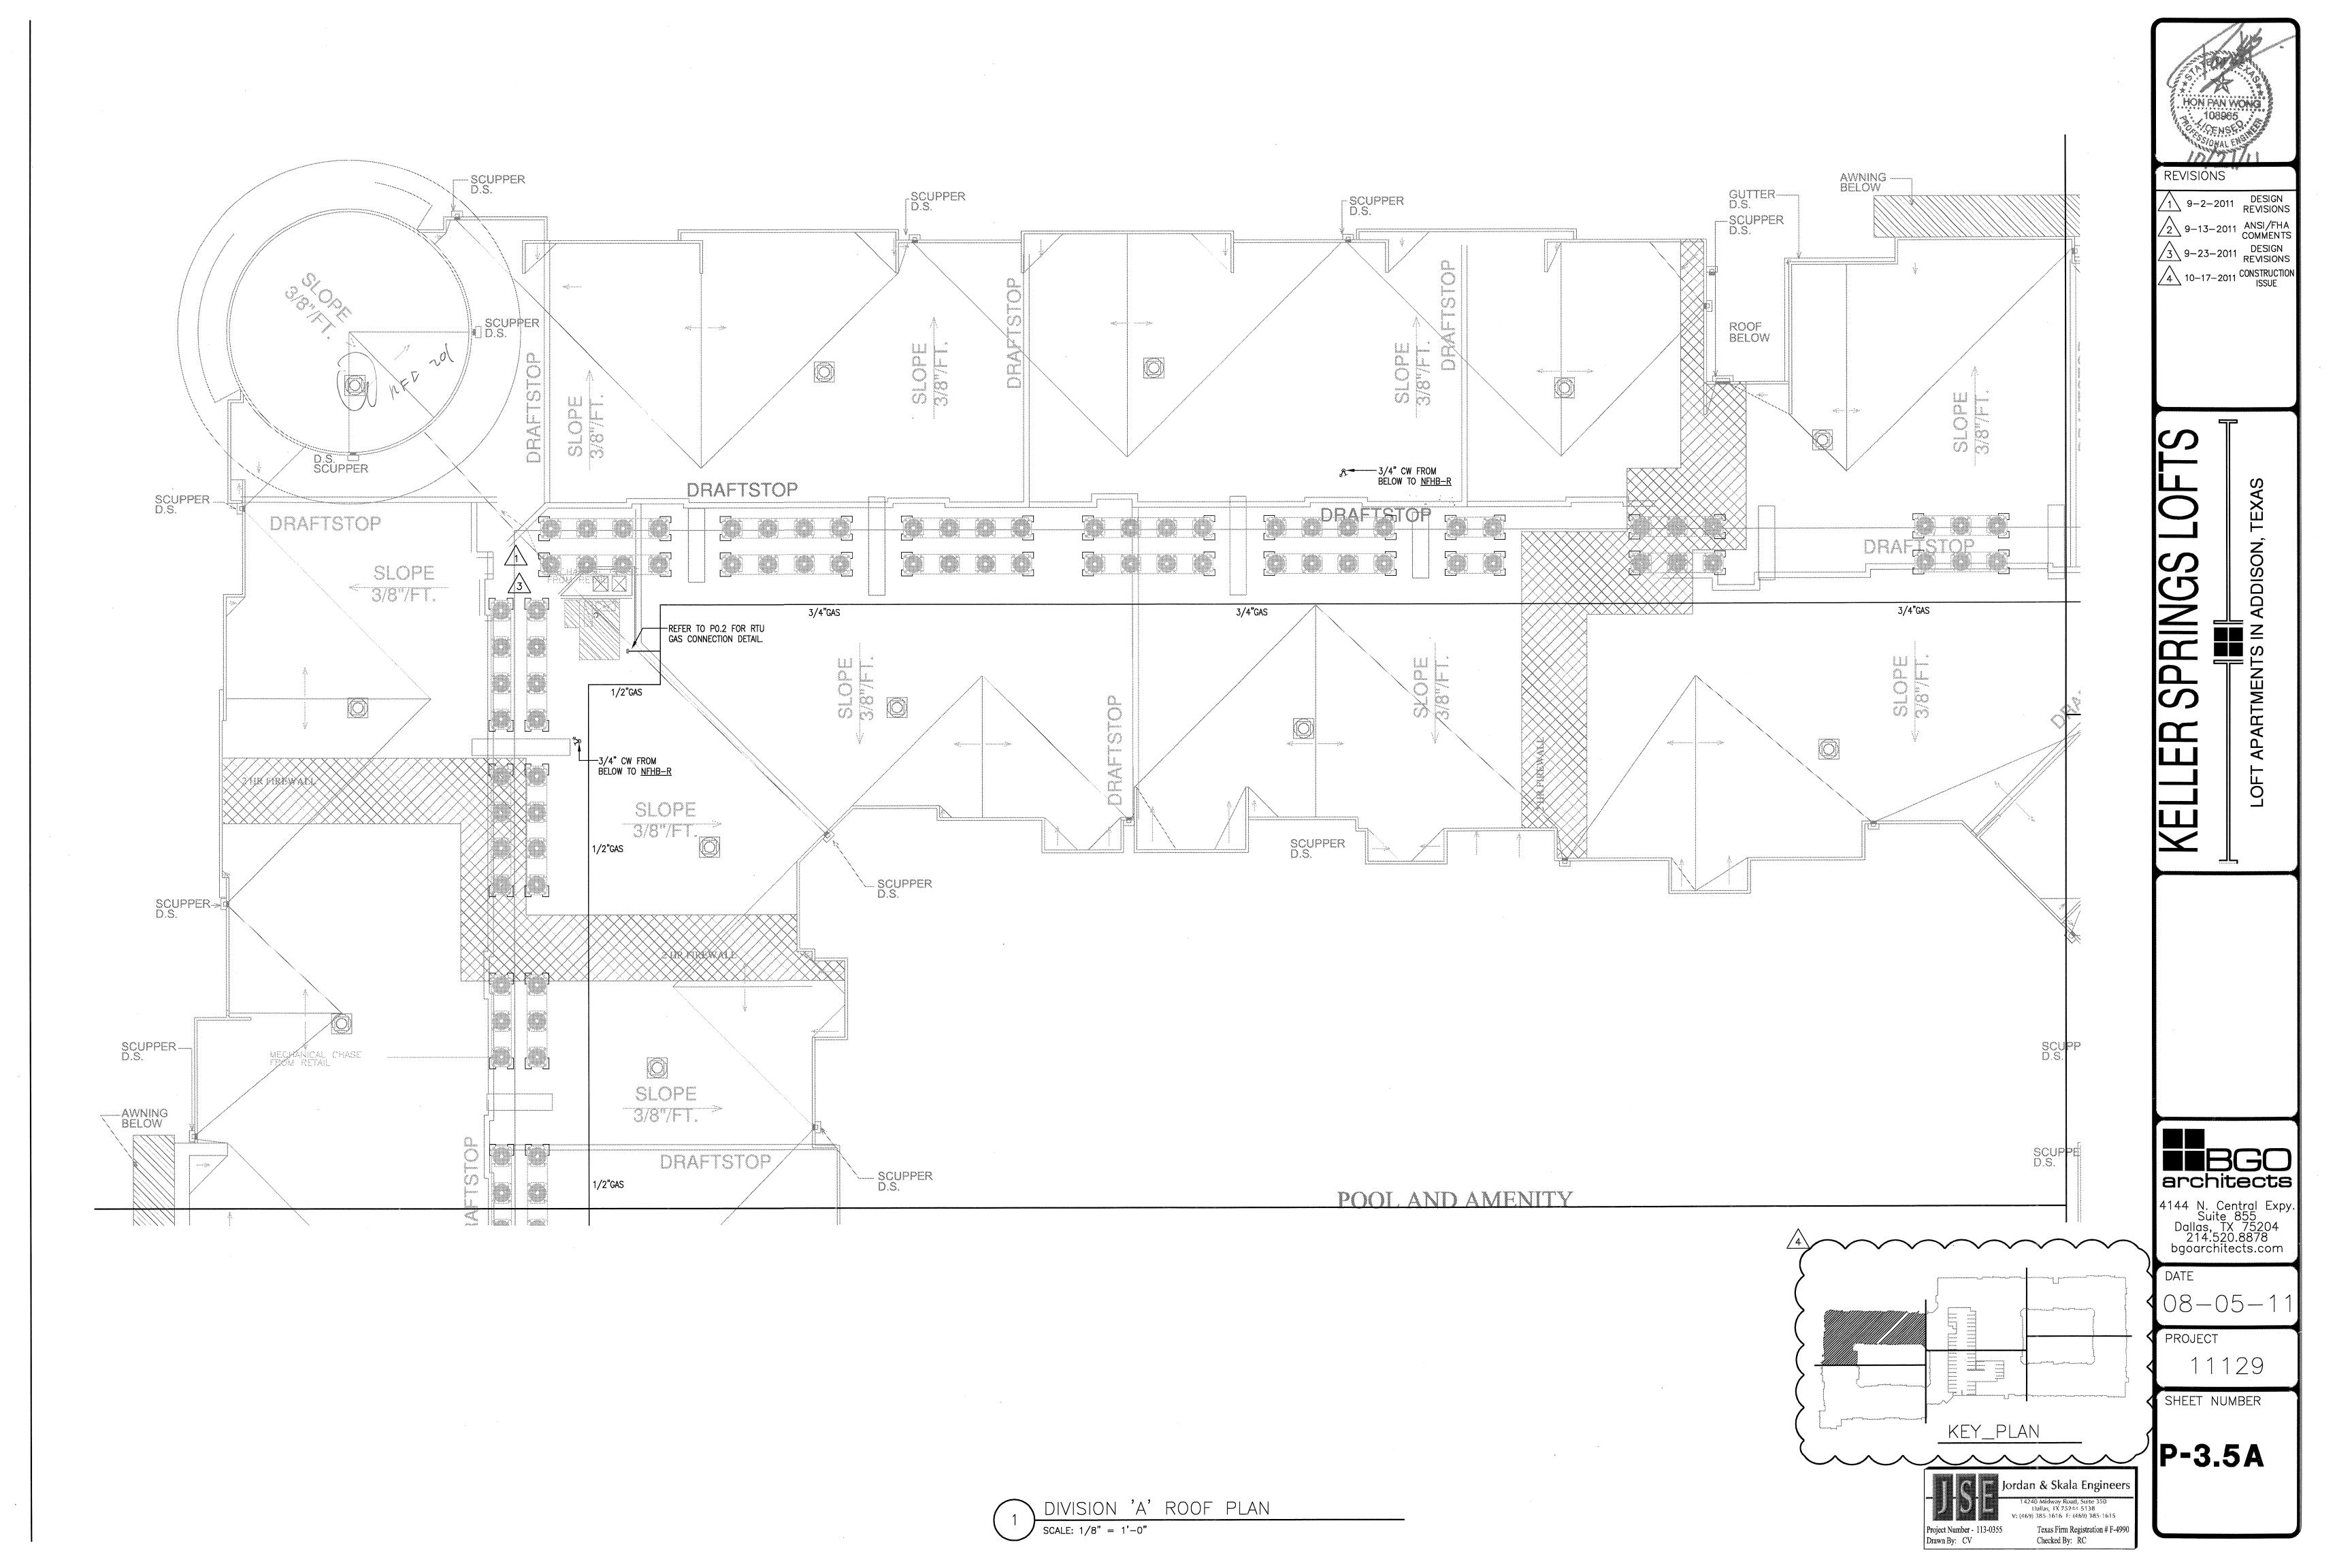


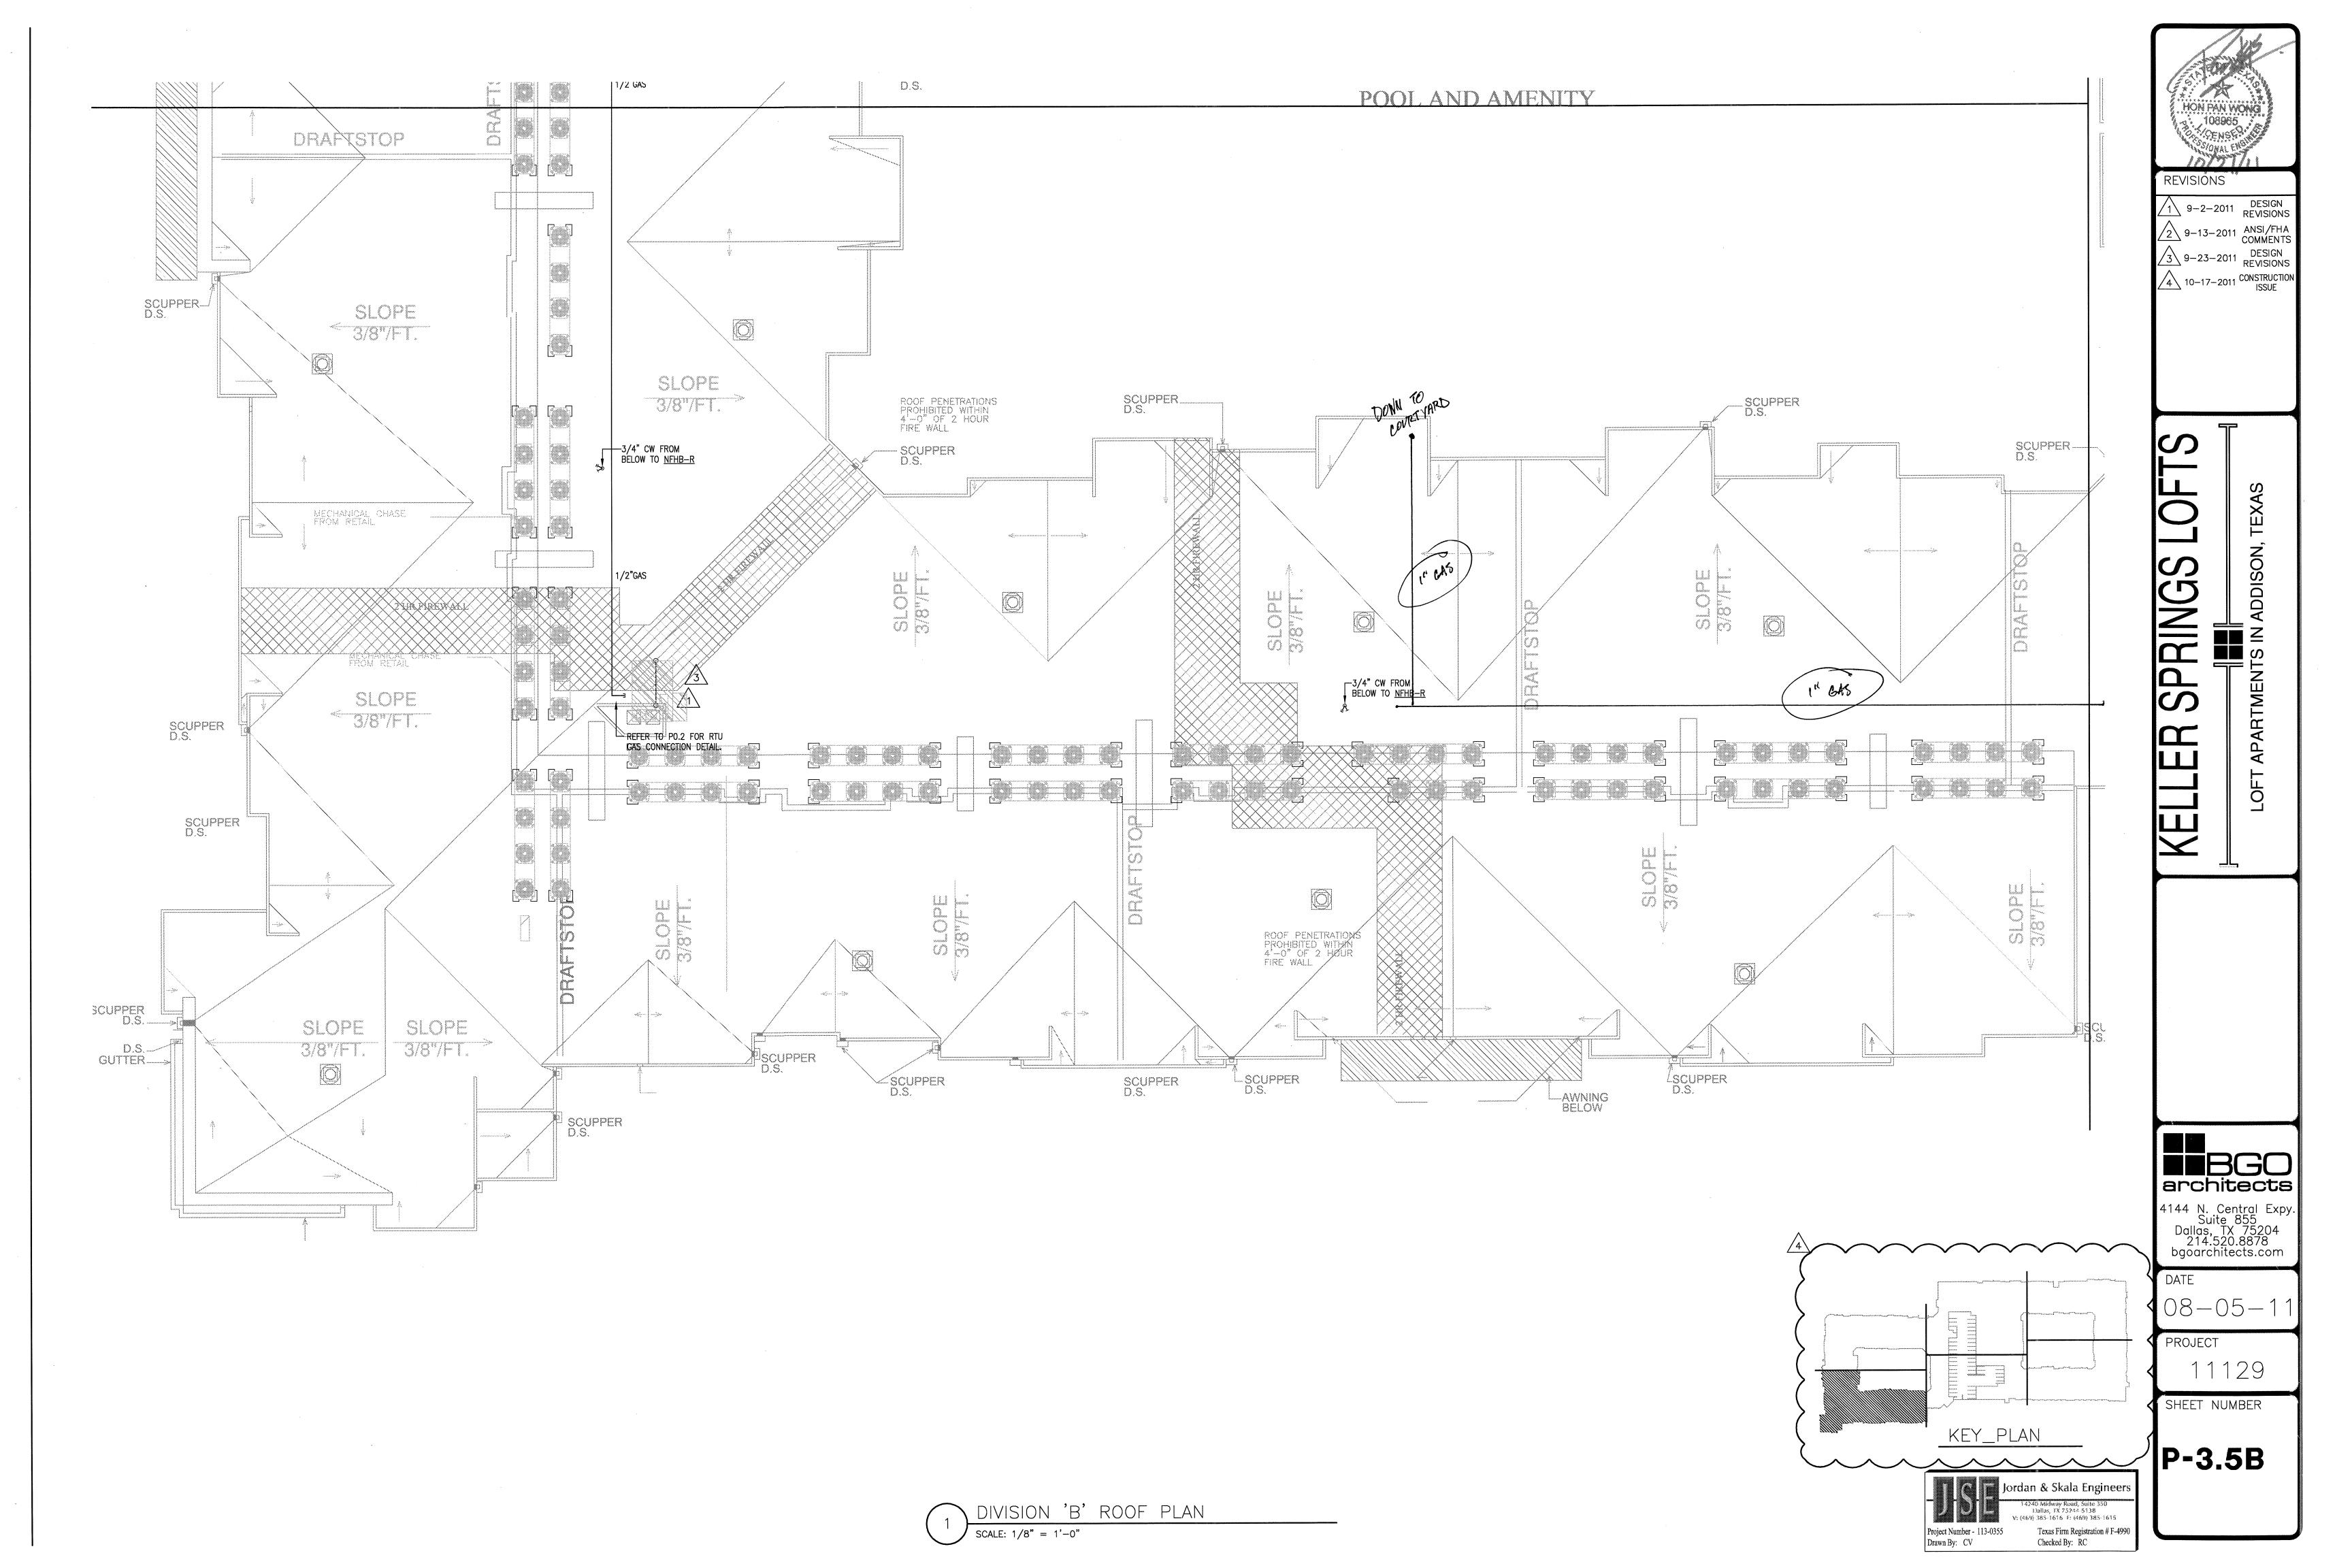


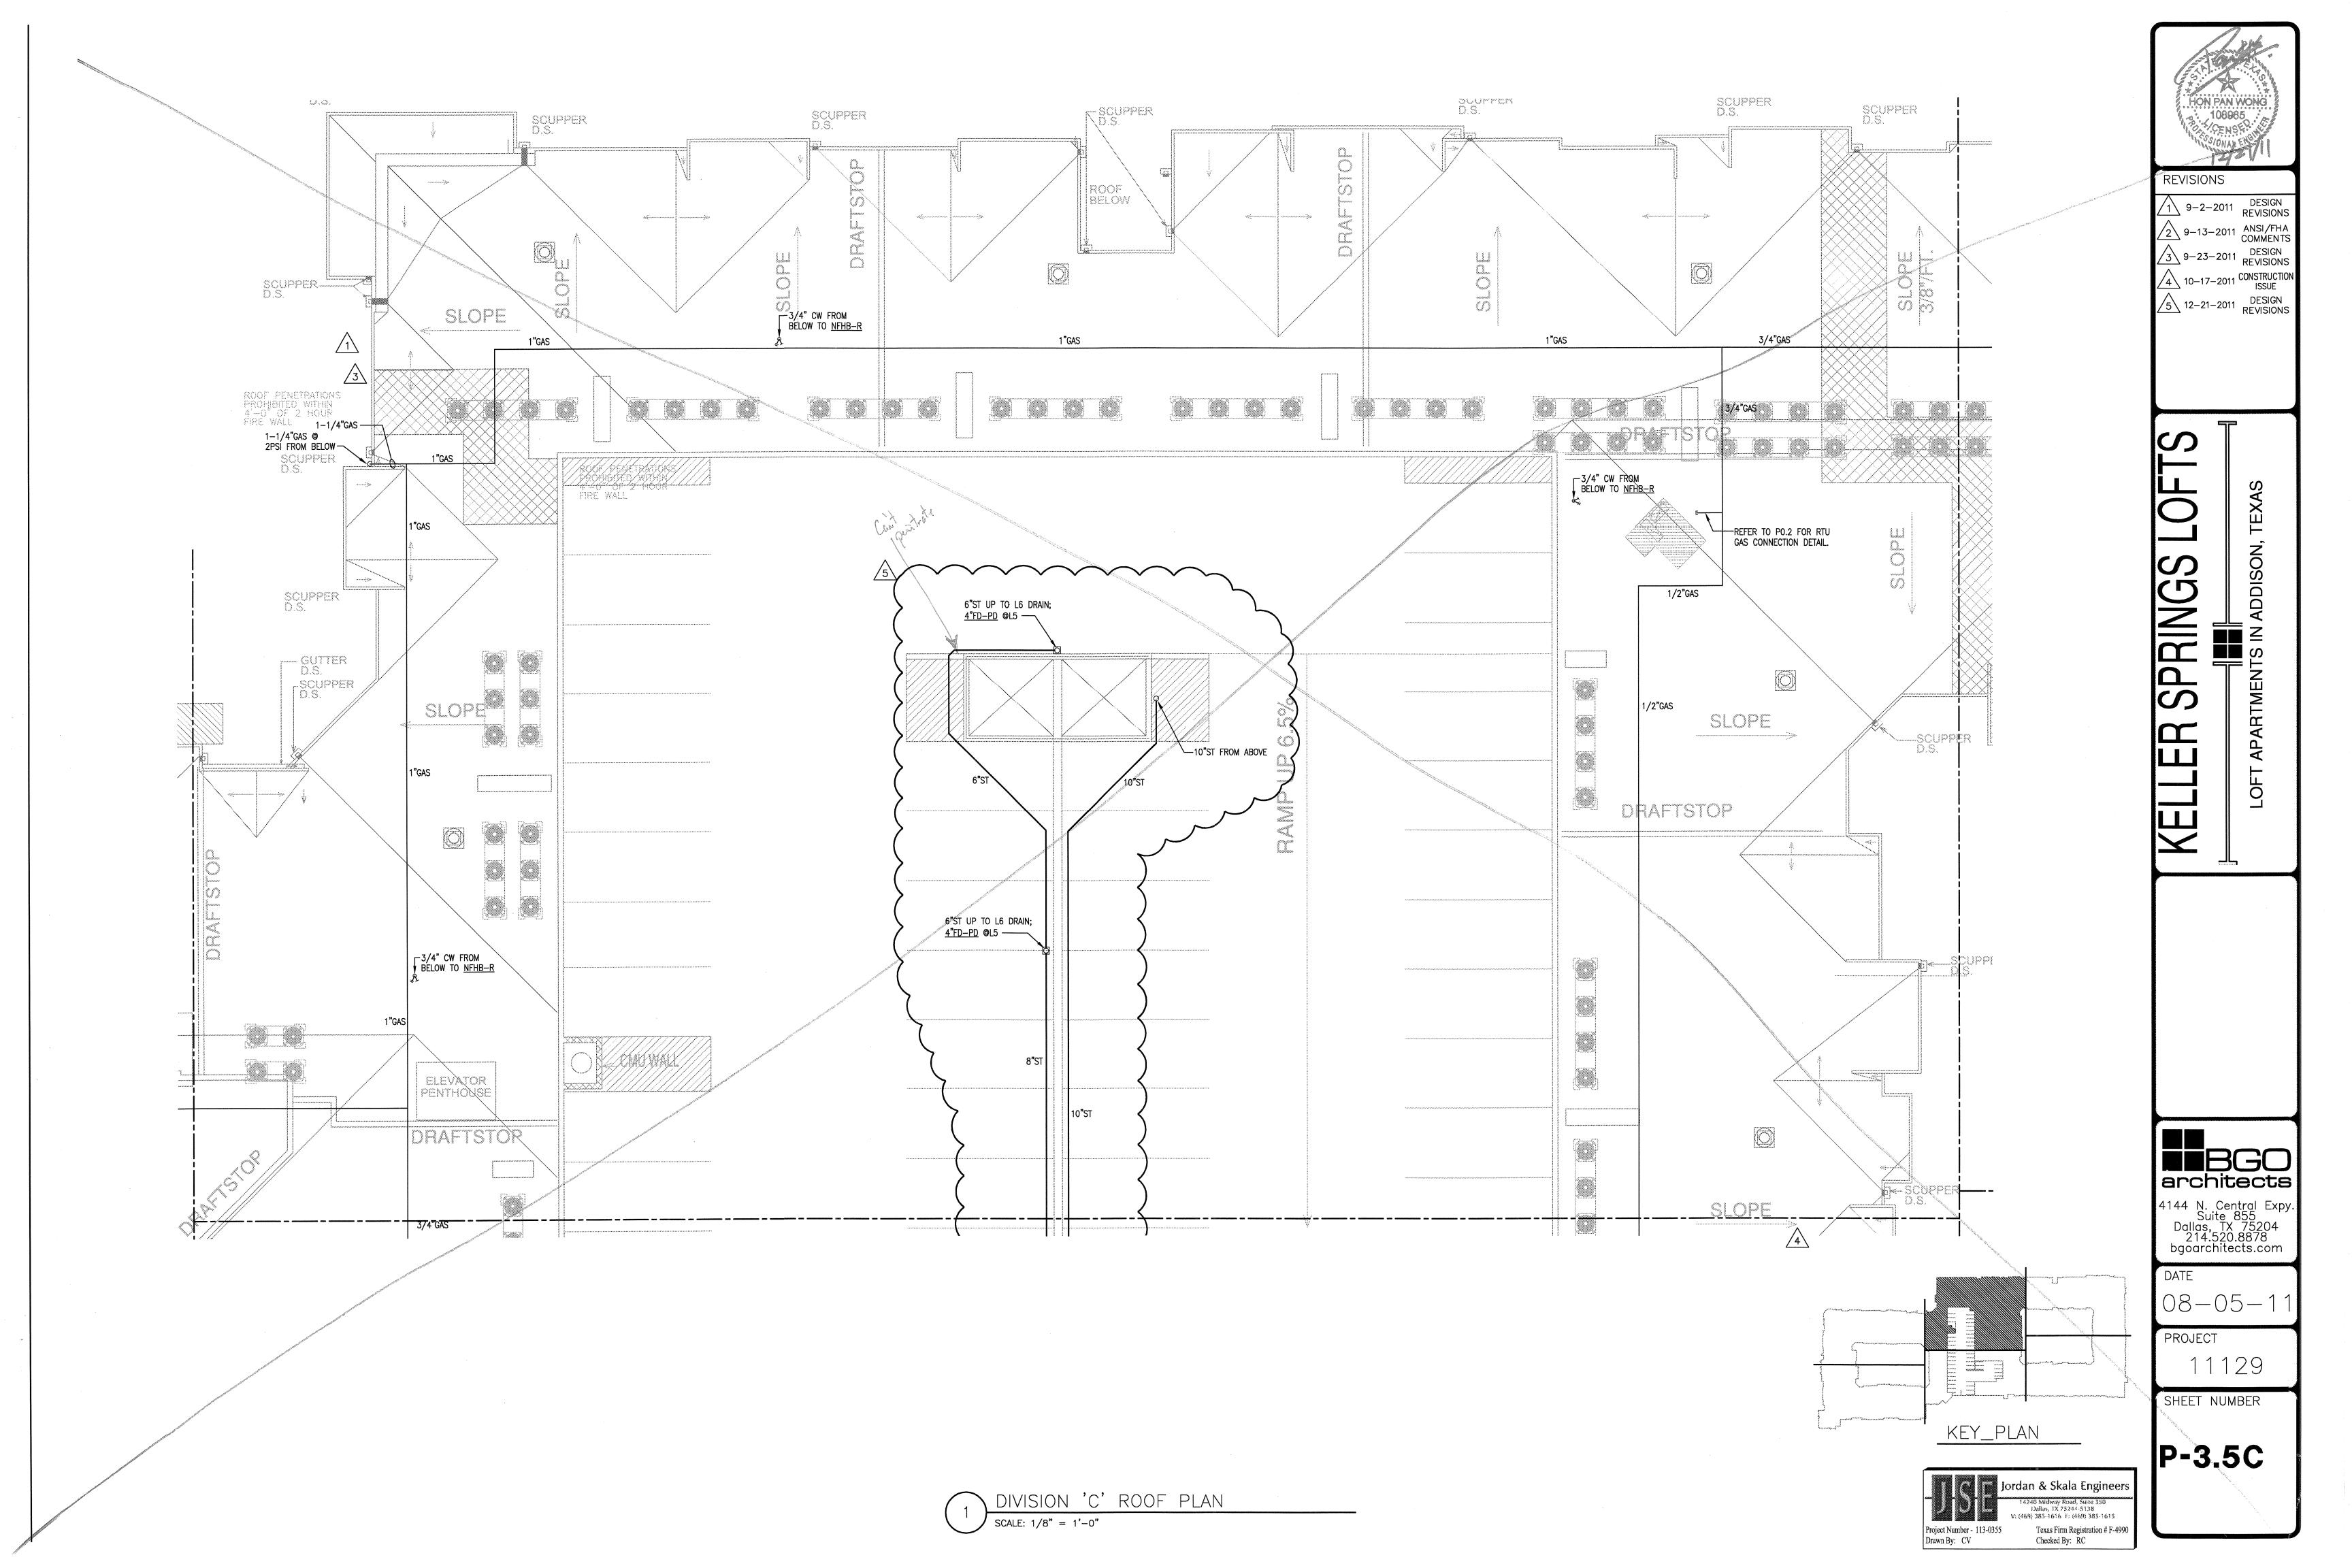

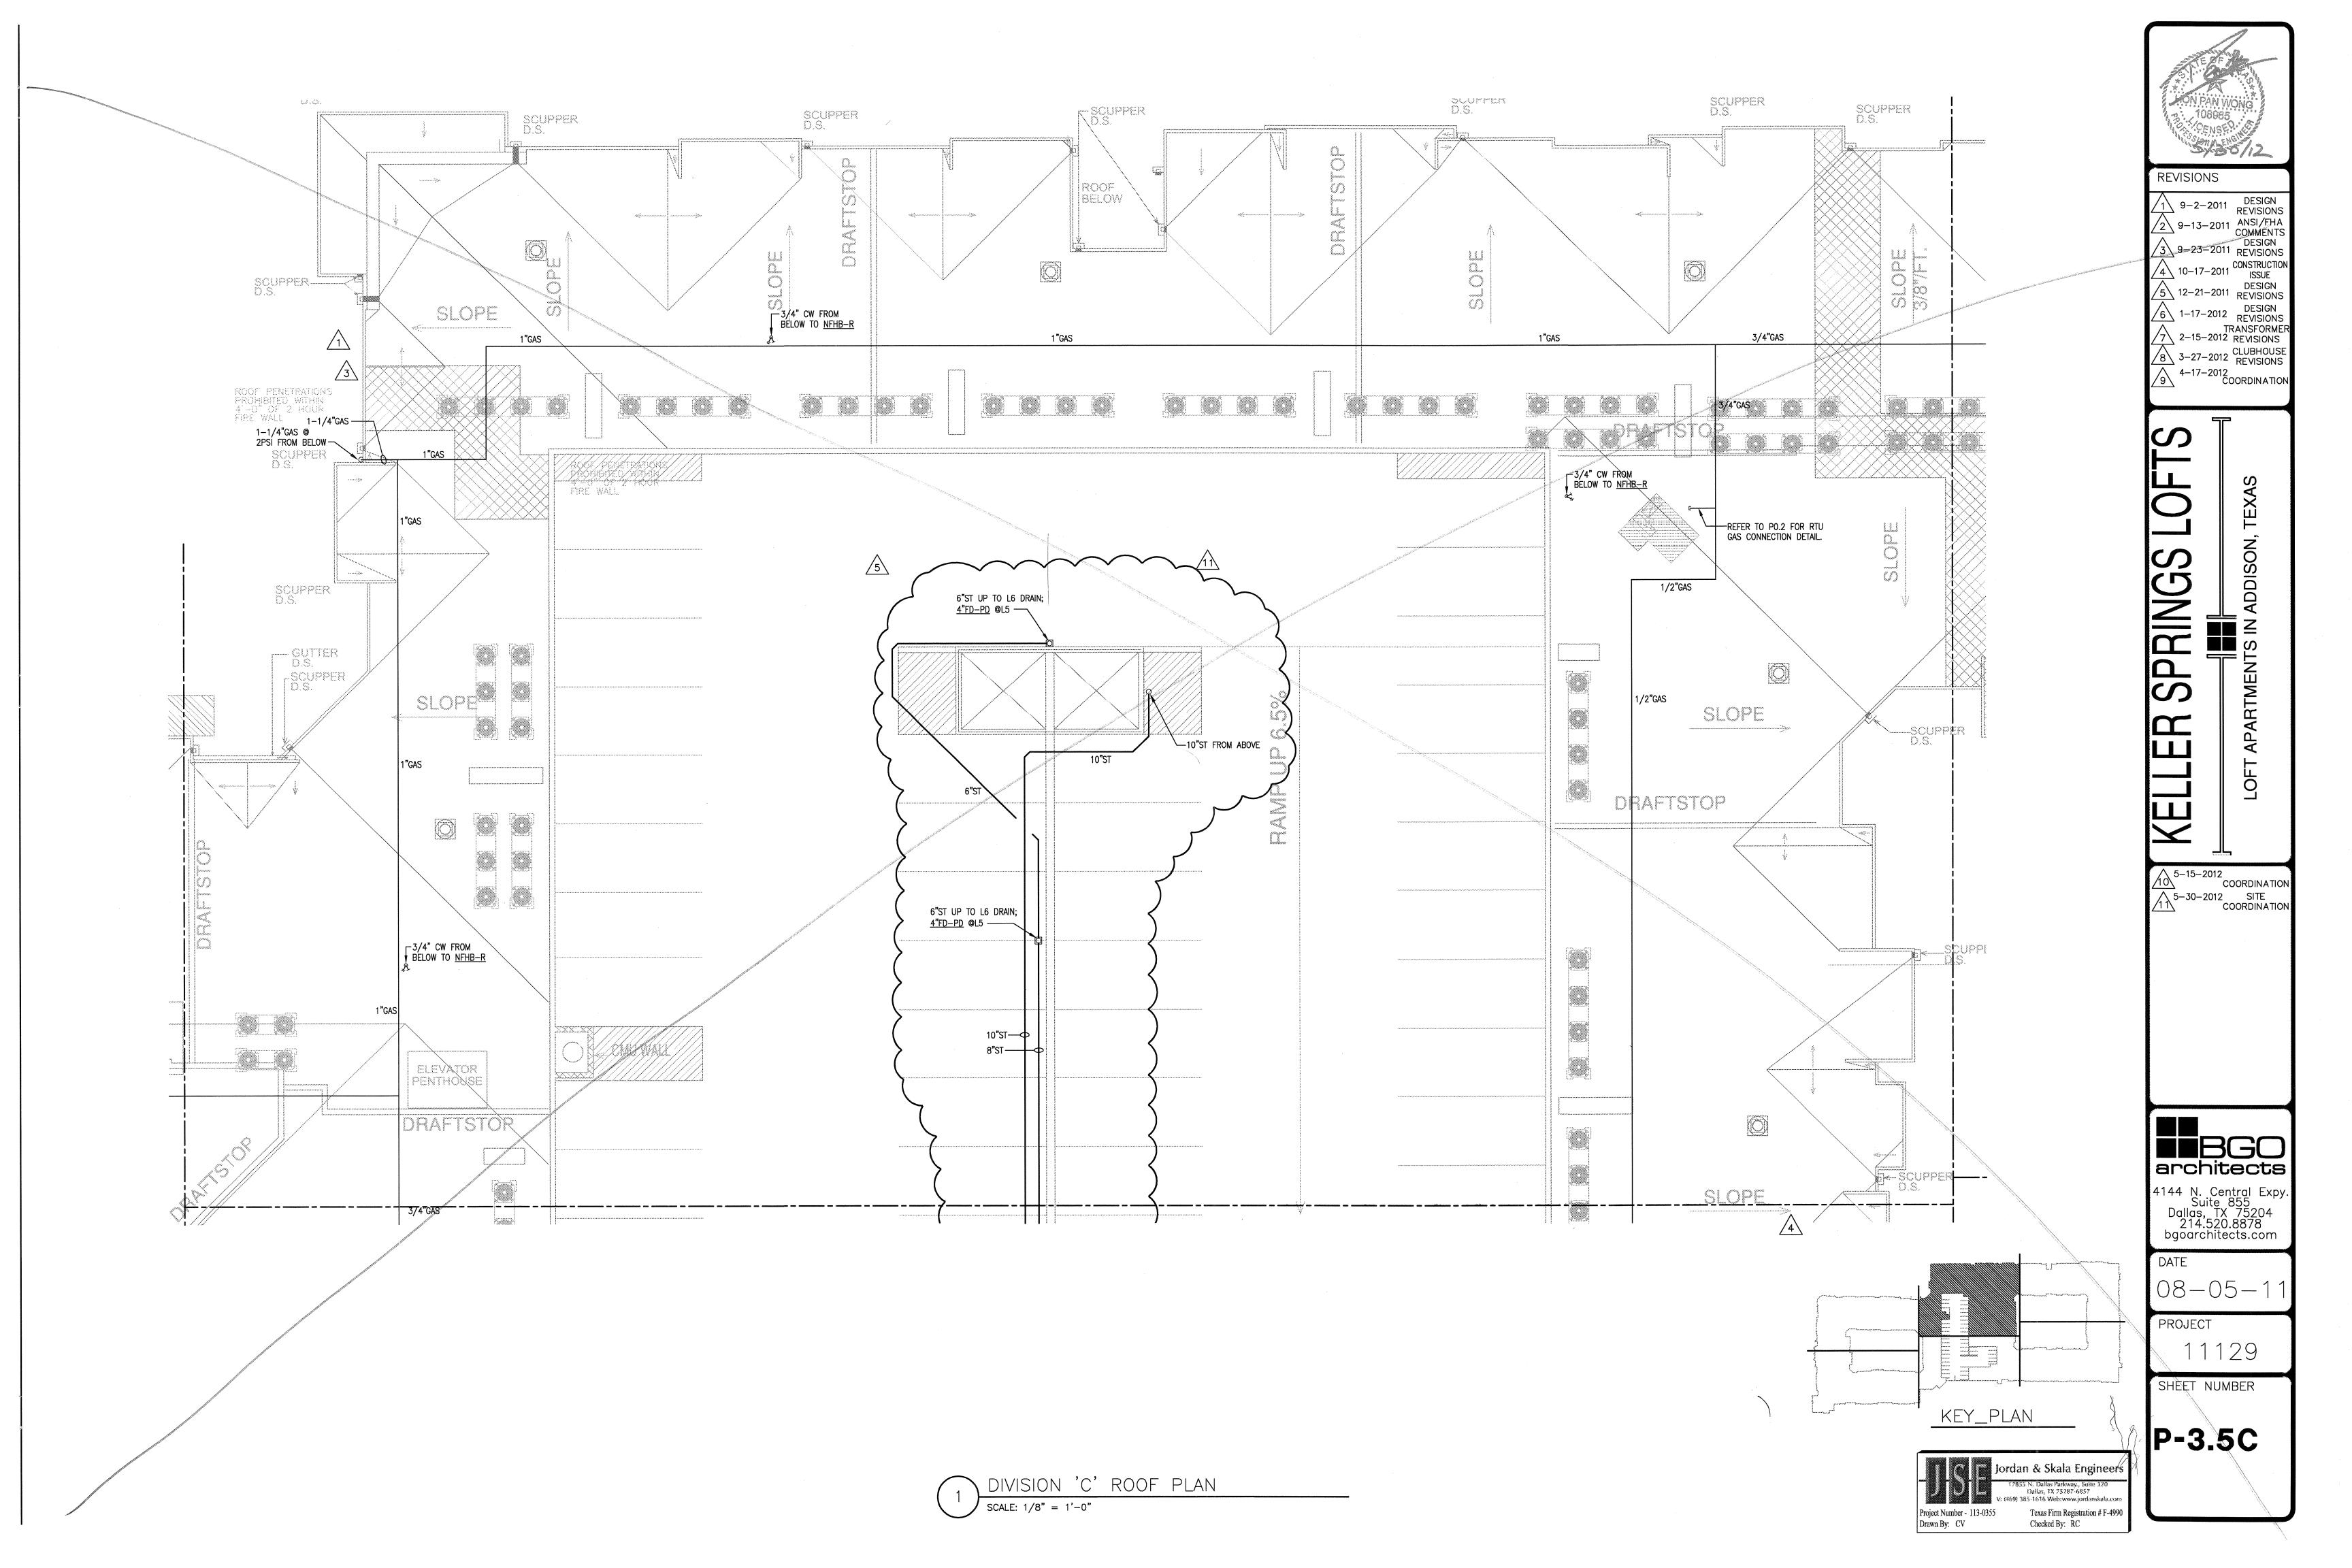


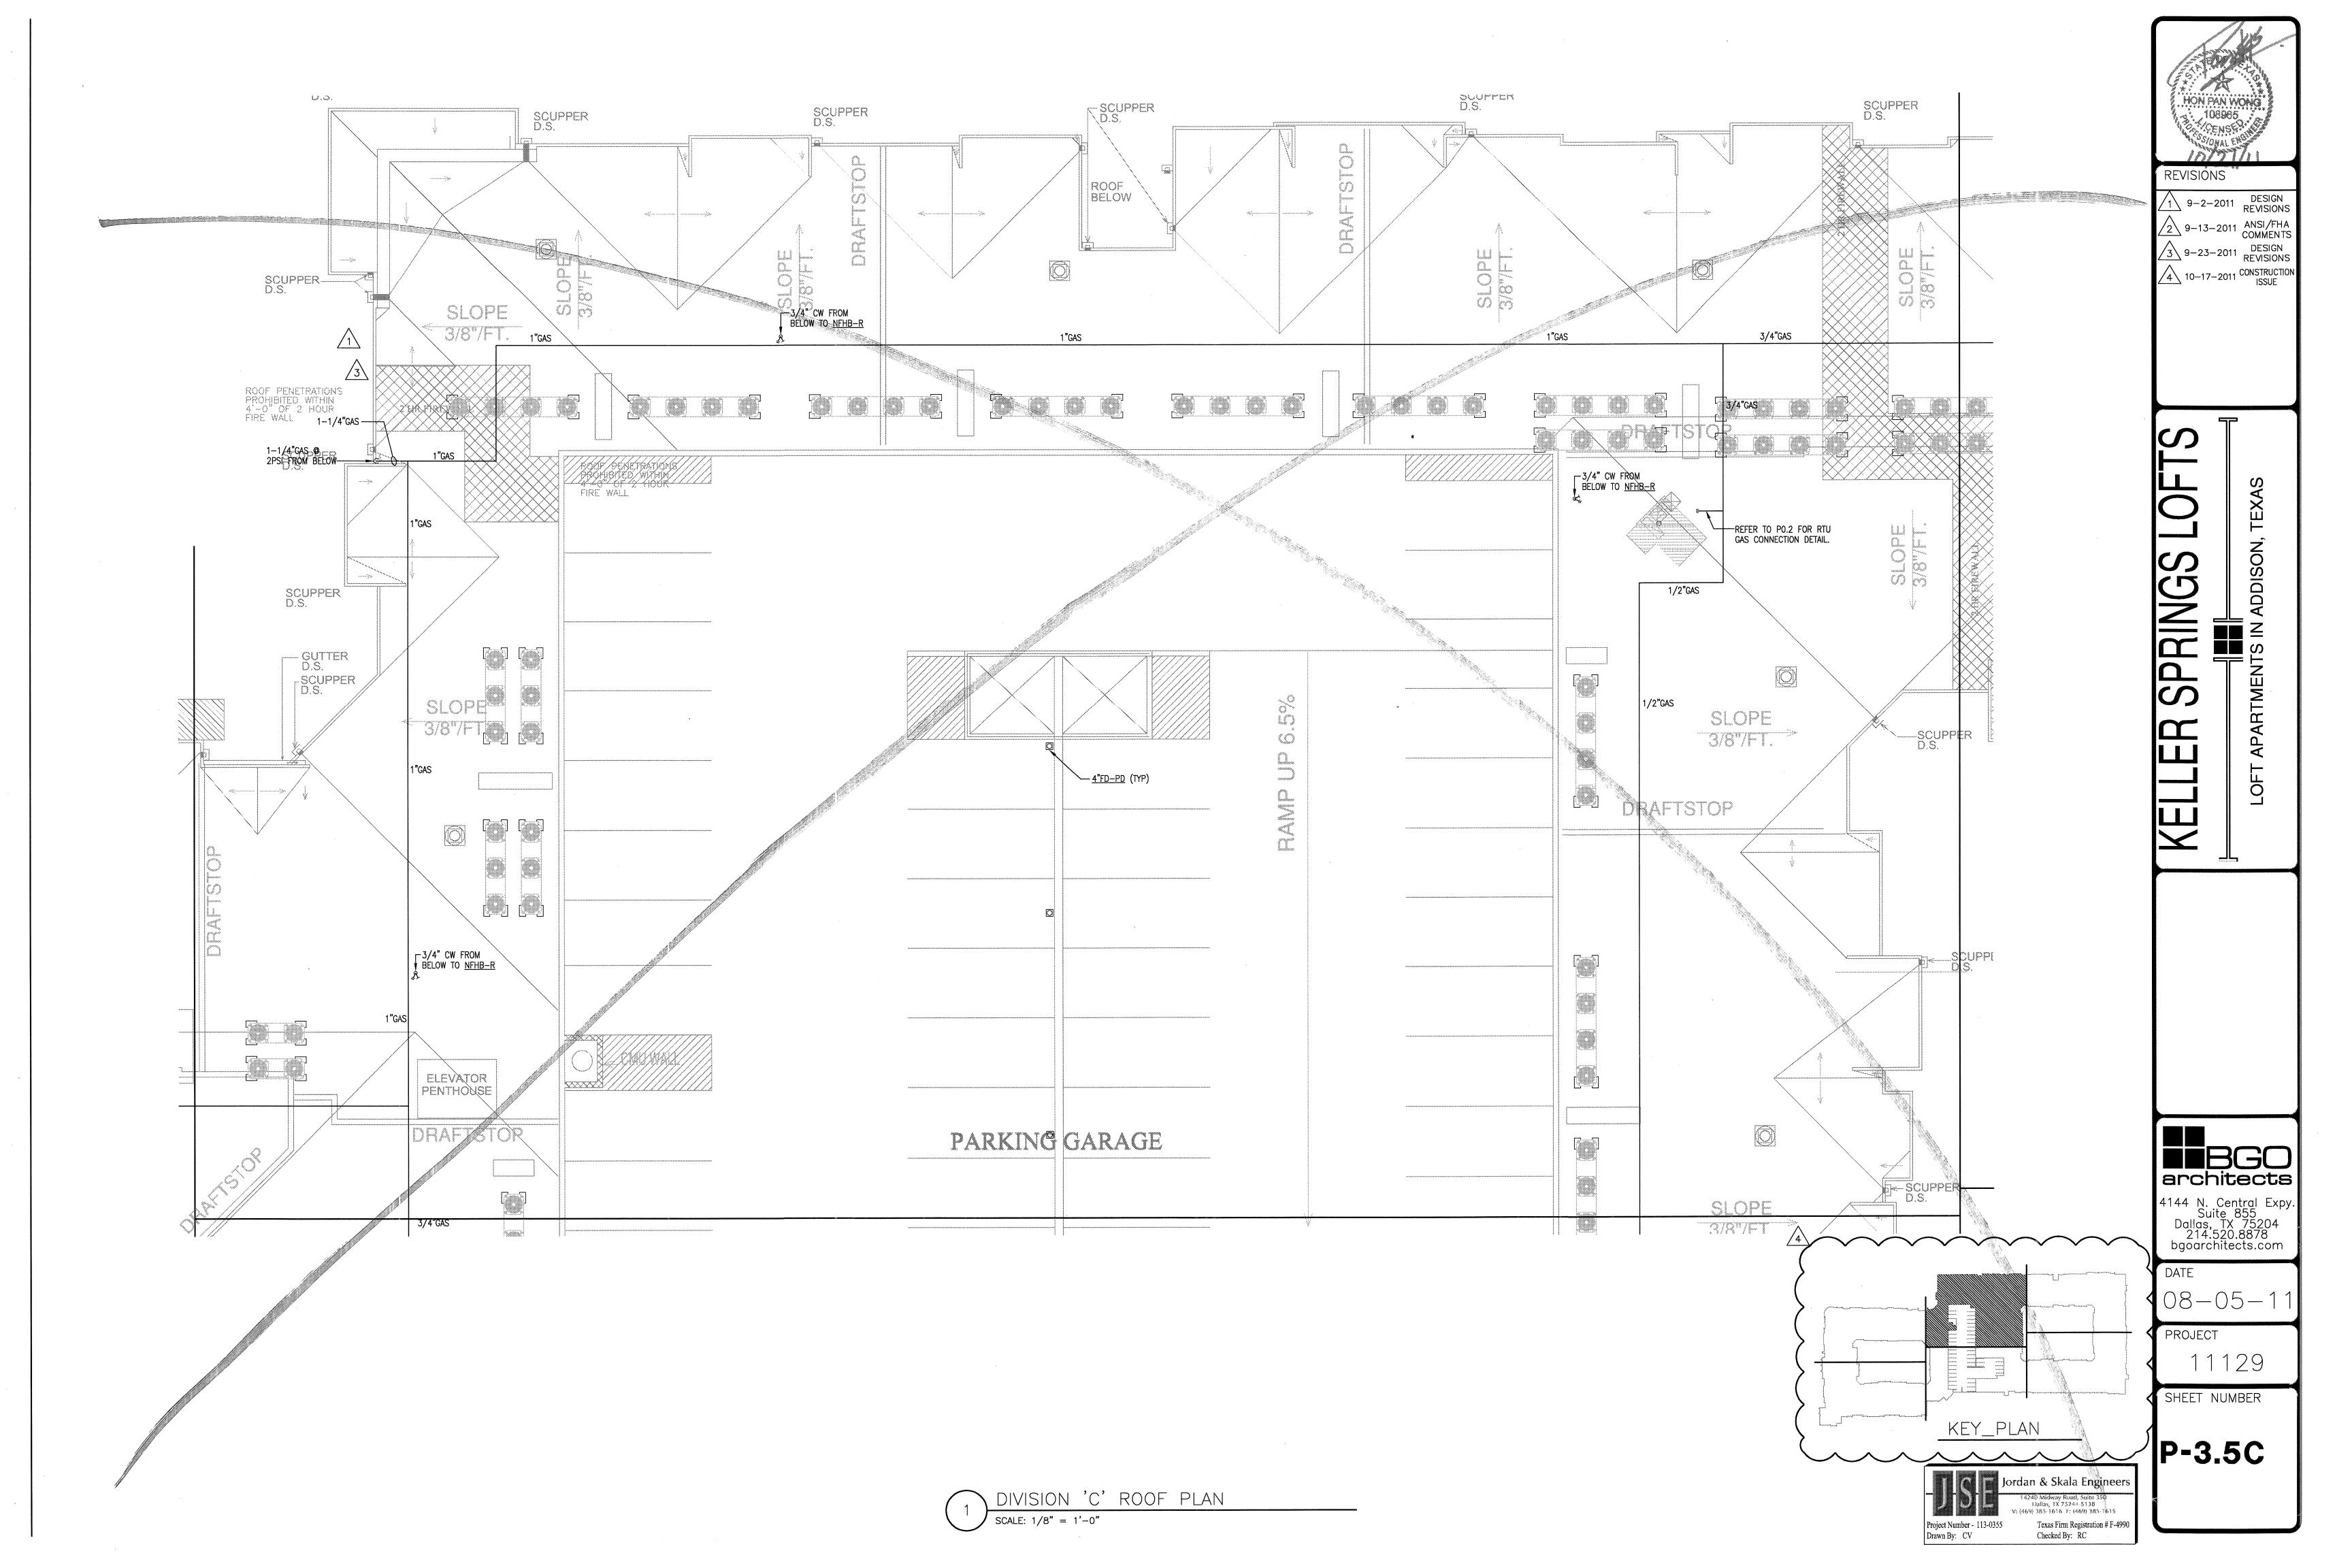

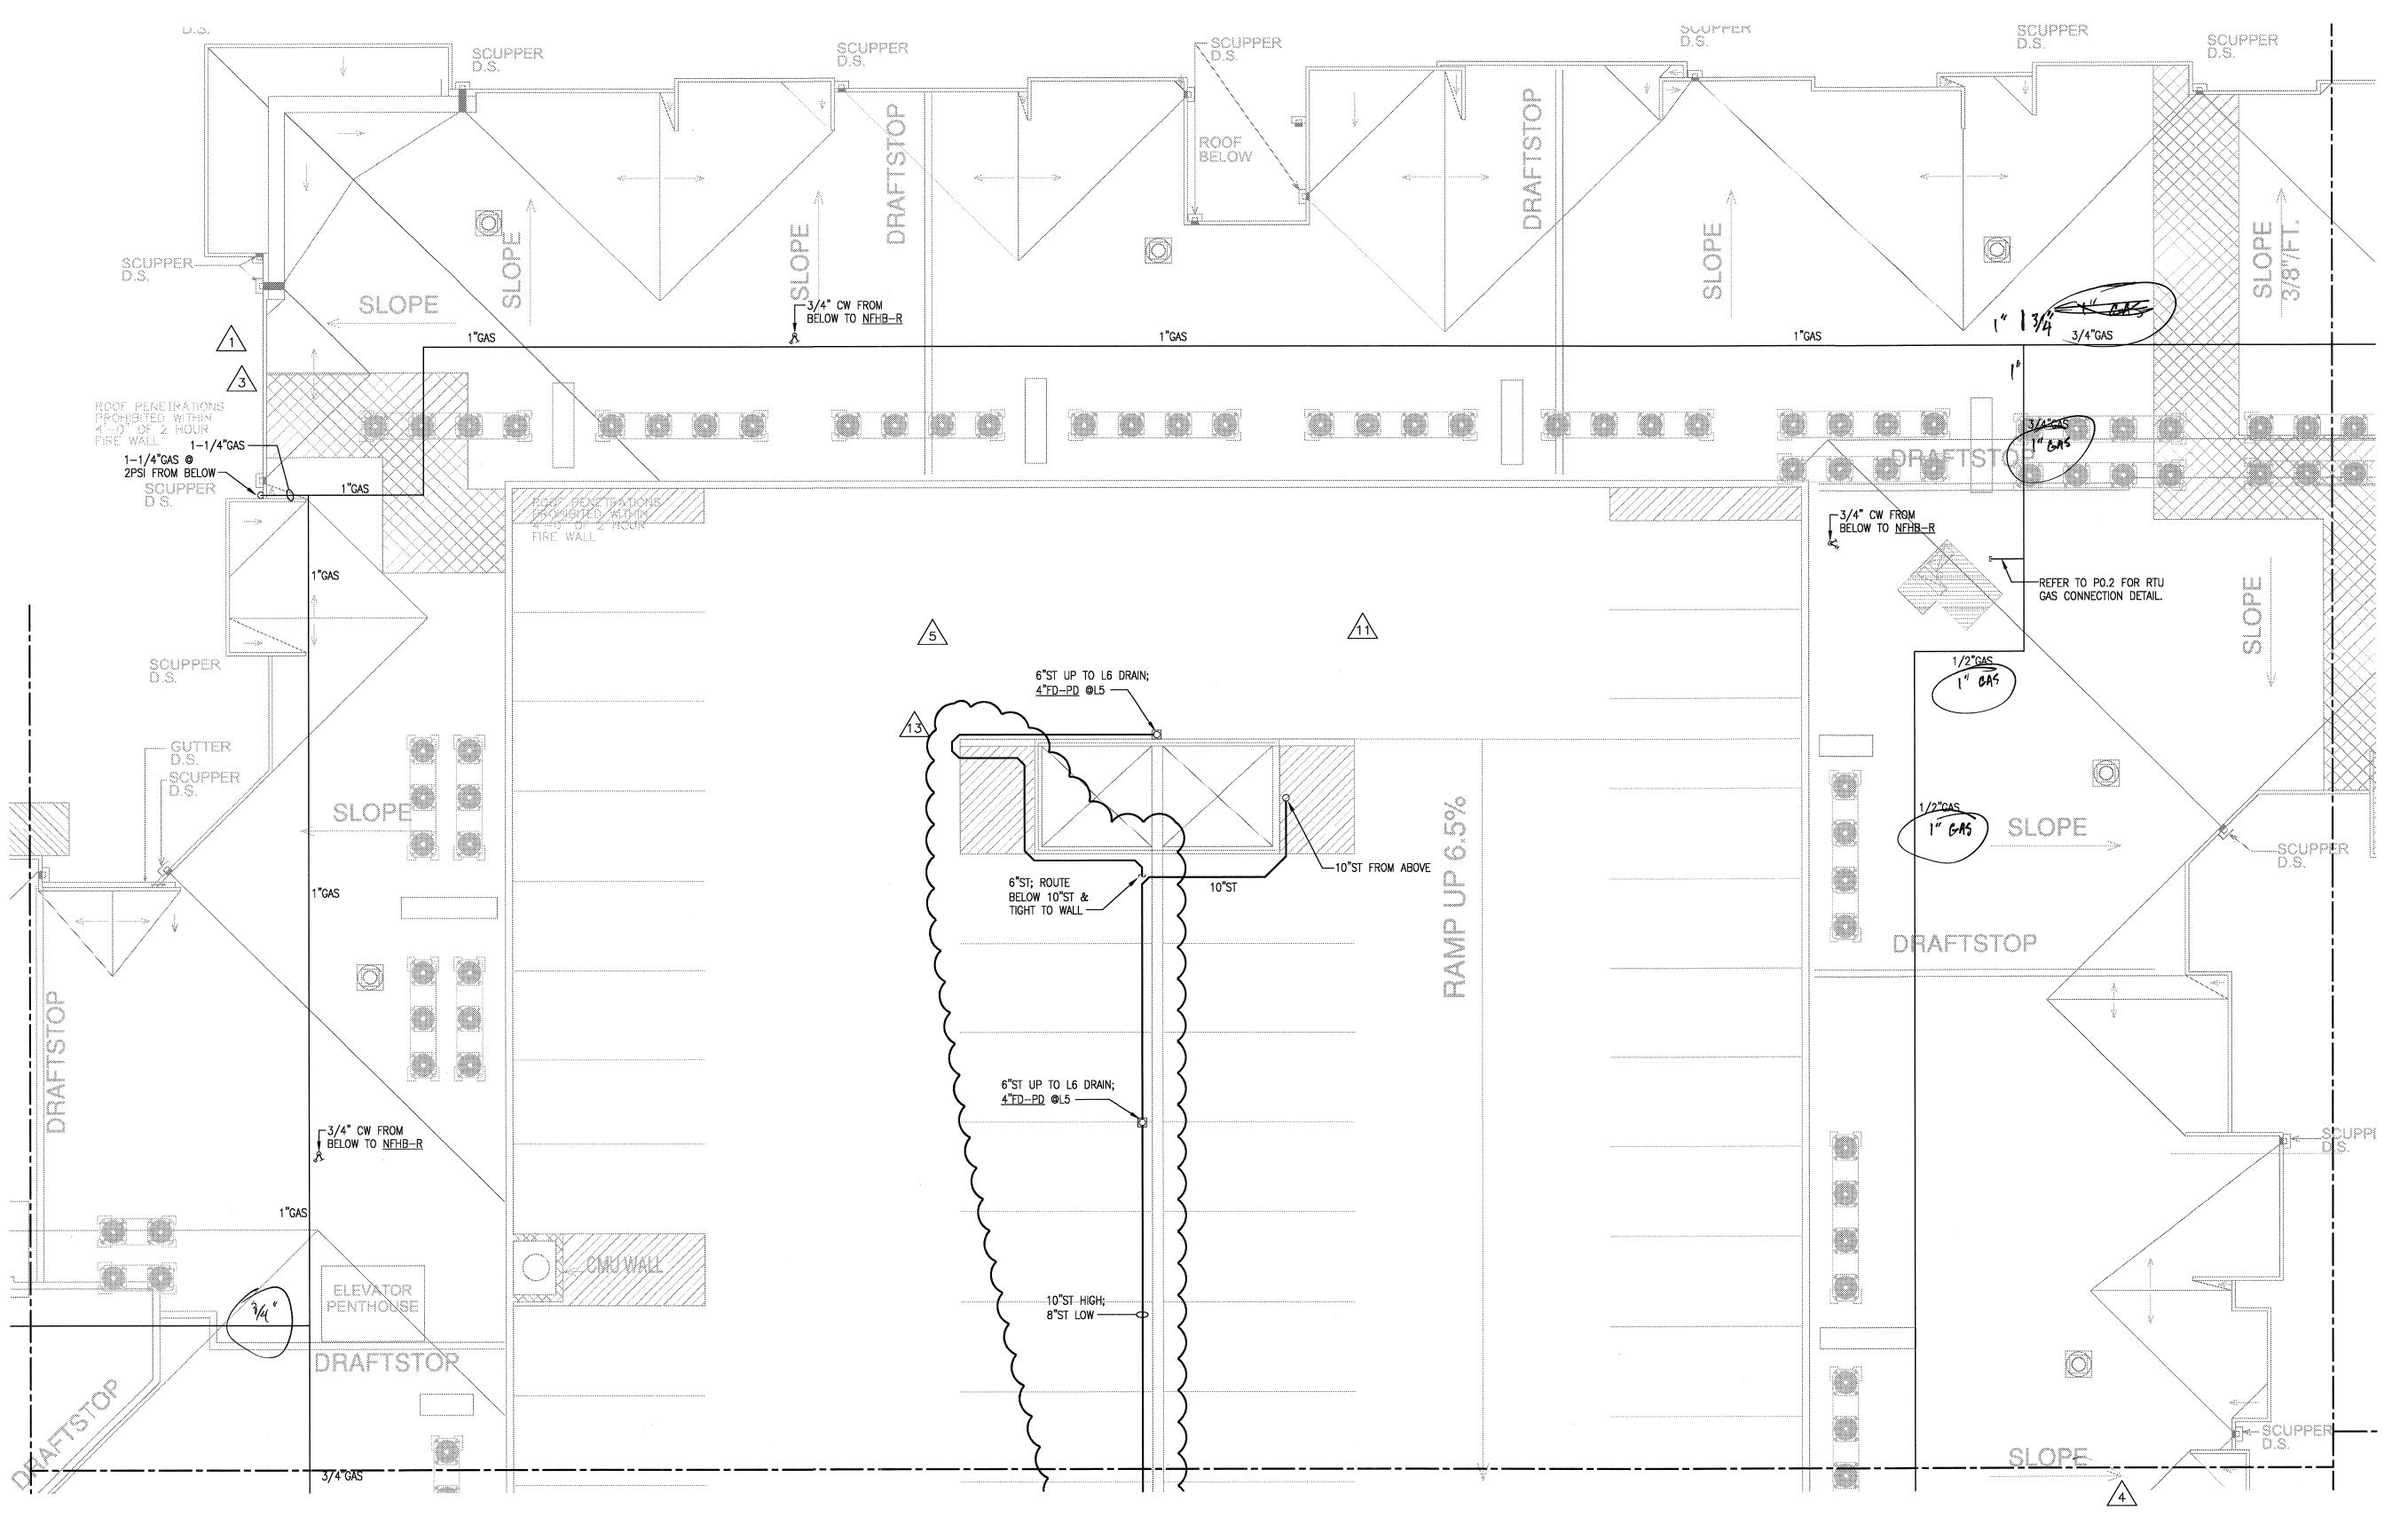

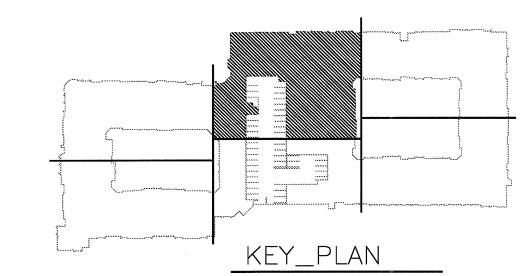



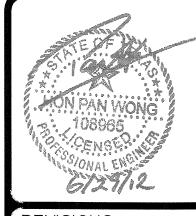

1 9-2-2011 DESIGN REVISIONS
2 9-13-2011 ANSI/FHA COMMENTS DESIGN REVISIONS
3 9-23-2011 REVISIONS
4 10-17-2011 CONSTRUCTION ISSUE DESIGN REVISIONS
5 12-21-2011 DESIGN REVISIONS
6 1-17-2012 DESIGN REVISIONS
7 2-15-2012 REVISIONS
8 3-27-2012 REVISIONS
4-17-2012 COORDINATION

KELLER SPRINGS LOFTS

LOFT APARTMENTS IN ADDISON, TEXAS

5-15-2012
COORDINATION
5-30-2012 SITE
COORDINATION
6-01-12 LIGHTING
REVISIONS
6-29-12 SITE
COORDINATION


4144 N. Central Expy.
Suite 855
Dallas, TX 75204
214.520.8878
bgoarchitects.com


date 08-05-11


PROJECT 11129


SHEET NUMBER

P-3.5C

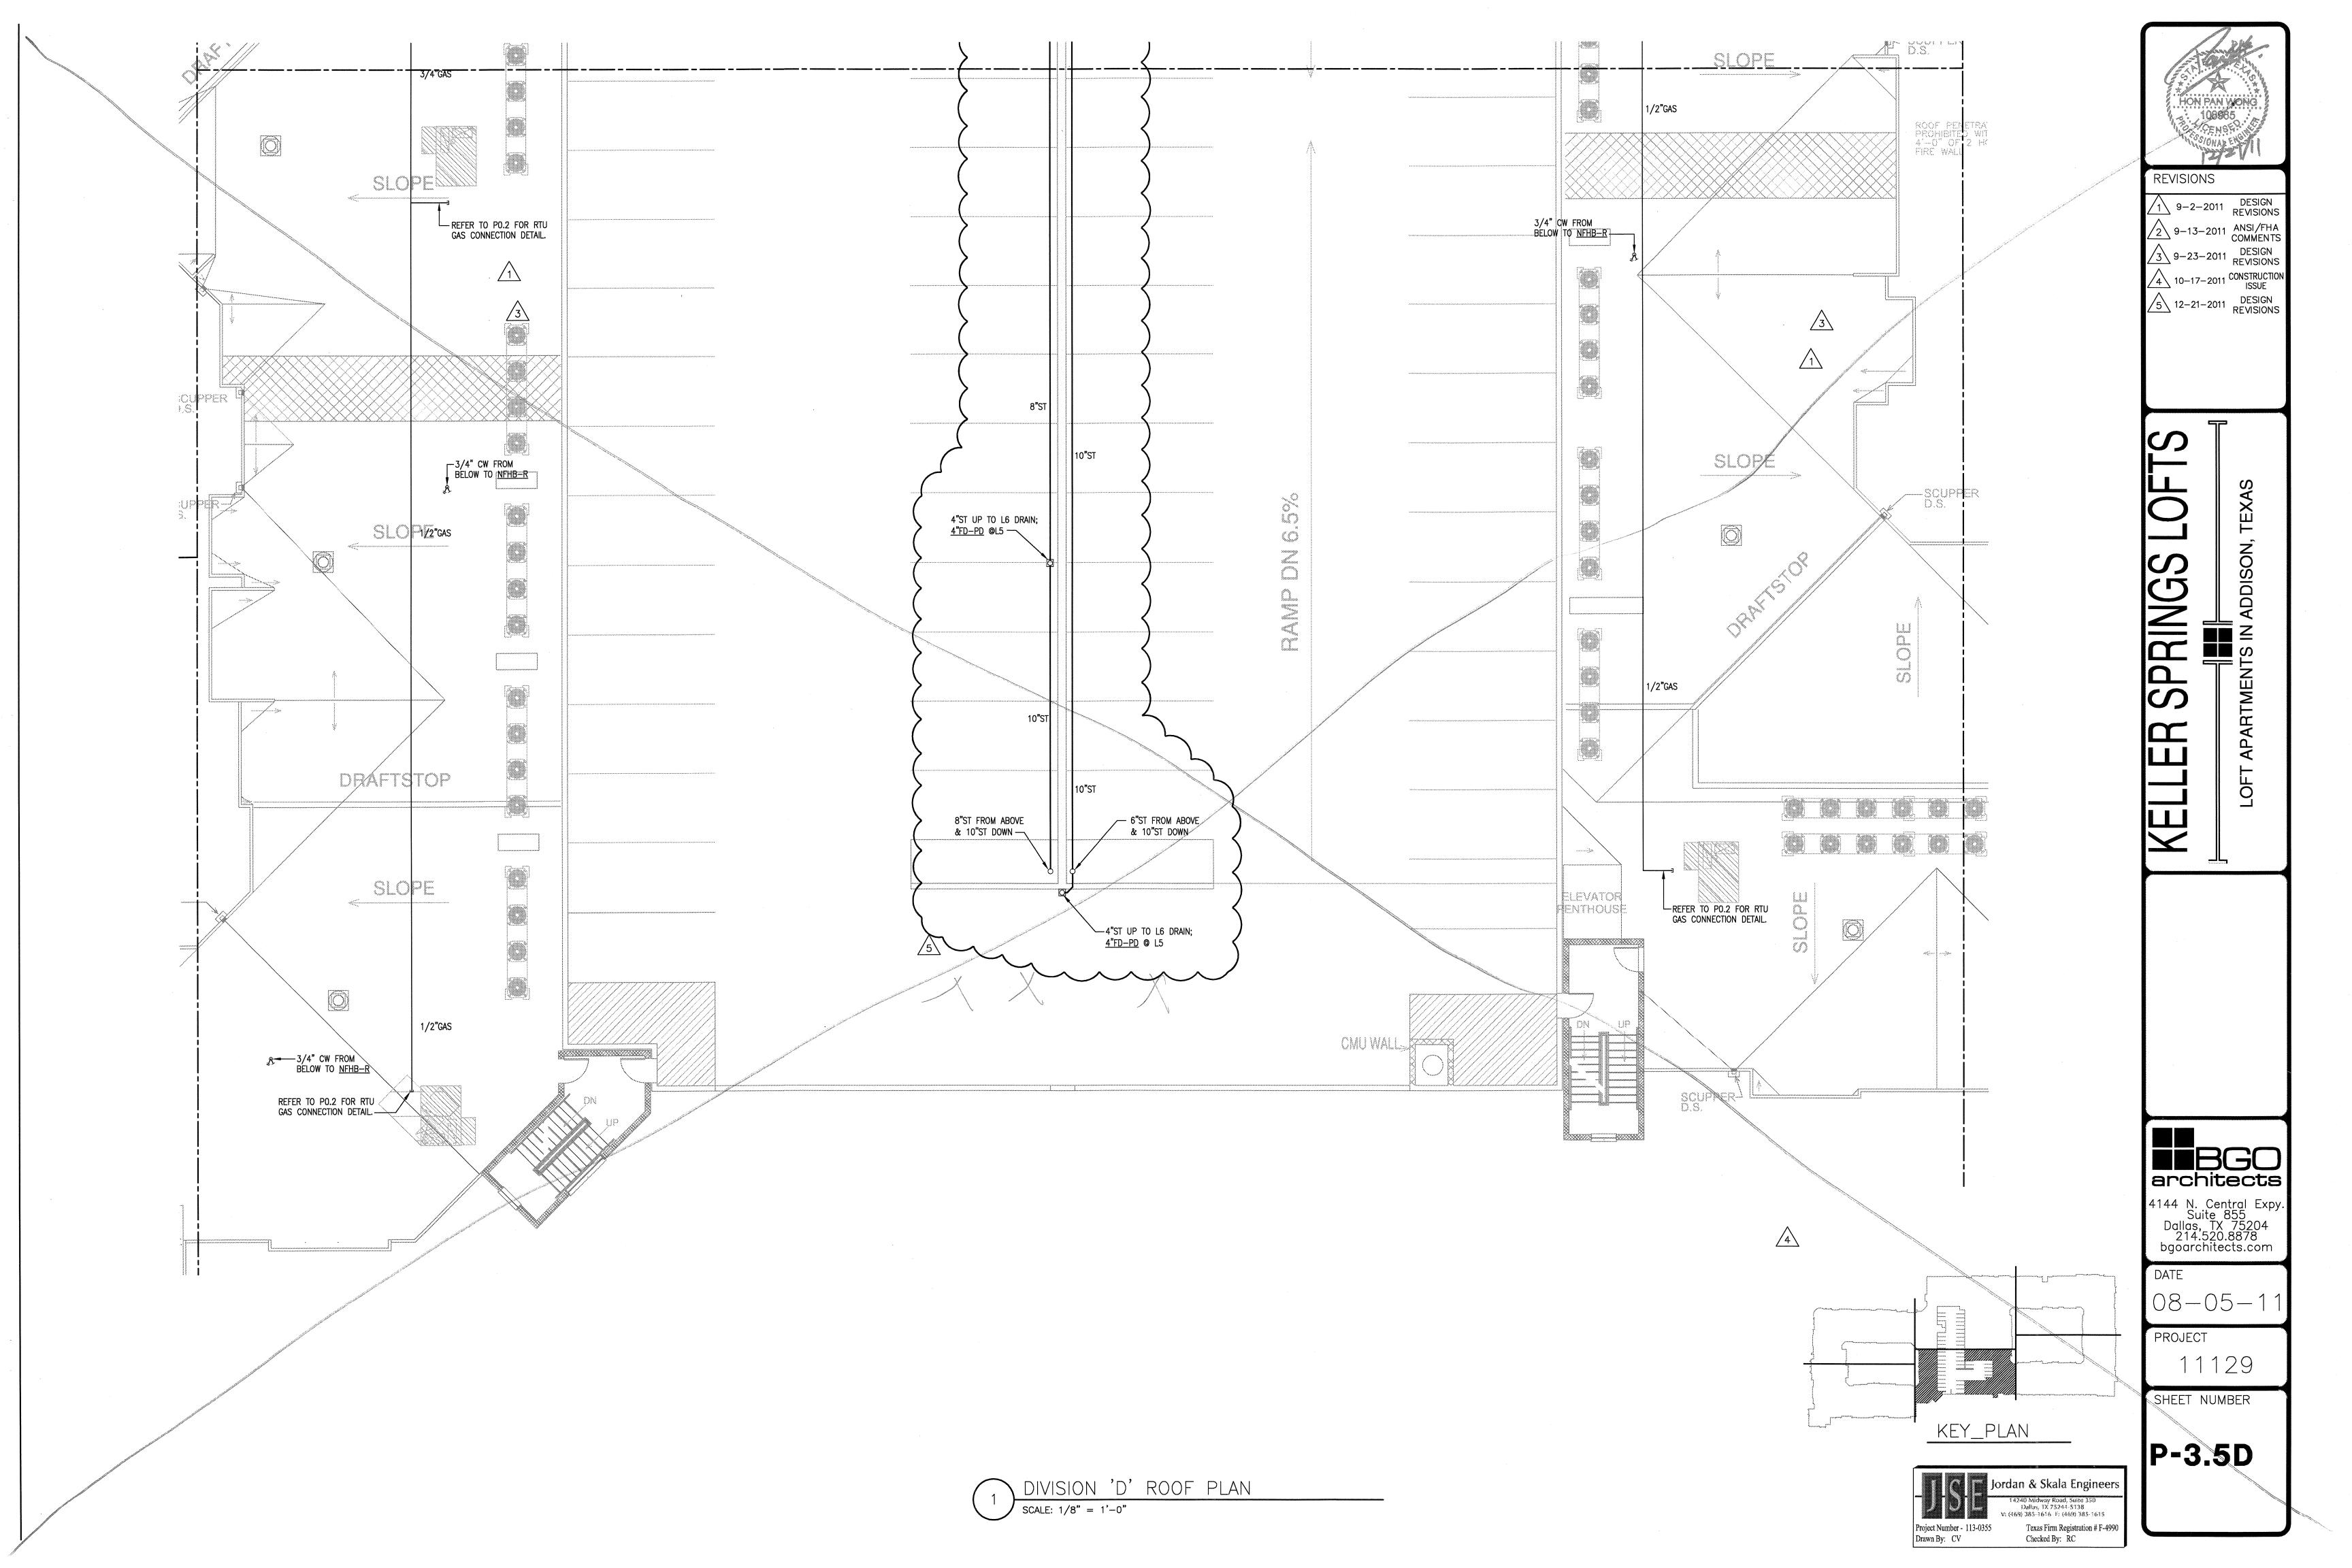

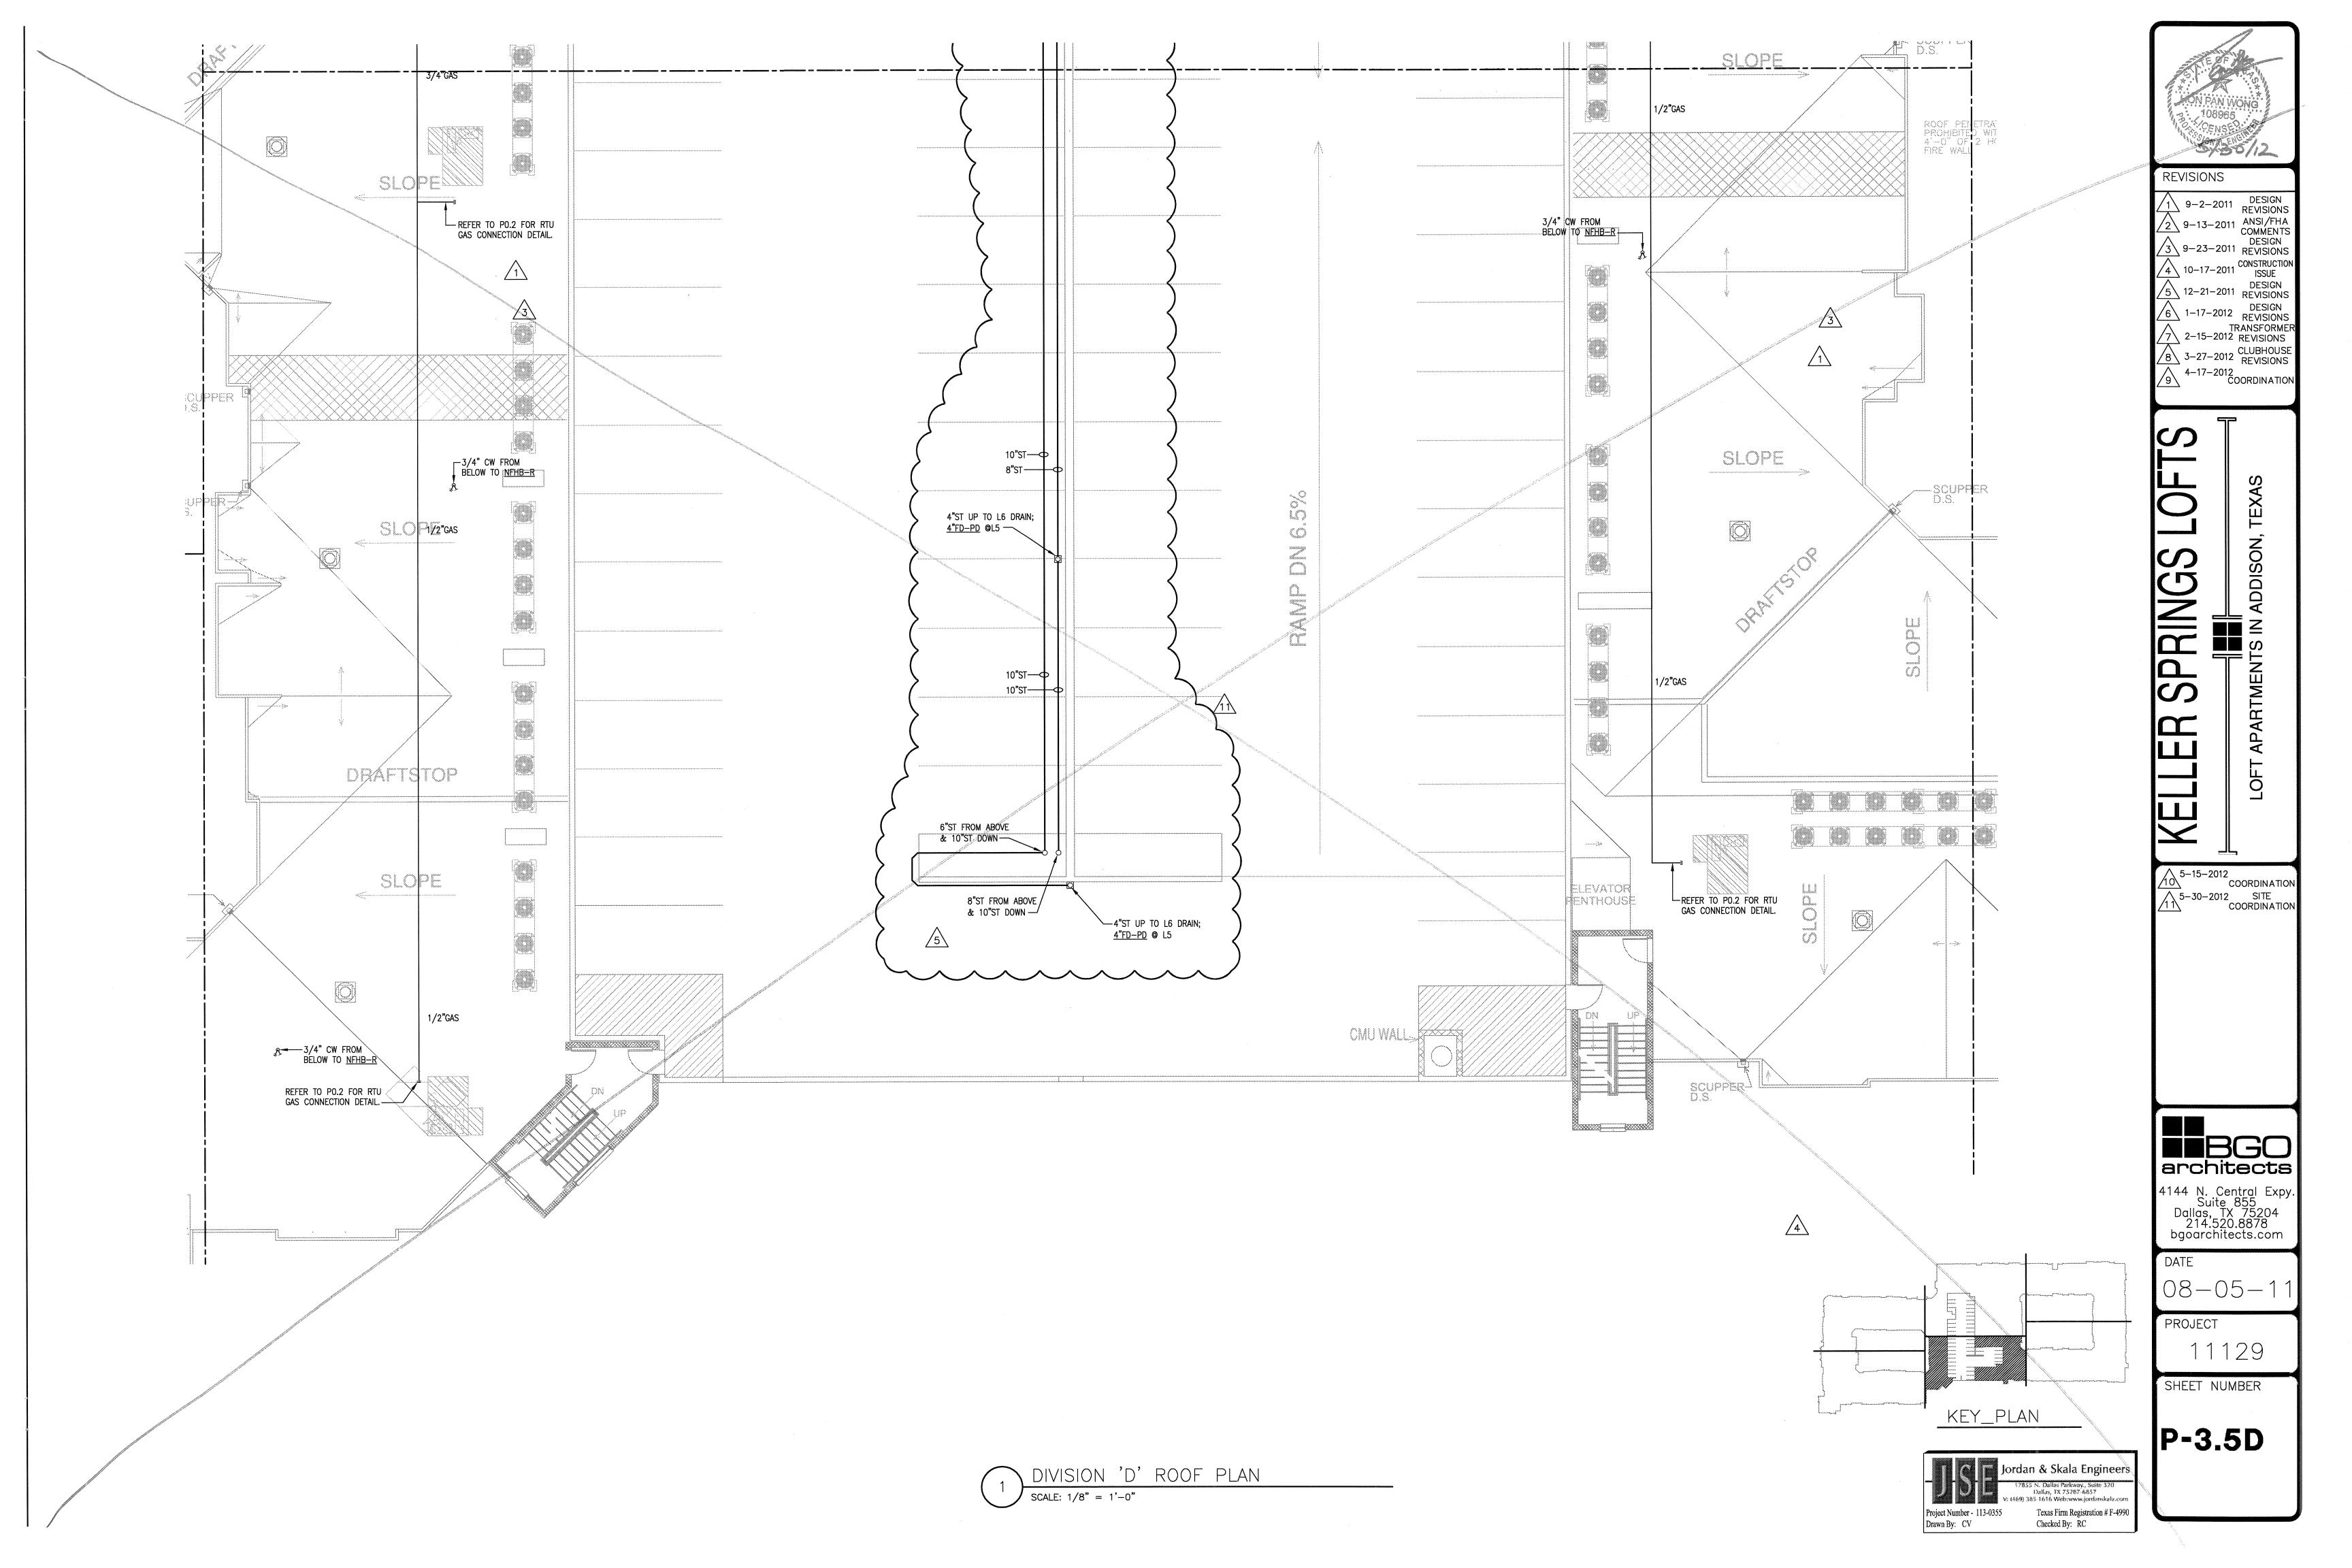

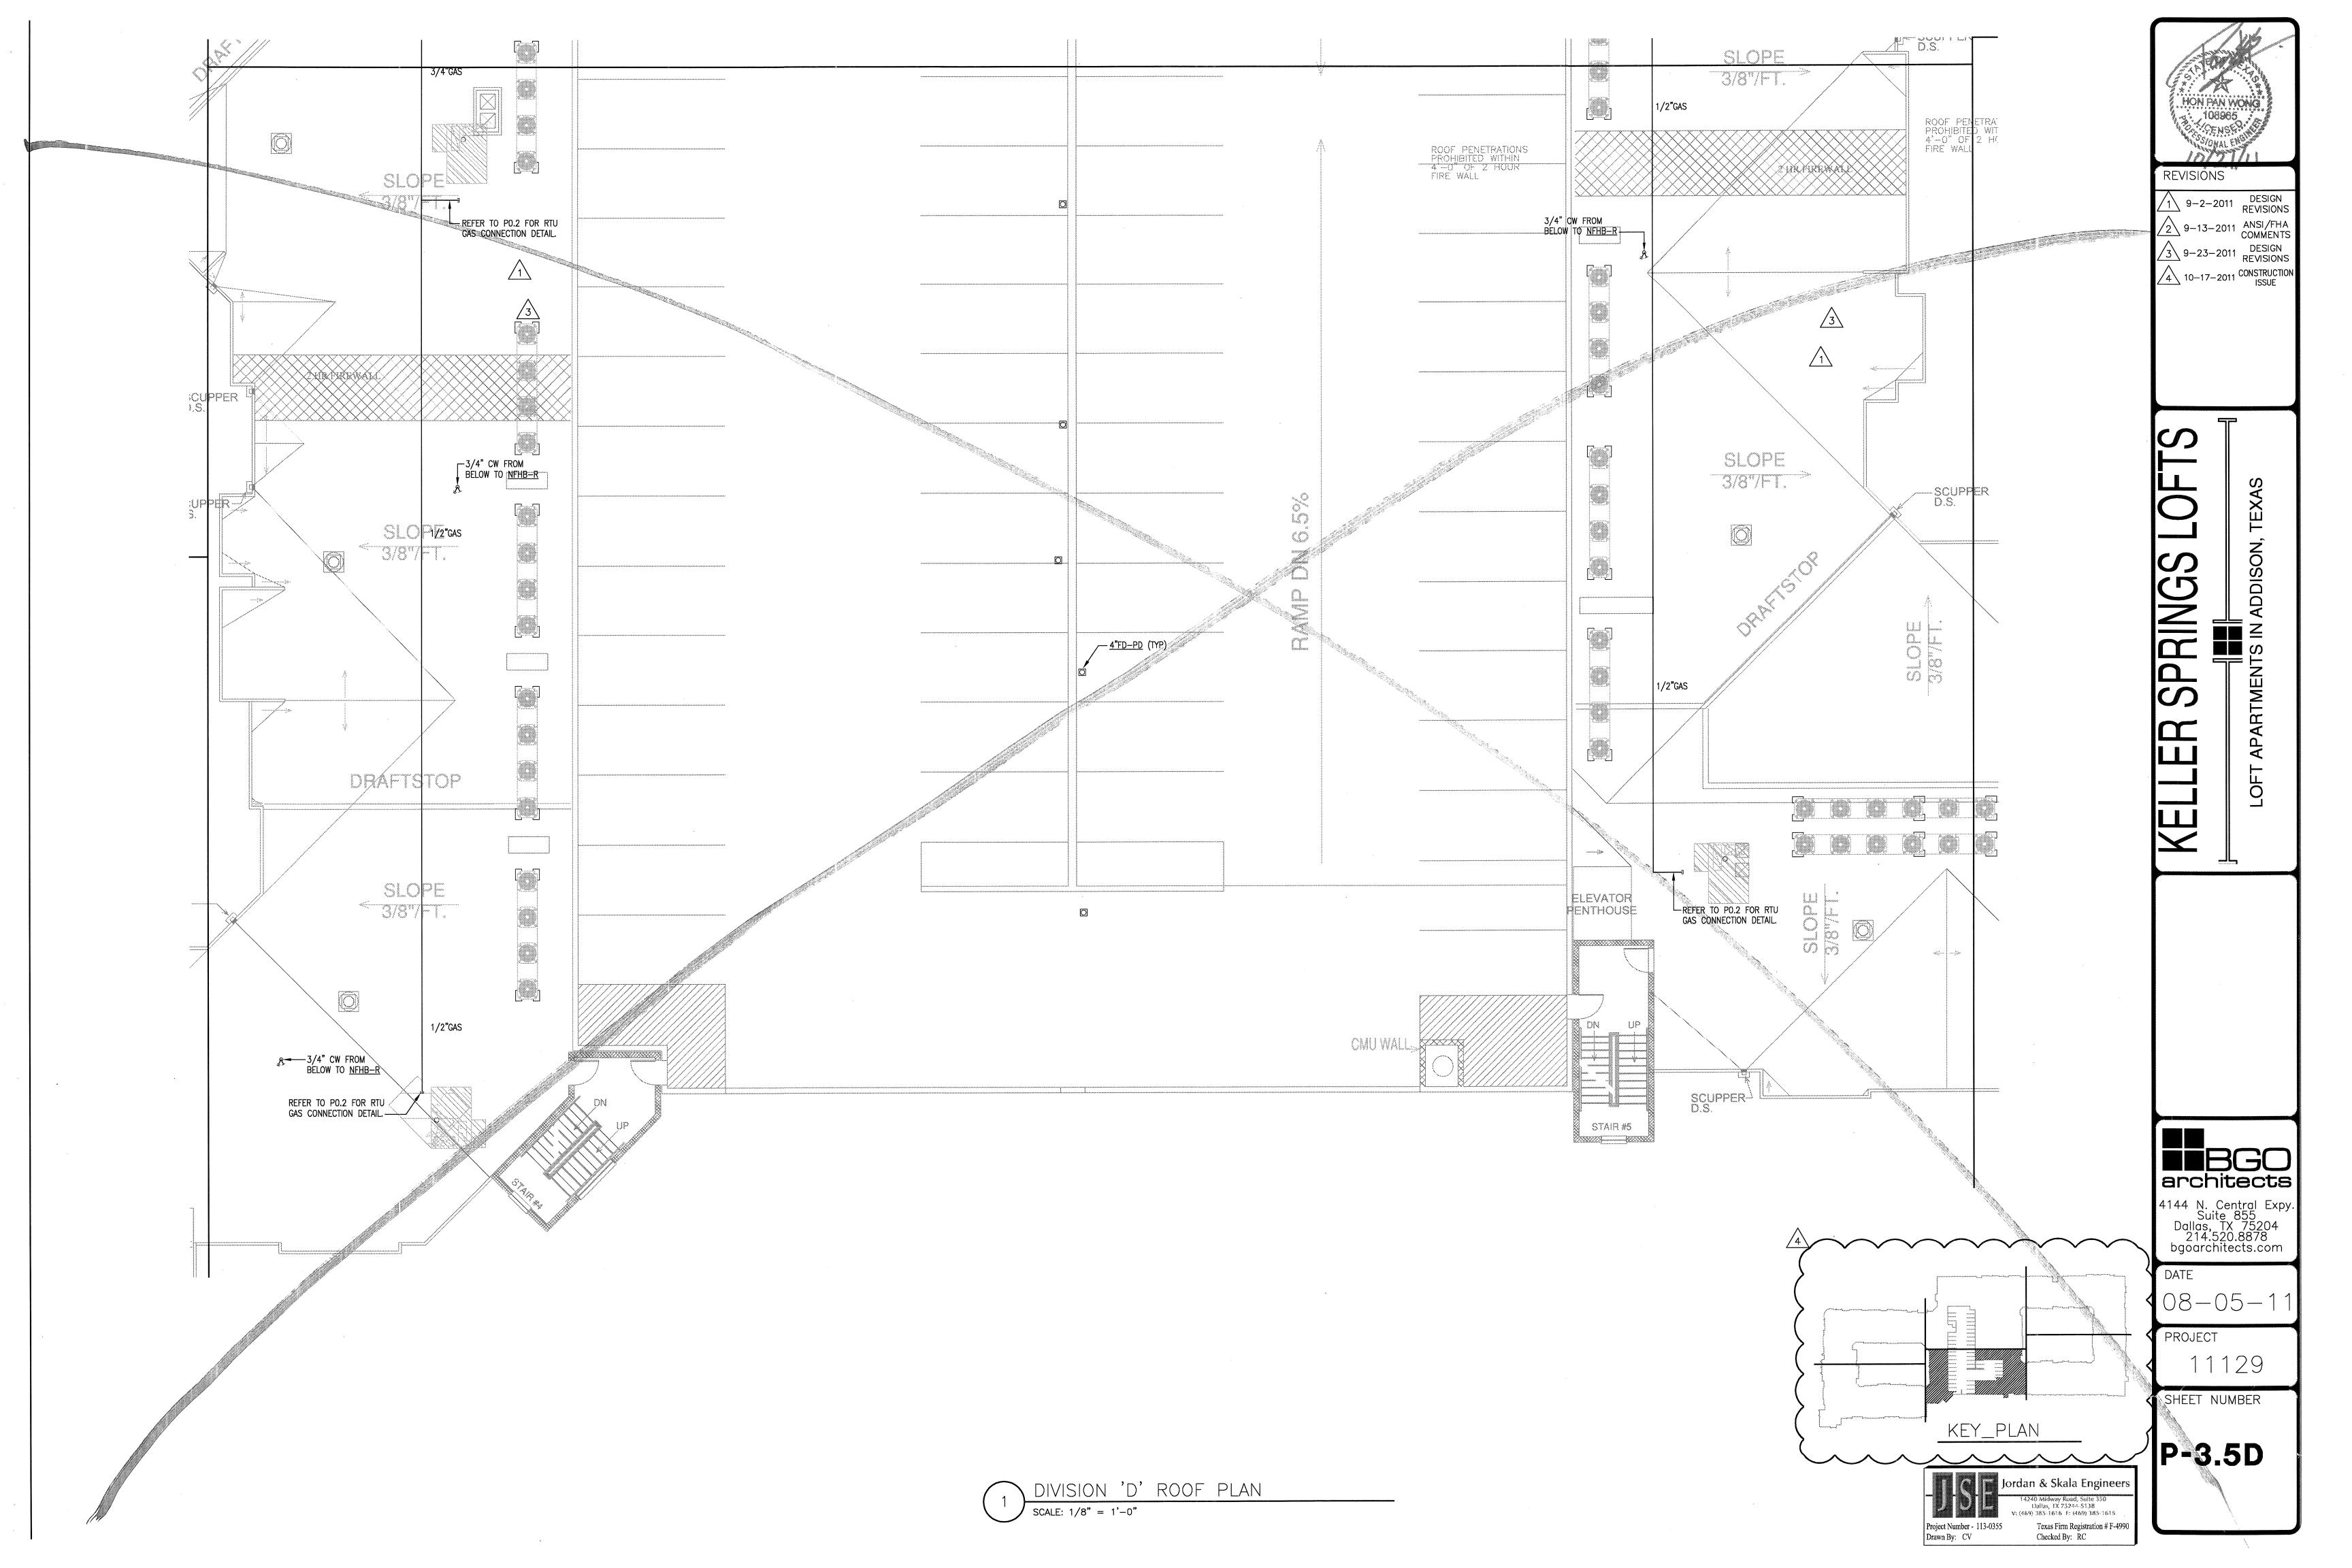

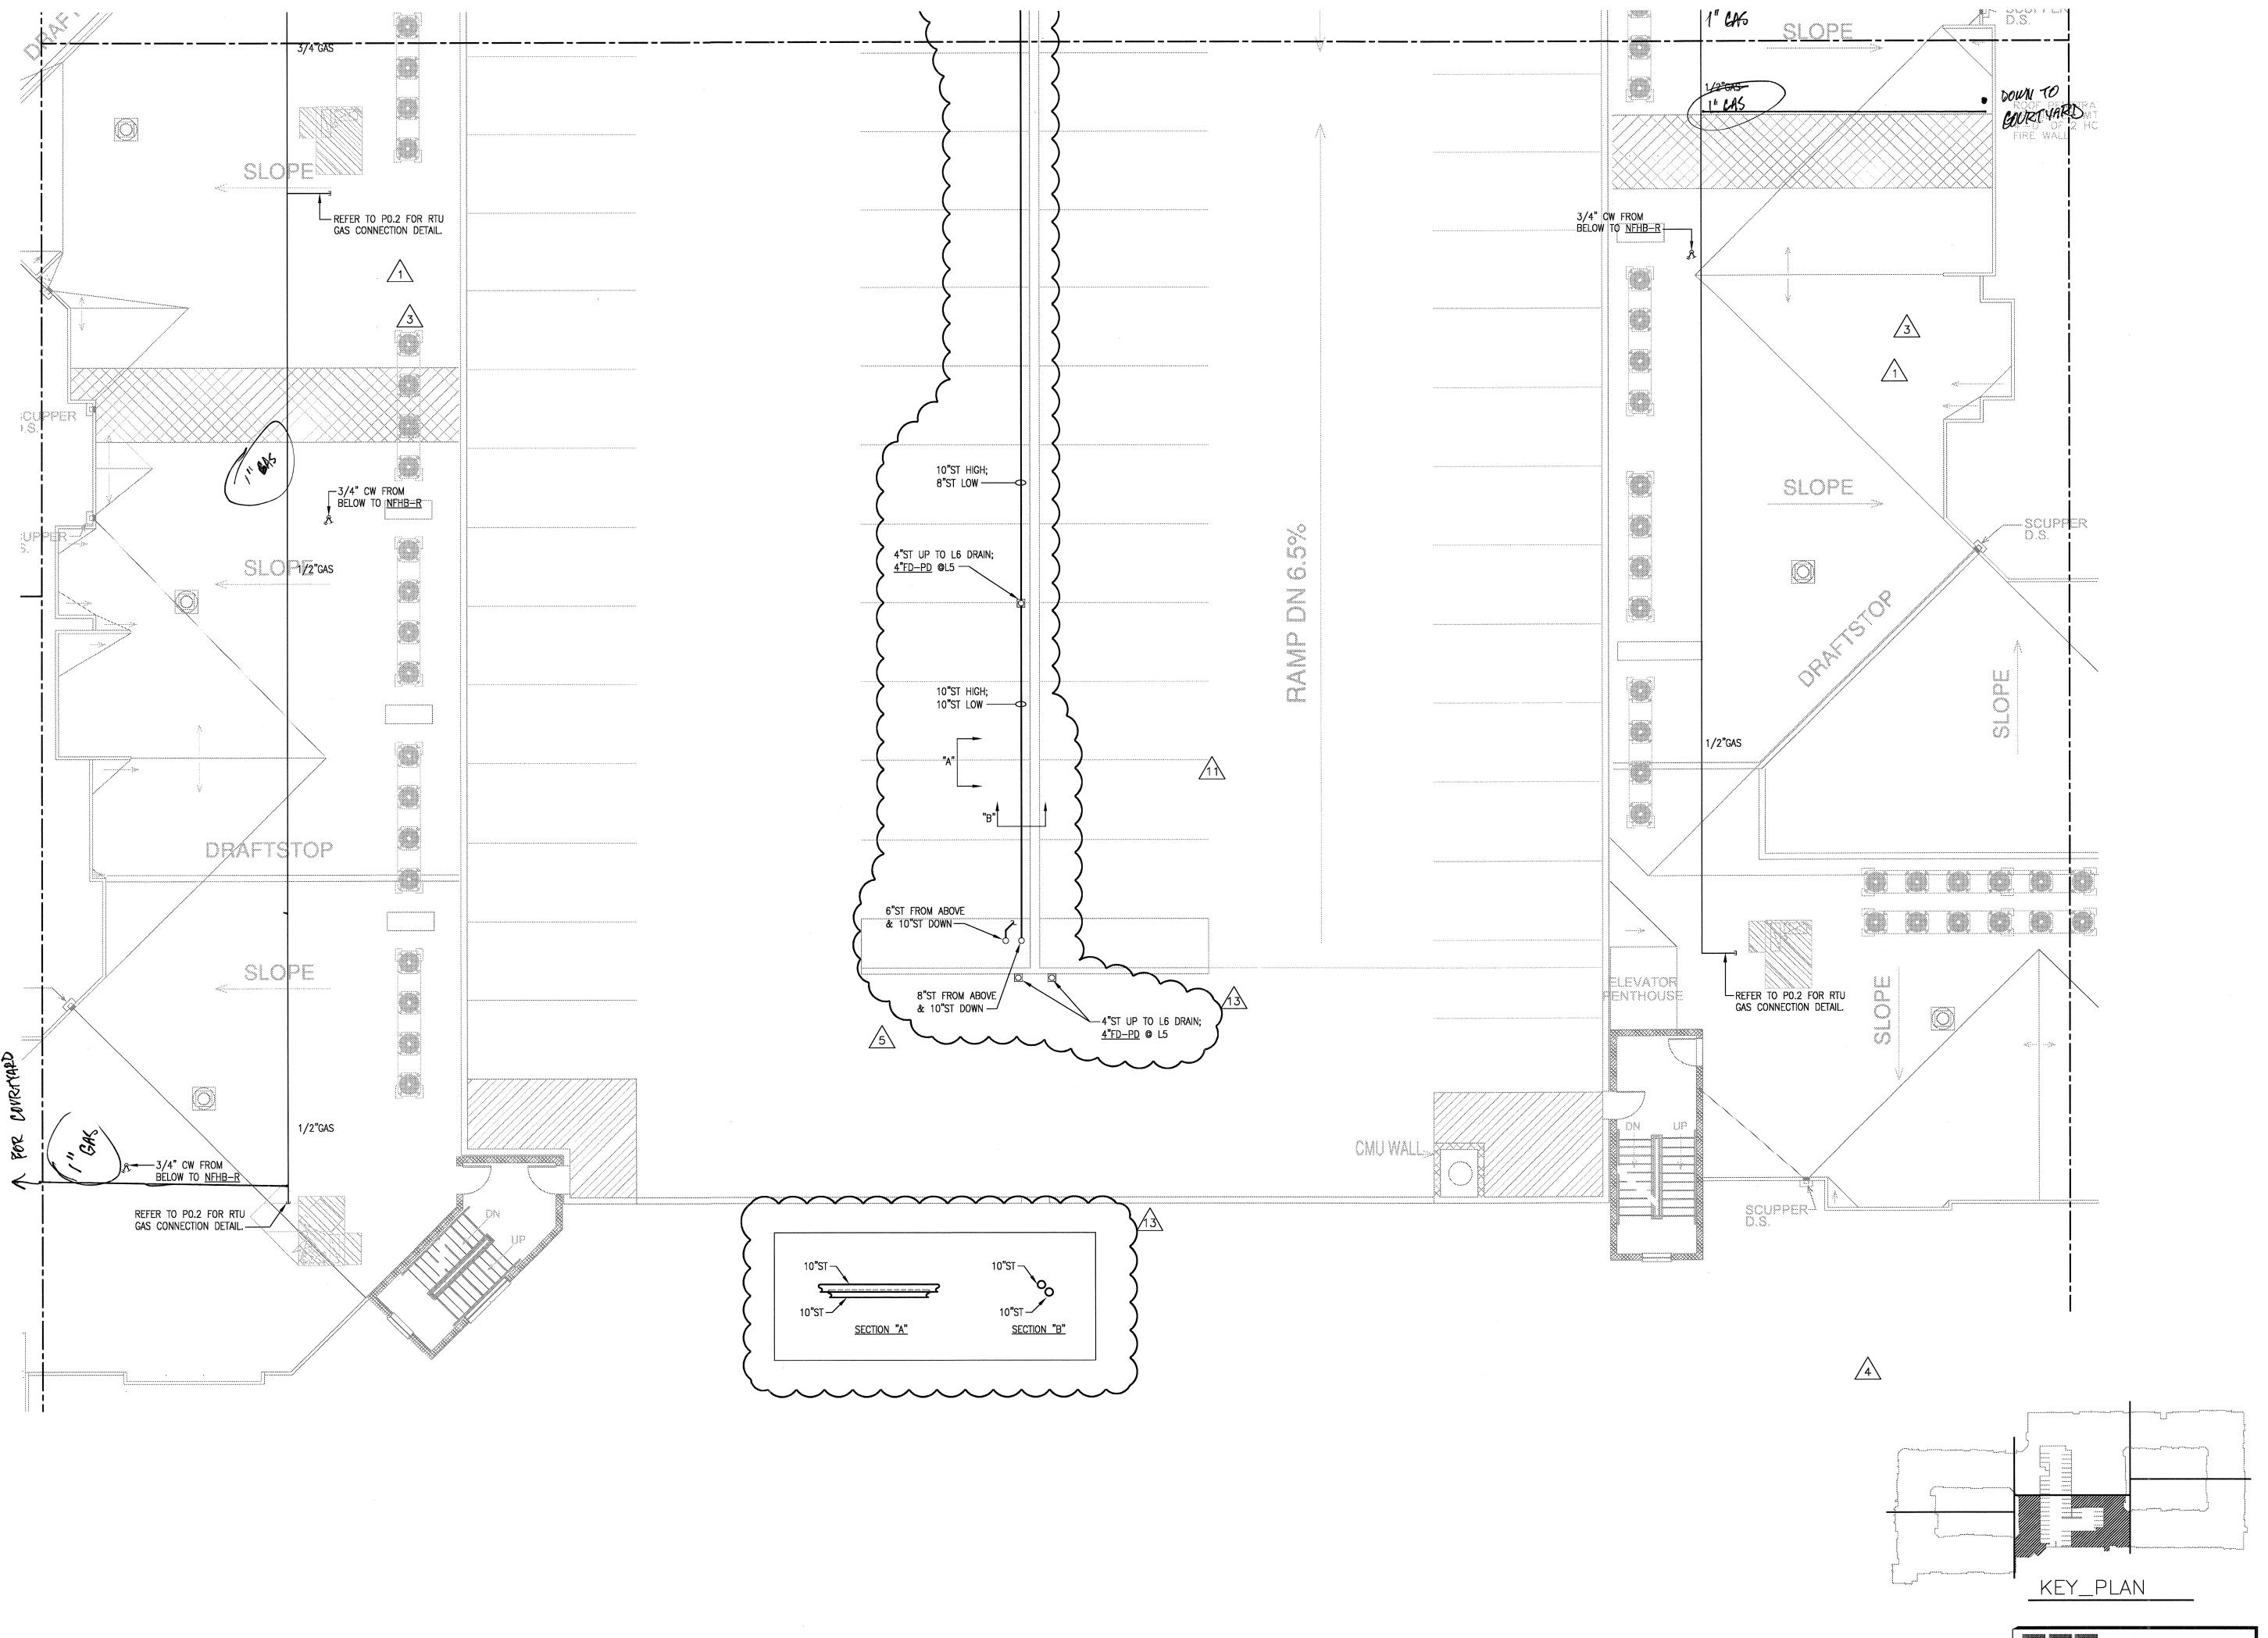



1 9-2-2011 DESIGN REVISIONS
2 9-13-2011 ANSI/FHA COMMENTS DESIGN REVISIONS
3 9-23-2011 CONSTRUCTION ISSUE
5 12-21-2011 DESIGN REVISIONS
6 1-17-2012 DESIGN REVISIONS
TRANSFORMER
7 2-15-2012 REVISIONS
8 3-27-2012 CLUBHOUSE REVISIONS
4-17-2012 COORDINATION

SPRINGS LOFTS

5-15-2012
COORDINATION
5-30-2012 SITE
COORDINATION
6-01-12 LIGHTING
REVISIONS
6-29-12 SITE
COORDINATION

BBGO architects

4144 N. Central Expy. Suite 855 Dallas, TX 75204 214.520.8878 bgoarchitects.com

DATE 08-05-11

PROJECT 11129

SHEET NUMBER

Jordan & Skala Engineers


17855 N. Dallas Parkway, Suite 320
Dallas, TX 75287-6857
V: (469) 385-1616 Web:www.jordanskala.com


Texas Firm Registration # F-499

Checked By: RC

DIVISION 'D' ROOF PLAN

SCALE: 1/8" = 1'-0"

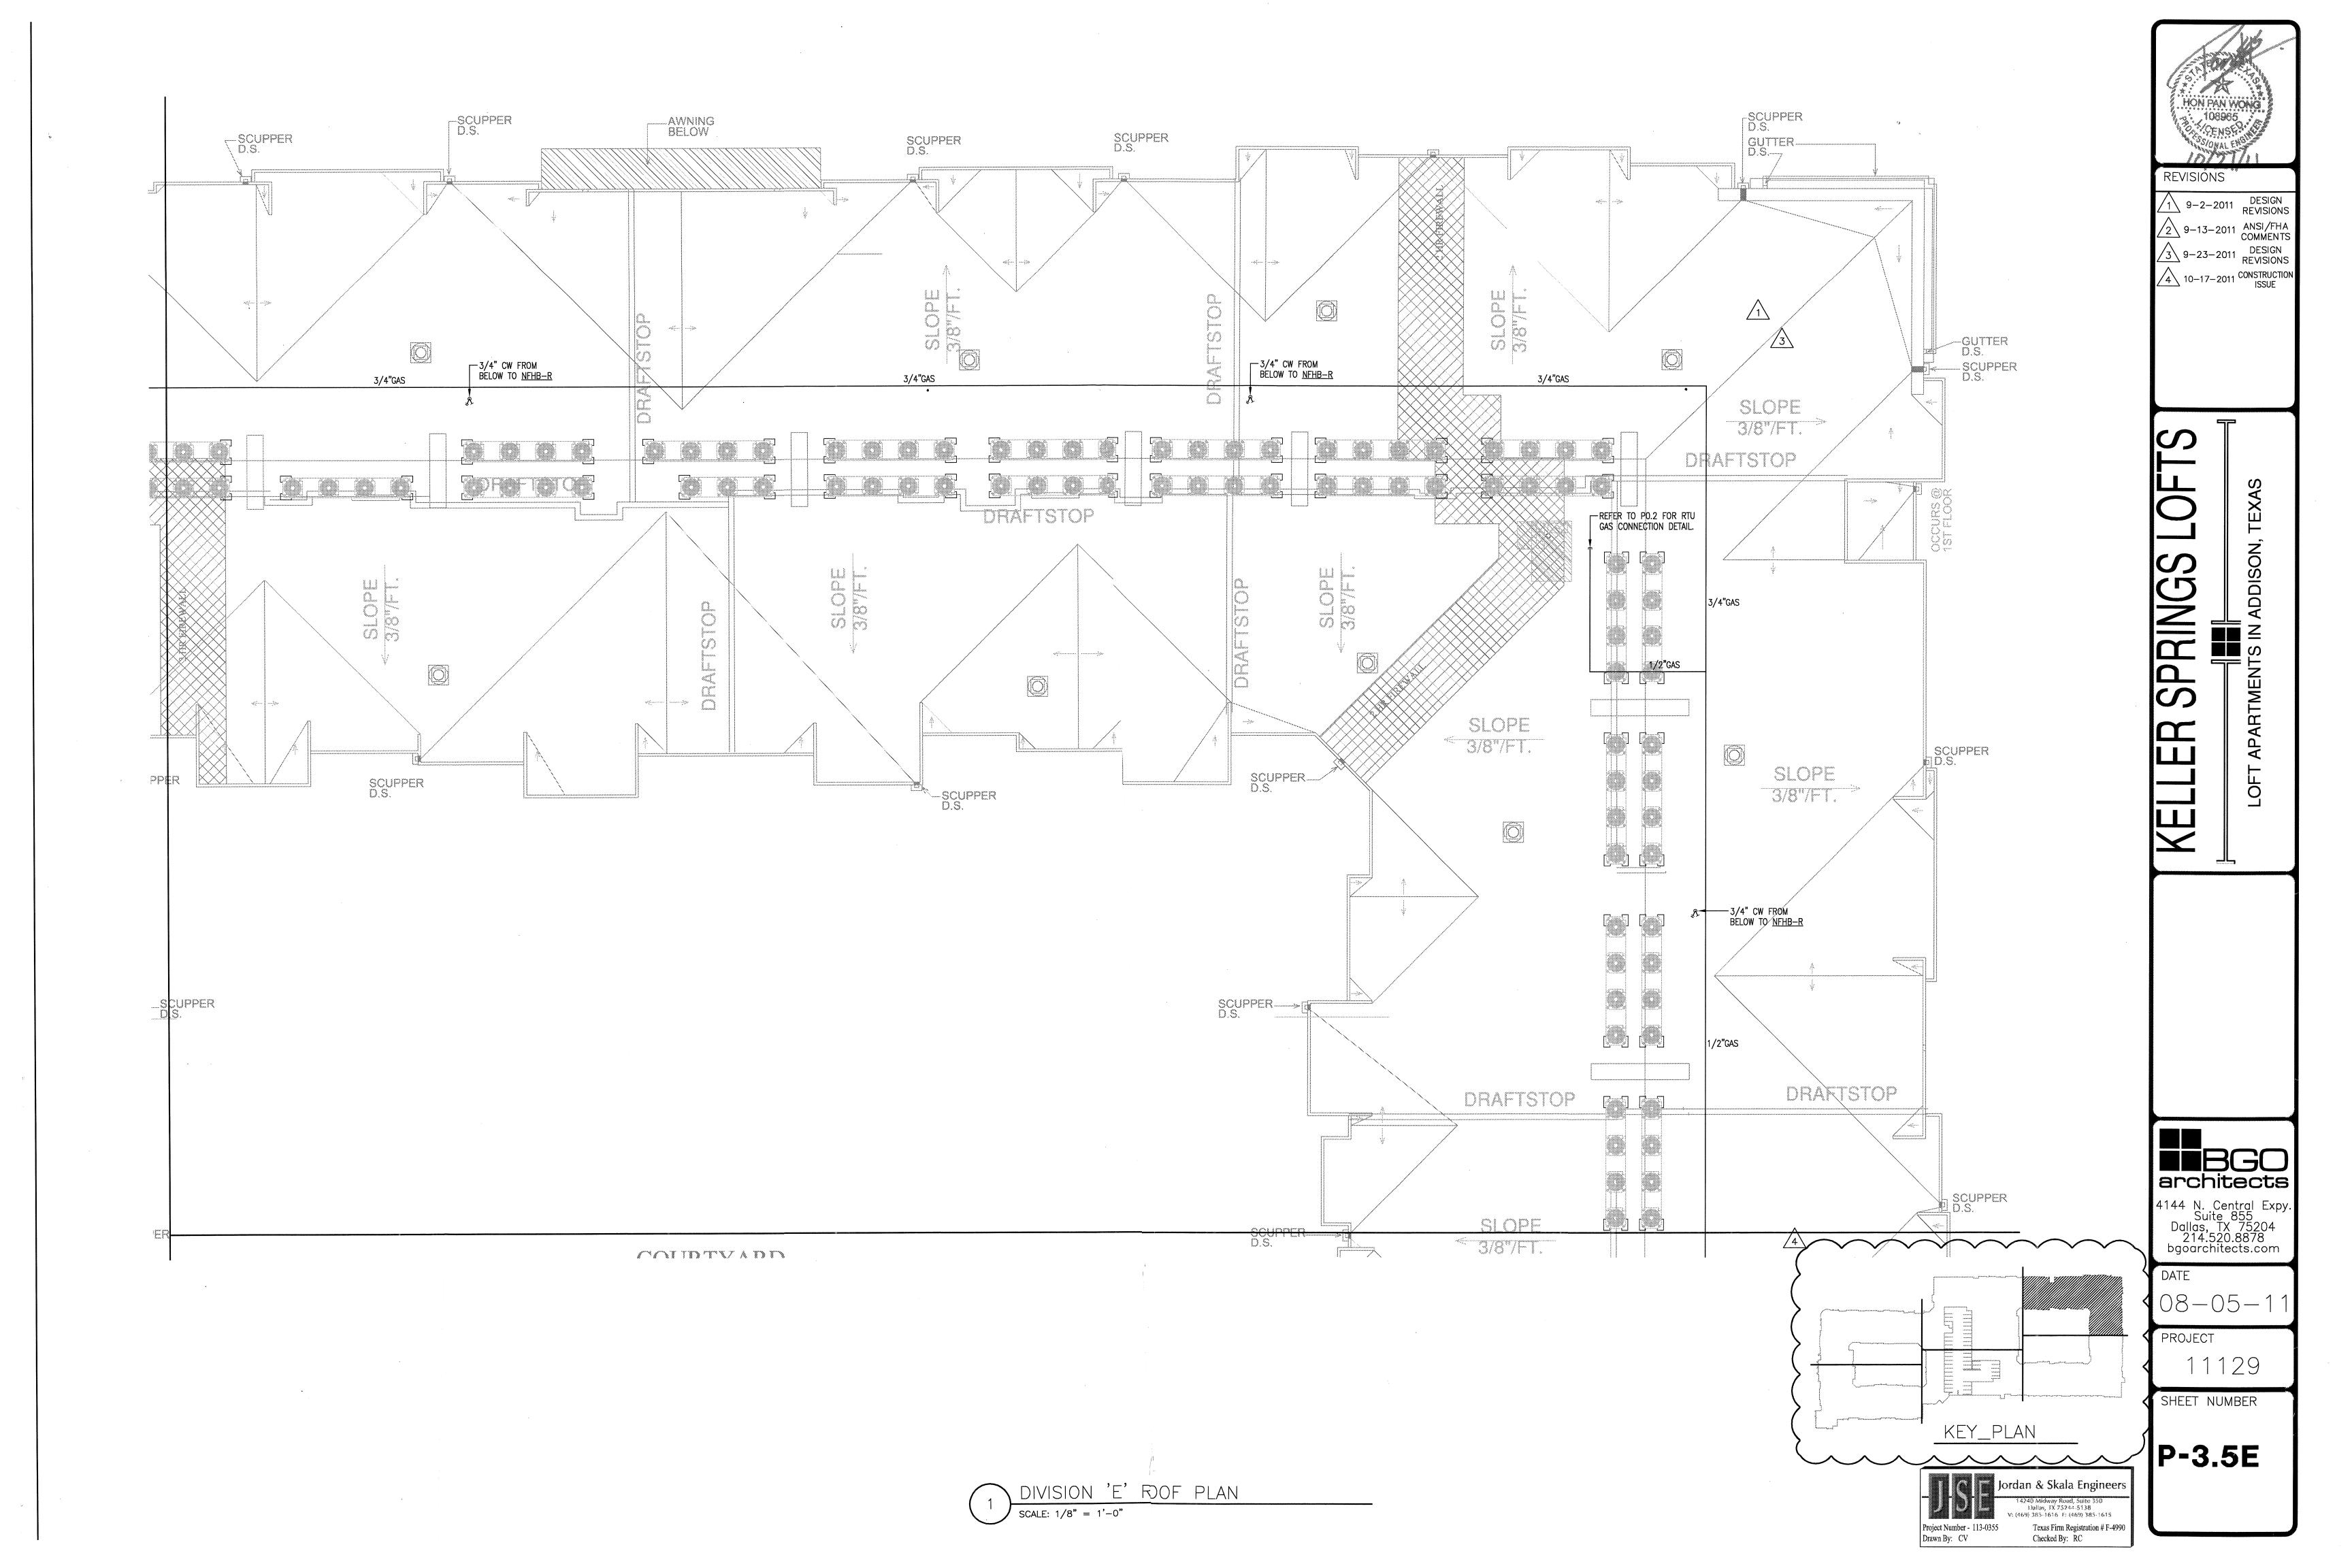

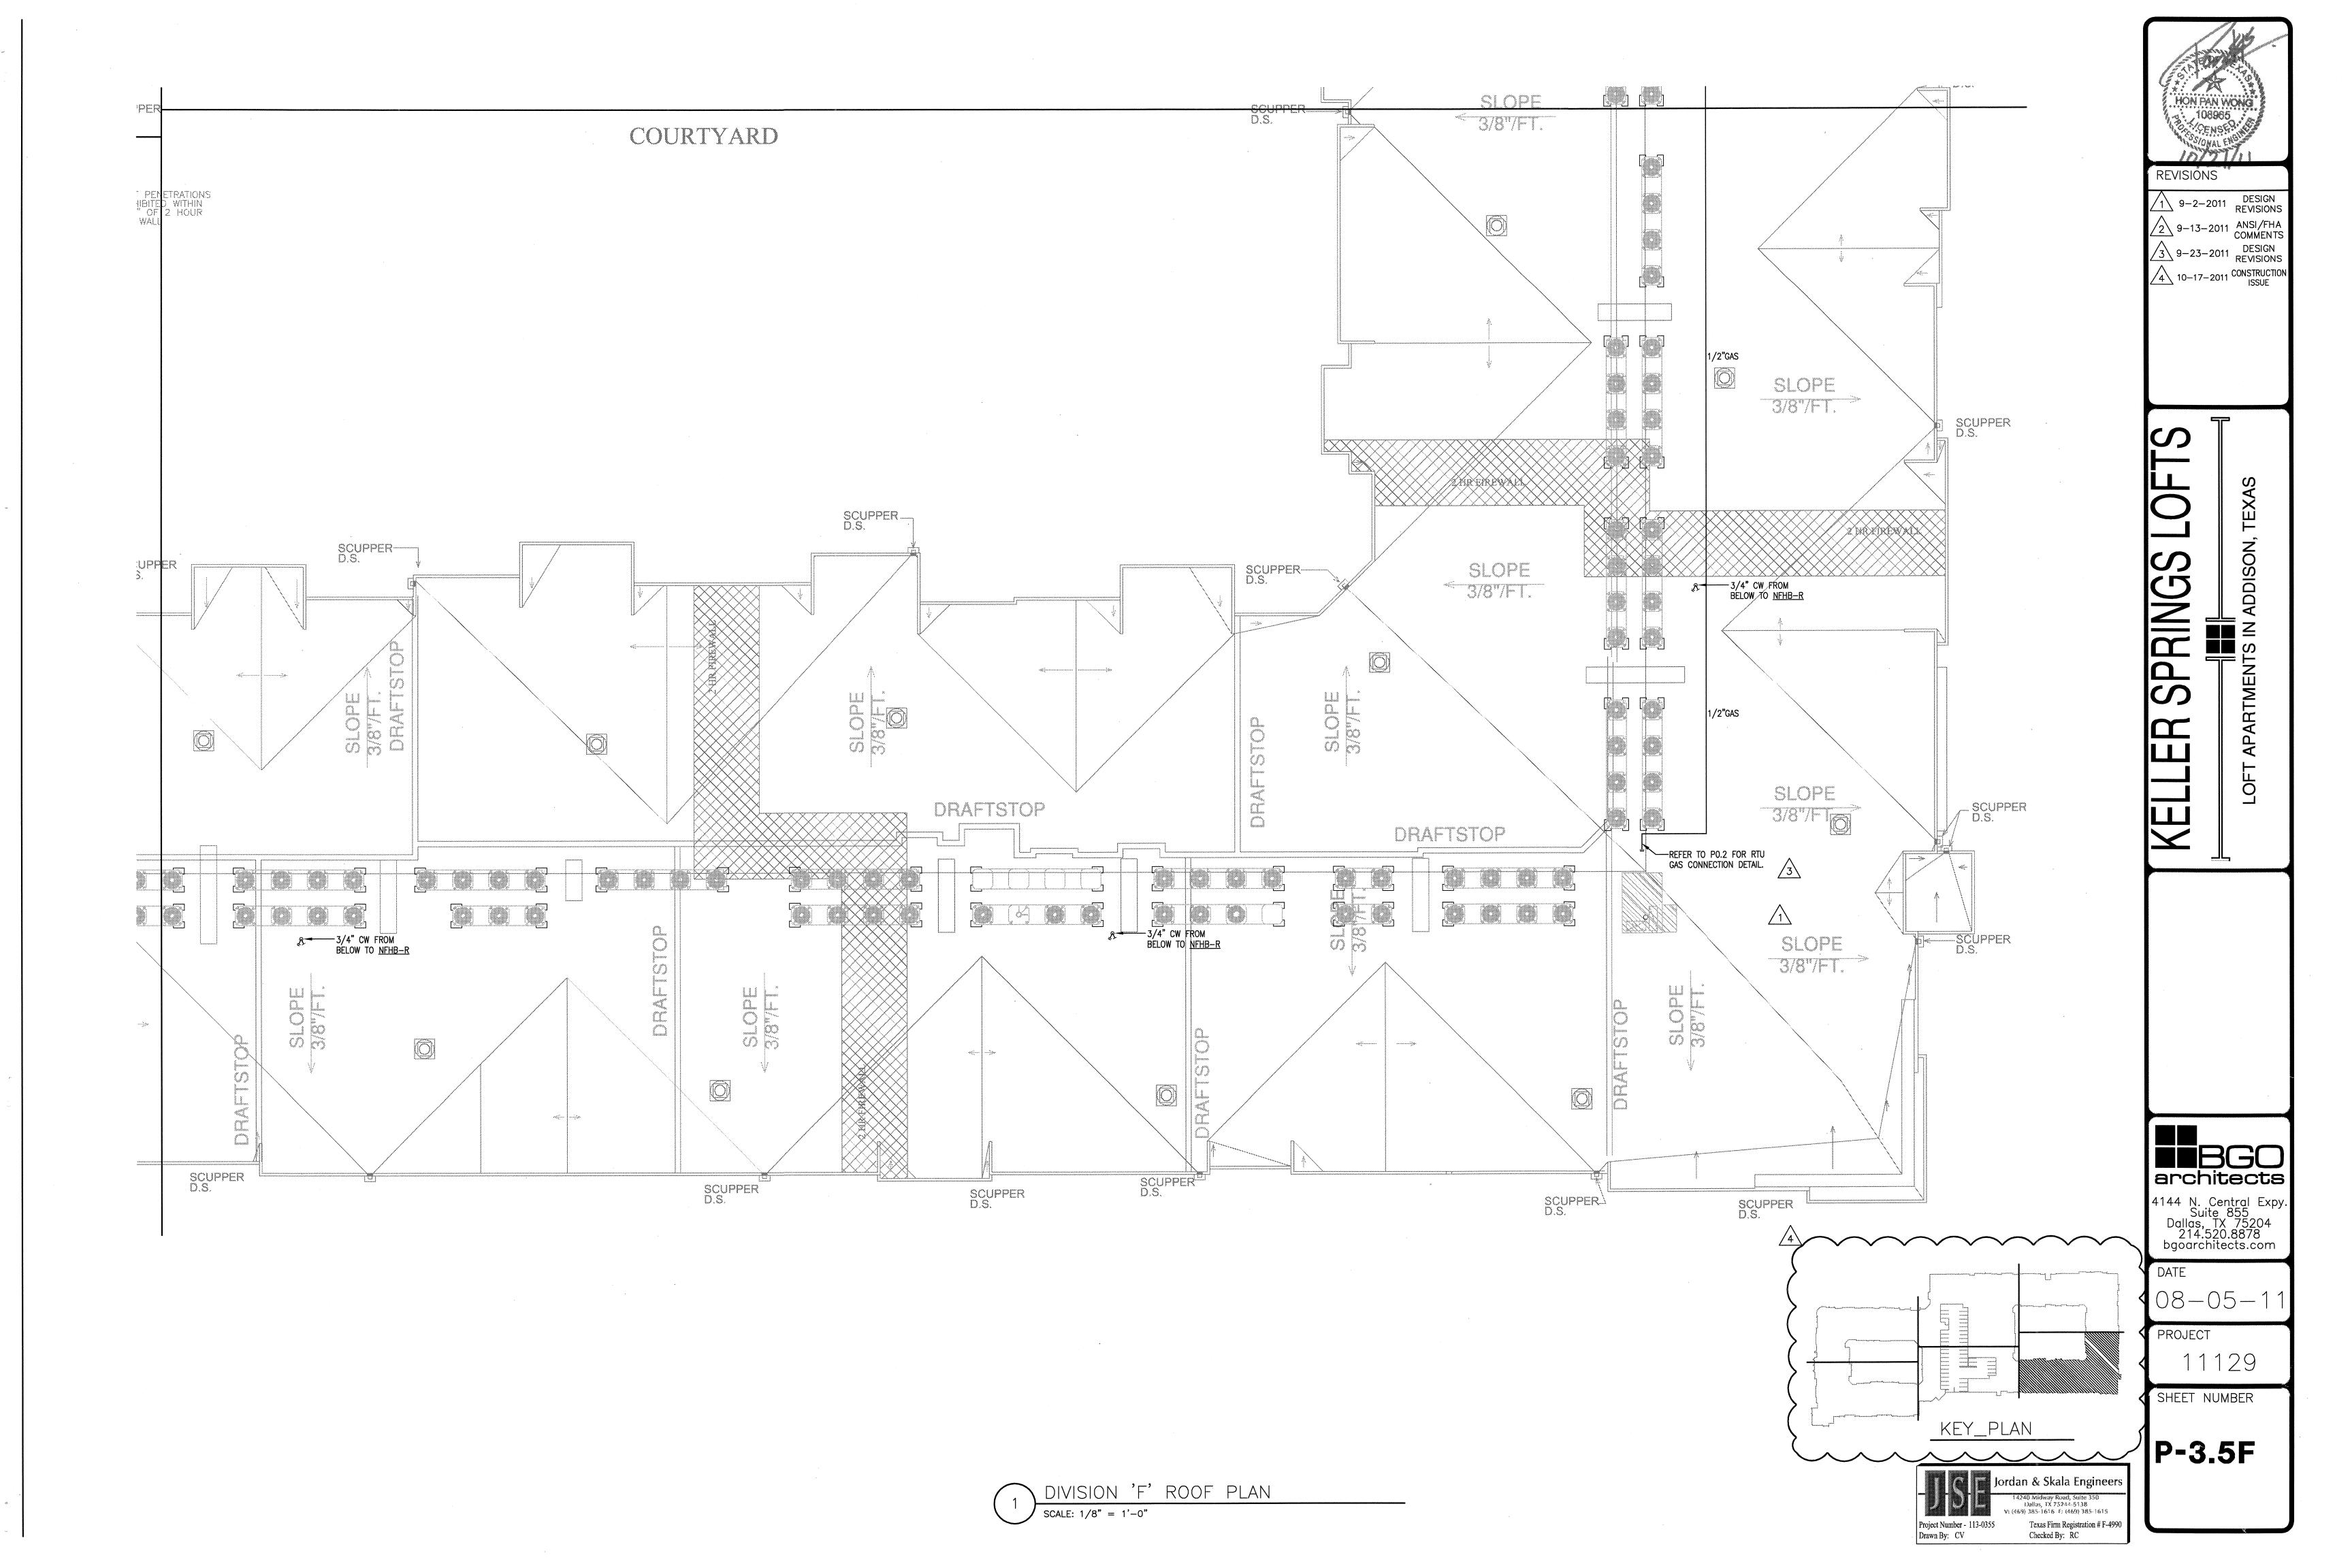

Embrey Builders, LLC 1020 N. E. Loop 410, Suite 700 San Antonio, TX 78209 Ph: (210) 824-6044 Fax: (210) 824-7656

RF	7	

To: Heath Parnell
Jordan & Skala Engineers, Inc.
14240 Midway Road, Suite 350 Dallas, TX 75244 Ph: 469/385-1616 Fax: 469/385-1615

Date: 6/1/2012 Job: EB-02 Keller Springs Lofts Phone: 877-777-5115

CC: Erik Earnshaw (Beeler Guest Owens Architects)

Subject: Trench Drain in Garage

Drawing: P-3.6 Cost Impact: None

Spec Section: Schedule Impact: None

Date Required: 6/11/2012 The trench drain shown on P-3.6 scales to about 24 feet in length. The actual opening in the double tee is about 6'-3" x 10". Is the 6'-3" size enough to handle the water load coming down the ramp? What size drain (depth) would be needed to handle the water? Requested by: David Miller

See the attached sketch sent for the latest trench drain layout and pipe sizing.

Embrey Builders LLC

Heath Parnell

Answered by
Jordan & Skala

Company


6/12/12


Page 1 of 1


RFI 137

X= CONNECTIONS

Should the Flange
be on top of the
Double-Tee deck t
The Topping pour be poured
over it. Or, should the
Flange be on Top of the
Topping pour?

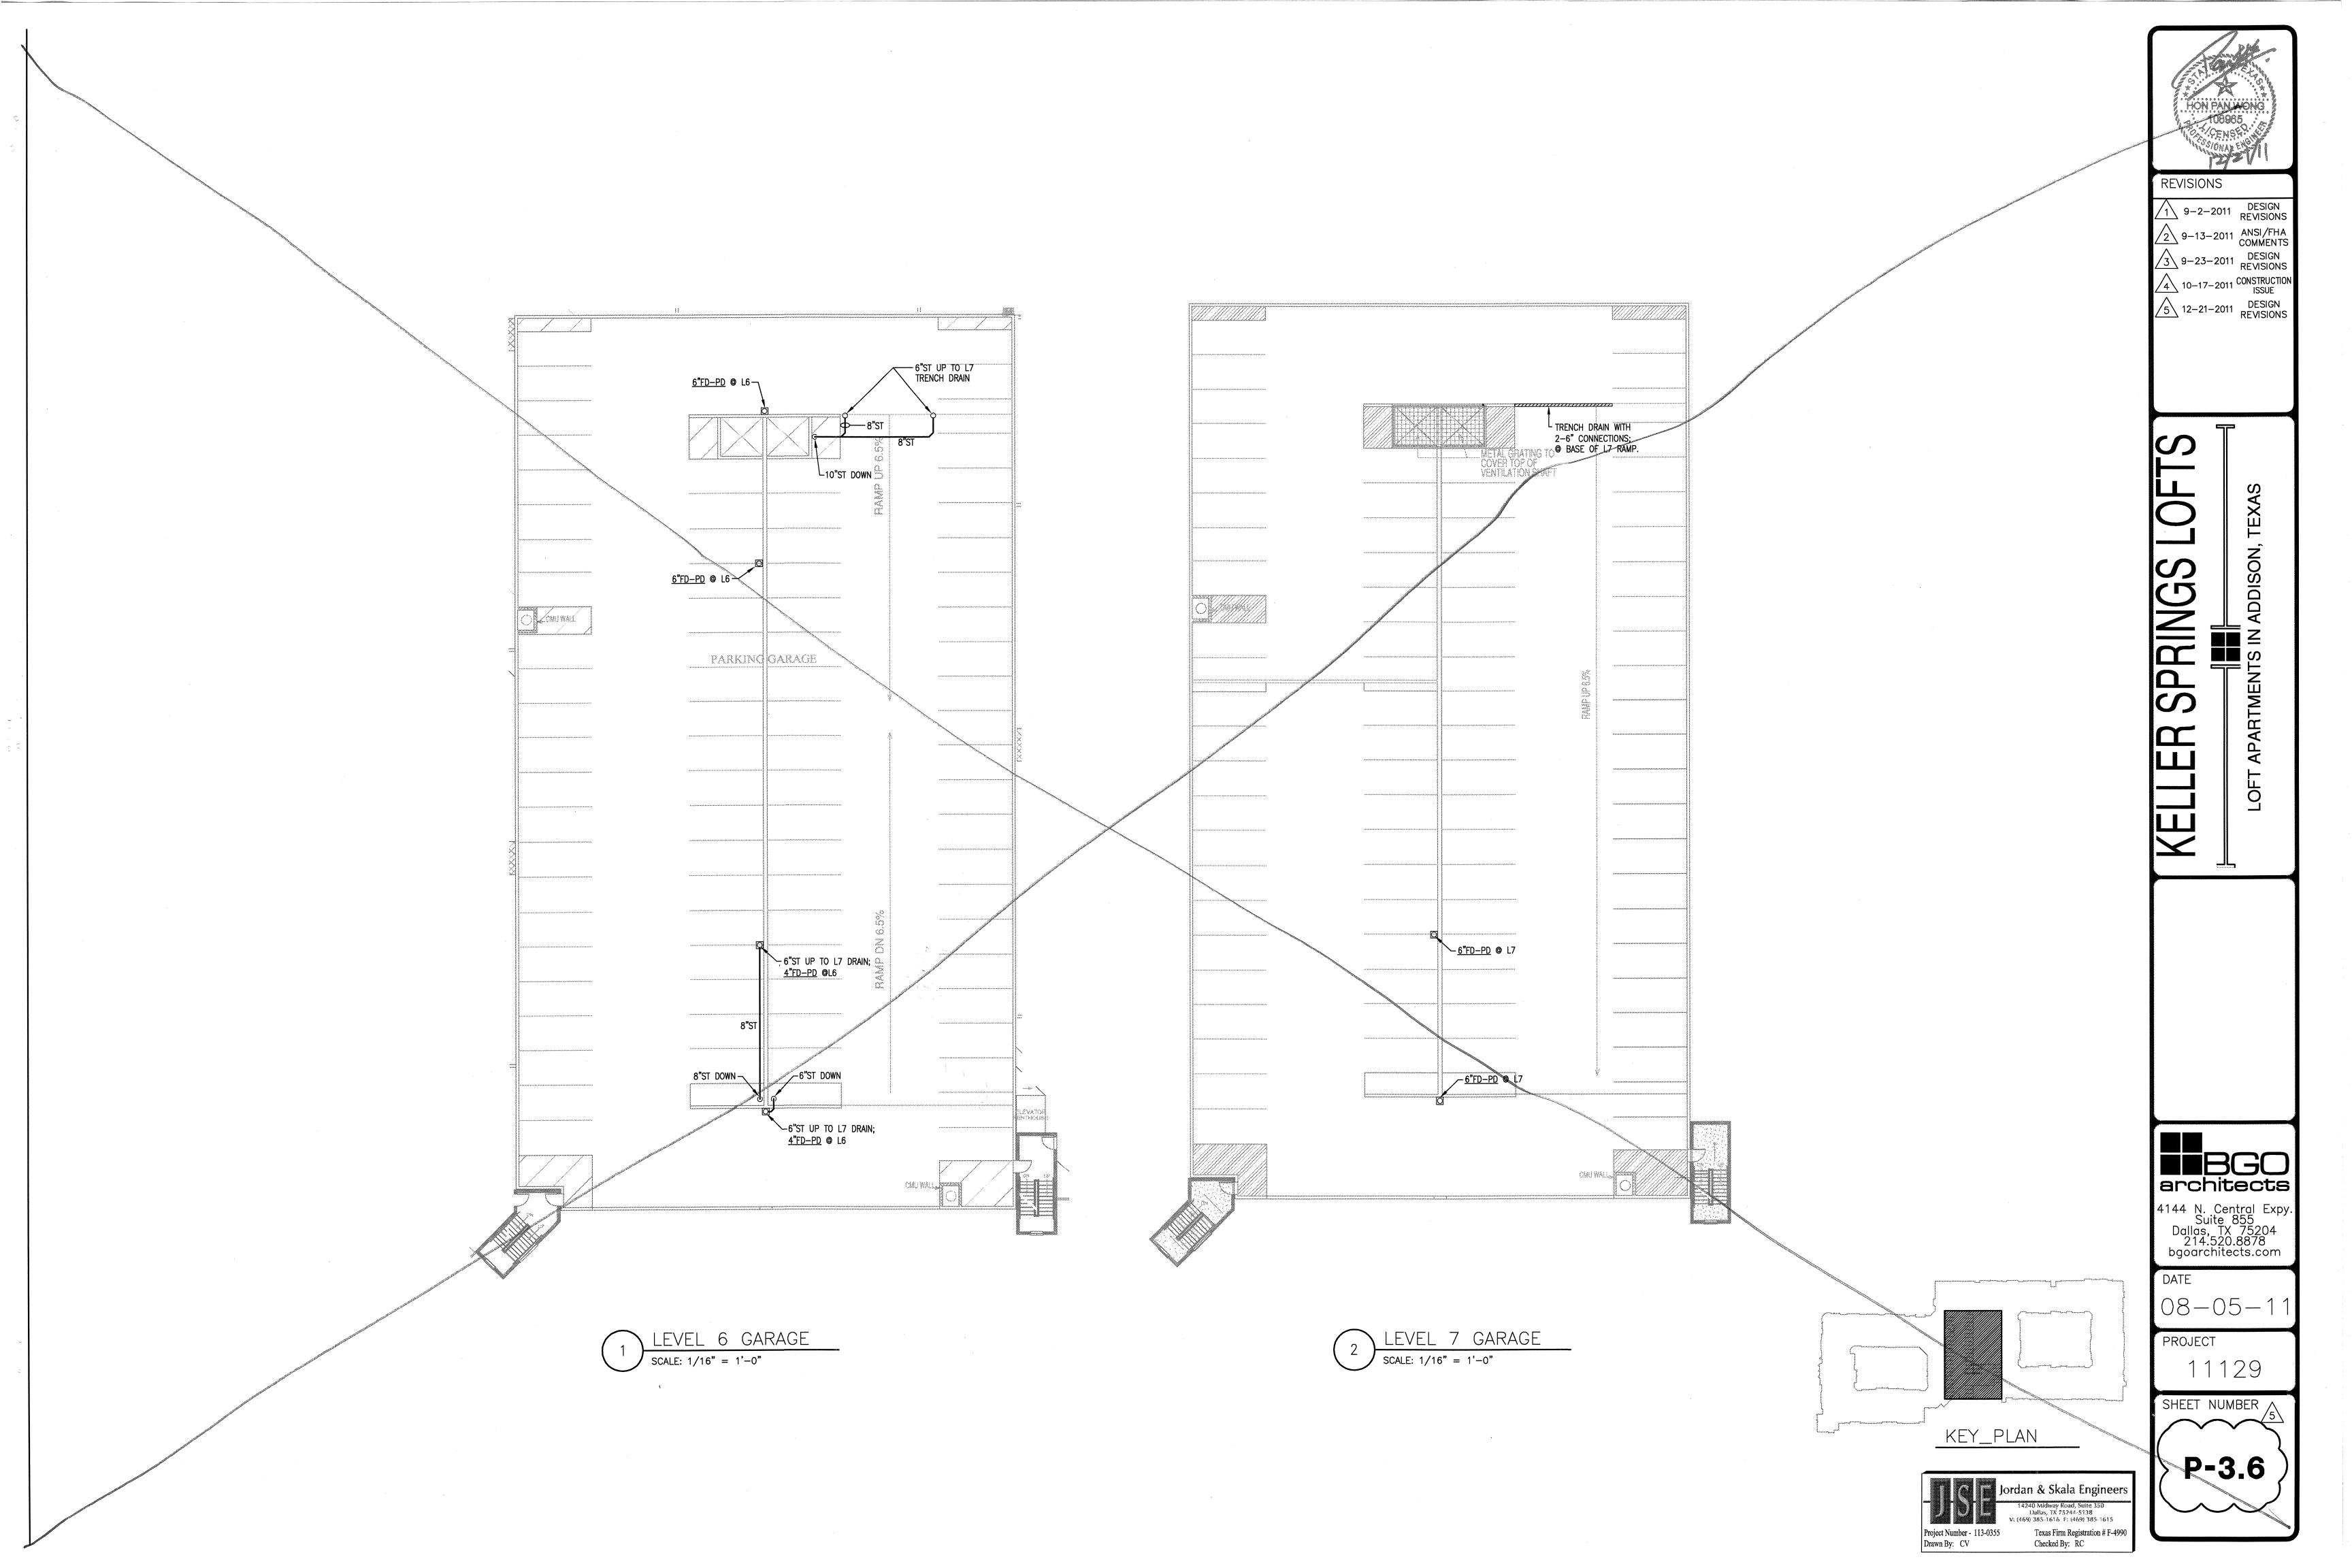

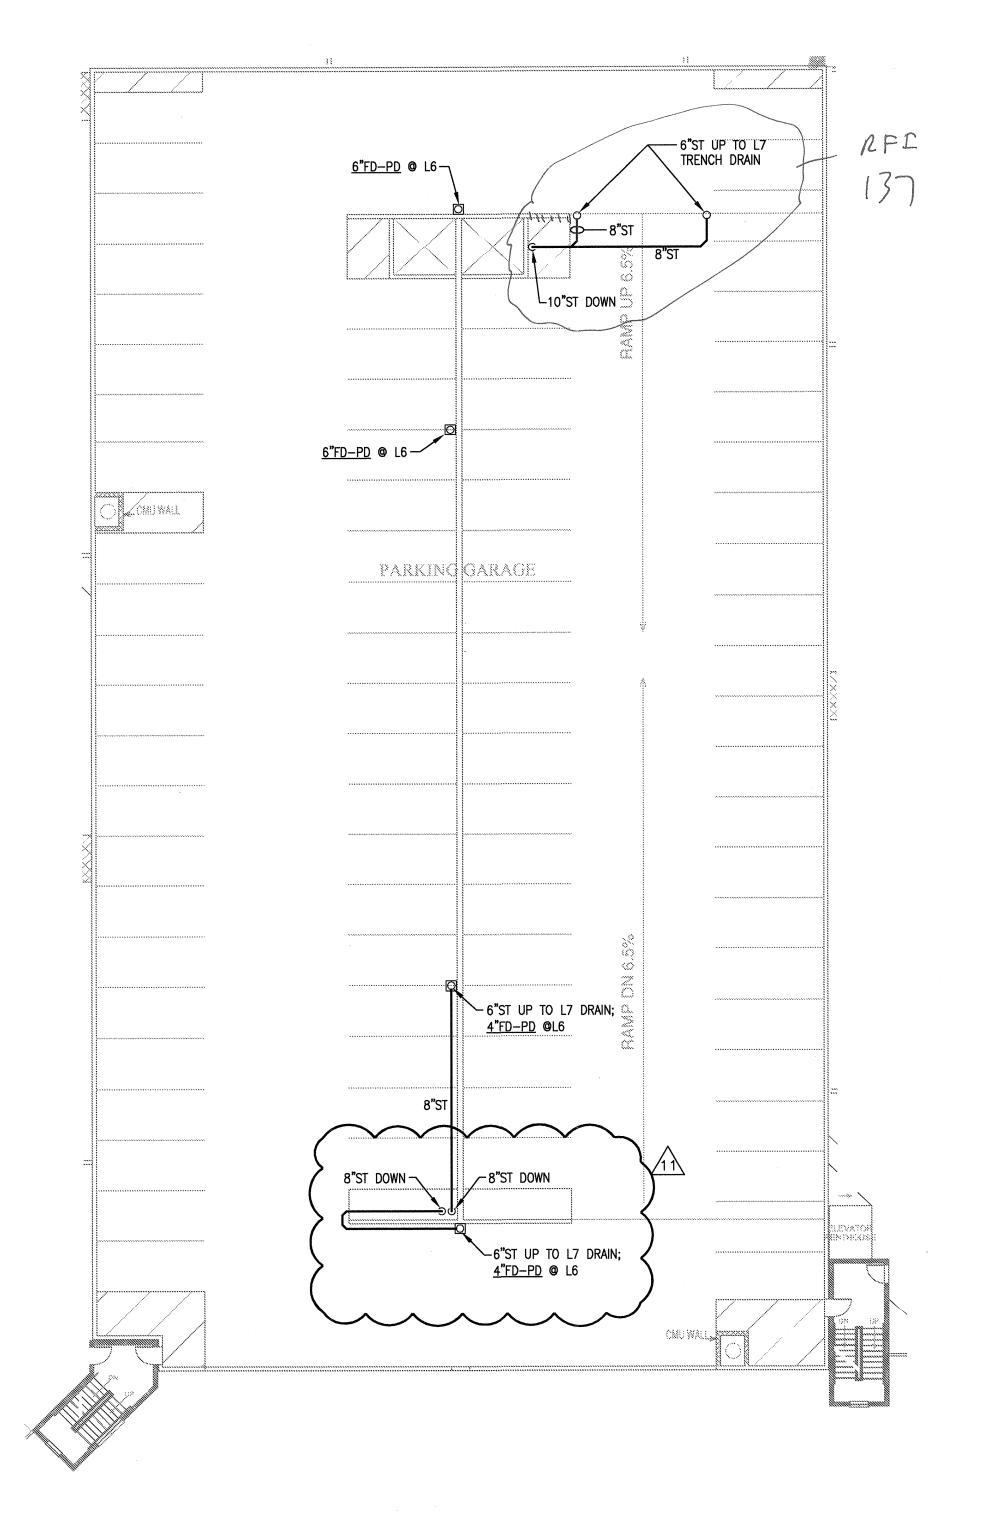

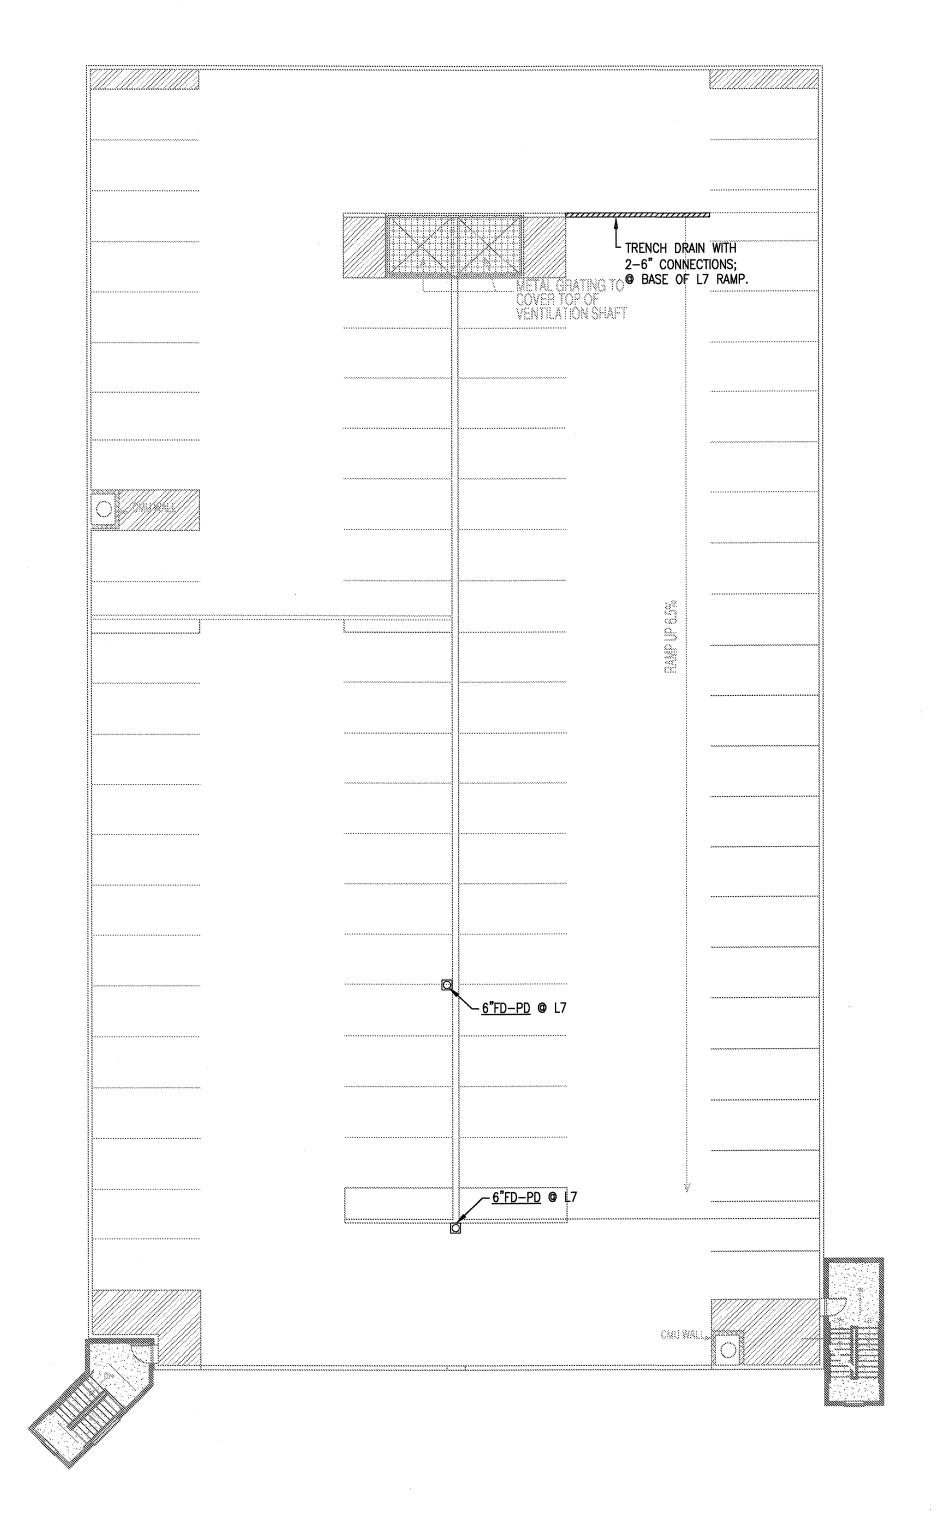

1 LEVEL 6 GARAGE

| SCALE: 1/16" = 1'-0"

2 LEVEL 7 GARAGE

SCALE: 1/16" = 1'-0"




REVISIONS

9-2-2011 DESIGN REVISIONS
ANSI/FHA COMMENTS DESIGN REVISIONS
3 9-23-2011 REVISIONS
CONSTRUCTION ISSUE
DESIGN REVISIONS
12-21-2011 DESIGN REVISIONS
DESIGN REVISIONS
TRANSFORMER
2-15-2012 REVISIONS
A-27-2012 REVISIONS
REVISIONS
CLUBHOUSE REVISIONS
A-17-2012 COORDINATION

TMENTS IN ADDISON, TEXAS

5-15-2012 COORDINATION 5-30-2012 SITE COORDINATION




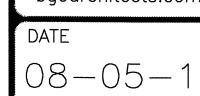

PROJECT


SHEET NUMBER


P-3.6

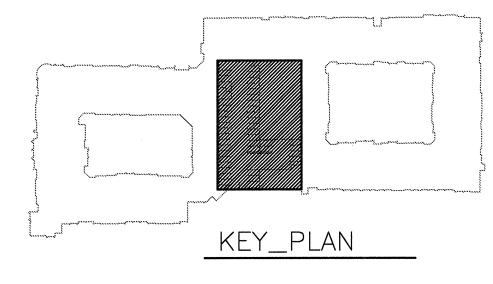

17855 N. Dallas Parkway., Suits 320 Dallas, TX 75287-6857 5 (469) 385-1616 Webewww.jordanskala.co

Texas Firm Registration # F-4990 Checked By: RC

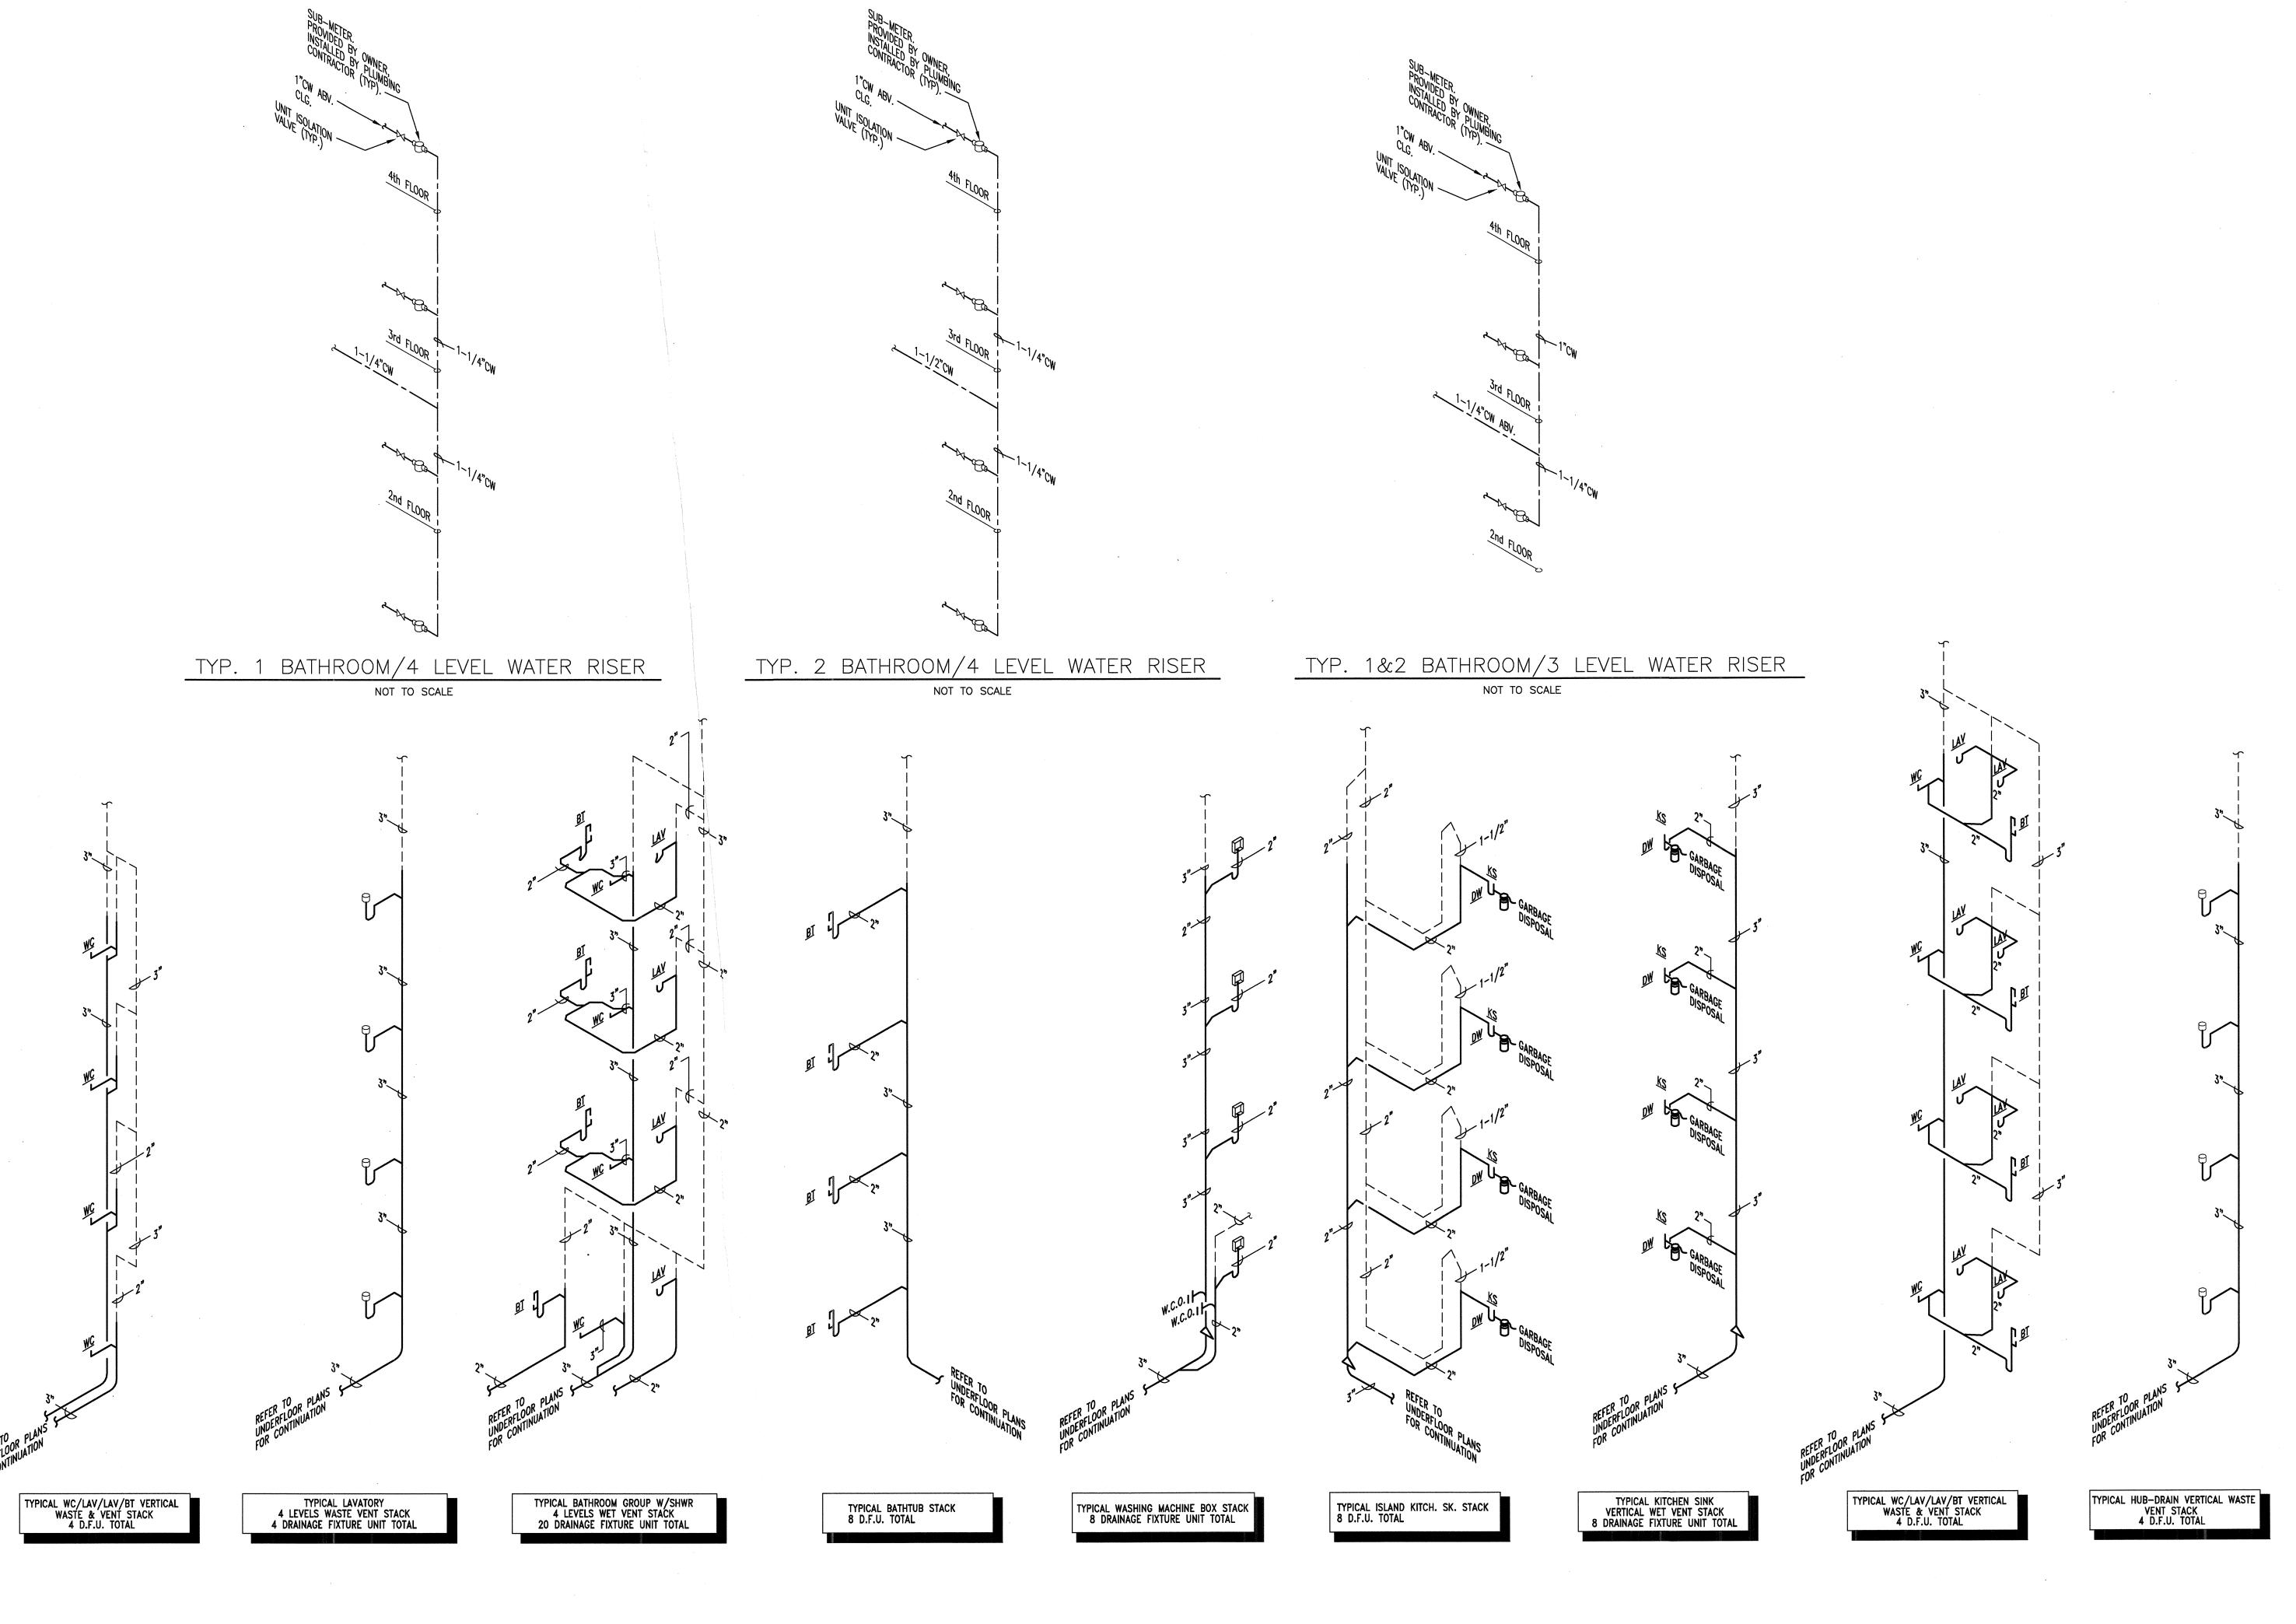

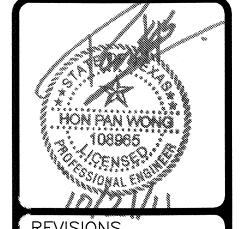

1 9-2-2011 DESIGN REVISIONS

9-13-2011 ANSI/FHA COMMENTS 3 9-23-2011 DESIGN REVISIONS 4 10-17-2011 CONSTRUCTION ISSUE

**BBGO** architects 4144 N. Central Expy. Suite 855 Dallas, TX 75204 214.520.8878 bgoarchitects.com

PROJECT

SHEET NUMBER

P-4.1

Jordan & Skala Engineers 14248 Midway Road, Suite 358 Dallas, 3X 75244-5138 V: (469) 385-1616 F: (469) 385-1615 Project Number - 113-0355 Drawn By: CV Texas Firm Registration # F-4990 Checked By: RC

EMBREY BUILDERS, LLC. 1020 N. E. Loop 410, Suite 700 San Antonio, TX 78209 Ph : (210) 824-6044 Fax: (210) 824-7656

To: Jordan & Skala Engineers, Inc. 14240 Midway Road, Suite 350 Dallas, TX 75244

Ph: 469/385-1616 Fax: 469/385-1615

Date: 2/23/2012 Job: EB-02 Keller Springs Lofts Phone: 877-777-5115

CC: Erik Earnshaw (BGO)

Subject: revised scale to corrdinate with Architectural and Plumbing sheets


**Drawing:** 4/6.4, 3.1D, P-3.1D, P-9.1 Cost Impact: None

Spec Section: Schedule Impact: None

Architectural 4/6.4 show inside dimensions for the Pump Room as 24'-8" X 17'-10", sheet 3.1D and P3.1D scale out the same using the 1/8" scale. Going to P-9.1 (which my plumber did) and using the ½" scale that is called out, the room scales to 21'-9" X 15'-6". The detail and sheet needs to be revised to scale to the correct dimensions which are 24'-8" X17'-10" this error has already created problems with my plumber who had to move his plumbing underground after using the detail on P-9.1. Requested by: Bryan Pickler Embrey Partners, Ltd. See attached sheet P-9.1 for corrected plan scale.

Russell Cox 3-01-2012 Jordan & Skala

Page 1 of 1

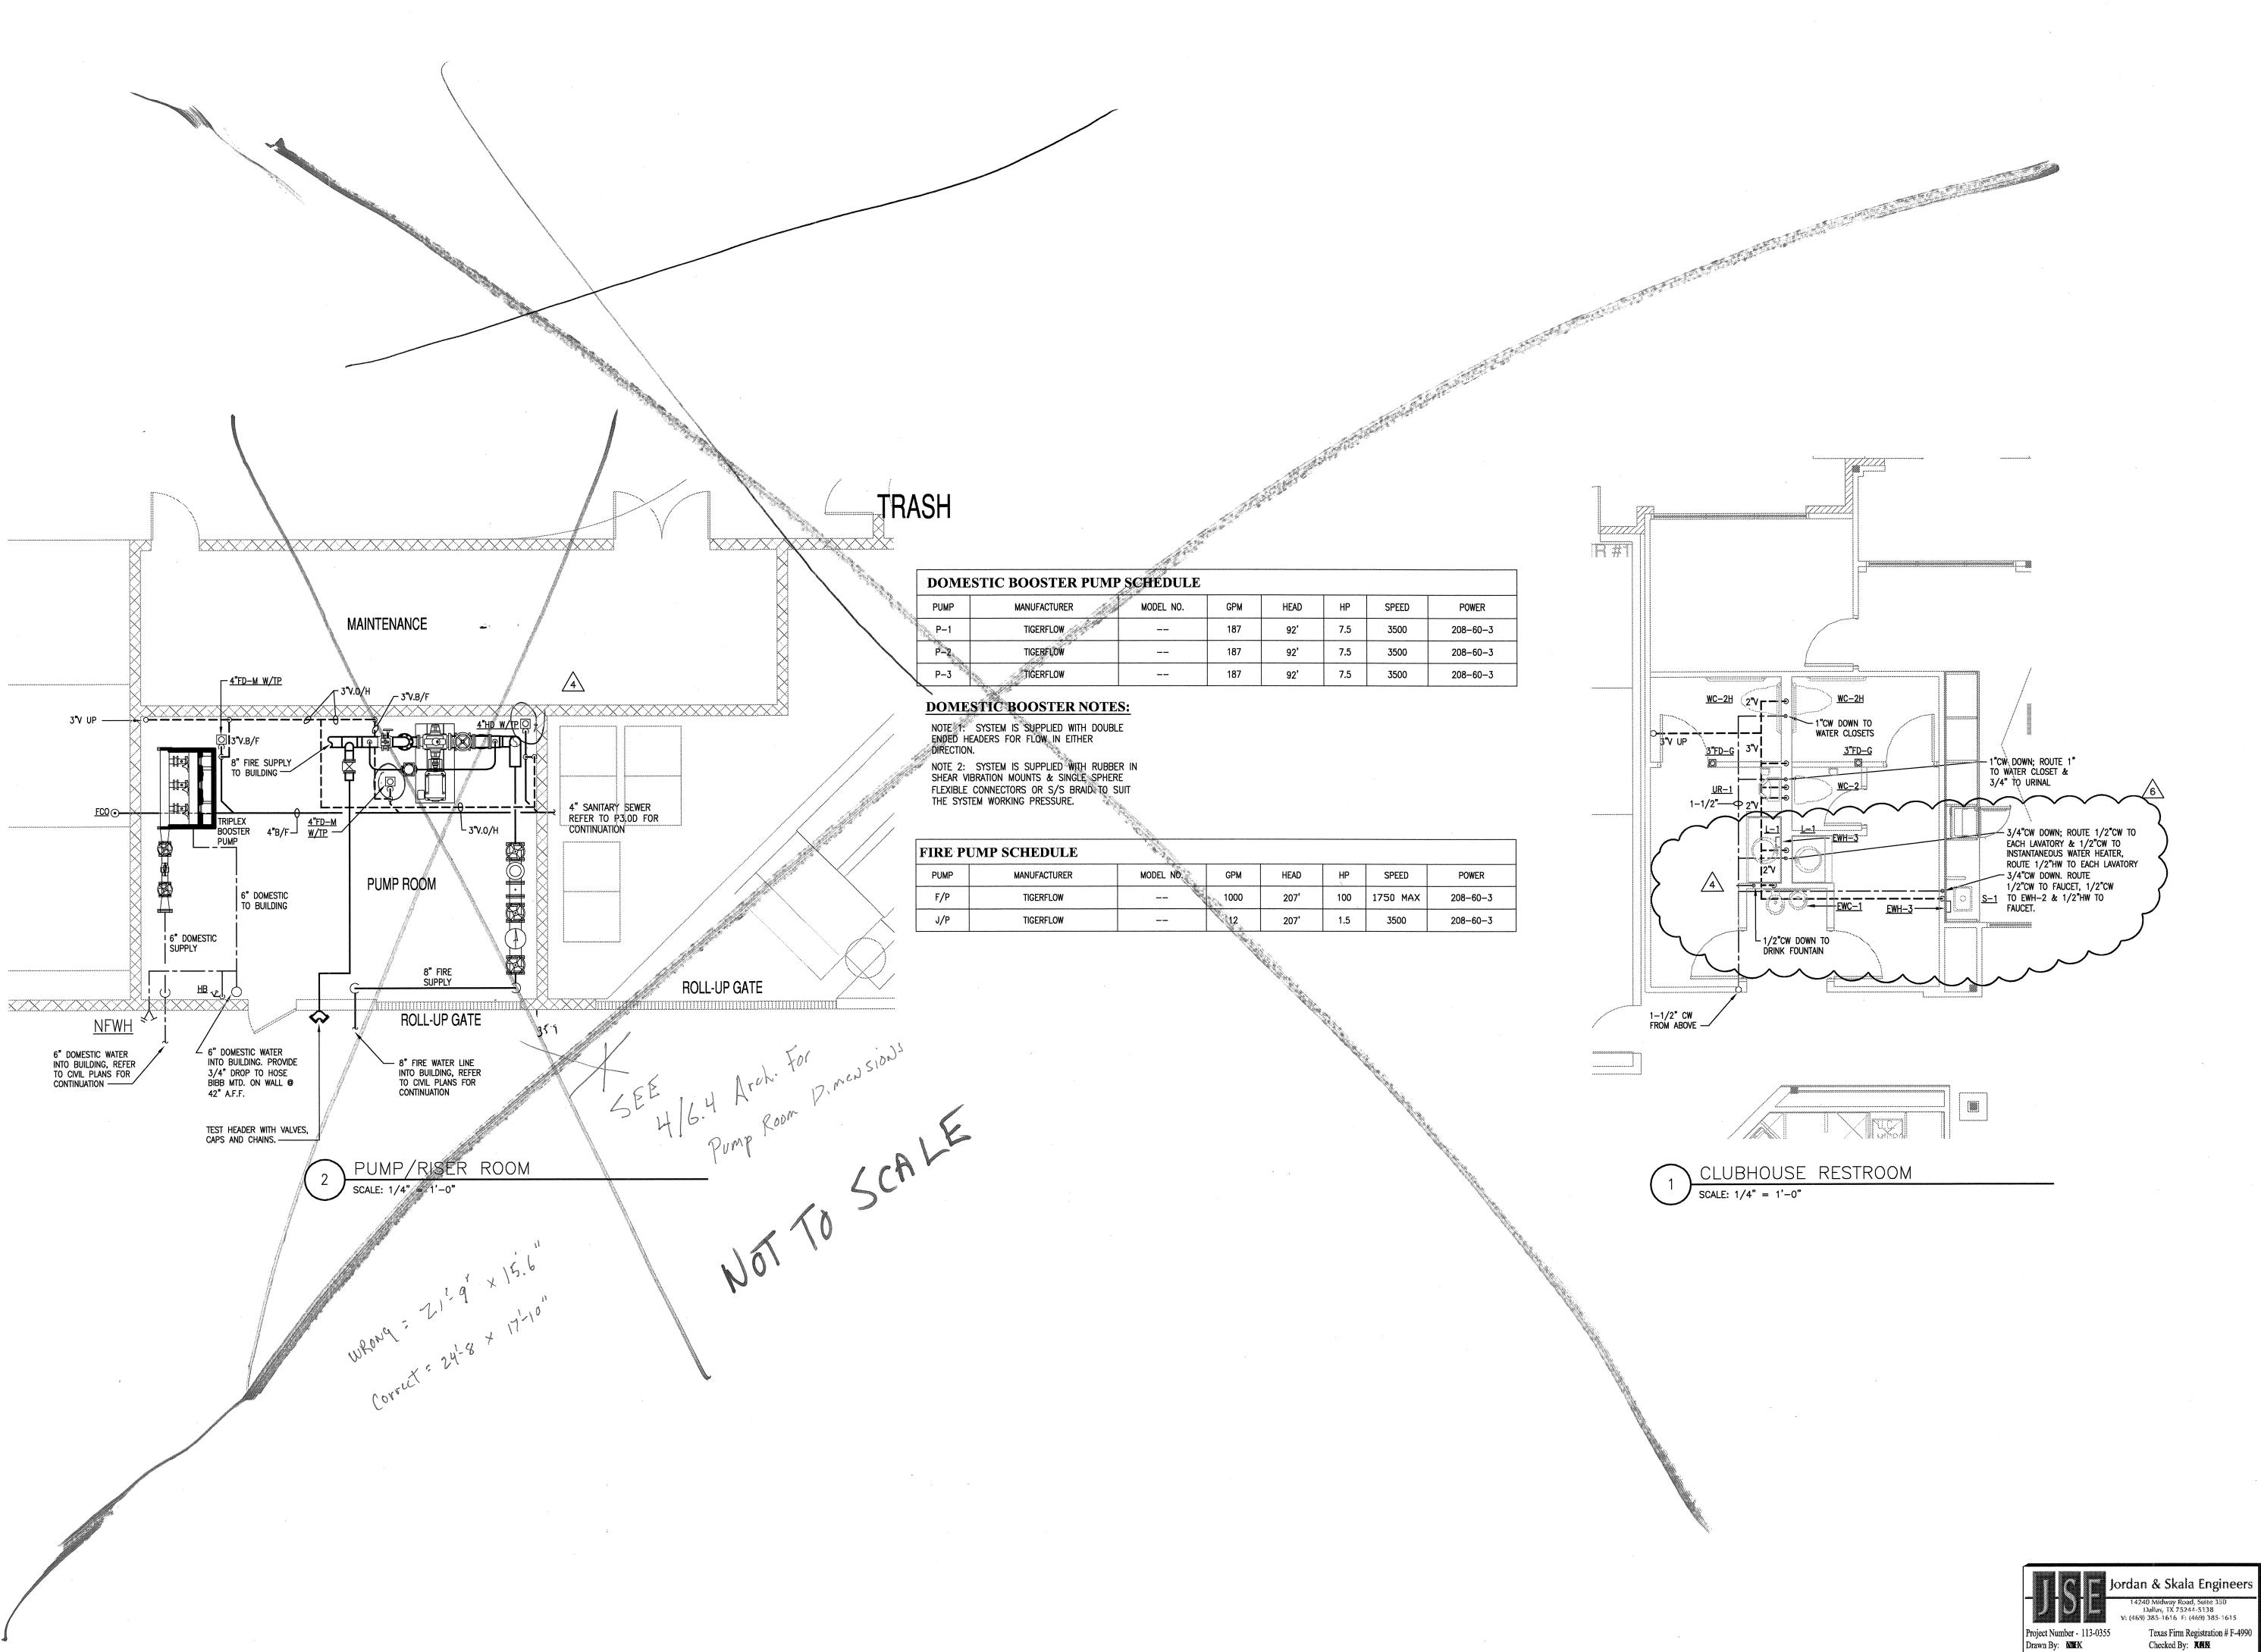

9-2-2011 DESIGN REVISIONS 2 9-13-2011 ANSI/FHA COMMENTS 9-23-2011 DESIGN REVISIONS 4\ 10-17-2011 CONSTRUCTION

5 12-21-2011 DESIGN REVISIONS 6 1-17-2012 DESIGN REVISIONS

BGO architects

4144 N. Central Expy. Suite 855 Dallas, TX 75204 214.520.8878 bgoarchitects.com

DATE


Checked By: KAN

08-05-1

PROJECT

11129 SHEET NUMBER

P-9.1

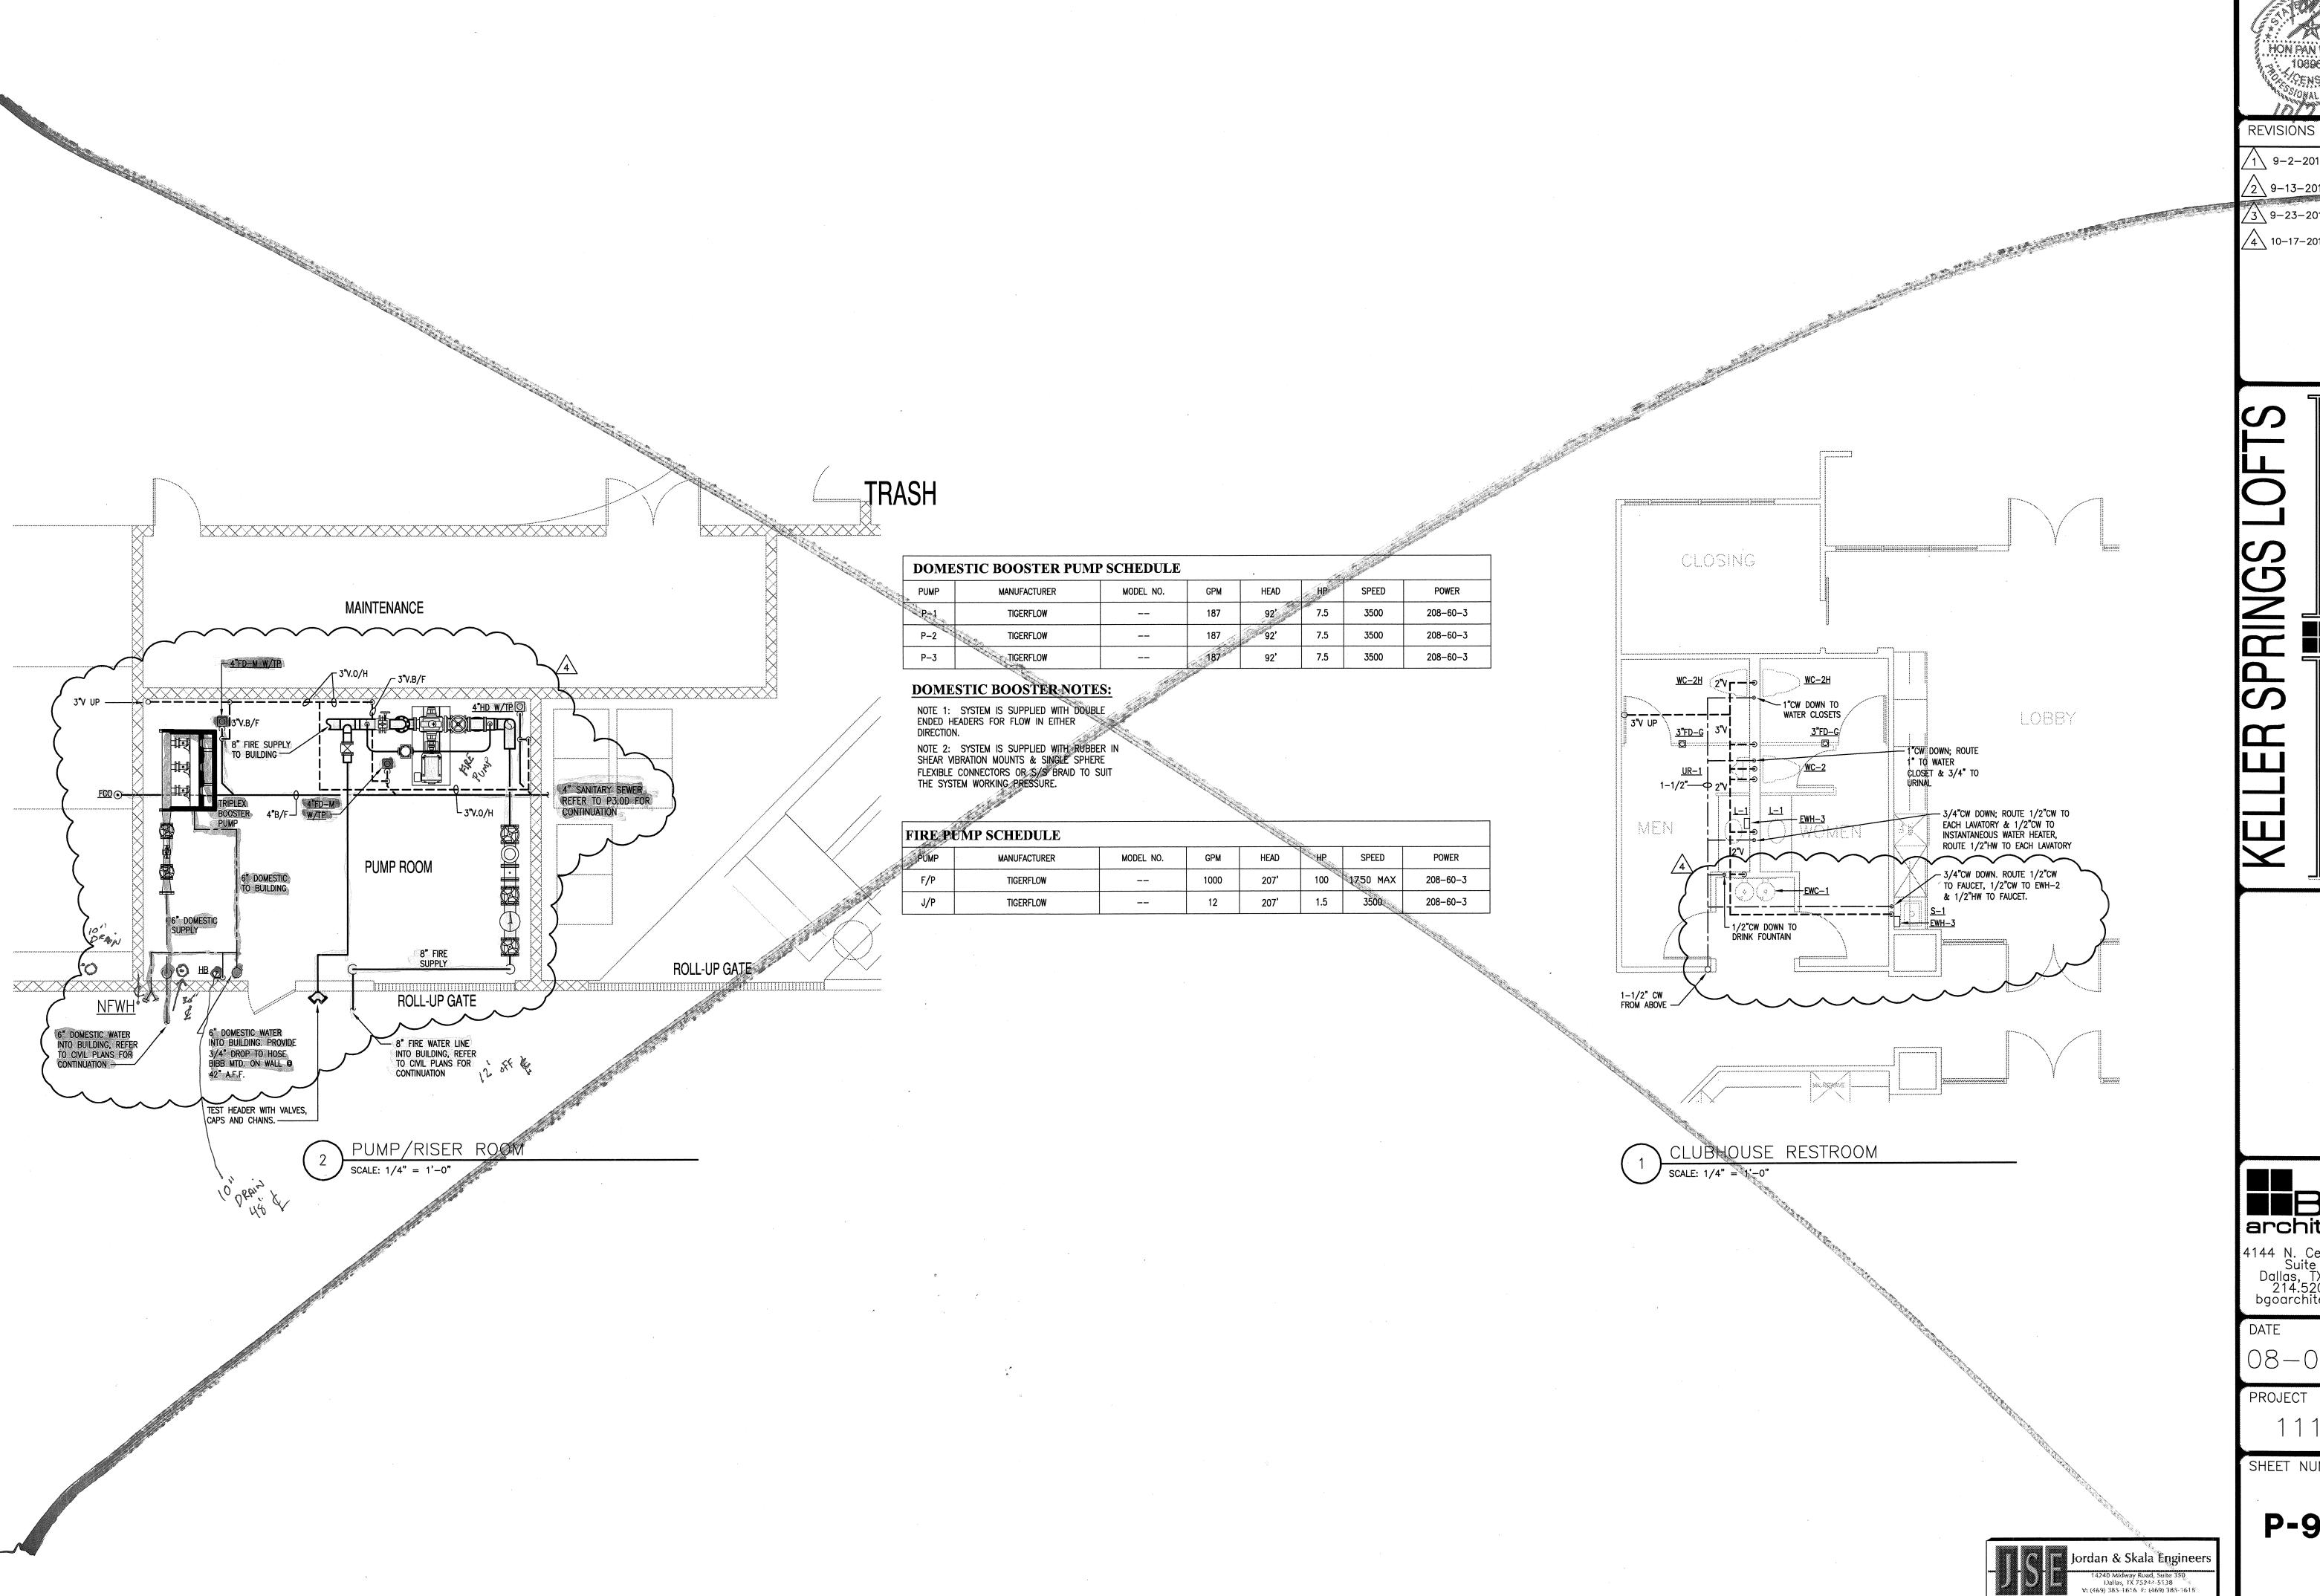

1 9-2-2011 DESIGN REVISIONS 9-13-2011 ANSI/FHA 3 9-23-2011 DESIGN REVISIONS 4 10-17-2011 CONSTRUCTION ISSUE

**BBGO** architects

4144 N. Central Expy. Suite 855 Dallas, TX 75204 214.520.8878 bgoarchitects.com

08-05-11


SHEET NUMBER


P-9.1

Project Number - 113-0355 Drawn By: CV

Texas Firm Registration # F-4990

Checked By: RC

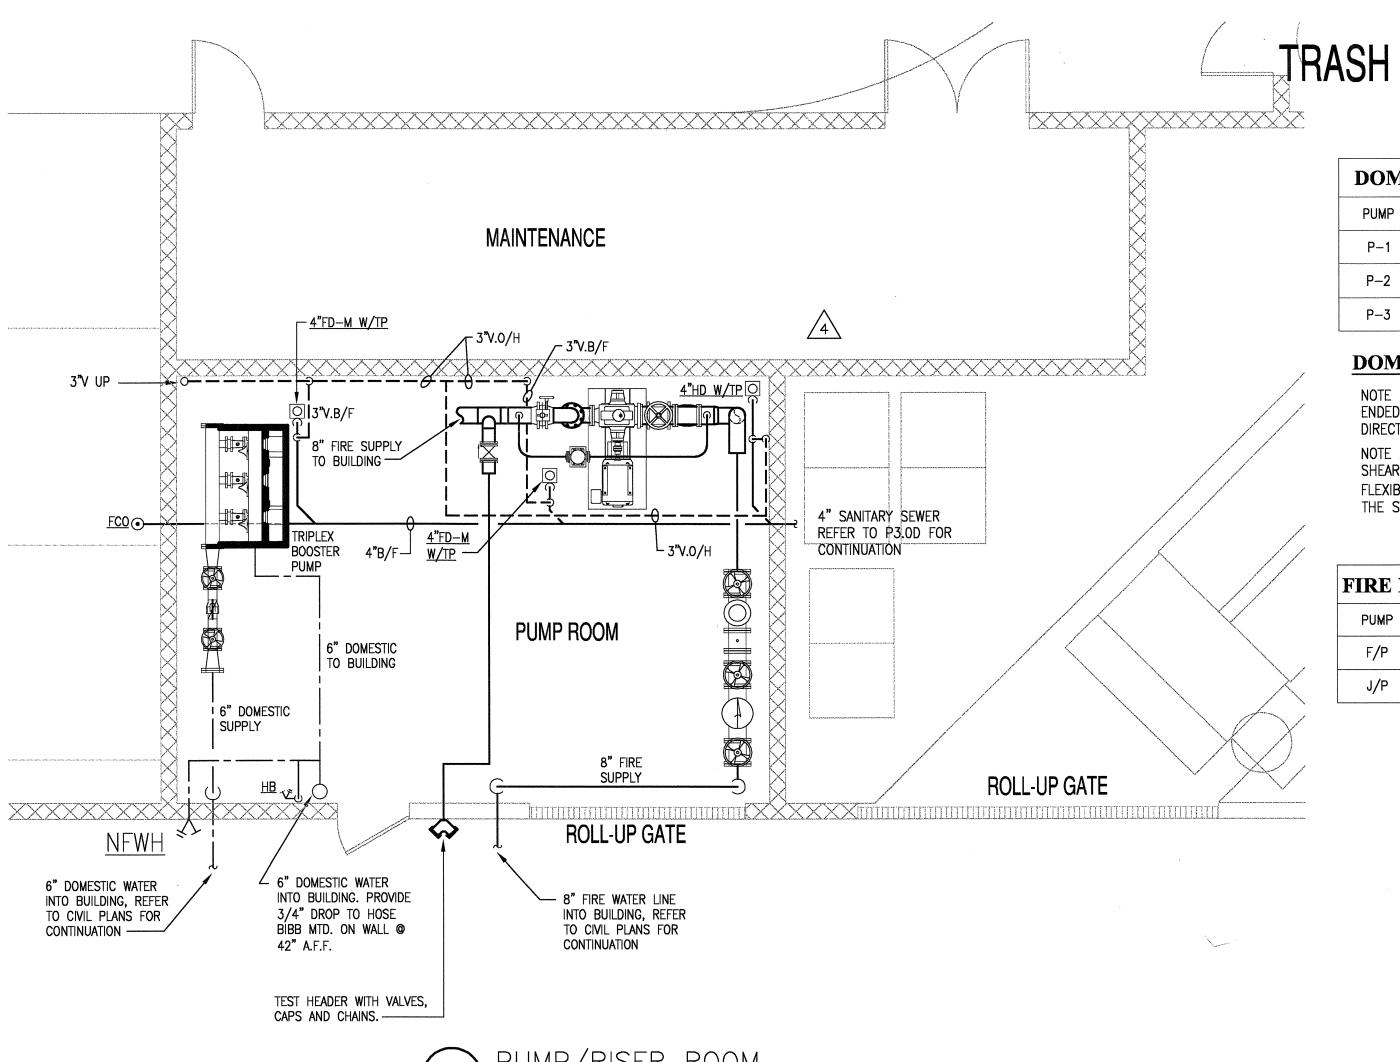

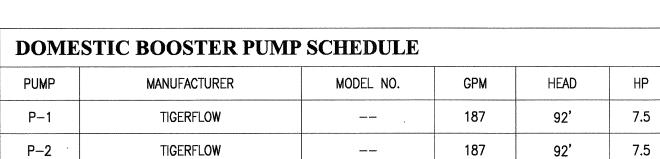

## **DOMESTIC BOOSTER NOTES:**

TIGERFLOW

NOTE 1: SYSTEM IS SUPPLIED WITH DOUBLE ENDED HEADERS FOR FLOW IN EITHER DIRECTION.

NOTE 2: SYSTEM IS SUPPLIED WITH RUBBER IN SHEAR VIBRATION MOUNTS & SINGLE SPHERE FLEXIBLE CONNECTORS OR S/S BRAID TO SUIT THE SYSTEM WORKING PRESSURE.

FIRE P	UMP SCHEDULE						
PUMP	MANUFACTURER	MODEL NO.	GPM	HEAD	HP	SPEED	POWER
F/P	TIGERFLOW		1000	207'	100	1750 MAX	208-60-3
J/P	TIGERFLOW		12	207'	1.5	3500	208-60-3

POWER

208-60-3


208-60-3


208-60-3

SPEED

3500

3500

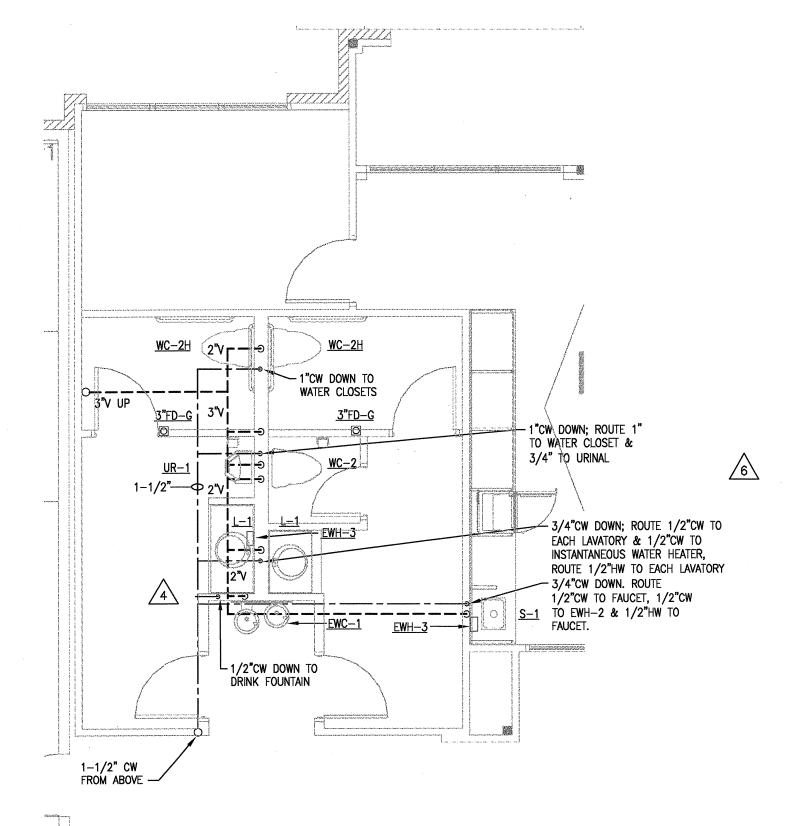

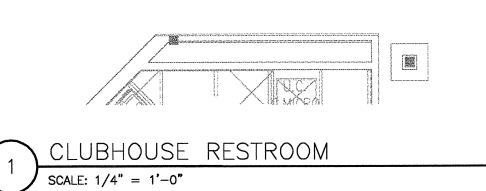



REVISIONS

9-2-2011 DESIGN REVISIONS

9-13-2011 ANSI/FHA COMMENTS

3 9-23-2011 DESIGN REVISIONS

4 10-17-2011 CONSTRUCTION

5 12-21-2011 DESIGN REVISIONS

6 1-17-2012 DESIGN REVISIONS

TRANSFORMER 2-15-2012 REVISIONS

4144 N. Central Expy. Suite 855 Dallas, TX 75204 214.520.8878 bgoarchitects.com


DATE 08-05-11

PROJECT

SHEET NUMBER

P-9.1



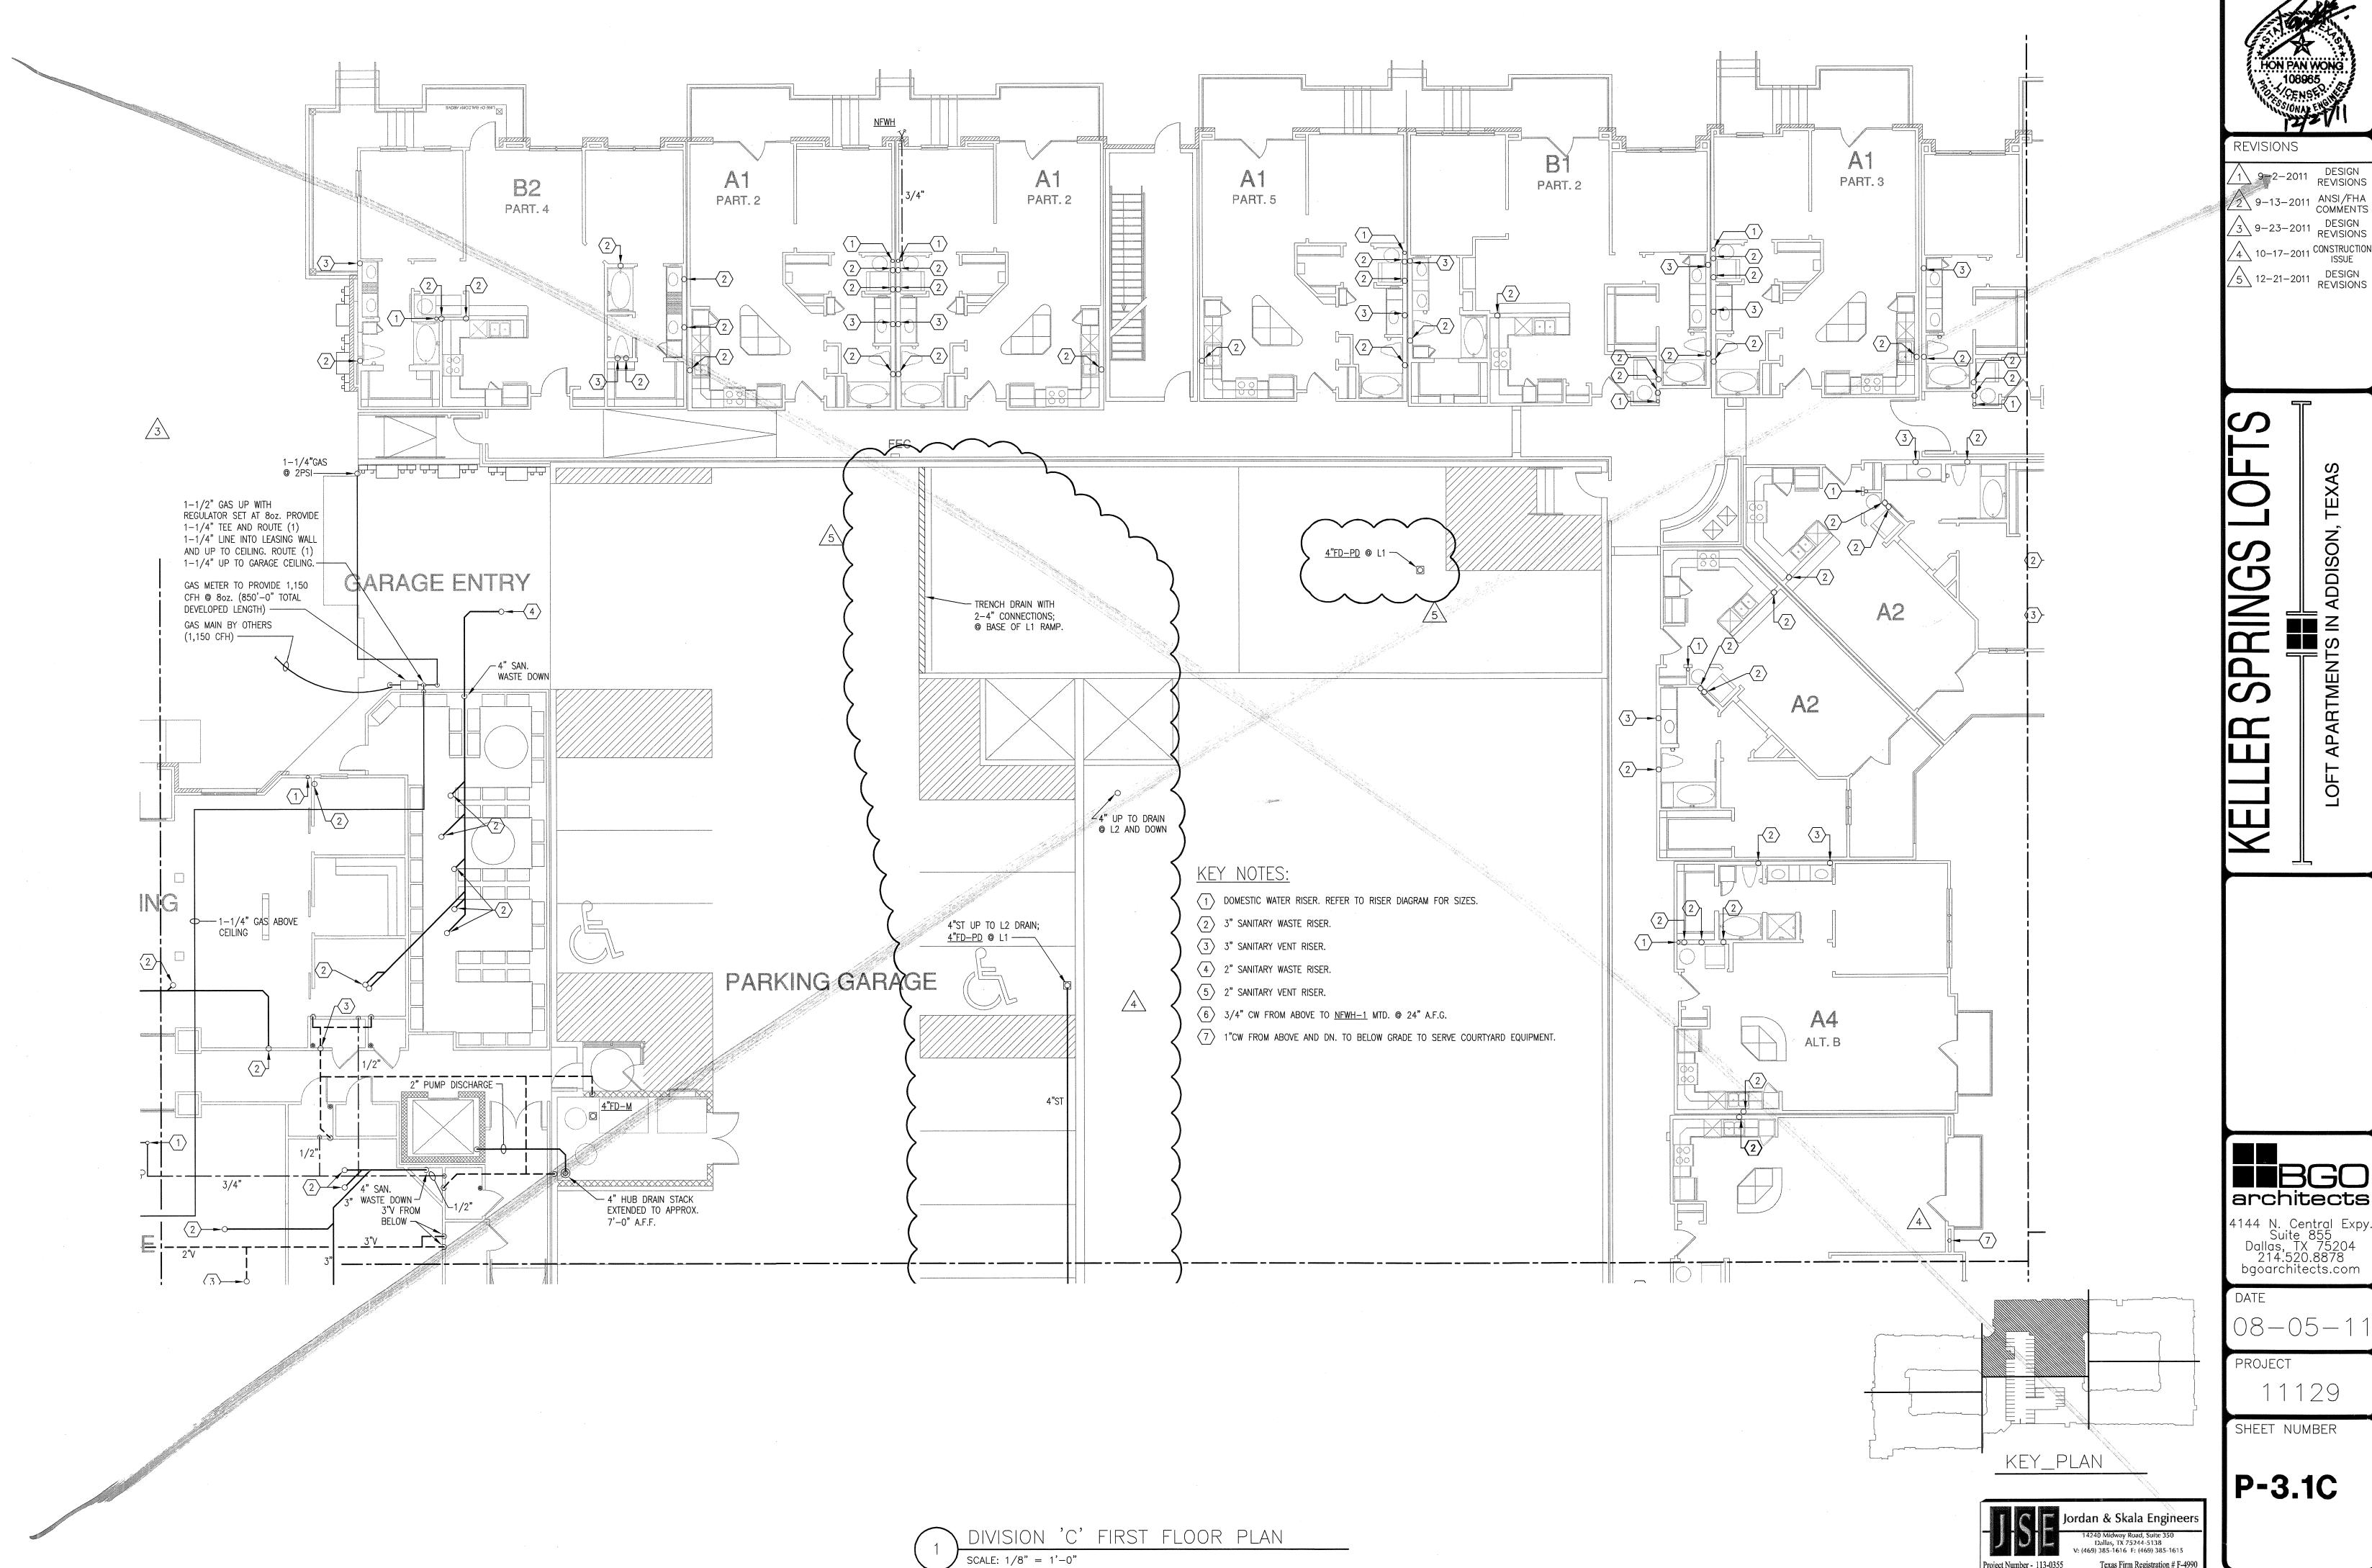




9-2-2011 DESIGN REVISIONS 2 9-13-2011 ANSI/FHA COMMENTS 3 9-23-2011 DESIGN REVISIONS 4 10-17-2011 CONSTRUCTION ISSUE

BBGO architects

4144 N. Central Expy. Suite 855 Dallas, TX 75204 214.520.8878 bgoarchitects.com

11129

Texas Firm Registration # F-495 Project Number - 113-0355 Drawn By: CV Checked By: RC

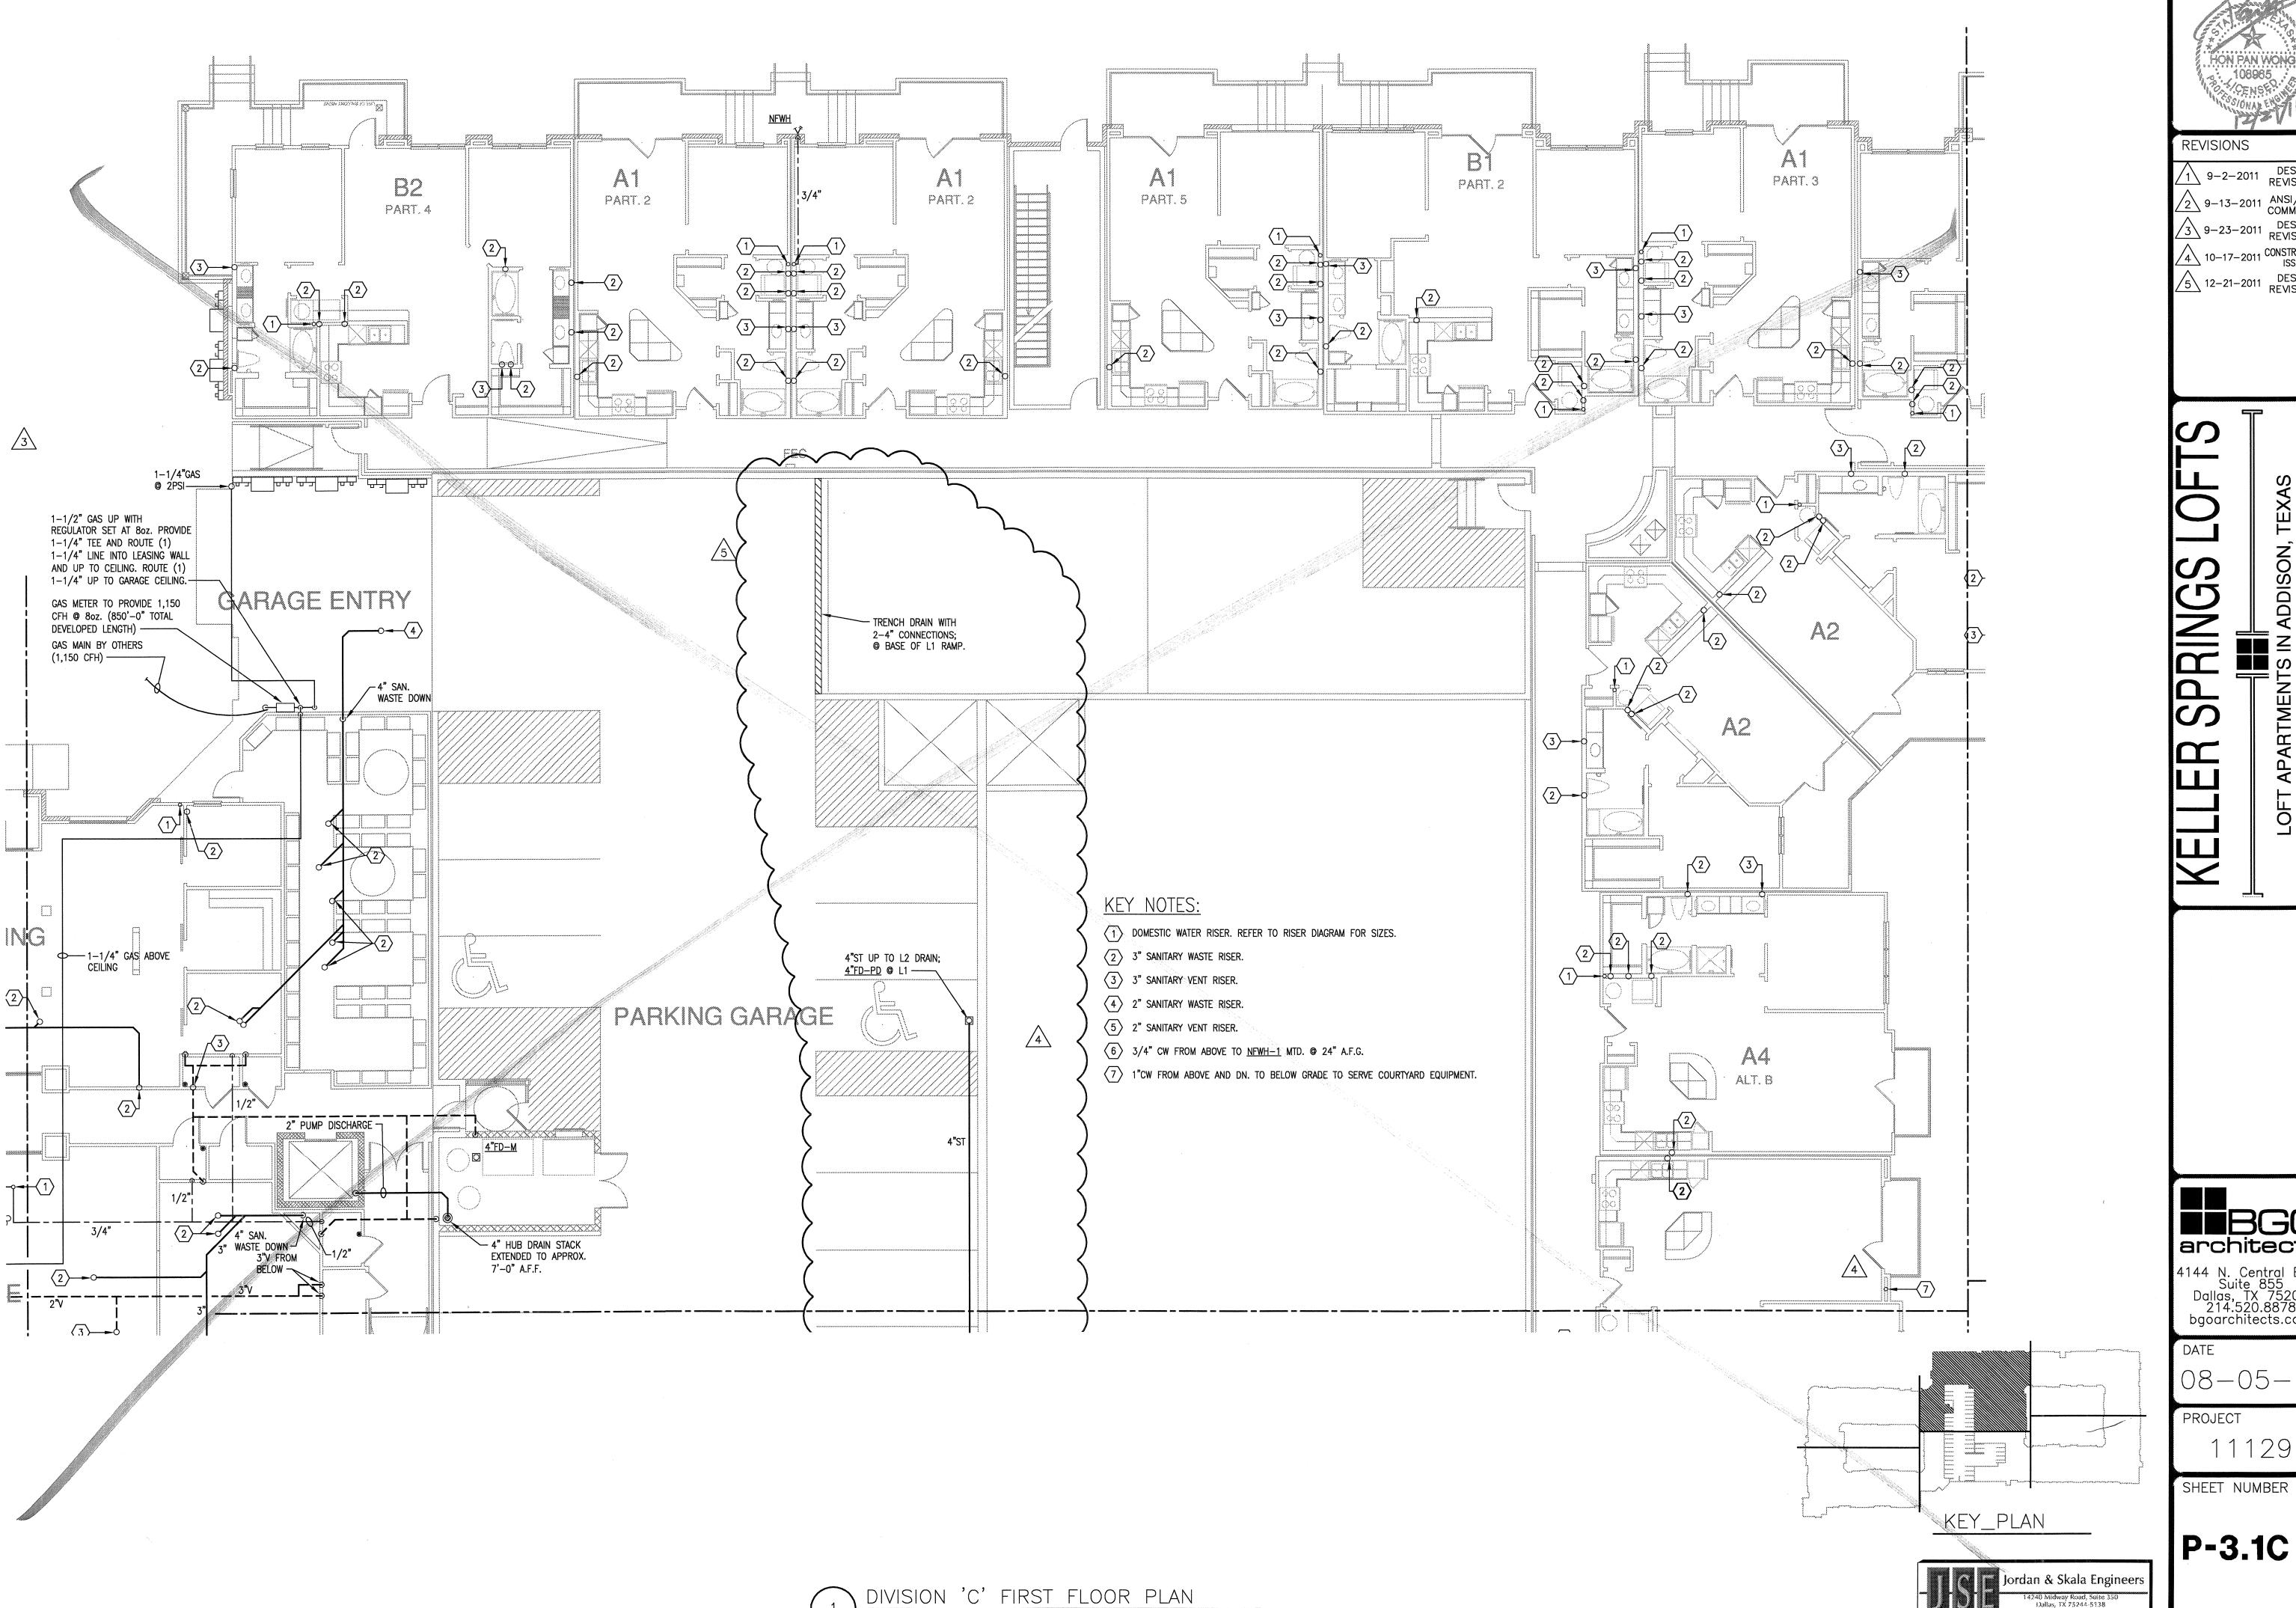

SCALE: 1/8" = 1'-0"

\_108985\_

REVISIONS

1 9-2-2011 DESIGN REVISIONS 2 9-13-2011 ANSI/FHA COMMENTS 3 9-23-2011 DESIGN REVISIONS 4 10-17-2011 CONSTRUCTION ISSUE 5 12-21-2011 DESIGN REVISIONS

BGO architects 4144 N. Central Expy. Suite 855 Dallas, TX 75204 214.520.8878 bgoarchitects.com

DATE


08-05-11


PROJECT

11129

P-3.1C

Texas Firm Registration # F-4990 Drawn By: CV Checked By: RC

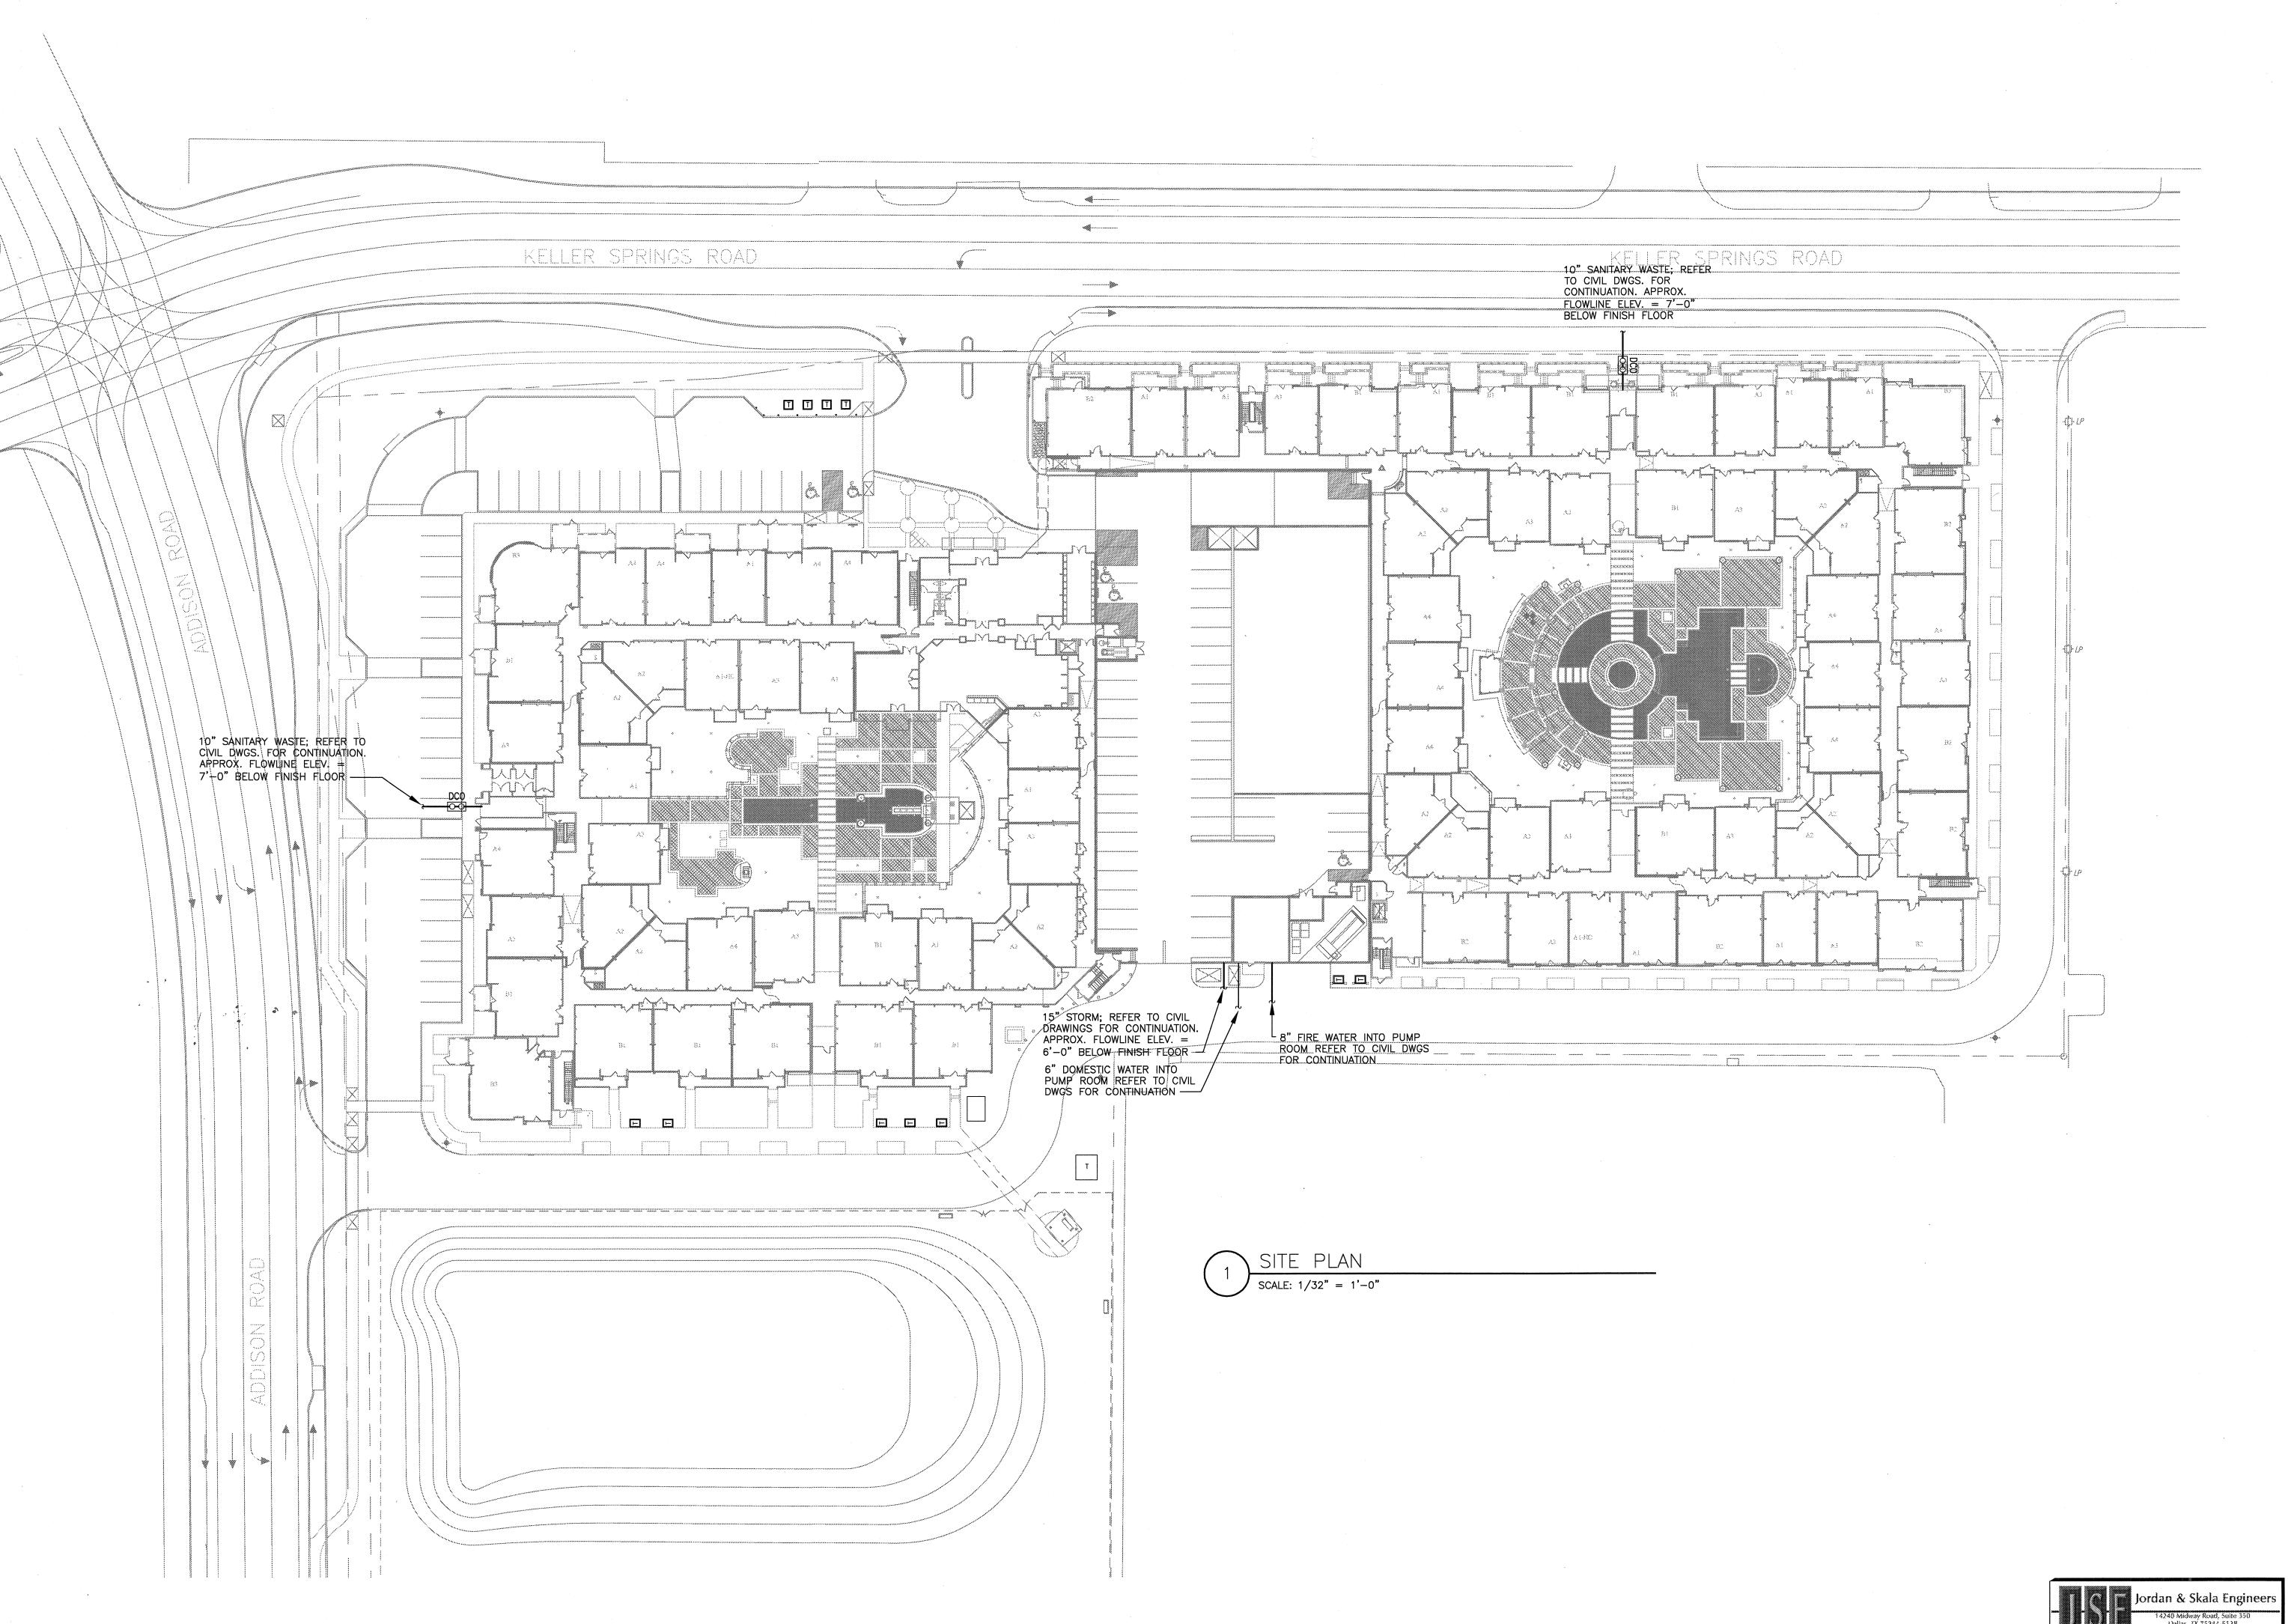

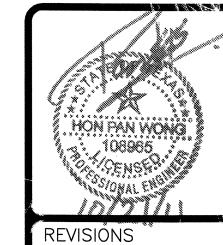

9-2-2011 DESIGN REVISIONS 9-13-2011 ANSI/FHA COMMENTS 3 9-23-2011 DESIGN REVISIONS

4 10-17-2011 CONSTRUCTION ISSUE

**BBGO** architects

4144 N. Central Expy. Suite 855 Dallas, TX 75204 214.520.8878 bgoarchitects.com

DATE

08 - 05 - 1

PROJECT

SHEET NUMBER

P-10.1

