

## GENERAL NOTES:

- REFER TO SPECIFICATION SECTIONS 2110, 2200, AND DRAWINGS C-2, C-3, C-4, C-5, AND C-6.
- THE INFORMATION SHOWN HEREIN WAS TAKEN FROM A SURVEY INCLUDED HEREIN BY: SPOONER & ASSOC. SURVEYORS, INC., DATED SEPT. 03, 1998, HURST, TEXAS. VERIFY SETBACKS WITH CODE OFFICIAL PRIOR

12/3/99 ADA 12/28/99 DOOR

JOB NO.

RESTAURANT

**FAZOLI'S** 

P.S.C.

œ,

क

DATE: 09/30/99

DRAWN BY: TRG

CHECKED BY: TRG

SHEET NO.

99154

ROAD

BELTINE

MARSH LA ADDISON,

01/17/00 AS-BUILT CLOUDED SECTION ONLY

- TO CONSTRUCTION. THE LOCATIONS OF ALL UTILITIES SHOWN ON THESE PLANS ARE BASED ON THE AVAILABLE INFORMATION. THE CONTRACTOR SHALL VERIFY THE EXACT LOCATION OF UTILITIES WITH THE UTILITY OWNERS PRIOR TO COMMENCEMENT OF CONSTRUCTION.
- ALL HANDICAP SITE FEATURES SHALL BE CONSTRUCTED TO MEET ALL STATE, LOCAL AND A.D.A. REQUIREMENTS.
- ANY DISCREPANCY IN THIS PLAN AND ACTUAL FIELD CONDITIONS SHALL BE REPORTED TO THE OWNER PRIOR TO START OF CONSTRUCTION. GENERAL CONTRACTOR SHALL BE RESPONSIBLE FOR VERIFICATION OF ALL SETBACKS, EASTBUCTION.
- PRIOR TO STARTING CONSTRUCTION, THE GENERAL CONTRACTOR SHALL BE RESPONSIBLE TO VERIFY THAT ALL REQUIRED PERMITS AND APPROVALS HAVE BEEN OBTAINED. NO CONSTRUCTION OR FABRICATION OF ANY ITEM SHALL BEGIN UNTIL THE CONTRACTOR HAS RECEIVED ALL PLANS AND ANY OTHER DOCUMENTATION FROM ALL OF THE PERMITTING AND ANY OTHER REGULATORY AUTHORITIES. FAILURE OF THE CONTRACTOR TO FOLLOW THIS PROCEDURE SHALL CAUSE THE CONTRACTOR TO ASSUME FULL RESPONSIBILITY FOR ANY SUBSEQUENT MODIFICATION OF THE WORK MANDATED BY ANY REGULATORY AUTHORITY.
- THE GENERAL CONTRACTOR SHALL CONTACT ALL OWNERS OF EASEMENTS, UTILITIES AND R.O.W.'S, PUBLIC OR PRIVATE, PRIOR TO WORKING IN THESE AREAS.
- CONTRACTOR SHALL MAINTAIN THE SITE IN A MANNER SO THAT WORKMEN AND PUBLIC SHALL BE PROTECTED FROM INJURY, AND ADJOINING PROPERTY PROTECTED FROM DAMAGE.
- ACCESS TO UTILITIES, FIRE HYDRANTS, STREET LIGHTING, ETC., SHALL REMAIN UNDISTURBED, UNLESS COORDINATED WITH RESPECTIVE UTILITY.
- CONTRACTOR IS RESPONSIBLE FOR DAMAGE TO ANY EXISTING ITEM AND/OR MATERIAL INSIDE OR OUTSIDE CONTRACT LIMITS DUE TO CONSTRUCTION OPERATIONS.
- 11. ALL DIMENSIONS ARE TO THE FACE OF CURB, UNLESS OTHERWISE NOTED.
- 12. DO NOT SCALE THIS DRAWING AS IT IS A REPRODUCTION AND SUBJECT TO
- 13. THE GENERAL CONTRACTOR SHALL REMOVE ALL TRASH AND DEBRIS FROM THE SITE UPON COMPLETION OF THE PROJECT.
- 14. THE G.C. SHALL KEEP THE AREA OUTSIDE THE "CONSTRUCTION LIMITS" BROOM CLEAN AT ALL TIMES.
- 15. ALL SITEWORK AND PAVING MUST BE IN ACCORDANCE WITH, OR SURPASS RECOMENDATIONS OF SOILS REPORT. IF SOILS REPORT CONFLICTS WITH DRAWINGS AND SPECIFICATIONS, THE MORE PROHIBITIVE OF THE TWO SHALL TAKE PRECEDENCE AND BE CONSIDERED TO BE THE INTENT OF THE BID DOCUMENTS.
- 16. TRAFFIC LANE MARKINGS: APPLY TWO (2) COATS OF CHLORINATED RUBBER-TYPE TRAFFIC LANE MARKING PAINT OVER CLEANED PAVING SURFACE ACCORDING TO LAYOUT SHOWN ON THE SITE PLAN. PAINT YELLOW OR AS REQUIRED BY CITY CODE OR SHOPPING CENTER DEVELOPER.

- 1. NEW FREESTANDING SIGN, SUPPLIED BY 14. PARKING LOT LIGHT FIXTURE. OWNER, INSTALLED BY SIGN CONTRACTOR. G.C. TO PROVIDE CONDUIT/WIRE TO PANEL AS REQUIRED. (G.C. AND SIGN CONTRACTOR 15 TO VERIFY ANY SIGN SETBACKS, AND CONFIRM CORRECT PLACEMENT \(\formall'\) CODE
- 2. "DO NOT ENTER/THANK YOU" SIGN SUPPLIED BY OWNER INSTALLED BY SIGN CONTRACTOR. (G.C. & SIGN CONTRACTOR TO VERIFY ANY SIGN
- 4. CONCRETE CURB, SEE 4/C-5 OR PROVIDE TO MATCH LOCAL STDS. IF APPROVED BY THE ENGINEER.
- CONCRETE WALK WITH TURNDOWN SEE 3/C-5. TURNDOWN MAY BE DELETED WHERE WALK DOES NOT ABUTT PAVEMENT.
- 6. ACCESS POINT IN CONCRETE SEE SHT. C-2.
- G.C. TO INSTALL SIGN SO AS NOT TO FALL WITHIN CAR OVERHANG 9. PAINTED SIGNS, STRIPES, ARROWS. SEE 5/C-5.
- 10. REFUSE ENCLOSURE/STOR. SHED -
- SEE DETAILS SHEET C-6. 11. GAS METER, SEE C-3.
- 12. ELECTRIC METER, SEE C-3. 13. 1000 GAL. GREASE INTERCEPTOR.

- OFFICIAL.) SEE SHT. C-3.
- 5. MENU BOARD, SUPPLIED AND INSTALLED BY GEN. CONTRACTOR SEE SHEET E-4, & 9/C-6.

SEE SHEET C-3, 11/C-6.

16. PRECAST CONCRETE WHEEL STOP ANCHORED TO PAVEMENT W/ 2 #4 x 2-0" LONG REBAR PINS. PLACE WHEEL STOPS 2.5' OFF WALK.

- 21. HANDRAIL @ EXIT DOOR, SEE A-1.
- 22. 2' CHAMFER ON EXPOSED
- CONCRETE CORNER (TYP.).
- 23. PAD MOUNTED TRANSFORMER BY UTILITY/G.C., SEE SHT. C-3.
- 24. PREVIEW ORDER BOARD PART OF ITEM (NOTE) 15.

## SITE STATISTICS:

SITE ADDRESS: LOT SIZE:

3,257 S.F. GROSS BUILDING AREA: 136 SEATS

SEATING: PARKING REQUIRED:

PARKING PROVIDED:


48 (INCL. 2 HC)

 $3,257 \div 75 = 44$ 

41,126.75 S.F./.95 AC.


MARSH LANE

DIMENSIONED SITE PLAN

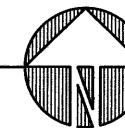

DIMENTIONED SITE PLAN

PLACE SO AS NOT TO INTERUPT SETBACKS AND CONFIRM CORRECT PLACEMENT CODE OFFICIAL.) HC ACCESS PATH. 3. H. D. CONCRETE PAVEMENT. SEE C-1A AND C-5. 17. ENTER SIGN. SUPPLIED BY OWNER INSTALLED BY SIGN CONTRACTOR. (G.C. & SIGN CONTRACTOR TO VERIFY ANY SIGN SETBACKS AND CONFIRM CORRECT PLACEMENT ♥ CODE OFFICIAL.) 18. CONCRETE PAVEMENT, SEE C-1A AND SHEET C-5. 19. LANDSCAPE AREA. SEE SHEET C-4. 20. G.C. TO INSTALL OWNER PROVIDED LOOP DETECTOR, SEE C-3. 7. PIPE BOLLARD, SEE 1/C-5. 8. HANDICAP PARKING SIGN, SEE 6/C-5.

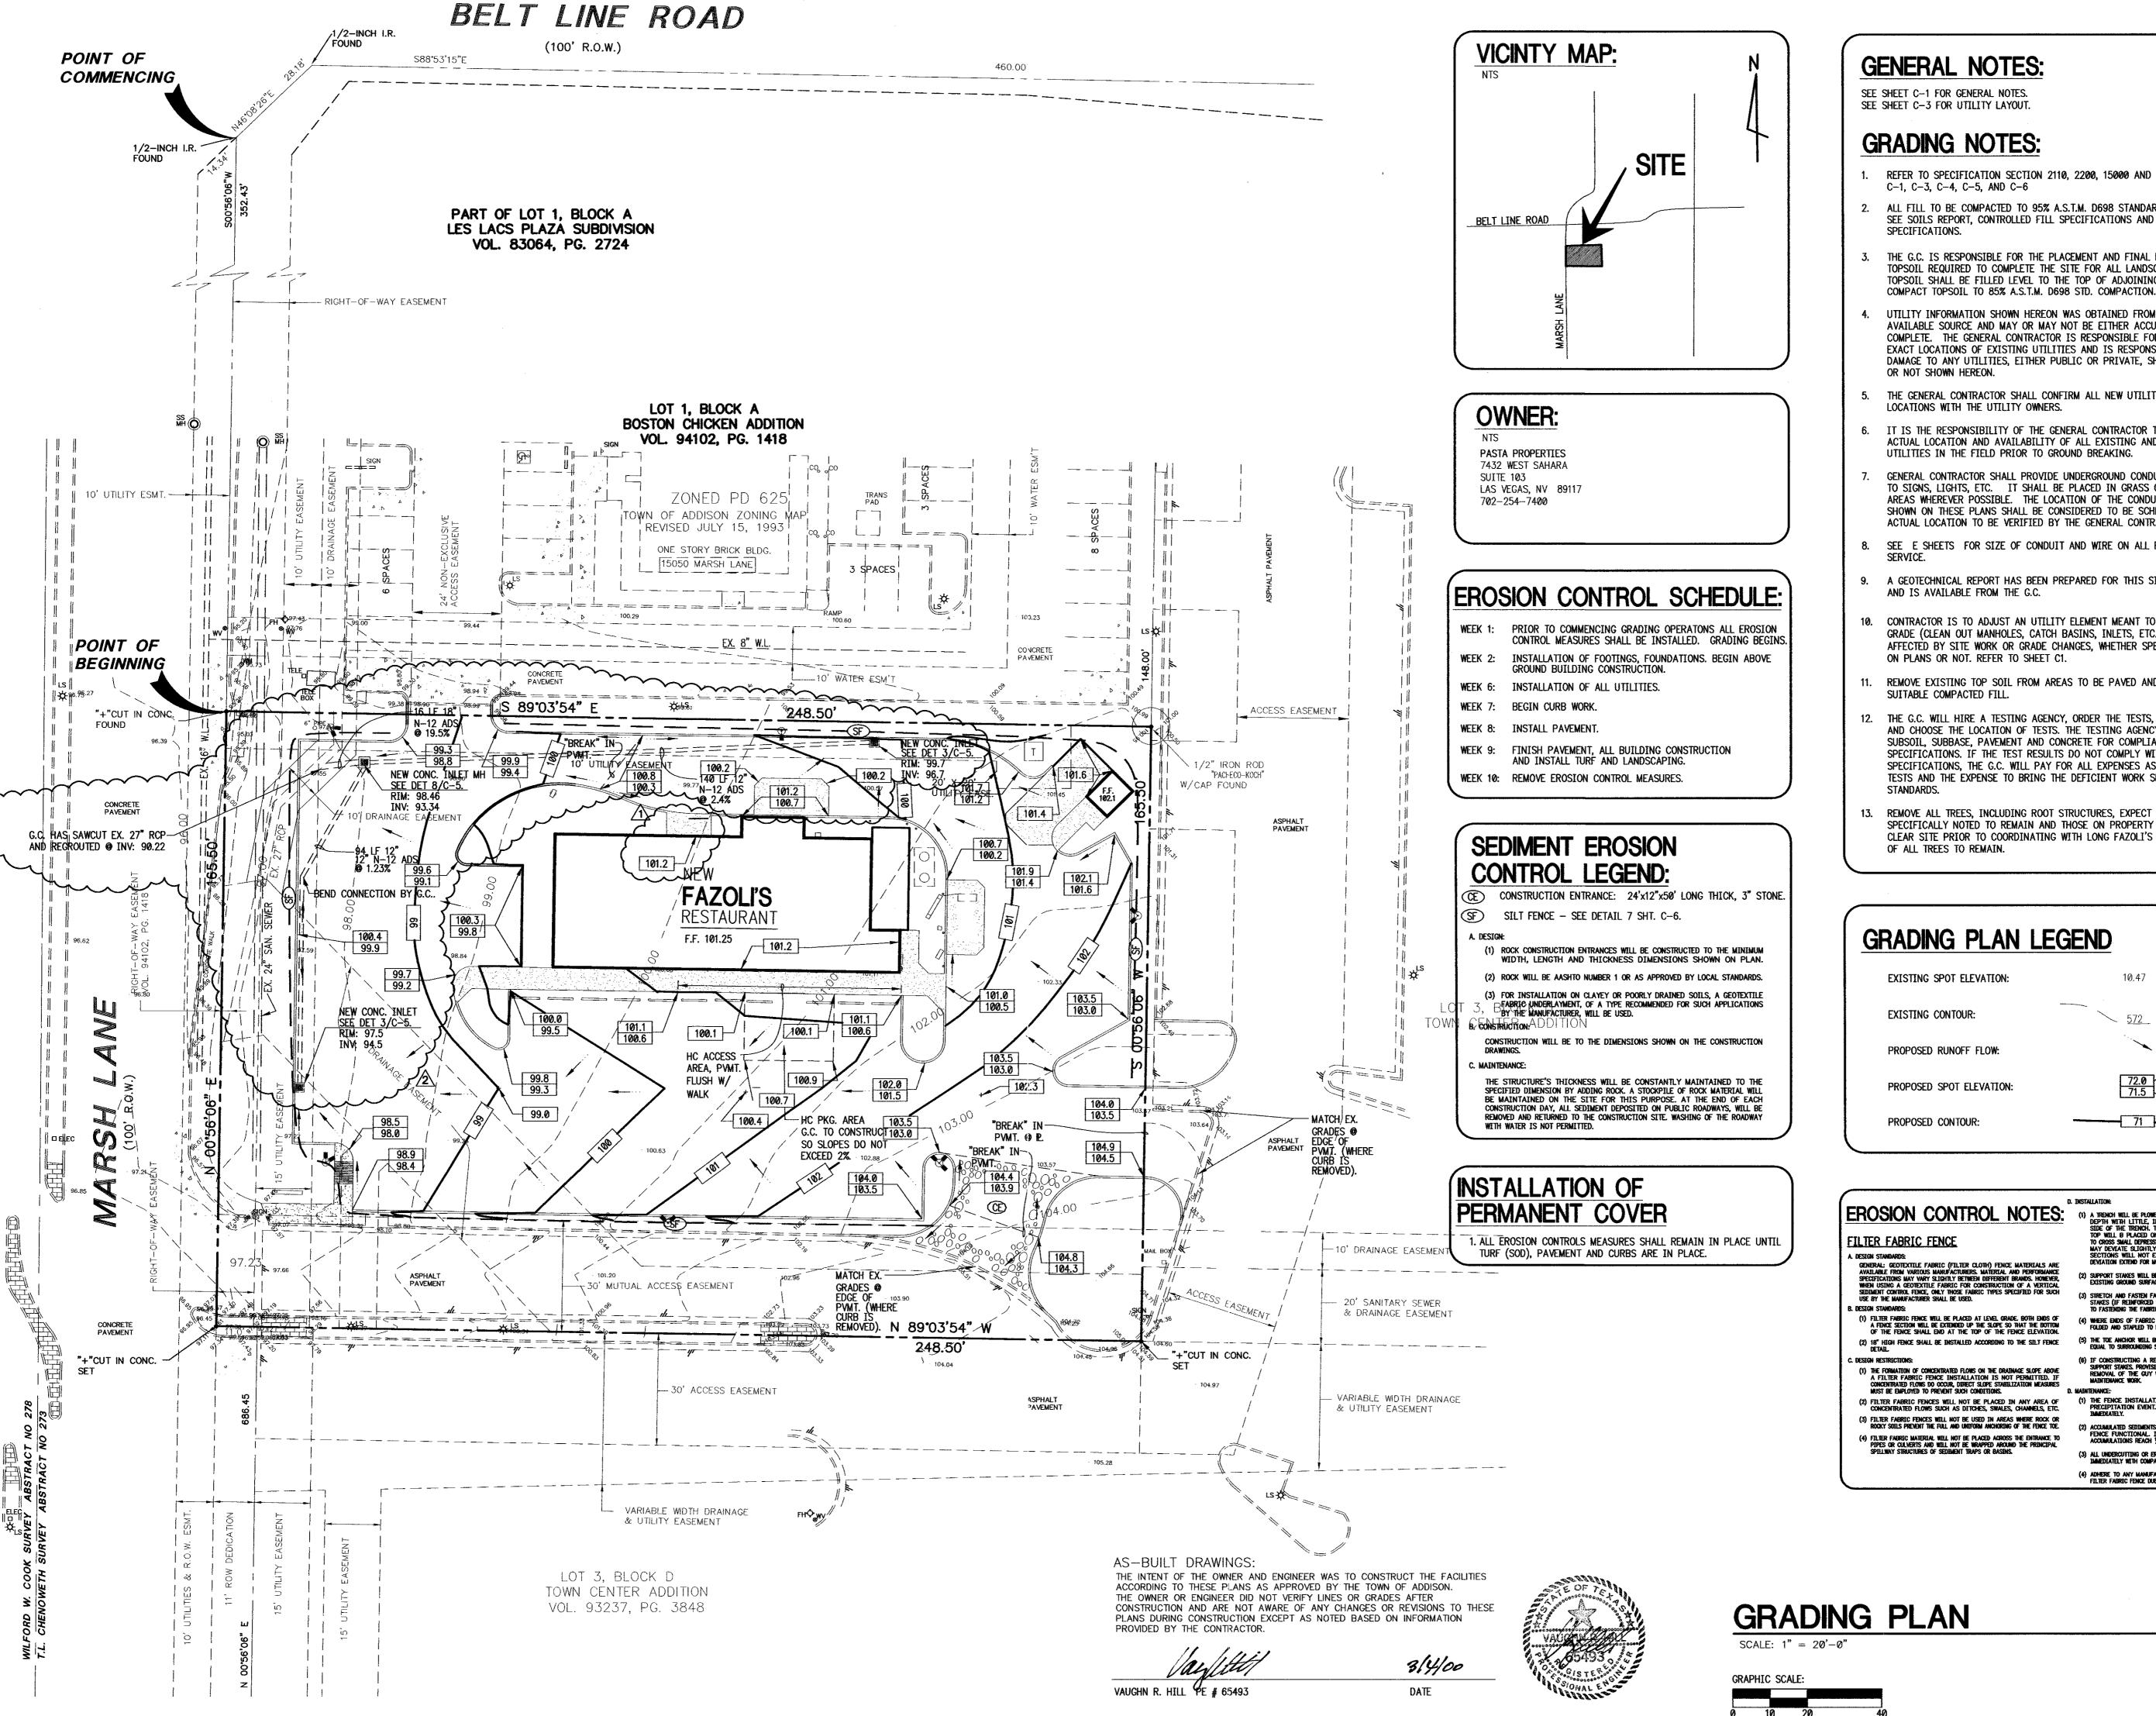

## **GENERAL NOTES:**

SEE SHEET C-1 FOR GENERAL NOTES. SEE SHEET C-3 FOR UTILITY LAYOUT.

## **GRADING NOTES:**

- REFER TO SPECIFICATION SECTION 2110, 2200, 15000 AND DRAWINGS
- 2. ALL FILL TO BE COMPACTED TO 95% A.S.T.M. D698 STANDARD COMPACTION. SEE SOILS REPORT, CONTROLLED FILL SPECIFICATIONS AND SUBSURFACE SPECIFICATIONS.
- THE G.C. IS RESPONSIBLE FOR THE PLACEMENT AND FINAL RAKING OF ALL TOPSOIL REQUIRED TO COMPLETE THE SITE FOR ALL LANDSCAPING. TOPSOIL SHALL BE FILLED LEVEL TO THE TOP OF ADJOINING CURBS.
- UTILITY INFORMATION SHOWN HEREON WAS OBTAINED FROM THE BEST AVAILABLE SOURCE AND MAY OR MAY NOT BE EITHER ACCURATE OR COMPLETE. THE GENERAL CONTRACTOR IS RESPONSIBLE FOR VERIFYING EXACT LOCATIONS OF EXISTING UTILITIES AND IS RESPONSIBLE FOR ANY DAMAGE TO ANY UTILITIES, EITHER PUBLIC OR PRIVATE, SHOWN HEREON
- THE GENERAL CONTRACTOR SHALL CONFIRM ALL NEW UTILITY TAP LOCATIONS WITH THE UTILITY OWNERS.
- IT IS THE RESPONSIBILITY OF THE GENERAL CONTRACTOR TO VERIFY THE ACTUAL LOCATION AND AVAILABILITY OF ALL EXISTING AND PROPOSED UTILITIES IN THE FIELD PRIOR TO GROUND BREAKING.
- GENERAL CONTRACTOR SHALL PROVIDE UNDERGROUND CONDUIT & WIRE TO SIGNS, LIGHTS, ETC. IT SHALL BE PLACED IN GRASS OR LANDSCAPE AREAS WHEREVER POSSIBLE. THE LOCATION OF THE CONDUIT AS SHOWN ON THESE PLANS SHALL BE CONSIDERED TO BE SCHEMATIC WITH ACTUAL LOCATION TO BE VERIFIED BY THE GENERAL CONTRACTOR.
- 8. SEE E SHEETS FOR SIZE OF CONDUIT AND WIRE ON ALL ELECTRICAL
- 9. A GEOTECHNICAL REPORT HAS BEEN PREPARED FOR THIS SITE BY TERRA-MAR AND IS AVAILABLE FROM THE G.C.
- 10. CONTRACTOR IS TO ADJUST AN UTILITY ELEMENT MEANT TO BE FLUSH WITH GRADE (CLEAN OUT MANHOLES, CATCH BASINS, INLETS, ETC.) THAT IS AFFECTED BY SITE WORK OR GRADE CHANGES, WHETHER SPECIFICALLY NOTED ON PLANS OR NOT. REFER TO SHEET C1.
- REMOVE EXISTING TOP SOIL FROM AREAS TO BE PAVED AND REPLACE WITH SUITABLE COMPACTED FILL
- THE G.C. WILL HIRE A TESTING AGENCY, ORDER THE TESTS, PAY FOR THE TEST AND CHOOSE THE LOCATION OF TESTS. THE TESTING AGENCY WILL TEST SUBSOIL, SUBBASE, PAVEMENT AND CONCRETE FOR COMPLIANCE WITH THE SPECIFICATIONS. IF THE TEST RESULTS DO NOT COMPLY WITH THE SPECIFICATIONS, THE G.C. WILL PAY FOR ALL EXPENSES ASSOCIATED WITH THE TESTS AND THE EXPENSE TO BRING THE DEFICIENT WORK SPECIFICATION
- 13. REMOVE ALL TREES, INCLUDING ROOT STRUCTURES, EXPECT THOSE SPECIFICALLY NOTED TO REMAIN AND THOSE ON PROPERTY LINES. DO NOT CLEAR SITE PRIOR TO COORDINATING WITH LONG FAZOLI'S THE LOCATION OF ALL TREES TO REMAIN.

## **GRADING PLAN LEGEND**

EXISTING SPOT ELEVATION:

**EXISTING CONTOUR:** 

PROPOSED RUNOFF FLOW:

PROPOSED SPOT ELEVATION:

72.0 TOP OF CURB PAVEMENT

10.47

572

EROSION CONTROL NOTES: FILTER FABRIC FENCE

GENERAL: GEOTEXTILE FABRIC (FILTER CLOTH) FENCE MATERIALS ARE AVAILABLE FROM VARIOUS MANUFACTURERS. MATERIAL AND PERFORMANCE SPECIFICATIONS MAY VARY SLIGHTLY BETWEEN DIFFERENT BRANDS. HOWEVER, WHEN USING A GEOTEXTILE FABRIC FOR CONSTRUCTION OF A VERTICAL SEDIMENT CONTROL FENCE, ONLY THOSE FABRIC TYPES SPECIFIED FOR SUCH USE BY THE MANUFACTURER SHALL BE USED.

- (1) FILTER FABRIC FENCE WILL BE PLACED AT LEVEL GRADE. BOTH ENDS OF A FENCE SECTION WILL BE EXTENDED UP THE SLOPE SO THAT THE BOTTOM OF THE FENCE SHALL END AT THE TOP OF THE FENCE ELEVATION. (2) 18" HIGH FENCE SHALL BE INSTALLED ACCORDING TO THE SILT FENCE
- : Design restrictions: (1) THE FORMATION OF CONCENTRATED FLOWS ON THE DRAINAGE SLOPE ABOVE A FILTER FABRIC FENCE INSTALLATION IS NOT PERMITTED. IF CONCENTRATED FLOWS DO OCCUR, DIRECT SLOPE STABILIZATION MEASURES MUST BE EMPLOYED TO PREVENT SUCH CONDITIONS.
- (2) FILTER FABRIC FENCES WILL NOT BE PLACED IN ANY AREA OF CONCENTRATED FLOWS SUCH AS DITCHES, SWALES, CHANNELS, ETC. (3) FILTER FABRIC FENCES WILL NOT BE USED IN AREAS WHERE ROCK OR ROCKY SOILS PREVENT THE FULL AND UNIFORM ANCHORING OF THE FENCE TOE. (4) FILTER FABRIC MATERIAL WILL NOT BE PLACED ACROSS THE ENTRANCE TO PIPES OR CULVERTS AND WILL NOT BE WRAPPED AROUND THE PRINCIPAL SPILLWAY STRUCTURES OF SEDIMENT TRAPS OR BASINS.
- (1) A TRENCH WILL BE PLOWED OR OTHERWISE EXCAVATED FOT HE REQUIRED DEPTH WITH LITTLE, IF ANY, DISTURBANCE TO THE DOWNSLOPE SIDE OF THE TRENCH. THE BOTTOM OF THE TRENCH AND THE FENCE TOP WILL B PLACED ON A LEVEL GRADE. WHEN IT IS NECESSARY TO CROSS SMALL DEPRESSIONS, THE TRENCH BOTTOM AND FENCE TOP EDGE MAY DEVIATE SLICHTLY FROM THE LEVEL GRADE. GRADES IN SUCH SECTIONS WILL NOT EXCEED ONE PERCENT (1%), NOR WILL THE DEVIATION EXTEND FOR MORE THAN 25 FEET.
- ) SERETCH AND FASTEN FABRIC TO THE UPSLOPE SIDE OF THE SUPPORT STAKES (IF REINFORCED SECTION, FASTEN REINFORCEMENT MESH PRIOR TO FASTENING THE FABRIC).
- (5) THE TOE ANCHOR WILL BE BACKFILLED AND COMPACTED TO A DENSITY EQUAL TO SURROUNDING SOILS.
- (6) IF CONSTRUCTING A REINFORCED SECTION, ATTACH GUY WIRES TO SUPPORT STAKES, PROVISIONS SHOULD BE MADE FOR EASY LOOSINING AND REMOVAL OF THE GUY WIRES TO ALLOW FOR ACCESS TO PERFORM MAINTENANCE WORK.

- (4) ADHERE TO ANY MANUFACTURER'S RECOMMENDATIONS FOR REPLACING FILTER FABRIC FENCE DUE TO WEATHERING.



DATE: 09/30/99

DRAWN BY: TRG

CHECKED BY: TRG

**GRADING &** 

DRAINAGE

12/28/99 DOOR

99154

ROAD

BELTINE


MARSH LANE ADDISON, TX

TAURANT

RES

AZOLI'S

01/17/00 AS-BUILT CLOUDED SECTION ONLY

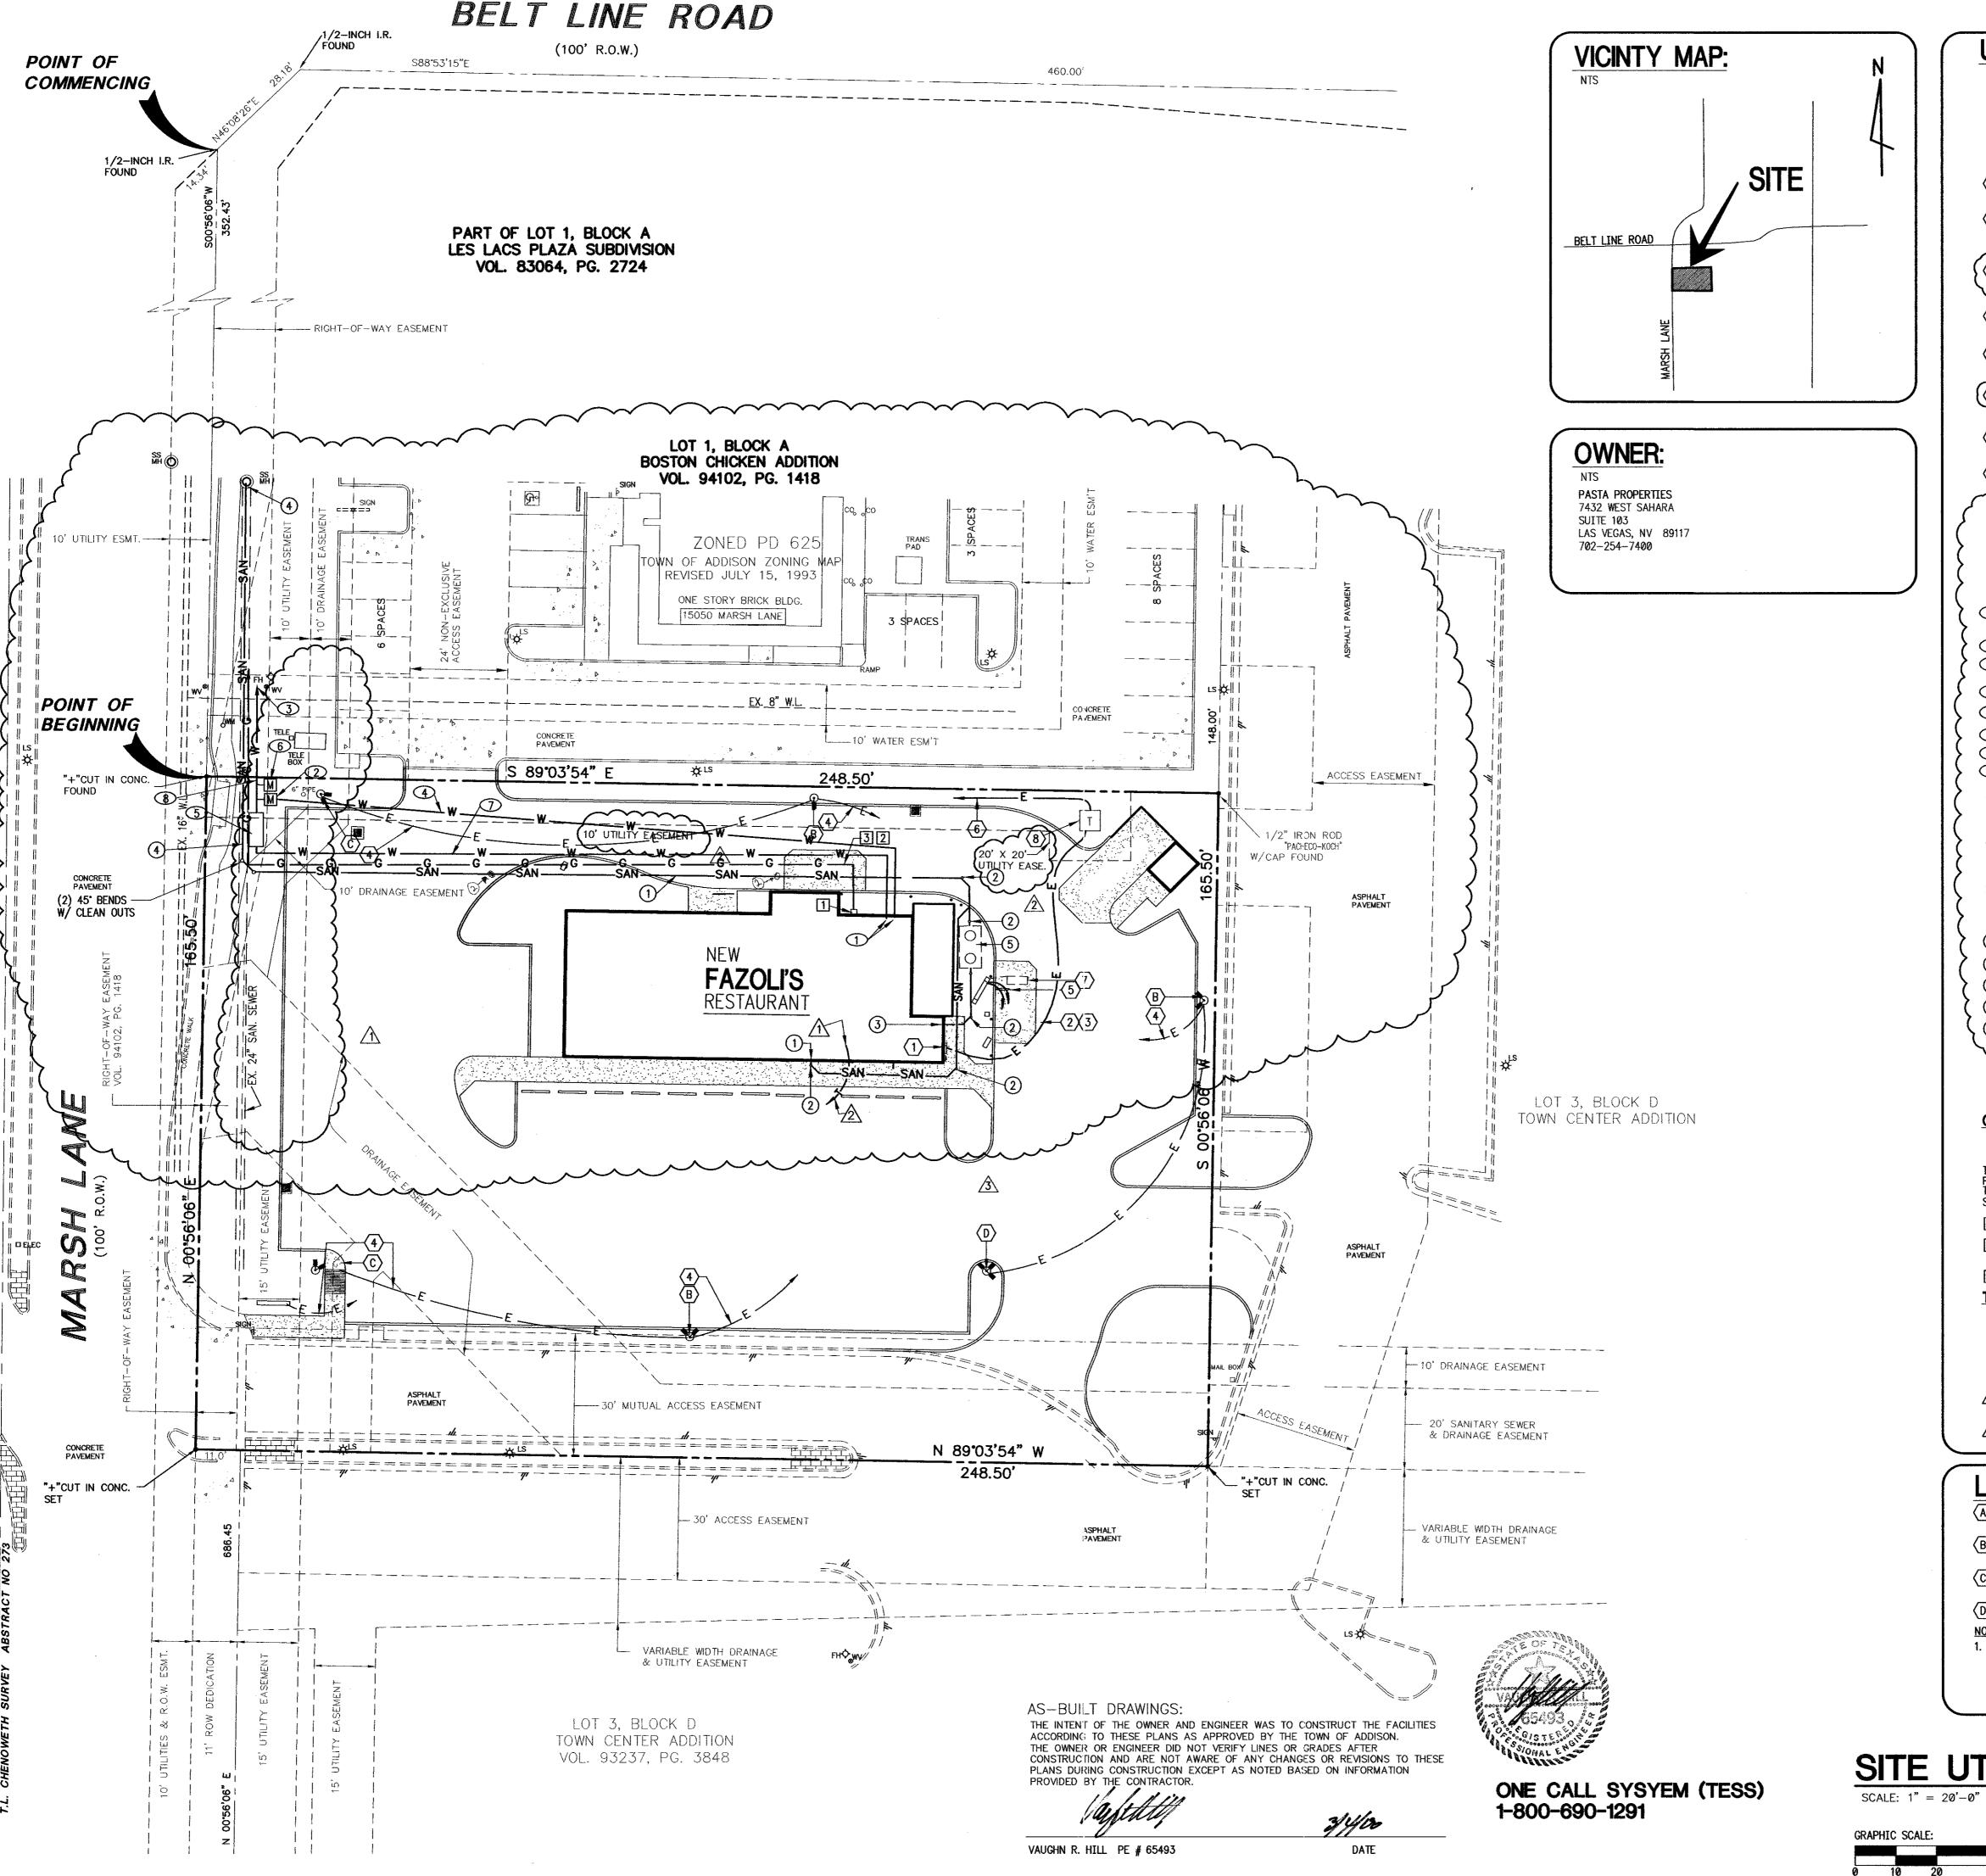

**UTILITY NOTES:** 

ELECTRIC SERVICE:

TXU ELECTRIC AND GAS

(972) 323-8913 THE G.C. SHALL BE RESPONSIBLE FOR ALL COSTS RELATED TO PROVIDING ELECTRIC SERVICE FOR THE NEW FAZOLI'S FACILITY. THE G.C. SHALL CONFIRM ALL COSTS PRIOR TO BIDDING.

- 1 NEW ELECTRIC CONNECTION POINT FOR UNDERGROUND
- ELECTRIC SERVICE AT THIS LOCATION. (SEE SHT. E-1.) (2) NEW SECONDARY ELECTRIC CABLE AS REQUIRED BY G.C. G.C. TO
- CONFIRM W/ UTILITY CO. PRIOR TO BIDDING. G.C. IS RESPONSIBLE FOR ALL COSIS ASSOCIATED WITH NEW ELECTRIC SERVICE. (CONDUIT, CABLE, ETC.) 3 NEW ELEC. CONNECTION LOCATION VERIFY WITH UTILITY COMPANY.
- ALL BENDS ARE TO BE LONG SWEEP 36" RADIUS GALV. IRON. (4) NEW CONDUIT AND WIRE BY G.C. TO NEW SIGNS, REMOTE STORAGE ROOM AND LIGHTS, SEE E-SHEETS IN THIS SET.

G.C. TO PROVIDE (2) 4" SCH 40 CONDUITS W/ PULL STRING, 39" DEEP MIN.

- (5) G.C. TO PROVIDE WIRING & CONDUIT FOR MENU BOARD, COMMUNICATION AND TIMING SYSTEMS AS REQUIRED. SEE FLECTRICAL SHEET E-4 IN THIS SET.
- (6) NEW ELECTRIC SERVICE (PRIMARY). G.C. TO INSTALL & VERIFY NEW POURED IN
- PLACE PAD LOCATION W UTILITY. (7) G.C. TO INSTALL OWNER PROVIDED LOOP DETECTOR IN CONC. SLAB PER
- MANUF. REQUIREMENTS. G.C. TO COORDINATE W/OWNER FOR TIMELY DEL.

(8) G.C. TO PROVIDE TRANSFORMER PAD, CONDUITS, ETC. AS REQUIRED BY

TOWN OF ADDISON, PUBLIC WORKS (972) 450-2871 MIKE MURPHY

THE G.C. SHALL BE RESPONSIBLE FOR ALL COSTS RELATED TO PROVIDING WATER SERVICE FOR THE NEW FAZOLI'S FACILITY. THE G.C. SHALL CONFIRM ALL COSTS PRIOR TO BIDDING. THE NEW METER SHOULD BE SIZED BASED ON THE NEW 1/2" WATER SERVICE.

- 11/2" WATER BLDG. CONNECTION POINT, SEE NOTE 2. EXISTING WATER METER, FIELD VERIFY IF REQUIRED.
- 2 1" DOMESTIC METER VAULT.
- 3 NEW WATER CONNECTION BY UTILITY OR G.C., G.C. TO CONFIRM.
- 4 11/2" TYPE "K" DOMESTIC WATERLINE BY G.C.
- 5 COUBLE CHECK VALVE VAULT PER CITY SPEC'S.
- 6 1" IRRIGATION METER VAULT.
- 4" C900 PVC FIRE WATER LINE.
- 8 6" C900 PVC FIRE WATER LINE.

SANITARY SEWER:

TOWN OF ADDISON, PUBLIC WORKS (972) 450-2871 MIKE MURPHY

THE G.C. SHALL BE RESPONSIBLE FOR ALL COSTS RELATED TO PROVIDING SANITARY SEWER SERVICE FOR THE NEW FAZOLI'S FACILITY. THE G.C. SHALL CONFIRM ALL COSTS PRIOR TO BIDDING.

- THE CONTRACTOR IS ADVISED A TRENCH SHIELD AND/OR SHORING DESIGNED IN ACCORDANCE WITH OSHA STANDARDS SHALL BE USED IN ALL OPEN TRENCH EXCAVATIONS.
- (1) 4" SCH 40 PVC NON-GREASE SAN. LINE
- (2) CLEAN OUT. G.C. TO PROVIDE PER THIS SHEET, P1, AND AS REQD. BY CODE.
- 3 4" SCH 40 PVC GREASE LADEN SAN. LINE TO GREASE INTERCEPTOR
- 4 6" SDR35 SAN. LINE TO EX. MH.
- (5) 1000 GALLON GREASE INTERCEPTOR BY G.C. PER LOCAL CODE STDS., ONLY

IF REQUIRED BY CODE.

GAS SERVICE:

TXU ELECTRIC AND GAS

(972) 323-8913 THE G.C. SHALL BE RESPONSIBLE FOR ALL COSTS RELATED TO PROVIDING GAS SERVICE FOR THE NEW FAZOLI'S FACILITY. THE G.C. SHALL COSTS PRIOR TO BIDDING.

- SEE DETAILS & SPEC'S SHT. C-7.
- 1 NEW GAS METER LOCATION BY G.C.. COORDINATE W UTILITY. 2 NEW GAS SERVICE LINE BY UTILITY CO.
- MUST HAVE MIN. 2" PIPE OUTSIDE OF BUILDING FOR CONNECTION. 3 G.C. TO VERIFY W UTILITY GAS LINE LOCATION.

TELEPHONE SERVICE:

SOUTHWESTERN BELL

(800) 499-7928 THE G.C. SHALL BE RESPONSIBLE FOR ALL COSTS RELATED TO PROVIDING TELEPHONE SERVICE FOR THE NEW FAZOLI'S FACILITY. THE G.C. SHALL CONFIRM ALL COSTS PRIOR TO BIDDING.

- 1\(\) TELEPHONE CONNECTION LOCATION SEE E1. COORDINATE W APPROPRIATE UTILITY COMPANY.
- NEW TELEPHONE LINE/ CONDUIT IN ELEC. TRENCH. CONFIRM REQUIREMENTS W/ UTILITY CO. PRIOR TO BIDDING.


## LIGHTING SCHEDULE:

- $\langle A \rangle$  = 1ASB RS MH1000 28, SINGLE HEAD, 1/1000W, 28' POLE
- $\langle B \rangle$  = 2ASB RS MH1000 28, DUAL HEAD, 90° BRACKET, 2/1000W, 28° POLE
- $\langle C \rangle$  = 2ASB RS MH1000 28, DUAL HEAD, 45' BRACKET, 2/1000W, 28' POLE

 $\langle D \rangle$  = 3ASB RS MH1000 28, TRIPLE HEAD, 3/1000W, 28' POLE

1. ALL LIGHT FIXTURES, POLES, BRACKETS, ANCHOR BOLTS, ETC., ARE PROVIDED BY THE E.C. NO SUBSTITUTIONS ARE ALLOWED, LIGHTING MATERIALS CAN BE OBTAINED FROM ACCUSERVE, MR. RAY ZIMMERER, 502-961-0096. G.C. SHALL INSTALL ALL LIGHTING EQUIPMENT & PROVIDE CONCRETE BASES PER 6/C-6.

SITE UTILITY PLAN

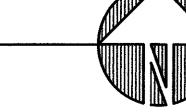

11/15/99

12/22/99

01/17/00 AS-BUILT CLOUDED SECTION ONLY

99154

ROAD BEL TINE **AURANT** 

MARSH LANE ADDISON, TX


ts.


DATE: 09/30/99


DRAWN BY: TRG

CHECKED BY: TRG


SITE UTILITY PLAN

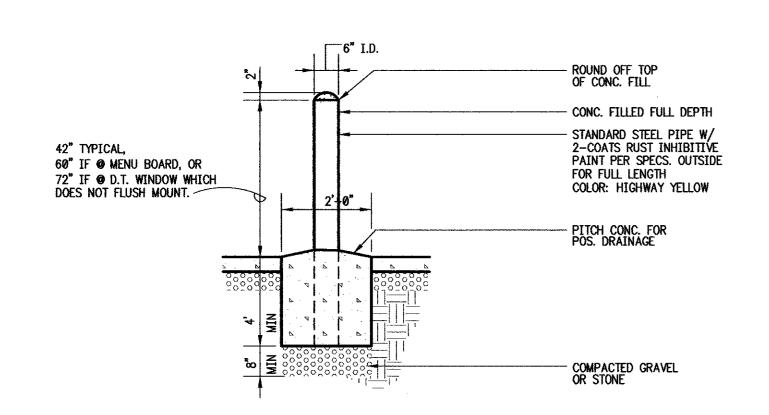

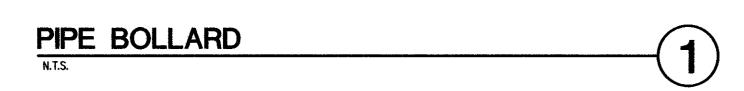


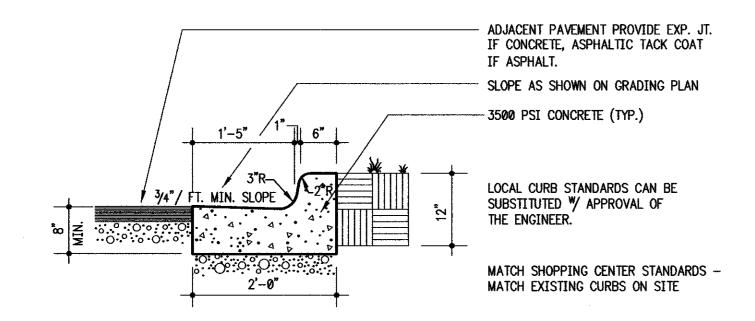


## **CONCRETE CURB & GUTTER DETAIL**

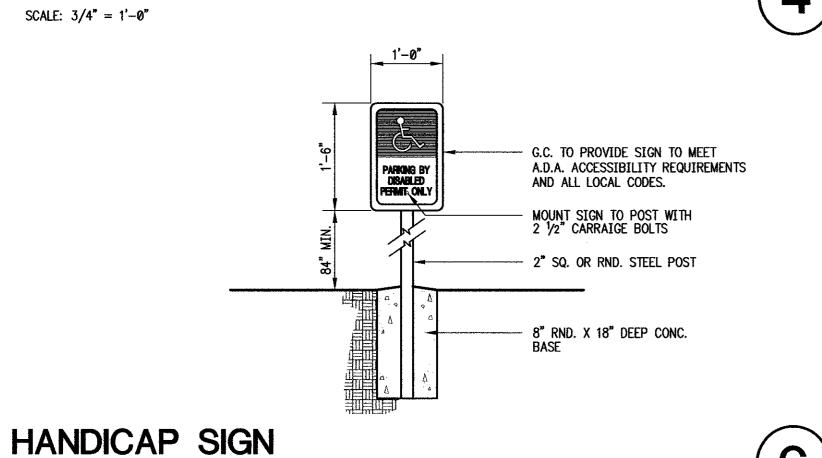

NOT USED

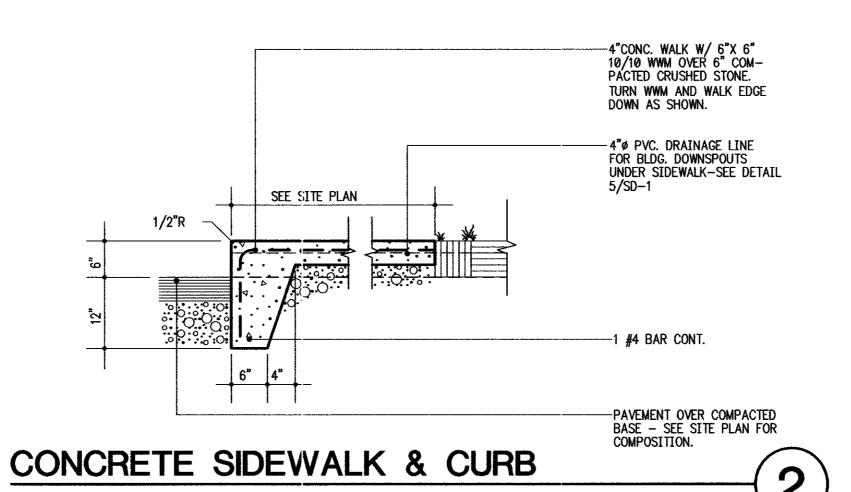

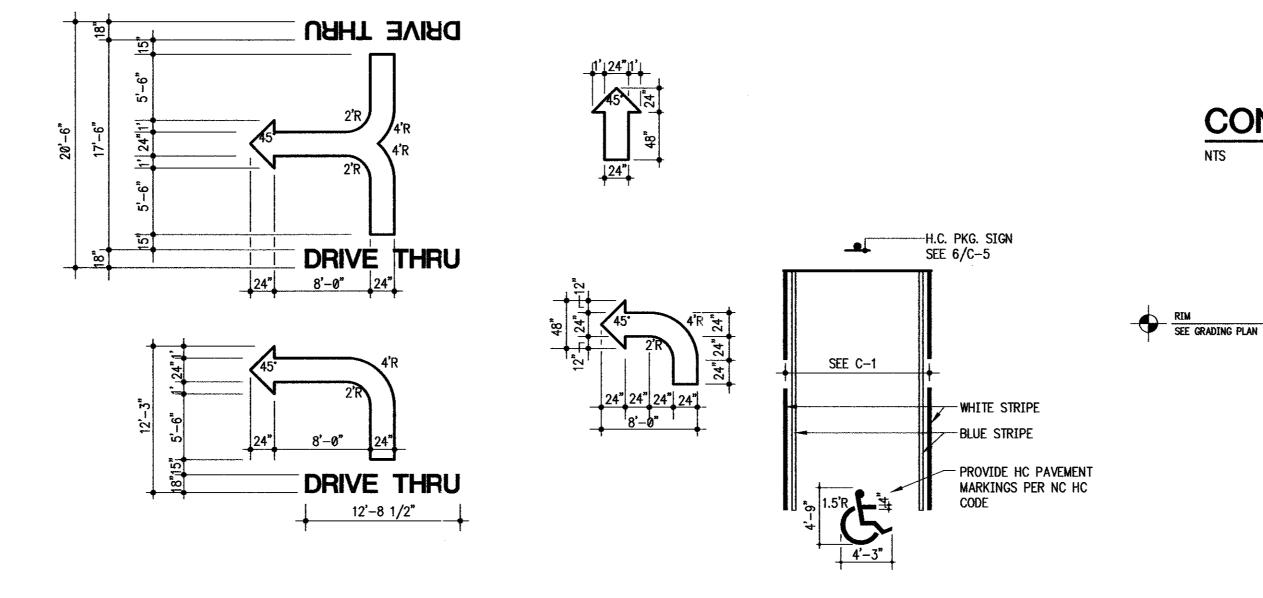




REFER TO SPECIFICATIONS AND DRAWINGS CE-1, CE-2, CE-3, CE-4, CE-6.

5

- ALL SITE WORK AND PAVING MUST BE IN ACCORDANCE WITH OR SURPASS RECOMMENDATIONS OF SOILS REPORT. IF SOILS REPORT CONFLICTS WITH DRAWINGS AND SPECIFICATIONS, THE MORE PROHIBITIVE OF THE TWO SHALL TAKE PRECEDENCE AND BE CONSIDERED TO BE THE INTENT OF THE BID
- ALL FILL ON THE PROPERTY SHALL BE ADEQUATELY COMPACTED BY ROLLING TO PRODUCE A SURFACE SATISFACTORY FOR THE PROPER INSTALLATION OF BASE COURSE AND PAVING. BEFORE PAVING WORK, THE PAVING CONTRACTOR MUST BE CERTAIN THAT THE SURFACES TO BE COVERED ARE IN PROPER CONDITIONS. SURFACE NOT ACCEPTABLE SHALL BE REPORTED TO THE OWNER IMMEDIATELY. THE APPLICATION OF PAVING MATERIALS SHALL BE HELD AS ACCEPTANCE OF THE SURFACES AND WORKING CONDITIONS BY THE PAVING CONTRACTOR WHO WILL BE HELD RESPONSIBLE FOR PRODUCING THE REASONABLE RESULTS EXPECTED.

FOR ALL PAVEMENT WORK.

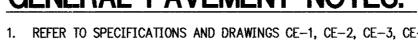

NOTE: THESE NOTES REPRESENT MINIMUM SPECIFICATIONS, FOLLOW STATE STANDARDS AND SOILS INVESTIGATION

AS-BUILT DRAWINGS: THE INTENT OF THE OWNER AND ENGINEER WAS TO CONSTRUCT THE FACILITIES ACCORDING TO THESE PLANS AS APPROVED BY THE TOWN OF ADDISON. THE OWNER OR ENGINEER DID NOT VERIFY LINES OR GRADES AFTER CONSTRUCTION AND ARE NOT AWARE OF ANY CHANGES OR REVISIONS TO PLANS DURING CONSTRUCTION EXCEPT AS NOTED BASED ON INFORMATION

CONCRETE CATCH BASIN MANHOLE

4'-0" DIA.

5'-0" DIA.

3/4/00

NEENAH #R-3401 INLET AND FRAME (HEAVY DUTY).

ANCHOR FRAME PER MANUFACTURER'S

CONCRETE OR BITUMINOUS ASPHALT.

CONCRETE OR BITUMINOUS ASPHALT.

ANCHOR FRAME PER MANUFACTURER'S

#4 REBARS, 12" O.C. BOTH WAYS.

- AS REQUIRED, SEE GRADING PLAN.

- EXISTING PIPE, SEE GRADING PLAN. ONLY CUT AWAY TOP HALF OF PIPE WHERE IT FALLS INSIDE NEW INLET

GROUT INVERT FOR POSITIVE DRAINAGE.

UNDISTURBED OR COMPACTED SUBGRADE.

NEENAH # R-3433 GRATE W/ ROUND BASE

ANCHOR FRAME PER MANUFACTURER'S SPECIFICATIONS.

5" THICK PRECAST CONCRETE SECTIONS FABRICATED IN COMPLIANCE W/A.S.T.M.

STEPS 16" O.C. (NEENAH CAT. NO.

R-1981-W OR EQUAL)

G.C. TO SAWCUT AND GROUT
 EX. 27" PIPE IN OPENING AS REQUIRED, SEE GRADING PLAN.

GROUT NEW 12" PIPE IN OPENING AS REQUIRED, SEE GRADING PLAN.

— 12" INLET, INLET PIPES, SEE GRADING PLAN.

GROUT INVERT FOR POSITIVE DRAINAGE

4" PRECAST CONCRETE FLOOR W/4"

3,500 PSI, AIR ENTRAINED CONCRETE.

SPECIFICATIONS.

SPECIFICATIONS.

PLAN VIEW

CONCRETE CATCH BASIN

99154

ROAD BELTINE FAZOLI'S RESTAURANT AT MARSH LANE ADDISON, TX

P.S.C. Group,

DATE: 09/30/99

DRAWN BY: TRG

CHECKED BY: TRG



SITE **DETAILS** 

**DETAIL** 

SCALE: 1-1/2"= 1'-0"

PAINTED PAVEMENT SIGNS

ALL PAVEMENT WORK SHALL COMPLY W/ SOILS INVESTIGATION/RECOMMENDATIONS PREPARED FOR THIS PROJECT. ALL MATERIALS SHALL BE PROVIDED & ALL WORK BE PERFORMED PER STATE OF TEXAS DEPARTMENT OF TRANSPORTATION STANDARDS.

5"-3500 PSI (6" AT REFUSE AREA) AIR-ENTRAINED P.C. CONCRETE REINFORCED W/ 6x6,

6" LIME TREATED SUBGRADE

-EXISTING (PROOFROLLED) SUB-GRADE OR COMPACTED SUBGRADE.

W1.4 x 1.4 W.W.M.

PAVEMENT DETAILS

SAWED CONTROL JOINTS SHALL BE 1/4 THE THICKNESS OF THE CONCRETE SECTION.

CONCRETE PAVEMENT SECTION

(9)


PAVEMENT DETAILS AND NOTES

6

INVERT SEE GRADING PLAN

VAUGHN R. HILL PE # 65493

DATE

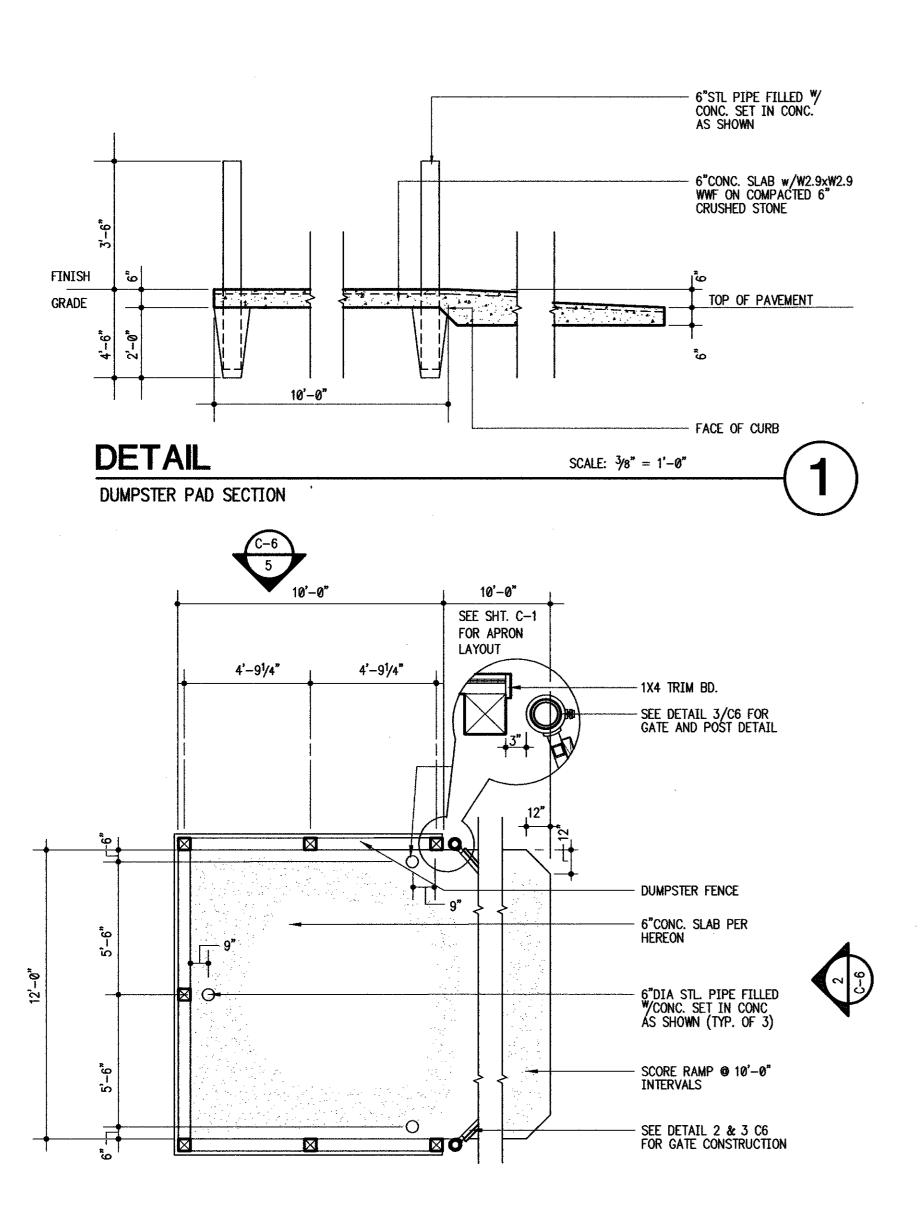

DETAIL

WOOD DUMPSTER FENCE W/ CONC. PAD & APRON

SEE SITE PLAN FOR TYPE OF FENCE SPECIFIED.


AS—BUILT DRAWINGS:


THE INTENT OF THE OWNER AND ENGINEER WAS TO CONSTRUCT THE FACILITIES ACCORDING TO THESE PLANS AS APPROVED BY THE TOWN OF ADDISON.

THE OWNER OR ENGINEER DID NOT VERIFY LINES OR GRADES AFTER CONSTRUCTION AND ARE NOT AWARE OF ANY CHANGES OR REVISIONS TO THESE PLANS DURING CONSTRUCTION EXCEPT AS NOTED BASED ON INFORMATION PROVIDED BY THE CONTRACTOR.


VAUGHN R. HILL PE # 65493

DATE

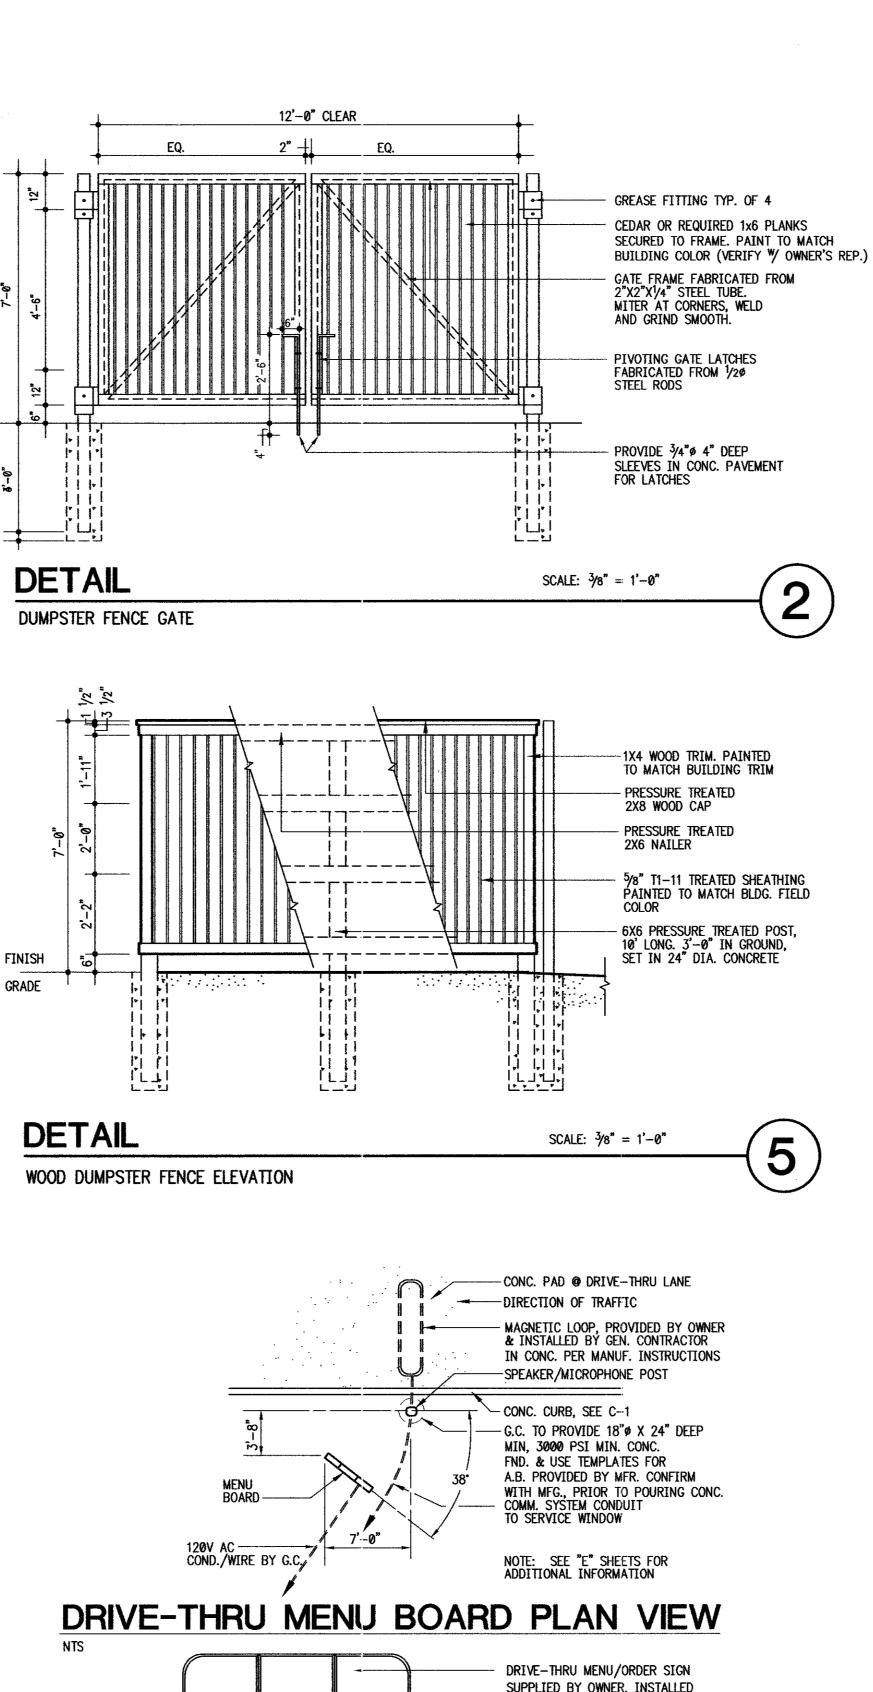

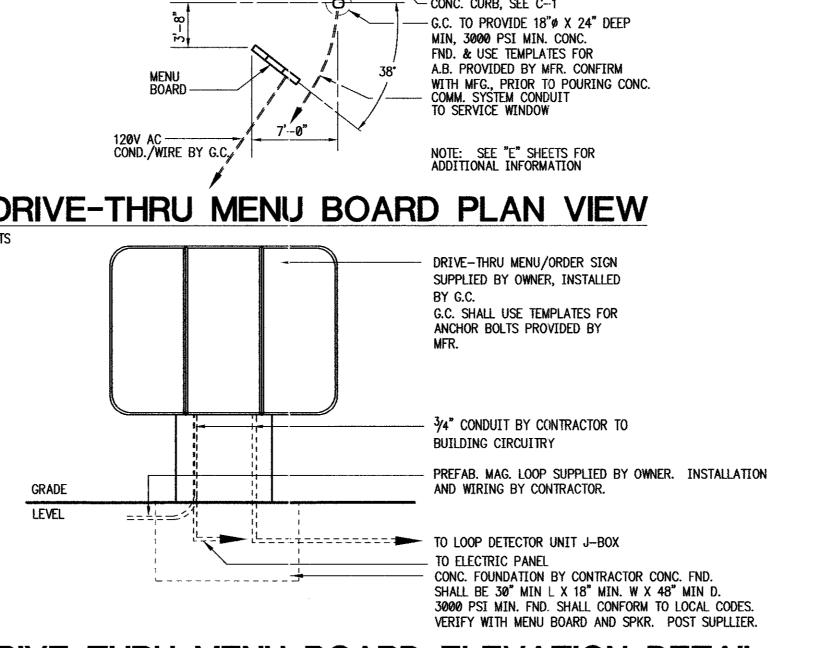



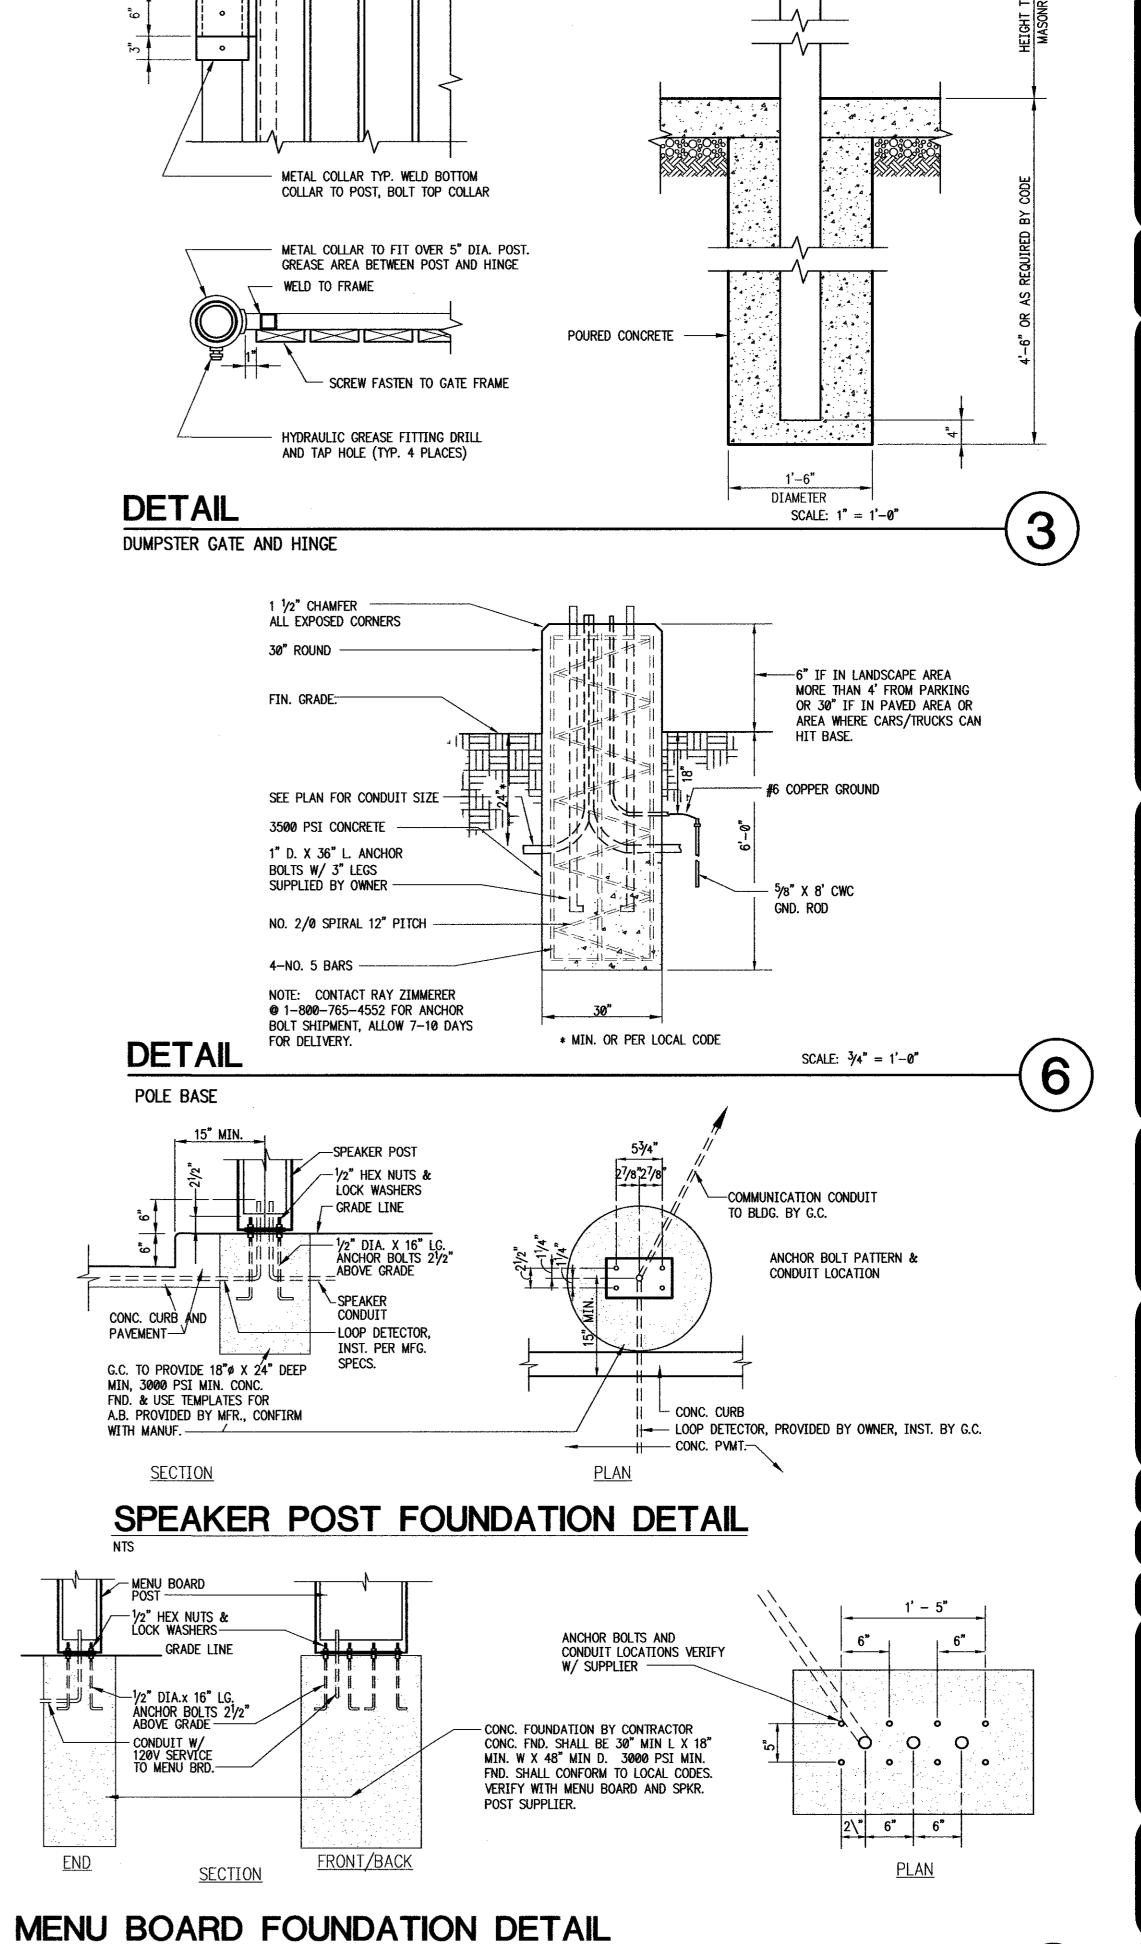

5" DIA. CONCRETE FILLED STEEL POST

ROAD

BELTINE

MARSH LANE ADDISON, TX

DATE: 09/30/99


DRAWN BY: TRG

CHECKED BY: TRG


FAZOLI'S RESTAURANT


DRIVE-THRU ORDER BOARD DETAILS


NOTE: ALL FOUNDATIONS SHALL MEET OR EXCEED LOCAL FROST DEPTH REQUIREMENTS

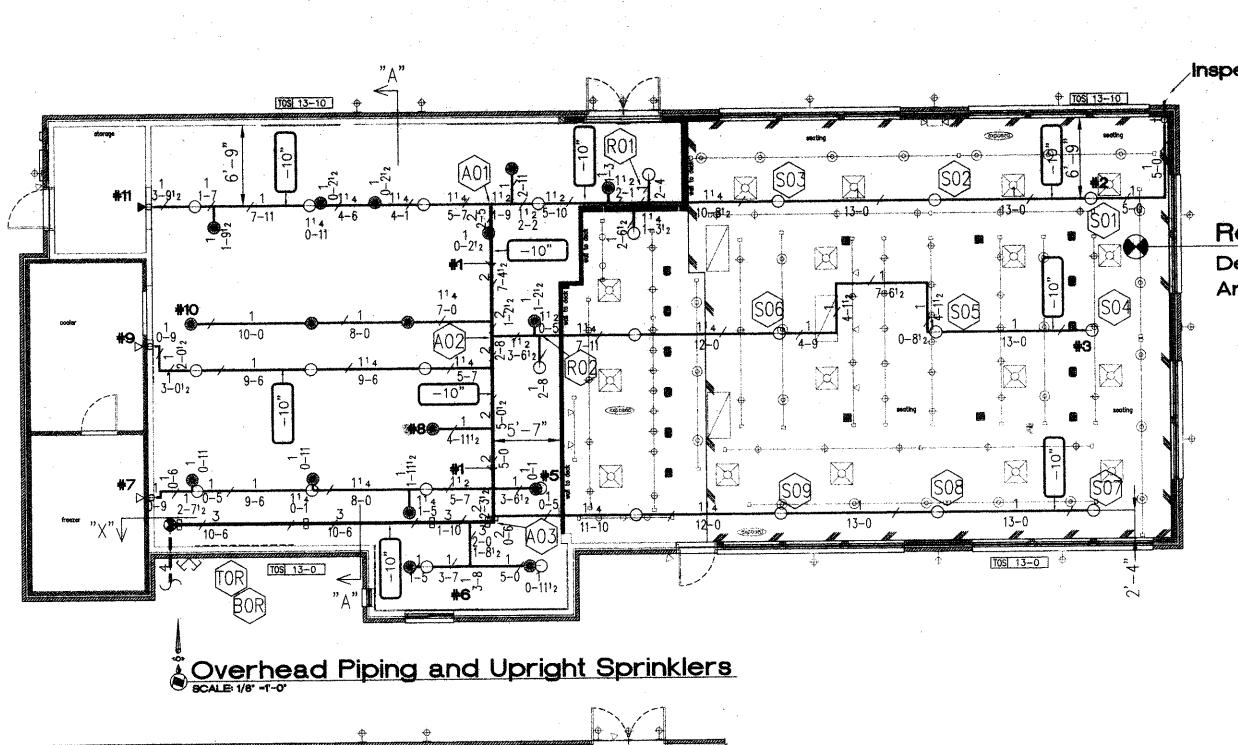


Remote Area Density: .15 Area: 1,050 sq. ft.

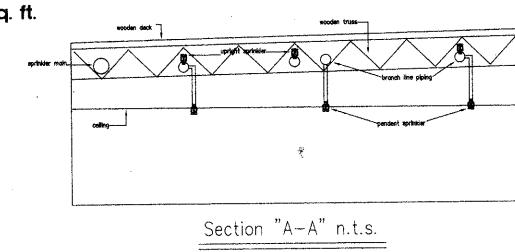

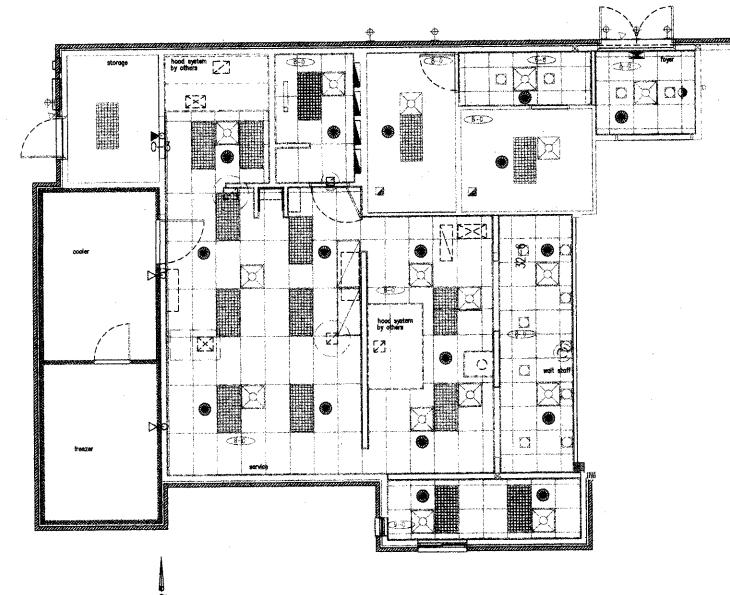

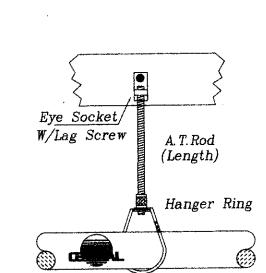

# Pendent Sprinkler locations

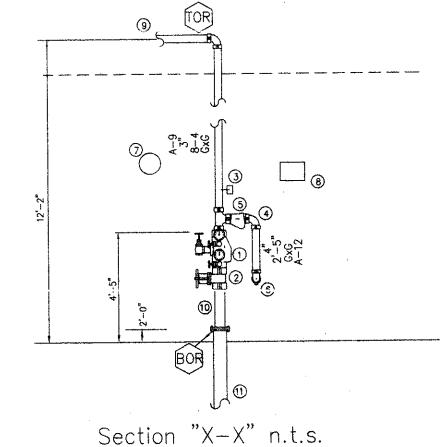


- 1. Central 3" alarm check va. w/trim (gxf)
  2. 3" Central grooved butterfly valve w/ tamper switch
- 3. 3" flow switch
- 4. 3" grooved 90 deg ell
- 5. 3" Central grooved swing check valve
  6. 3" grooved 90 deg ell away 3"x3'-0" to f.d.c.(w/ 1/2" ball drip)
  7. Water motor & gong
- 8. 6 head spare sprinkler cabinet 9. 3" to sprinklers
- 10. 3"x1'-0" grv x flg(3"x9" red. flg.) 11. 4" underground supply—by others


## GENERAL NOTES

- 1. Structure to be adequately heated to prevent system from freezing. (by owner)
- 2. All materials to be in accordance w/NFPA 13 & Town of Addison. 3. Design to be in accordance w/NFPA 13 & Town of Addison.
- 4. All hangers to be in accordance w/NFPA 13. & Town of Addison.
- 5. Installation to be in accordance w/NFPA 13 & Town of Addison. 6. All pipe 2 1/2" and larger to be schedule 10 black w/ grooved fittings.
- All pipe 2" and smaller to be threadable lightwall w/ cast iron screwed fittings.
- 7. Hydraulic calculations reference point. (A03)
- 8. Symbols: (0-8)- Pipe elevation below top of steel. [15-0]— Pipe elevation above finished floor.
- TOS 12'-3" Top of steel above finished floor. 9. All fire sprinkler underground to be installed per N.F.P.A.#24.


### CONTRACT EXCLUSIONS


- 1. Electrical or alarm wiring.
- 2. Overtime work. 3. Painting or patching.
- 4. Insulation of building & piping.
- 5. Freeze damage.
- 6. Replacement of sprinklers damaged by other trades.
- 7. Annual testing or system inspection.
- 8. Sprinklers in center of ceiling tile.

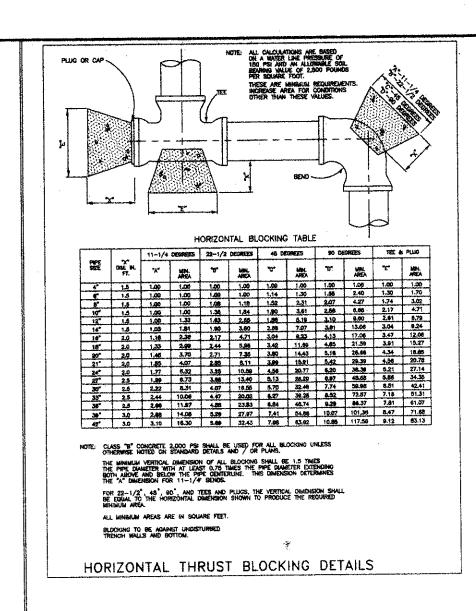

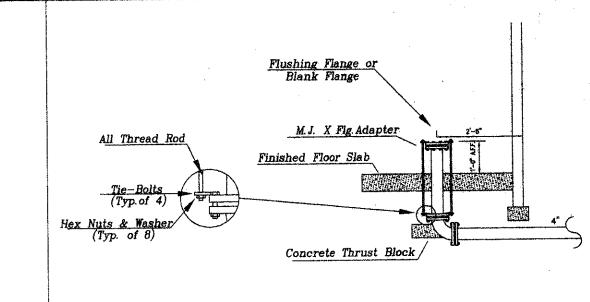

WATER FLOW TEST INFO PER CITY OF ADDISON TEST TAKEN 09-04-99 BY FIRE DEPARTMENT STATIC-----87 P.S.I. RESIDUAL----78 P.S.I. FLOWING----3084 G.P.M. FROM (1) 4" OUTLET PITOT=52 TEST LOCATION--- 3750 Beltline Rd. 20" CIRCULATING MAIN

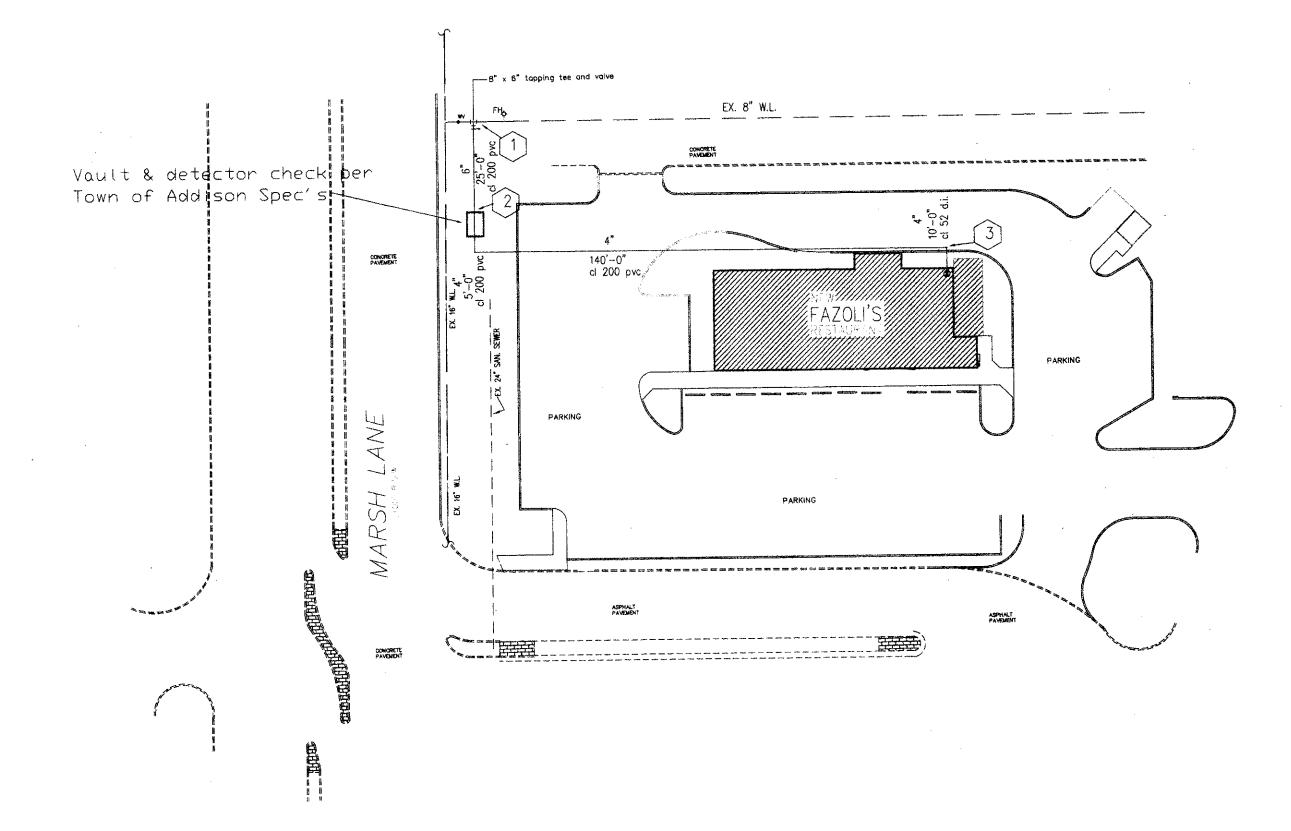

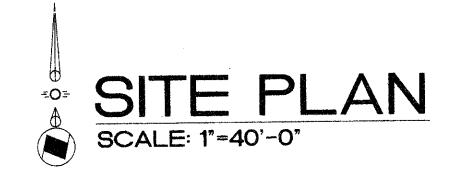

### GENERAL NOTES

- 1. All work performed and all materials installed shall be in accordance
- with N.F.P.A. #13 & #24 and City.
- 2. Design to be in accordance w/NFPA #13 and #24 and City.
- 3. All underground piping to be class 200 pvc except for 5'-0" outside of building and spigot into building to be class 52 ductile iron.
- 5. Hydraulic calculations reference point.  $\langle$  1  $\rangle$


## CONTRACT EXCLUSIONS

- 1. Concrete and/or paving replacement or removal.
- 2. Overtime work.
- 3. Painting or patching. 4. Insulation of building & piping.
- 5. Removal and disposal of unused excavated materials from site.
- 6. Replacement of sprinklers damaged by other trades.
- 7. Annual testing or system inspection.
- 8. Performance and or maintenance bonds.


Automatic Fire Sprinkler System for: Fazoli's Restaurant 15000 Marsh Lane Addison, Texas




\*\*\*\*\*\*\*\*\*\*\*

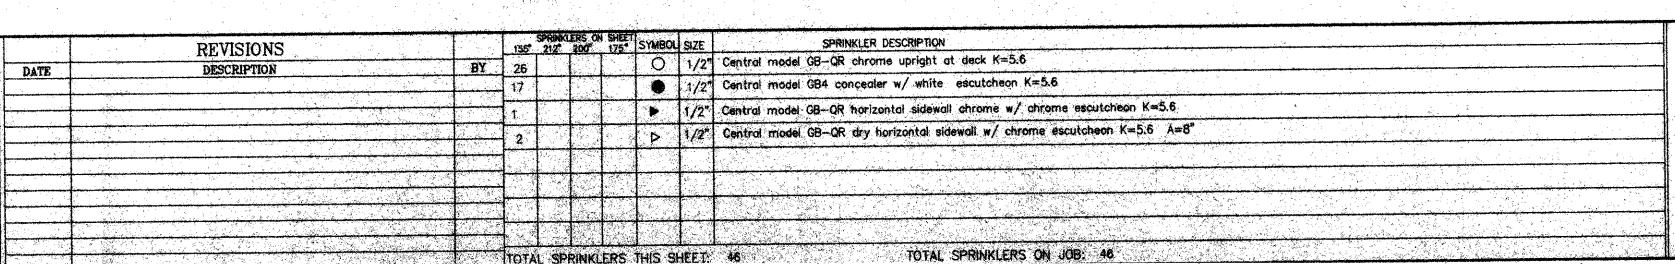

Overhead Fire Sprinkler Plan

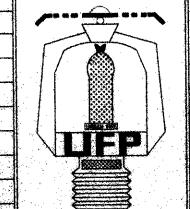



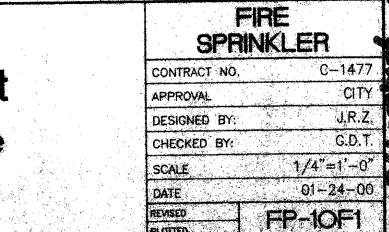

DRAWING SUBMITTED FOR REVIEW
I hereby certify that this sprinkler system has been designed in accordance with the specifications, contract agreements, local ordinances, building codes, or applicable NFPA standards adopted by the Authority having Jurisdiction.