AS BUILT SITE DEVELOPMENT PLANS



Marsh 15 120

For Taco Cabana 8919 Tesoro Drive Ste. 200 San Antonio, Texas

Submittal Date:

Site Planning, Engineering, & Landscape Architecture



LEGAL DESCRIPTION: PROPOSED LOT 1, BLOCK 2,

MARSH BELT LINE SHOPPING CENTER

SHEET INDEX


DRAINAGE PLAN
EROSION AND SEDIMENTATION CONTROL PLAN

ZONING: PD

THIS PROJECT WAS CONSTRUCTED IN CONFORMITY TO THE TOWN TO THE BEST OF MY KNOWLEDGE

Airport Carrollton Addison S Belt Line Road Belt Line Road Farmer's Branch

LOCATION MAP

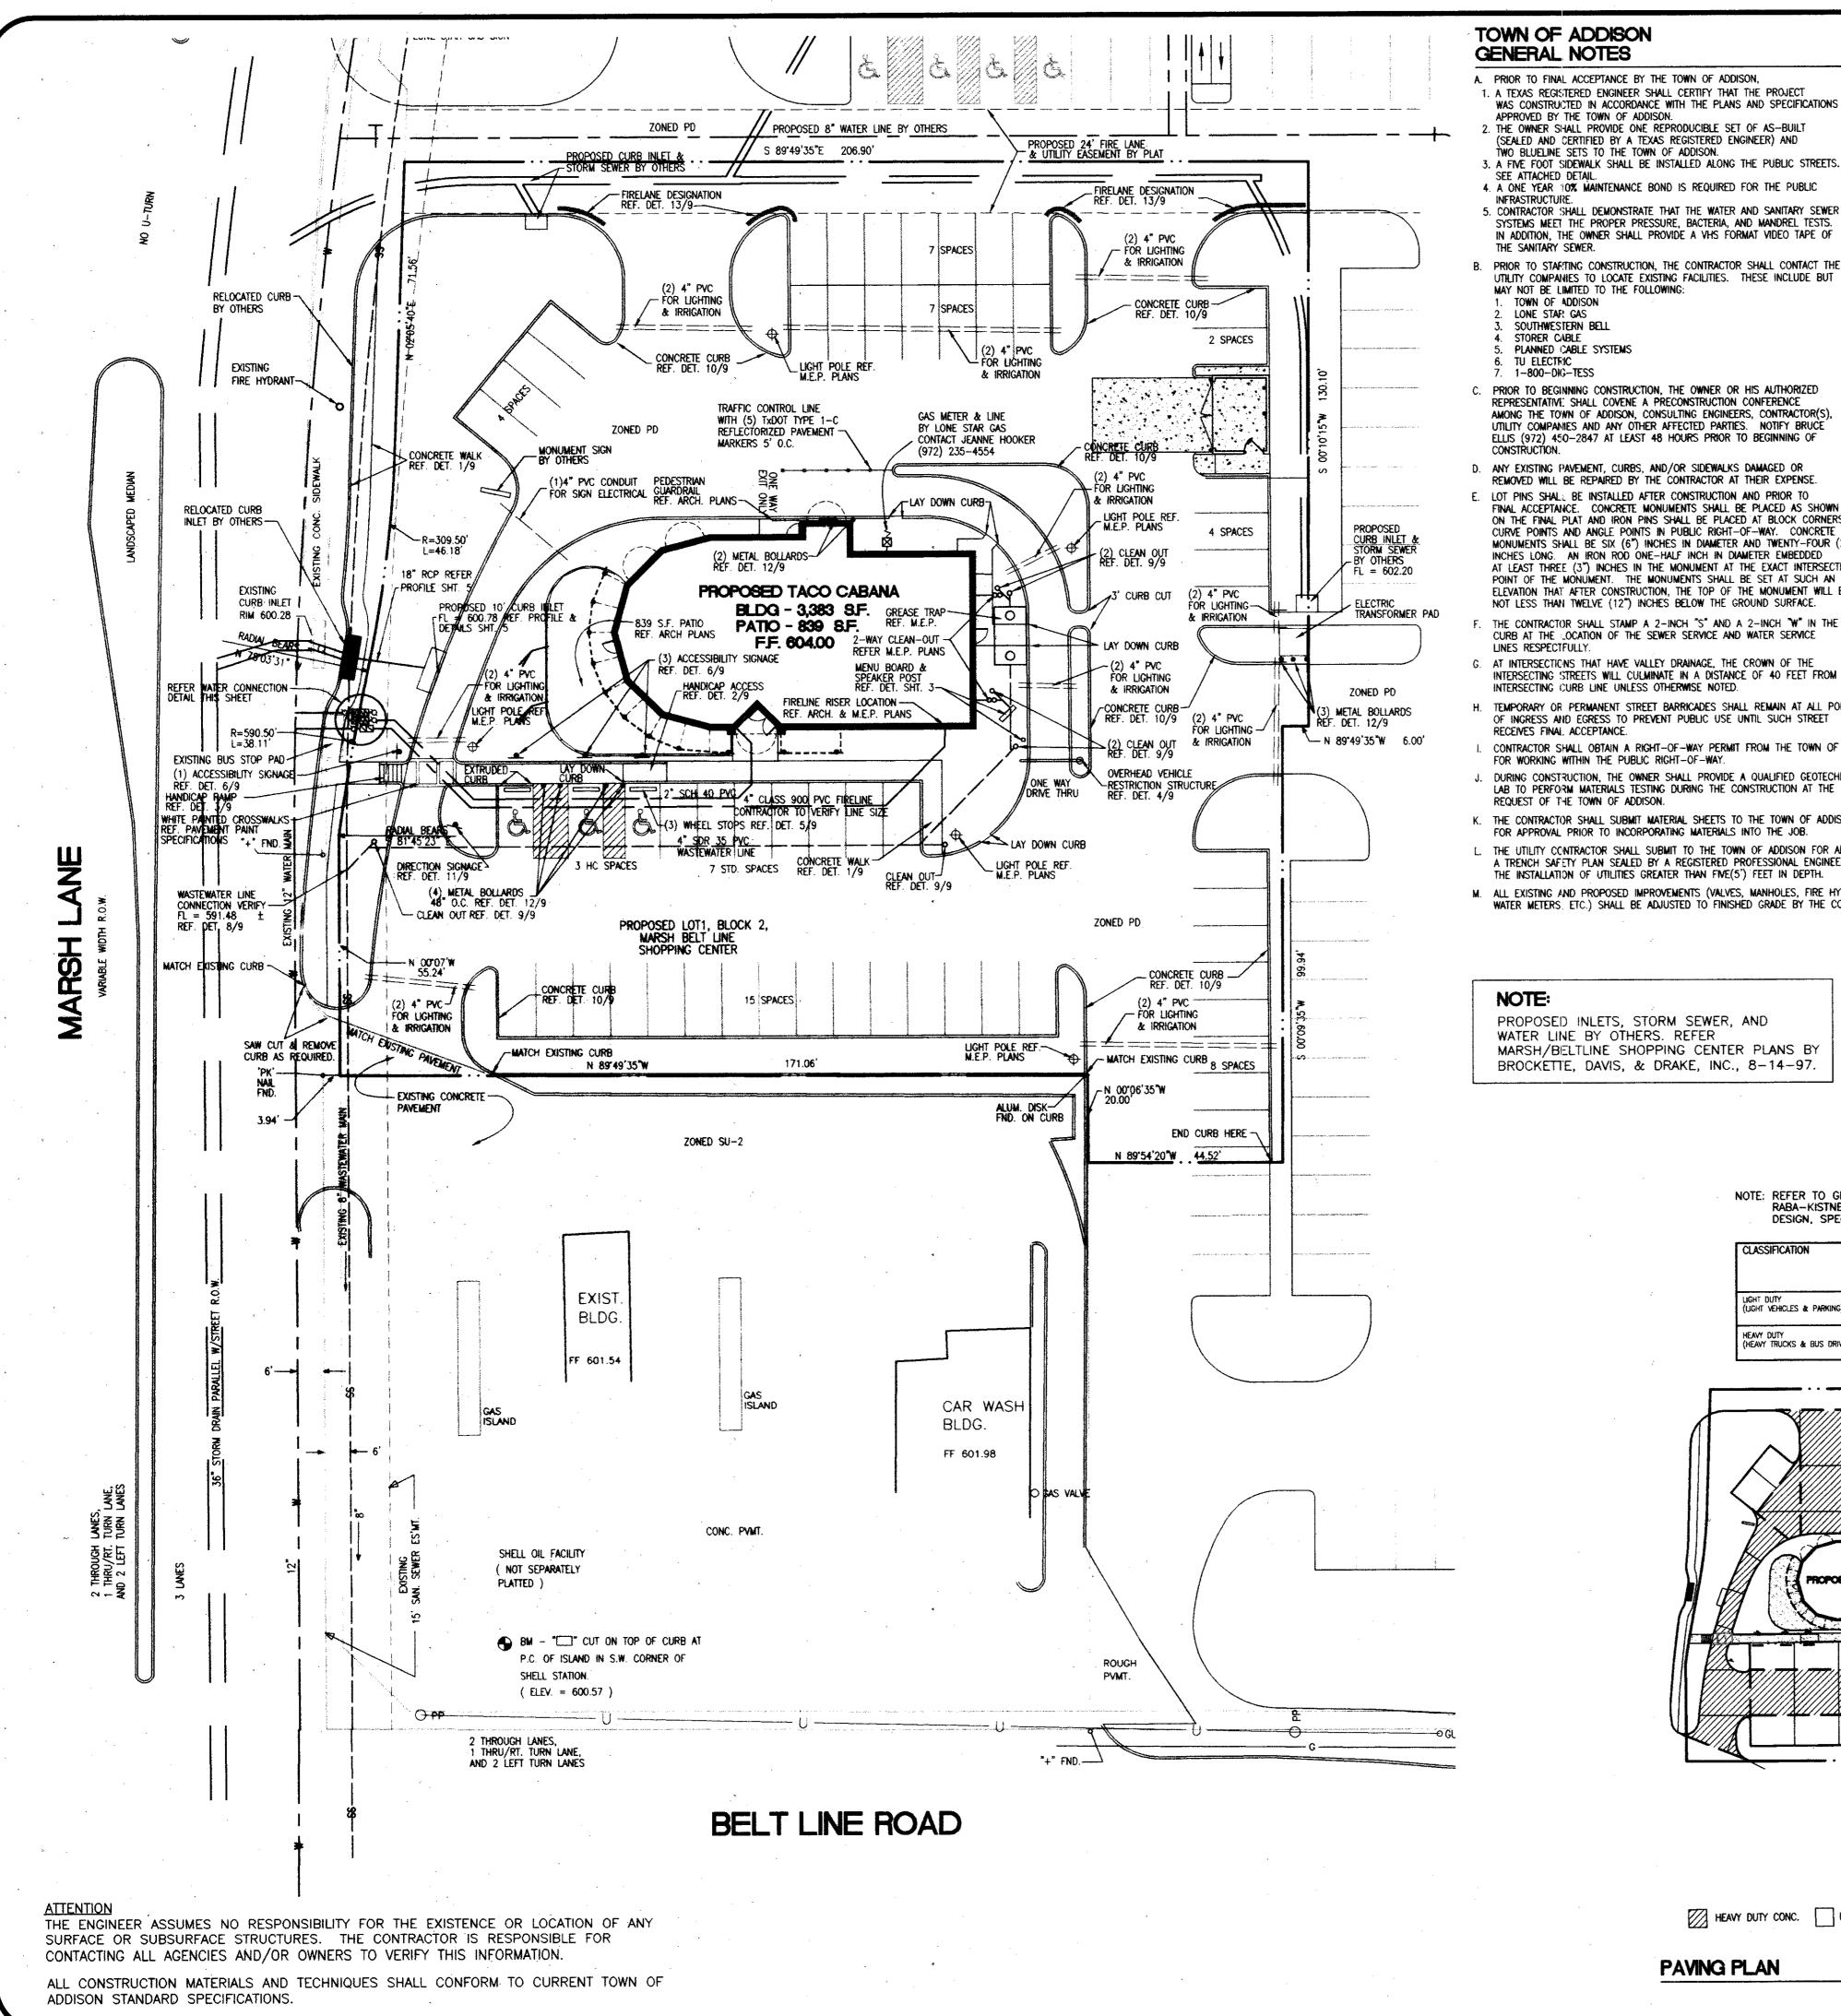

TOWN OF ADDISON

- A. PRIOR TO FINAL ACCEPTANCE BY THE TOWN OF ADDISON, 1. A TEXAS REGISTERED ENGINEER SHALL CERTIFY THAT THE PROJECT
- APPROVED BY THE TOWN OF ADDISON. . THE OWNER SHALL PROVIDE ONE REPRODUCIBLE SET OF AS-BUILT (SEALED AND CERTIFIED BY A TEXAS REGISTERED ENGINEER) AND
- TWO BLUELINE SETS TO THE TOWN OF ADDISON. 3. A FIVE FOOT SIDEWALK SHALL BE INSTALLED ALONG THE PUBLIC STREETS
- 4. A ONE YEAR 10% MAINTENANCE BOND IS REQUIRED FOR THE PUBLIC INFRASTRUCTURE 5. CONTRACTOR SHALL DEMONSTRATE THAT THE WATER AND SANITARY SEWER SYSTEMS MEET THE PROPER PRESSURE, BACTERIA, AND MANDREL TESTS. IN ADDITION, THE OWNER SHALL PROVIDE A VHS FORMAT VIDEO TAPE OF
- B. PRIOR TO STAFFTING CONSTRUCTION, THE CONTRACTOR SHALL CONTACT THE UTILITY COMPANIES TO LOCATE EXISTING FACILITIES. THESE INCLUDE BUT MAY NOT BE LIMITED TO THE FOLLOWING: TOWN OF ADDISON
- SOUTHWESTERN BELL STORER CABLE
- PLANNED CABLE SYSTEMS THE FLECTRIC
- 1-800-DKG-TESS
- PRIOR TO BEGINNING CONSTRUCTION, THE OWNER OR HIS AUTHORIZED REPRESENTATIVE SHALL COVENE A PRECONSTRUCTION CONFERENCE AMONG THE TOWN OF ADDISON, CONSULTING ENGINEERS, CONTRACTOR(S), UTILITY COMPANIES AND ANY OTHER AFFECTED PARTIES. NOTIFY BRUCE ELLIS (972) 450-2847 AT LEAST 48 HOURS PRIOR TO BEGINNING OF
- D. ANY EXISTING PAVEMENT, CURBS, AND/OR SIDEWALKS DAMAGED OR REMOVED WILL BE REPAIRED BY THE CONTRACTOR AT THEIR EXPENSE
- LOT PINS SHALL BE INSTALLED AFTER CONSTRUCTION AND PRIOR TO FINAL ACCEPTANCE. CONCRETE MONUMENTS SHALL BE PLACED AS SHOWN ON THE FINAL PLAT AND IRON PINS SHALL BE PLACED AT BLOCK CORNERS, CURVE POINTS AND ANGLE POINTS IN PUBLIC RIGHT-OF-WAY. CONCRETE MONUMENTS SHALL BE SIX (6") INCHES IN DIAMETER AND TWENTY-FOUR (24") INCHES LONG. AN IRON ROD ONE-HALF INCH IN DIAMETER EMBEDDED AT LEAST THREE (3") INCHES IN THE MONUMENT AT THE EXACT INTERSECTION POINT OF THE MONUMENT. THE MONUMENTS SHALL BE SET AT SUCH AN ELEVATION THAT AFTER CONSTRUCTION, THE TOP OF THE MONUMENT WILL BE NOT LESS THAN TWELVE (12") INCHES BELOW THE GROUND SURFACE.
- F. THE CONTRACTOR SHALL STAMP A 2-INCH "S" AND A 2-INCH "W" IN THE CURB AT THE LOCATION OF THE SEWER SERVICE AND WATER SERVICE
- G. AT INTERSECTIONS THAT HAVE VALLEY DRAINAGE, THE CROWN OF THE INTERSECTING STREETS WILL CULMINATE IN A DISTANCE OF 40 FEET FROM THE INTERSECTING CURB LINE UNLESS OTHERWISE NOTED.
- H. TEMPORARY OR PERMANENT STREET BARRICADES SHALL REMAIN AT ALL POINTS OF INGRESS AND EGRESS TO PREVENT PUBLIC USE UNTIL SUCH STREET RECEIVES FINAL ACCEPTANCE.
- CONTRACTOR SHALL OBTAIN A RIGHT-OF-WAY PERMIT FROM THE TOWN OF ADDISON FOR WORKING WITHIN THE PUBLIC RIGHT-OF-WAY.
- J. DURING CONSTRUCTION, THE OWNER SHALL PROVIDE A QUALIFIED GEOTECHNICAL LAB TO PERFORM MATERIALS TESTING DURING THE CONSTRUCTION AT THE REQUEST OF THE TOWN OF ADDISON.
- K. THE CONTRACTOR SHALL SUBMIT MATERIAL SHEETS TO THE TOWN OF ADDISON FOR APPROVAL PRIOR TO INCORPORATING MATERIALS INTO THE JOB. L. THE UTILITY CONTRACTOR SHALL SUBMIT TO THE TOWN OF ADDISON FOR APPROVAL
- A TRENCH SAFETY PLAN SEALED BY A REGISTERED PROFESSIONAL ENGINEER FOR THE INSTALLATION OF UTILITIES GREATER THAN FIVE(5') FEET IN DEPTH.
- M. ALL EXISTING AND PROPOSED IMPROVEMENTS (VALVES, MANHOLES, FIRE HYDRANTS, WATER METERS, ETC.) SHALL BE ADJUSTED TO FINISHED GRADE BY THE CONTRACTOR.

SITE PLAN NOTES

- 1 ALL DIMENSIONS ARE TAKEN TO FACE OF CURB OR BUILDING UNLESS OTHERWISE NOTED.
- 2 CONTRACTOR SHALL VERIFY DIMENSIONS AND NOTIFY ENGINEER OF ANY DISCREPANCIES.
- 3 USE DIMENSIONAL INFORMATION GIVEN. DO NOT SCALE DRAWINGS.

WILL NOT BE ACCEPTABLE.

- CONTRACTOR SHALL VERIFY EXACT LOCATIONS AND PROTECT ALL EXISTING SITE IMPROVEMENTS AND UTILITIES DURING CONSTRUCTION OPERATIONS.
- 5 ALL WALKWAYS LEADING TO ENTRANCES ARE TO BE

CENTERED ON DOORWAYS UNLESS OTHERWISE NOTED.

- 6 AT LOCATIONS WHERE EXISTING PAVEMENT ABUTS NEW PAVEMENT, CONTRACTOR SHALL BLEND NEW PAVEMENT TO EXISTING CONDITIONS. PAVEMENTS SHALL ALIGN BOTH VERTICALLY AND HORIZONTALLY PONDING AT JOINTS
- 7 PROVIDE MINIMUM 1/8" PER FOOT CROSS SLOPE IN DIRECTION OF SURFACE DRAINAGE ON ALL WALKWAYS.
- 8 WHERE NEW CONCRETE PAVEMENT MEETS EXISTING CONCRETE OR VERTICAL SURFACES PROVIDE 1/2' EXPANSION JOINT. WHERE NEW CONCRETE PAVEMENT MEETS EXISTING ASPHALT, SAW CUT EDGE OF ASPHALT AND BUTT NEW PAVEMENT TIGHT. SCORING JOINTS SHALL MATCH EXISTING CONDITION WHERE NEW CONCRETE PAVEMENT REPLACES EXISTING OR ABUTS EXISTING CONCRETE PAVEMENT.
- 9 FINISH ON CONCRETE SHALL BE PERPENDICULAR TO
- 10 WHERE NEW ASPHALT PAVEMENT MEETS EXISTING ASPHALT, SAW CUT EXISTING ASPHALT. ALL NEW PAVEMENTS SHALL MEET EXISTING FLUSH:
- PARKING LOT LINES AND TRAFFIC CONTROL MARKINGS SHALL BE PAINTED ON PAVEMENT WITH MINIMUM 4" WIDE LINES OR AS SHOWN ON PLANS.
- 12 PROVIDE EXPANSION JOINT MATERIAL AT ALL LOCATIONS WHERE CURB AND GUTTER ABUTS OR IS ADJACENT
- 13 AUTOMATIC UNDERGROUND IRRIGATION SYSTEM WILL BE PROVIDED. CONTRACTOR TO PROVIDE SLEEVING FOR UNDERGROUND IRRIGATION SYSTEM AND COORDINATE WITH IRRIGATION PLAN.
- 14 ALL HANDICAP PARKING SPACES SHALL HAVE SIGNS as indicated on the plans and as per details

15 LIGHT POLES OR SIGN POLES ARE NOT ALLOWED IN

- PARKING OR DRIVEWAY PAVEMENT AREAS. COORDINATE LOCATIONS WITH LANDSCAPE PLAN. 16 PIERS FOR LIGHT ROLES SHALL NOT BE ABOVE CURB.
- 17 ALL LIGHT POLES WILL BE A MINIMUM THREE (3) FEET
- 18 CONTRACTOR TO ADJUST ALL EXISTING MANHOLES, PULLBOXES, AND OTHER UTILITIES WHERE NECESSARY TO BE FLUSH WITH FINISH GRADE.

REINFORCED PORTLAND CEMENT CONCRETE, IN.

19 FOR PAVEMENT DESIGN AND CONSTRUCTION REF. TO GEOTECHNICAL STUDY PREPARED FOR TACO CABANA BY RABA-KISTNER-BRYTEST INC. PROJECT NO. AAA97-047-00. CONCRETE PAVING IS REQUIRED.

PAVEMENT PAINT SPECIFICATION: FIRE LANE PAVEMENT PAINT SHALL, BE GLIDDEN ∦4520 OIL ENAMEL "SAFETY RED" TRAFFIC ARROW PAVEMENT PAINT SHALL BE

GLIDDEN #22693 OIL ENAMEL "TRAFFIC WHITE" CROSSWALK PAVEMENT PAINT SHALL BE GLIDDEN #22693 OIL ENAMEL "TRAFFIC WHITE" YELLOW TRAFFIC STRIPE PAVEMENT PAINT SHALL BE GLIDDEN #22692 OIL ENAMEL "TRAFFIC YELLOW"

SITE DATA

TOTAL LOT AREA	45,460 S.F.
	1.0436 ac.
IMPERVIOUS COVER	34,738 S.F.
% OF SITE AREA	76 %
BUILDING AREA	3,383 S.F.
PROPOSED USE	RESTAURANT W/ DRIVE-THROUGH
STORIES	1 .
HEIGHT	16'-8"
FINISH FLOOR	604.00
ZONING	PD

POWER POLE ----P--- OVERHEAD ELECTRIC + 100.00 EXISTING SPOT ELEVATION 100.00 PROPOSED SPOT ELEVATION MISC. CONCRETE PAVING LIMITS OF CONSTRUCTION ------ PROPERTY LINE SILT FENCE DRAINAGE AREA DRAINAGE AREA BOUNDARY +++++++ FILTER DIKE -X X TREE PROTECTION FENCE --- 704 --- EXISTING CONTOUR PROPOSED CONTOUR EXISTING TREE TO REMAIN

TOP OF GRATE

BOTTOM OF CURB

TOP OF CURB

BACK OF CURB

FACE OF CURB

MORTAR STACK ROCK WALL

FIRE HYDRANT

WATER METER

TOP OF WALL

INVERT

RETAINING WALL

— — WASTE WATER LINE

- STORM SEWER LINE

--- WATER LINE

FLOW LINE

HIGH POINT

LEGEND


EXISTING TREE TO BE REMOVED TRAFFIC GUARD RAIL

FIRE LANE DESIGNATION HAND RAILS


PARKING

USE	REQUIRED -	PROVIDED		
		STANDARD	HANDICAP	TOTAL
RESTAURANT (3,383 S.F.) © 1 SPACE/70S.F.	48	46	2	48
PATIO (839 S.F.) © 1 SPACE/70S.F.	12	11	1	12
TOTAL	60	57	3	60

FOR METER VAULT PRODUCTS CONTACT: BROOKS PRODUCTS, INC. 2001 W. MAYFIELD ARLINGTON, TEXAS 76015 (817) 467–2783 or (817) 465–0080 FAX (817) 465-6909

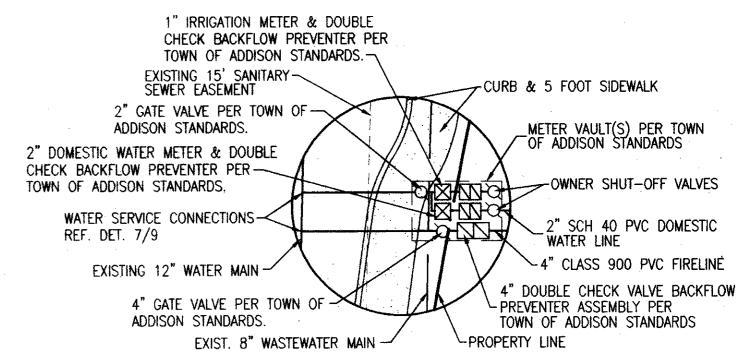

WATER CONNECTION DETAIL

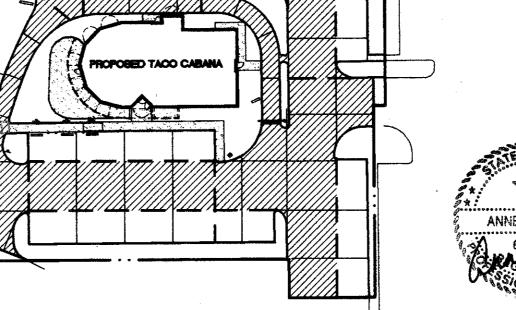

HEAVY DUTY CONC. UGHT DUTY CONC.

NOTE: REFER TO GEOTECHNICAL STUDY PREPARED BY RABA-KISTNER-BRYTEST INC. FOR ALL PAVEMENT

LIGHT DUTY (LIGHT VEHICLES & PARKING)

DESIGN, SPECIFICATIONS, AND CONSTRUCTION.

STRUCTURAL FI

PAVING PLAN


SCALE: 1" = 50'



SITE, PAVING, AND UTILITY PLAN AS BUILT

SHT. TACO CABANA 3801 BELT LINE ROAD


SCALE: 1" = 20'DRAWN BY: 9-23-97 REVISIONS: 11-14-97

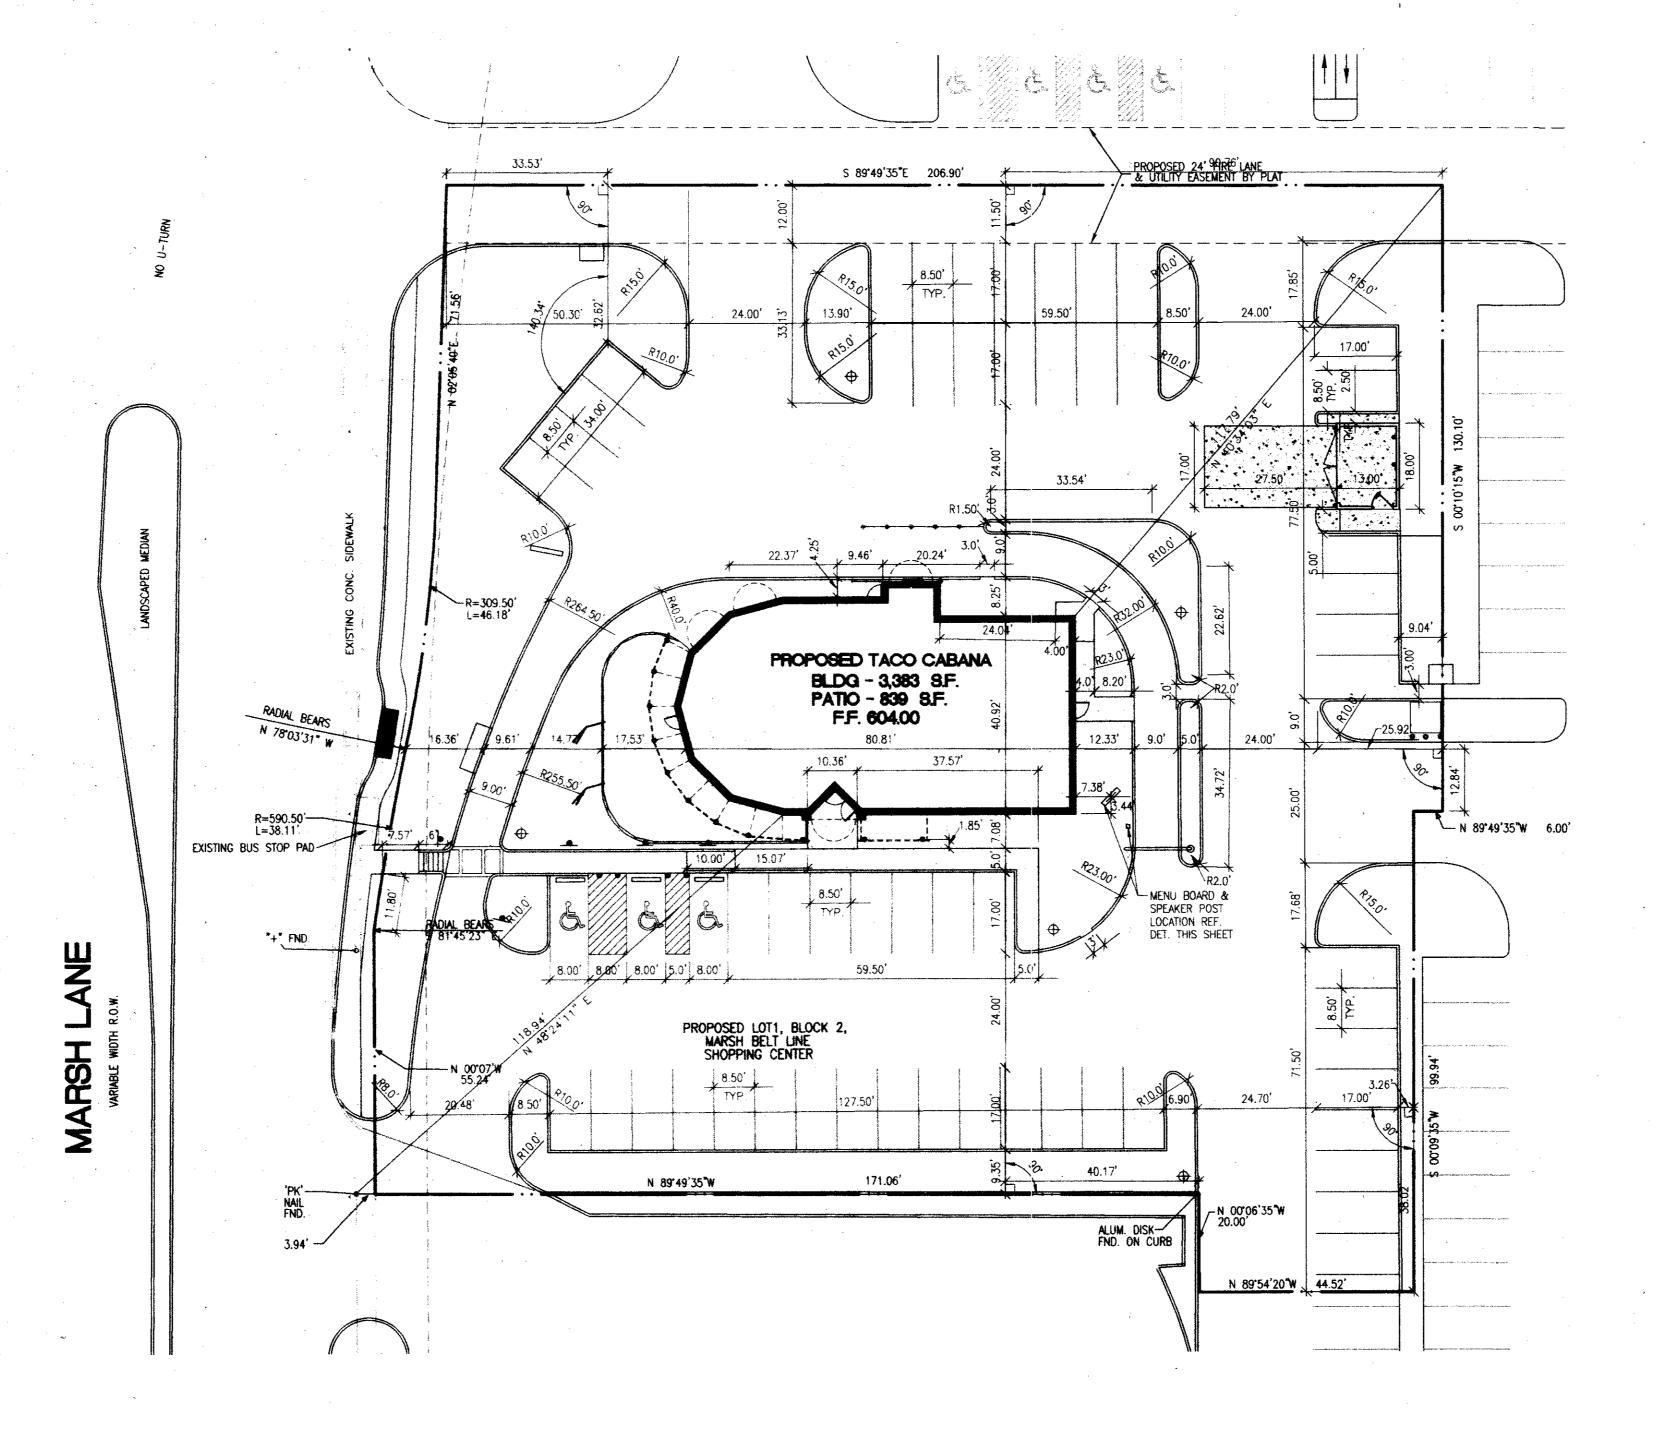


DIMENSION CONTROL NOTES

- 1 ALL DIMENSIONS ARE TAKEN TO FACE OF CURB OR BUILDING UNLESS OTHERWISE NOTED.
- 2 CONTRACTOR SHALL VERIFY DIMENSIONS AND NOTIFY ENGINEER OF ANY DISCREPANCIES.
- 3 USE DIMENSIONAL INFORMATION GIVEN. DO NOT SCALE DRAWINGS.
- 4 CONTRACTOR SHALL VERIFY EXACT LOCATIONS AND PROTECT ALL EXISTING SITE IMPROVEMENTS AND UTILITIES DURING CONSTRUCTION OPERATIONS.

PARKING SPACE DIMENSION TABLE

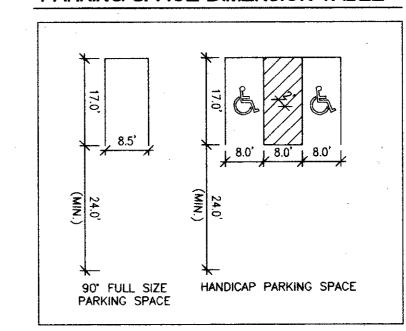

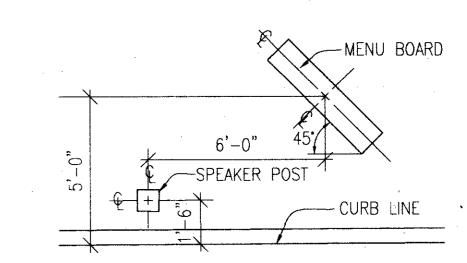

DRIVE THRU MENUBOARD AND SPEAKER LOCATION LEGEND

TOP OF GRATE INVERT FLOW LINE HIGH POINT BOTTOM OF CURB TOP OF CURB TOP OF WALL

BOC BACK OF CURB FOC FACE OF CURB RETAINING WALL

MORTAR STACK ROCK WALL --- WATER LINE --- WASTE WATER LINE - STORM SEWER LINE

FIRE HYDRANT WATER METER POWER POLE ----P--- OVERHEAD ELECTRIC + 100.00 EXISTING SPOT ELEVATION

100.00 PROPOSED SPOT ELEVATION MISC. CONCRETE PAVING ■■■■ LIMITS OF CONSTRUCTION ----- PROPERTY LINE SILT FENCE

DRAINAGE AREA DRAINAGE AREA BOUNDARY ++++++++ FILTER DIKE TREE PROTECTION FENCE

PROPOSED CONTOUR EXISTING TREE TO REMAIN

EXISTING TREE TO BE REMOVED

--- 704 --- EXISTING CONTOUR

TRAFFIC GUARD RAIL

FIRE LANE DESIGNATION + HAND RAILS


DIMENSION CONTROL PLAN AS BUILT





SHT. TACO CABANA 3801 BELT LINE ROAD 9-23-97 DRAWN BY:

THE ENGINEER ASSUMES NO RESPONSIBILITY FOR THE EXISTENCE OR LOCATION OF ANY SURFACE OR SUBSURFACE STRUCTURES. THE CONTRACTOR IS RESPONSIBLE FOR CONTACTING ALL AGENCIES AND/OR OWNERS TO VERIFY THIS INFORMATION.

ALL CONSTRUCTION MATERIALS AND TECHNIQUES SHALL CONFORM TO CURRENT TOWN OF ADDISON STANDARD SPECIFICATIONS.

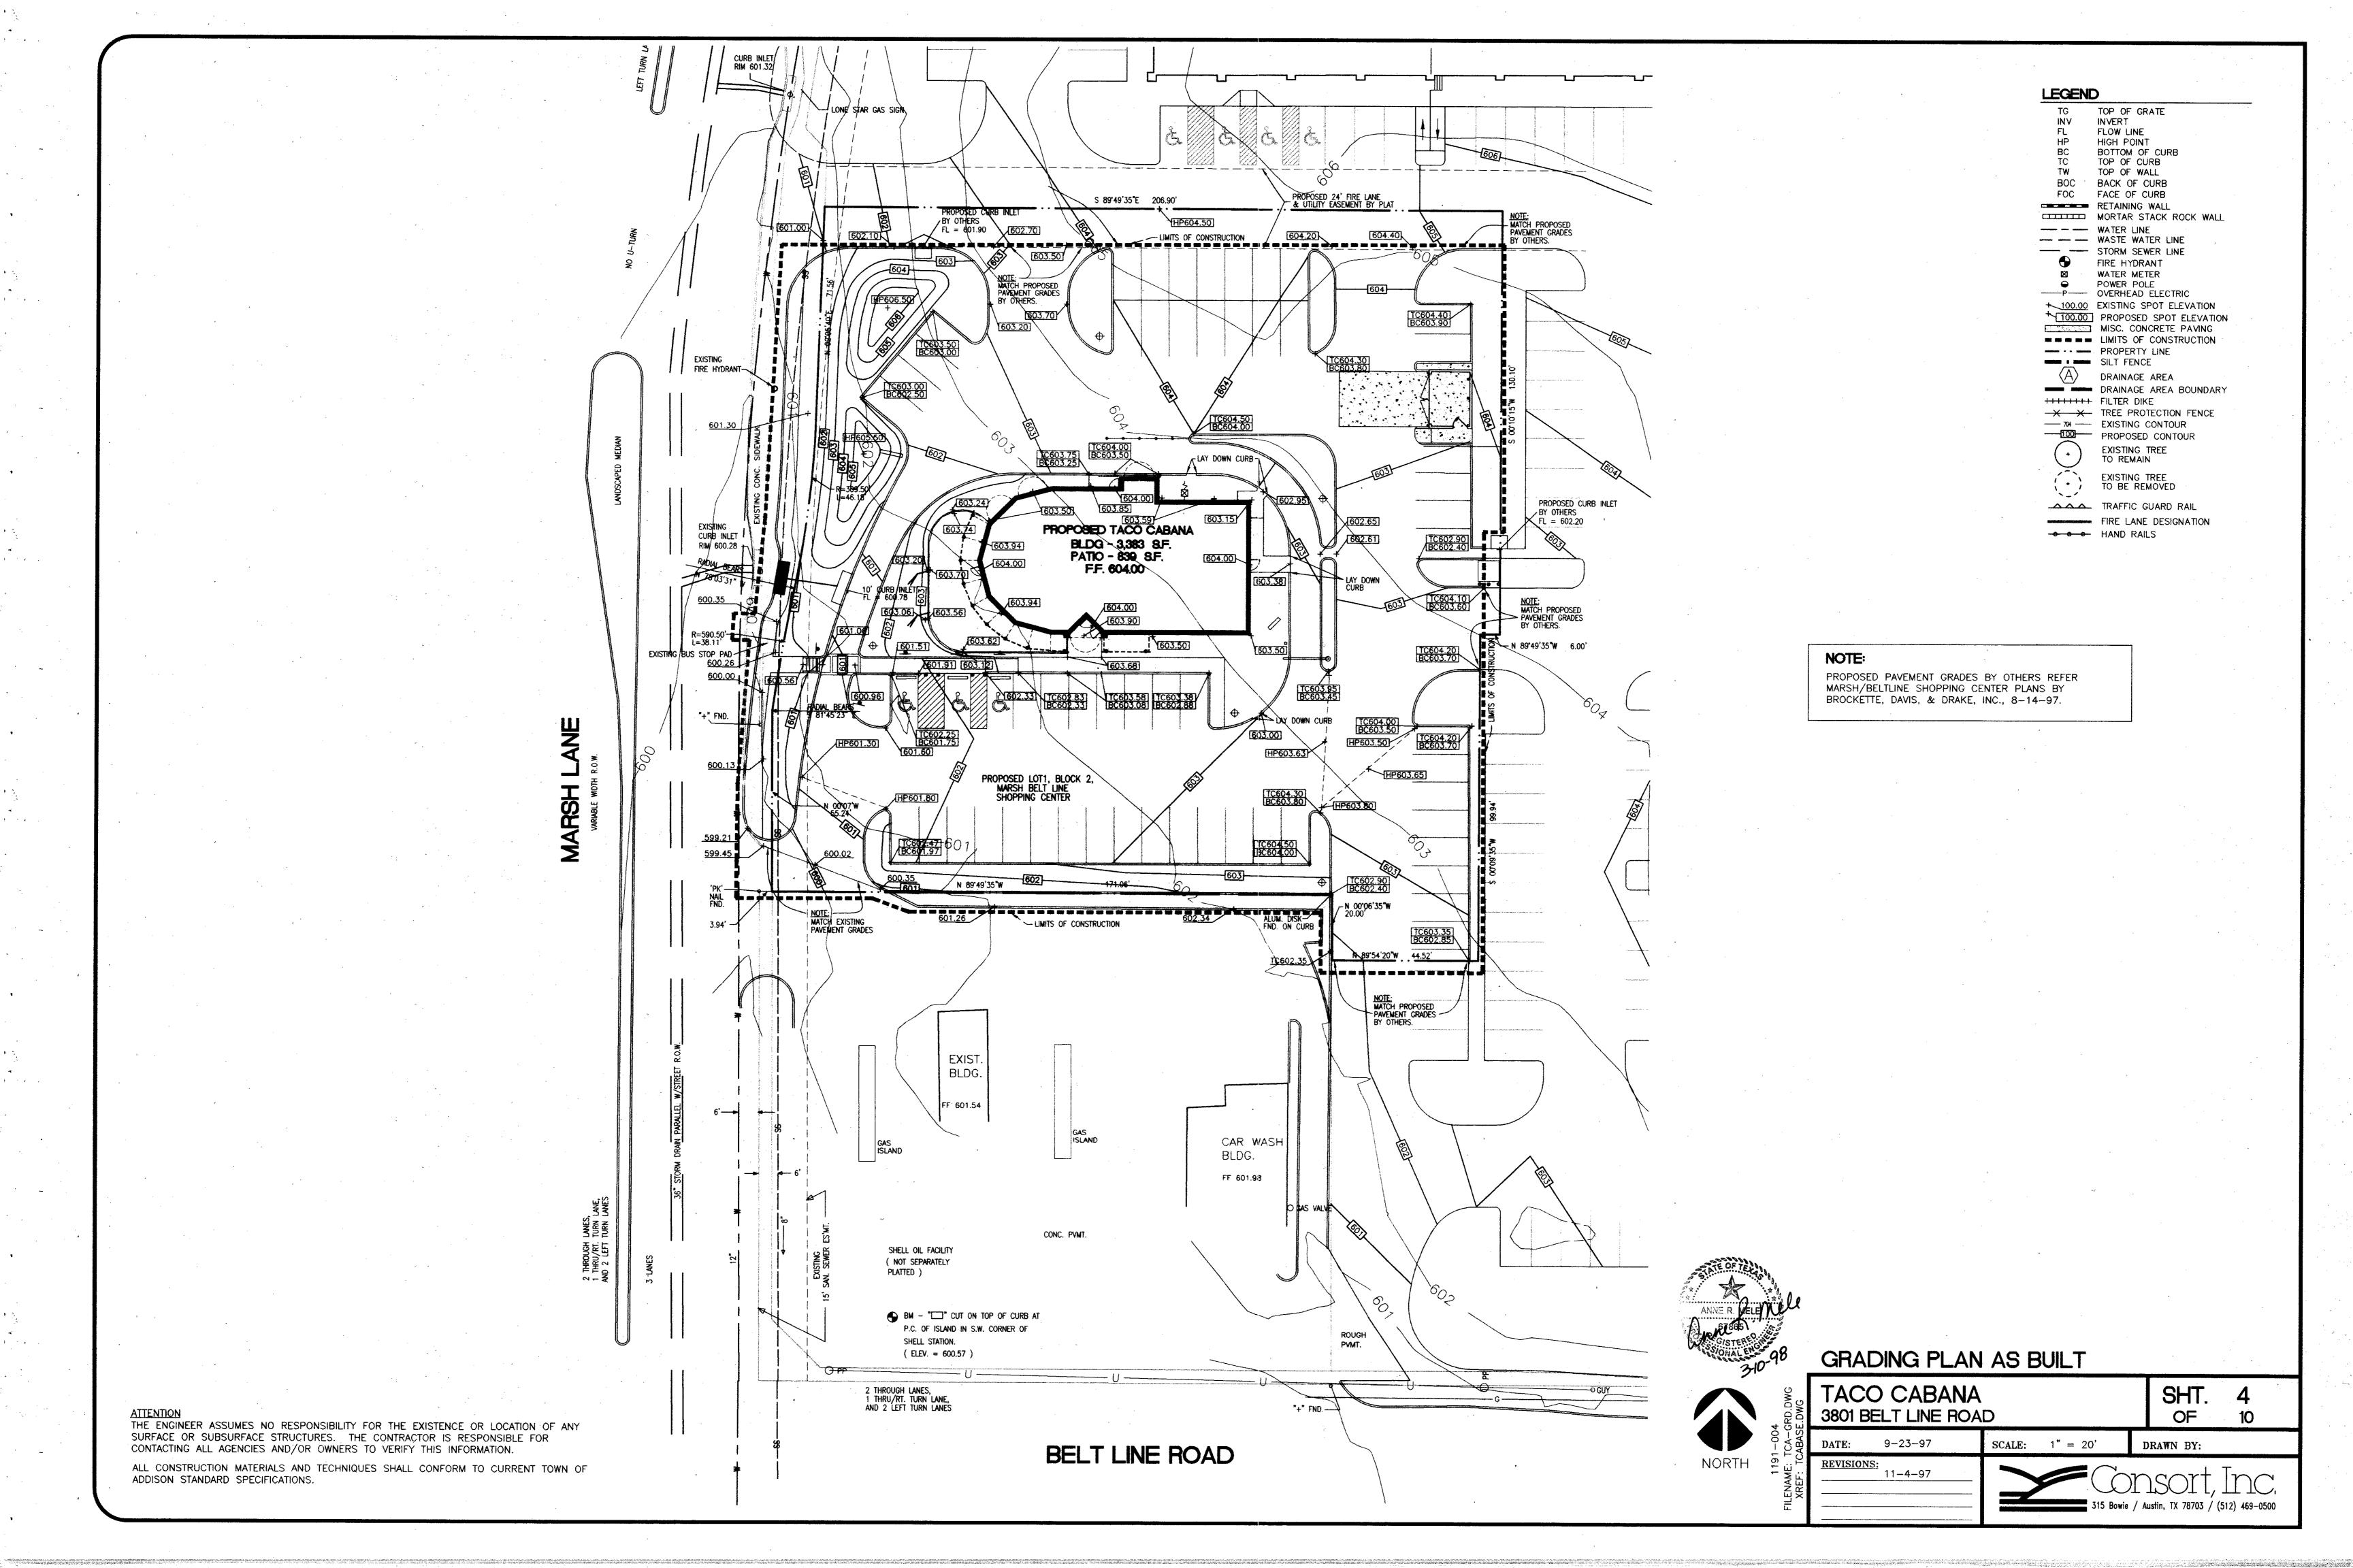

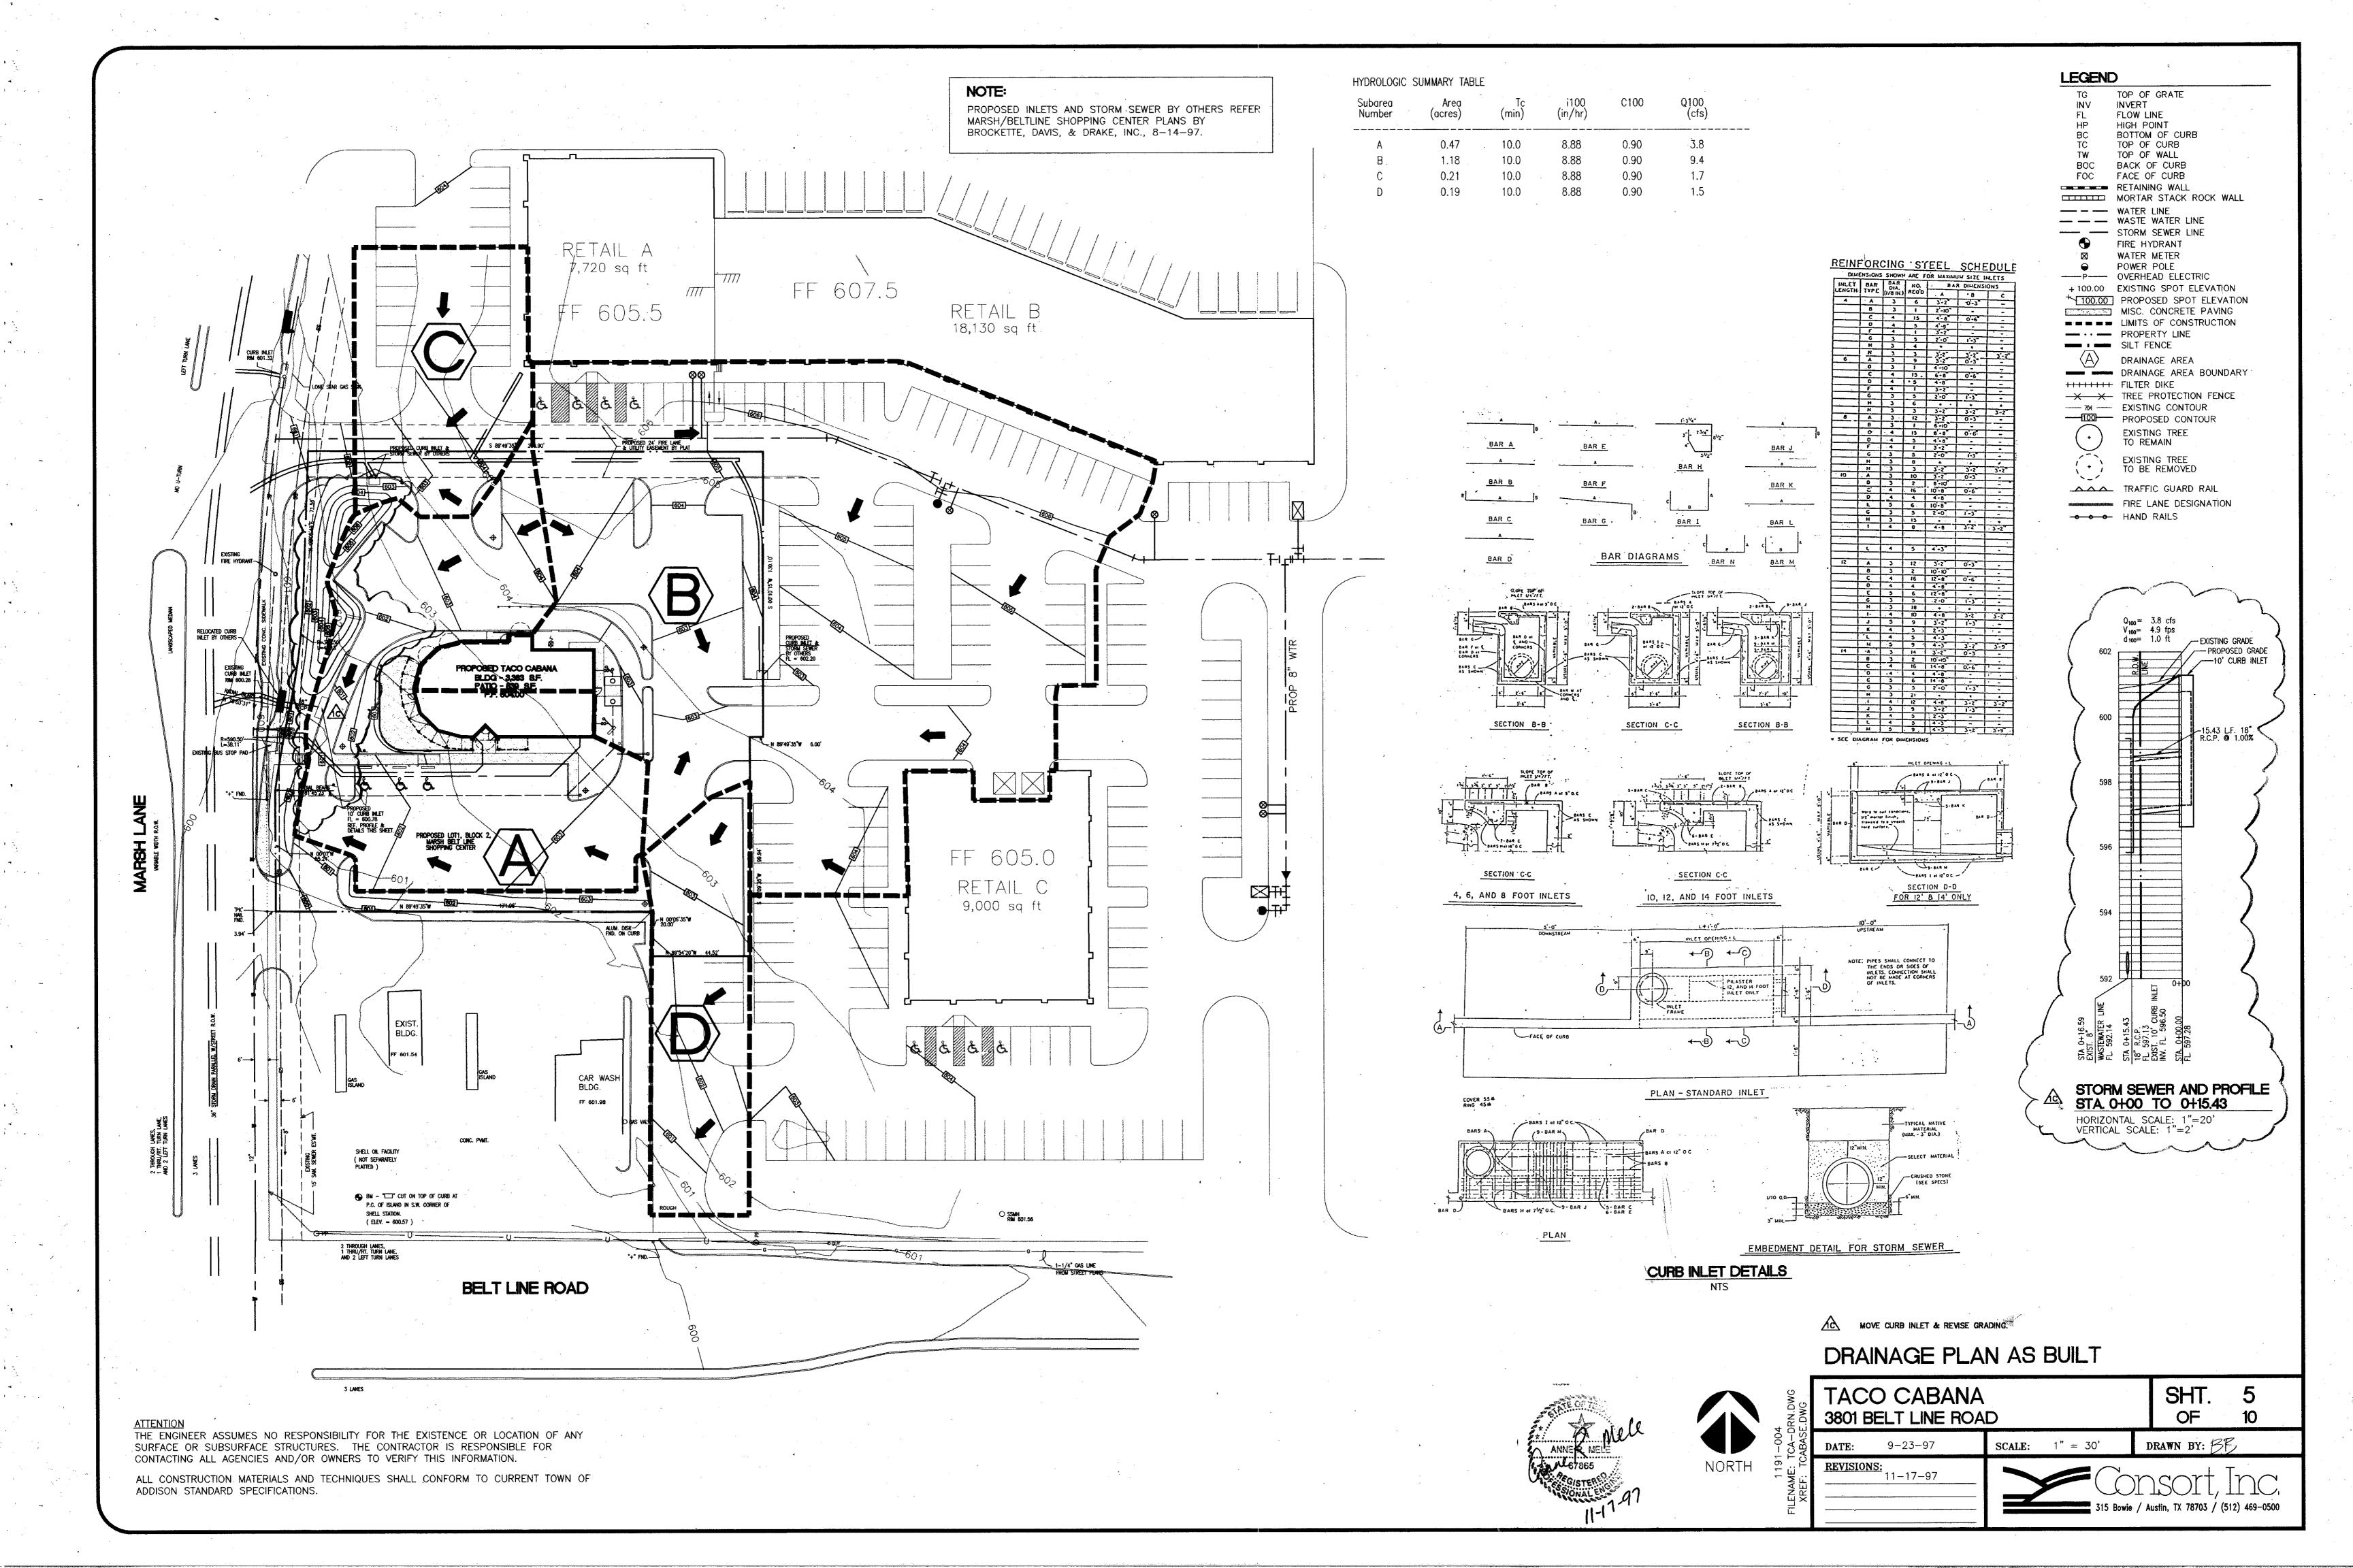

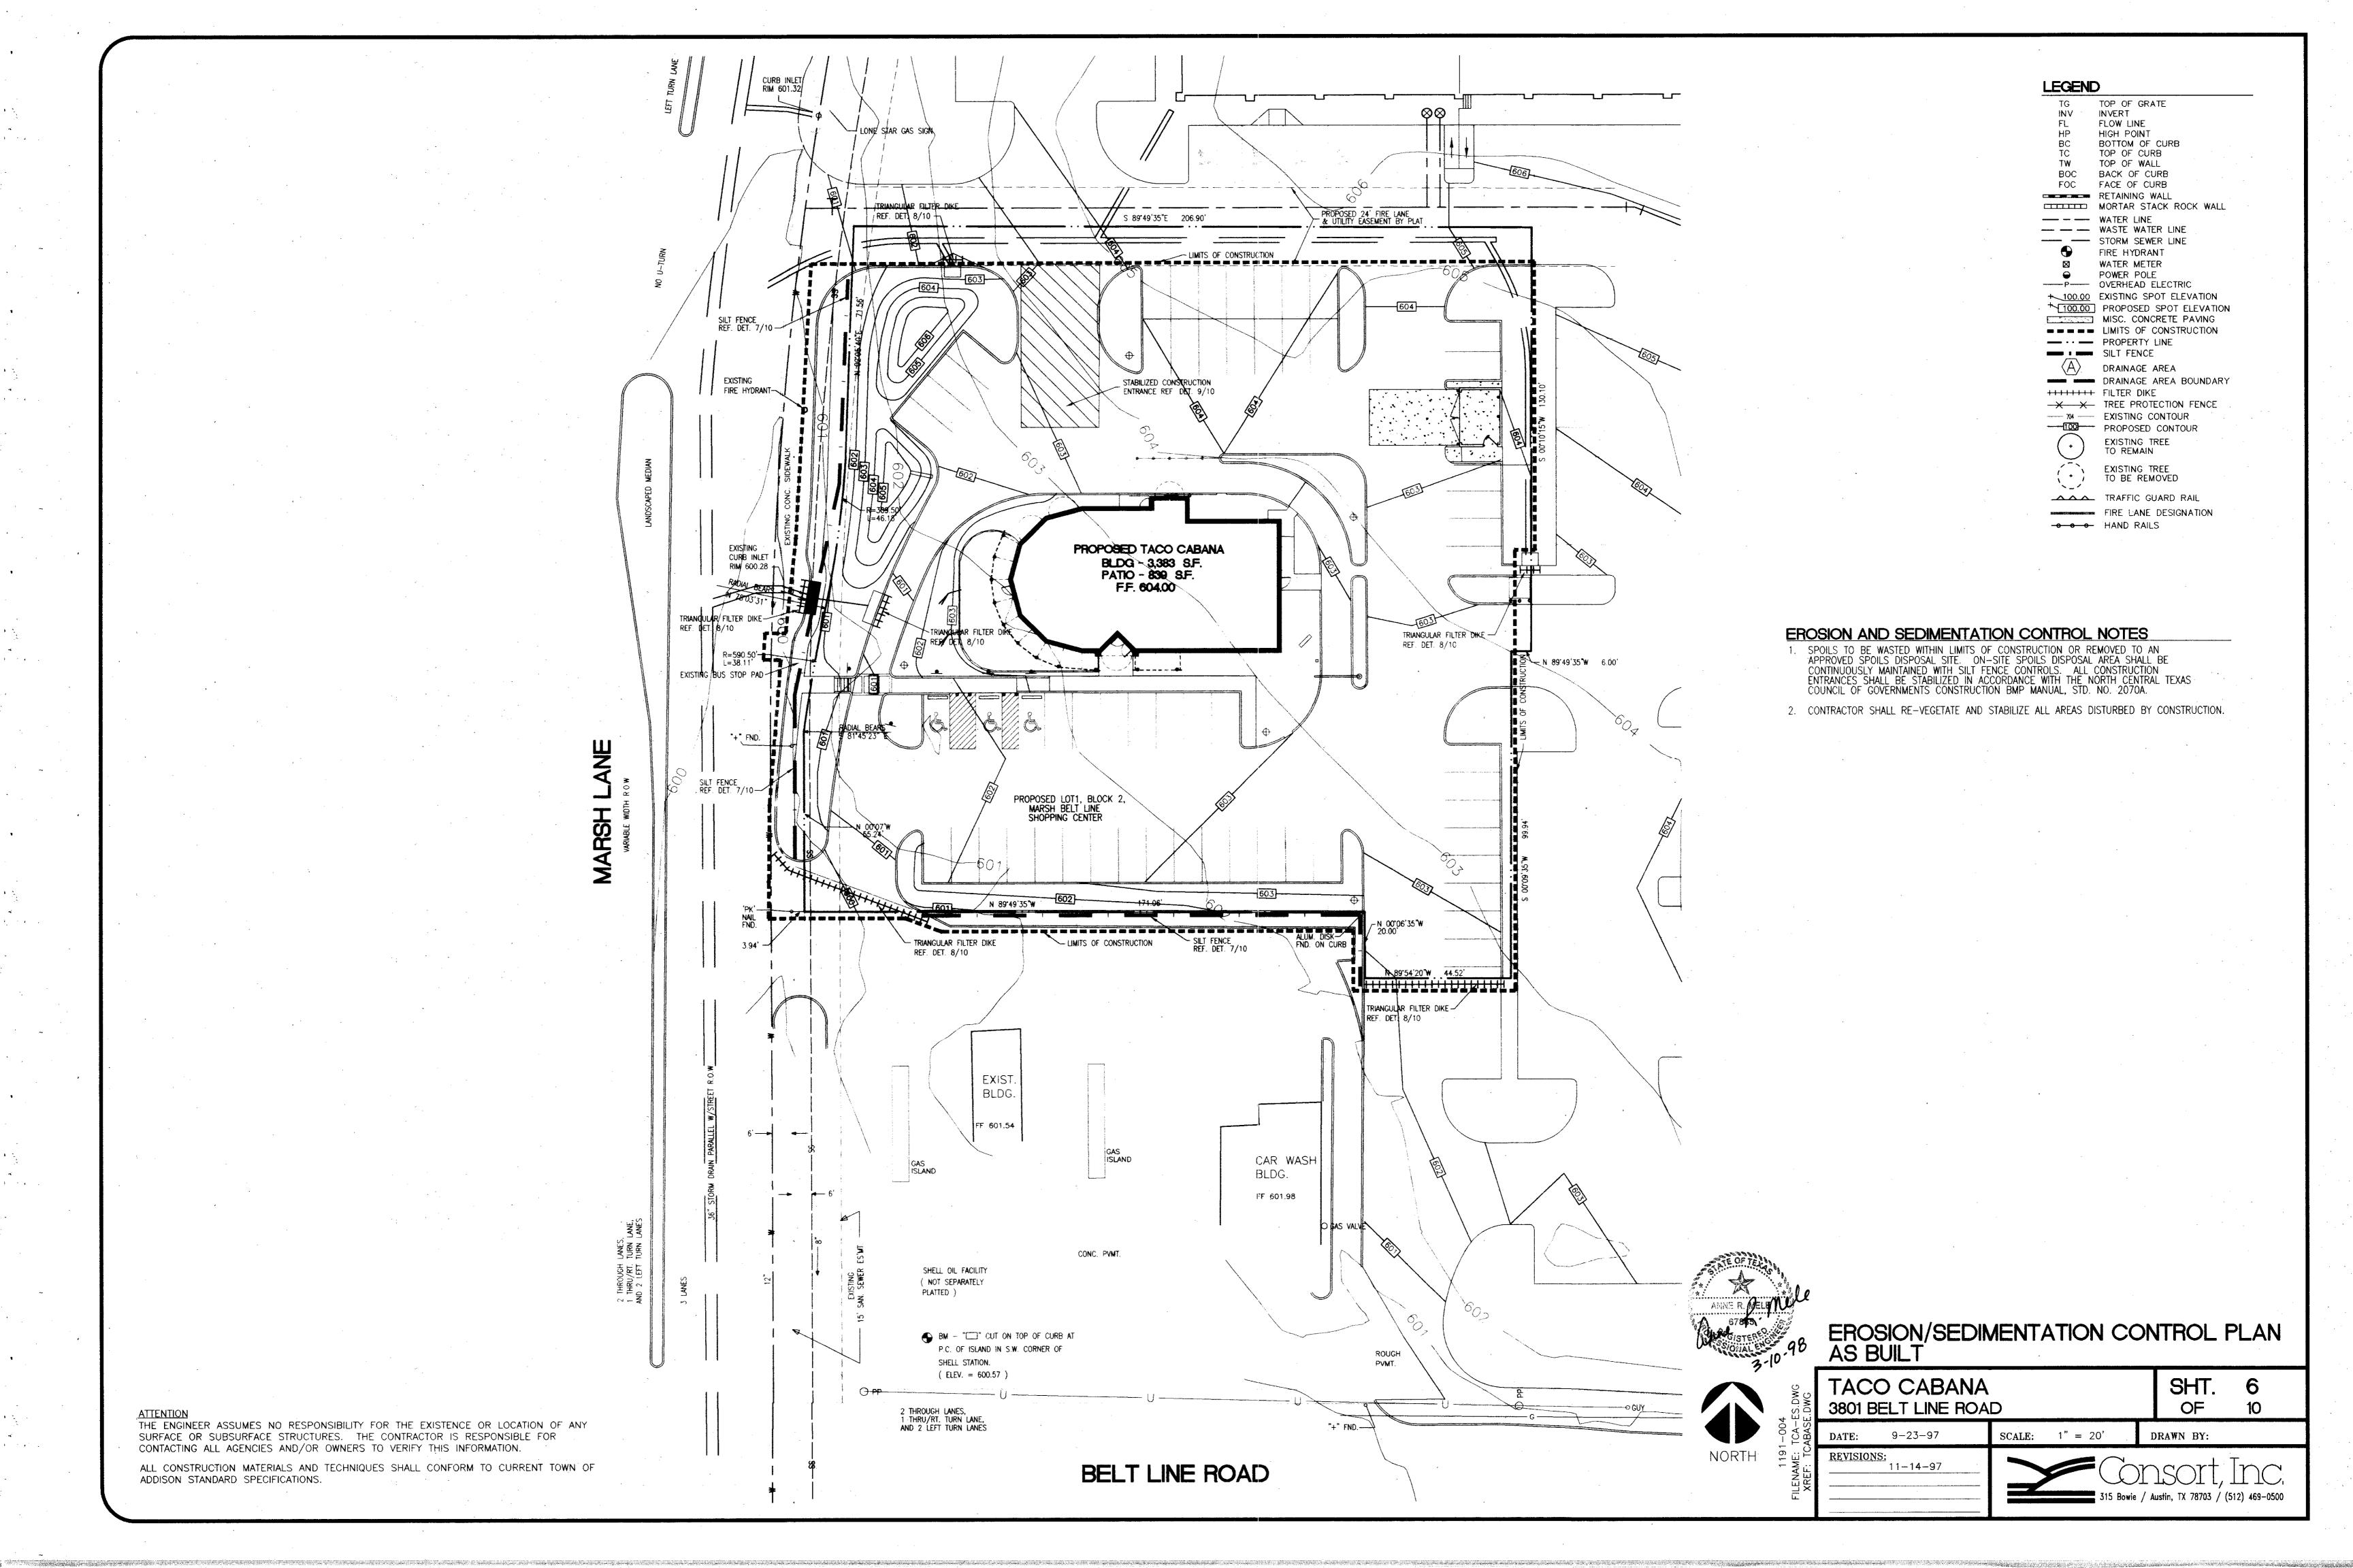

PLANT LIST SYMBOL QUAN

SYMBOL	QUAN.	BOTANICAL NAME COMMON NAME SIZE	REMARKS
	12	QUERCUS SHUMARDII RED OAK 4" CAL. MIN. 10'-12' HT.	SINGLE TRUNK; DARK GREEN; MATCHED; B&B FULL CROWN; HEALTHY
\bigcirc	6	TAXODIUM DISTICHUM BALD CYPRESS 3-1/2" CAL. MIN. 10'-12' HT.	SINGLE TRUNK; DARK GREEN; MATCHED; B&B FULL CROWN; HEALTHY; UPRIGHT
	. 2	ULMUS CRASSIFOLIA CEDAR ELM 3" CAL. MIN. 10'-12' HT.	SINGLE TRUNK; DARK GREEN; MATCHED; B&B FULL CROWN; HEALTHY
 *	5	CHAMAEROPS HUMILIS MEDITERRANEAN FAN PALM 8'-10' HT.	MULIT TRUNK; 3 TRUNKS MIN.; DARK GREEN; MATCHED; B&B FULL CROWN; HEALTHY
\Diamond	.2	SOPHORA SECUNDIFLORA TEXAS MOUNTAIN LAUREL 4-6' HT. MIN.	FULL; HEALTHY; DARK GREEN; B&B PLANT AS SHOWN 3-5 CANES MIN.
	12	RAPHIOLEPIS INDICA 'MAJESTIC BEAUTY' MAJESTIC BEAUTY INDIAN HAWTHORNE 10 GAL. 16" HT. MIN. 14" SPREAD MIN.	DARK GREEN; FULL; HEALTHY; MATCHED; PLANT 4'-0" O.C.
O	45	RAPHIOLEPIS INDICA 'CLARA' CLARA INDIAN HAWTHORN 5 GAL. 16" HT. MIN. 14" SPREAD MIN.	DARK GREEN; FULL; HEALTHY; MATCHED; PLANT 3'-0" O.C.
	47	ILEX VOMITORIA 'NANA' DWARF YOUPON HOLLY 5 GAL. 16" HT. MIN. 16" SPREAD MIN.	DARK GREEN; FULL; HEALTHY; MATCHED; PLANT 2'-6" O.C.
€	5	YUCCA RECURVIFOLIA YUCCA PENDULA 5 GAL 16" HT. MIN.	DARK GREEN; FULL; HEALTHY; MATCHED; PLANT AS SHOWN
\odot	. 1	MYRICA CERIFERA WAX MYRTLE 10 GAL 4' HT. MIN.	DARK GREEN; FULL; HEALTHY; MATCHED; PLANT AS SHOWN
	126	ILEX CORNUTA 'BURFORDII' BURFORD HOLLY 5 GAL: 18" HT. MIN. AT PLANTING TIME	DARK GREEN; FULL; HEALTHY; MATCHED; PLANT 3'-0" O.C.
\oslash	7	JUNIPERUS CHINENSIS 'SEA GREEN' SEA GREEN JUNIPER 5 GAL 2' HT. MIN., 2' SPREAD MIN.	DARK GREEN; FULL; HEALTHY; MATCHED; PLANT 3'-0" O.C.
	60	LIRIOPE MUSCARI GIANT LIRIOPE 1 GAL	DARK GREEN; FULL; HEALTHY; MATCHED; PLANT 12" O.C.
	246	SEASONAL COLOR REFER TABLE THIS SHEET	HEALTHY; FULL PLANT ACCORDING TO TABLE
		CYNODEN DACTOLYN BERMUDA SOLID SOD	DARK GREEN; FULL; HEALTHY;

SEASONAL COLOR

BOTANICA	۱L	NAME
COMMON	N	AME


COMMON NAME SIZE	PLANT	BLOOM	REMARKS
MOLA SPP. PANSY 4" POTS	NOV.1- JAN. 10	WINTER	FULL BLOOM RED AND WHITE VARIETIES, 6" O.C.
ANTIRRHINUM MAJUS SNAPDRAGON 4" POTS	FEB.10- MAR. 10	SPRING/ EARLY SUMMER	FULL BLOOM RED AND WHITE VARIETIES, 6" O.C.
BEGONIA SEMPERFLORENS WAX LEAF BEGONIA 4" POTS	APRIL 15- MAY 30	SUMMER/ FALL:	FULL BLOOM RED AND WHITE VARIETIES, 6" O.C.

LANDSCAPE CALCULATIONS

# .	REQUIRED	PROVIDED
TOTAL LOT AREA	N/A	45,460 S.F. (1.0436 AC.)
TOTAL LANDSCAPE AREA.	9,092 S.F. (20%)	10,722 S.F. (24%)

ATTENTION
THE ENGINEER ASSUMES NO RESPONSIBILITY FOR THE EXISTENCE OR LOCATION OF ANY SURFACE OR SUBSURFACE STRUCTURES. THE CONTRACTOR IS RESPONSIBLE FOR CONTACTING ALL AGENCIES AND/OR OWNERS TO VERIFY THIS INFORMATION.

ALL CONSTRUCTION MATERIALS AND TECHNIQUES SHALL CONFORM TO CURRENT TOWN OF ADDISON STANDARD SPECIFICATIONS.

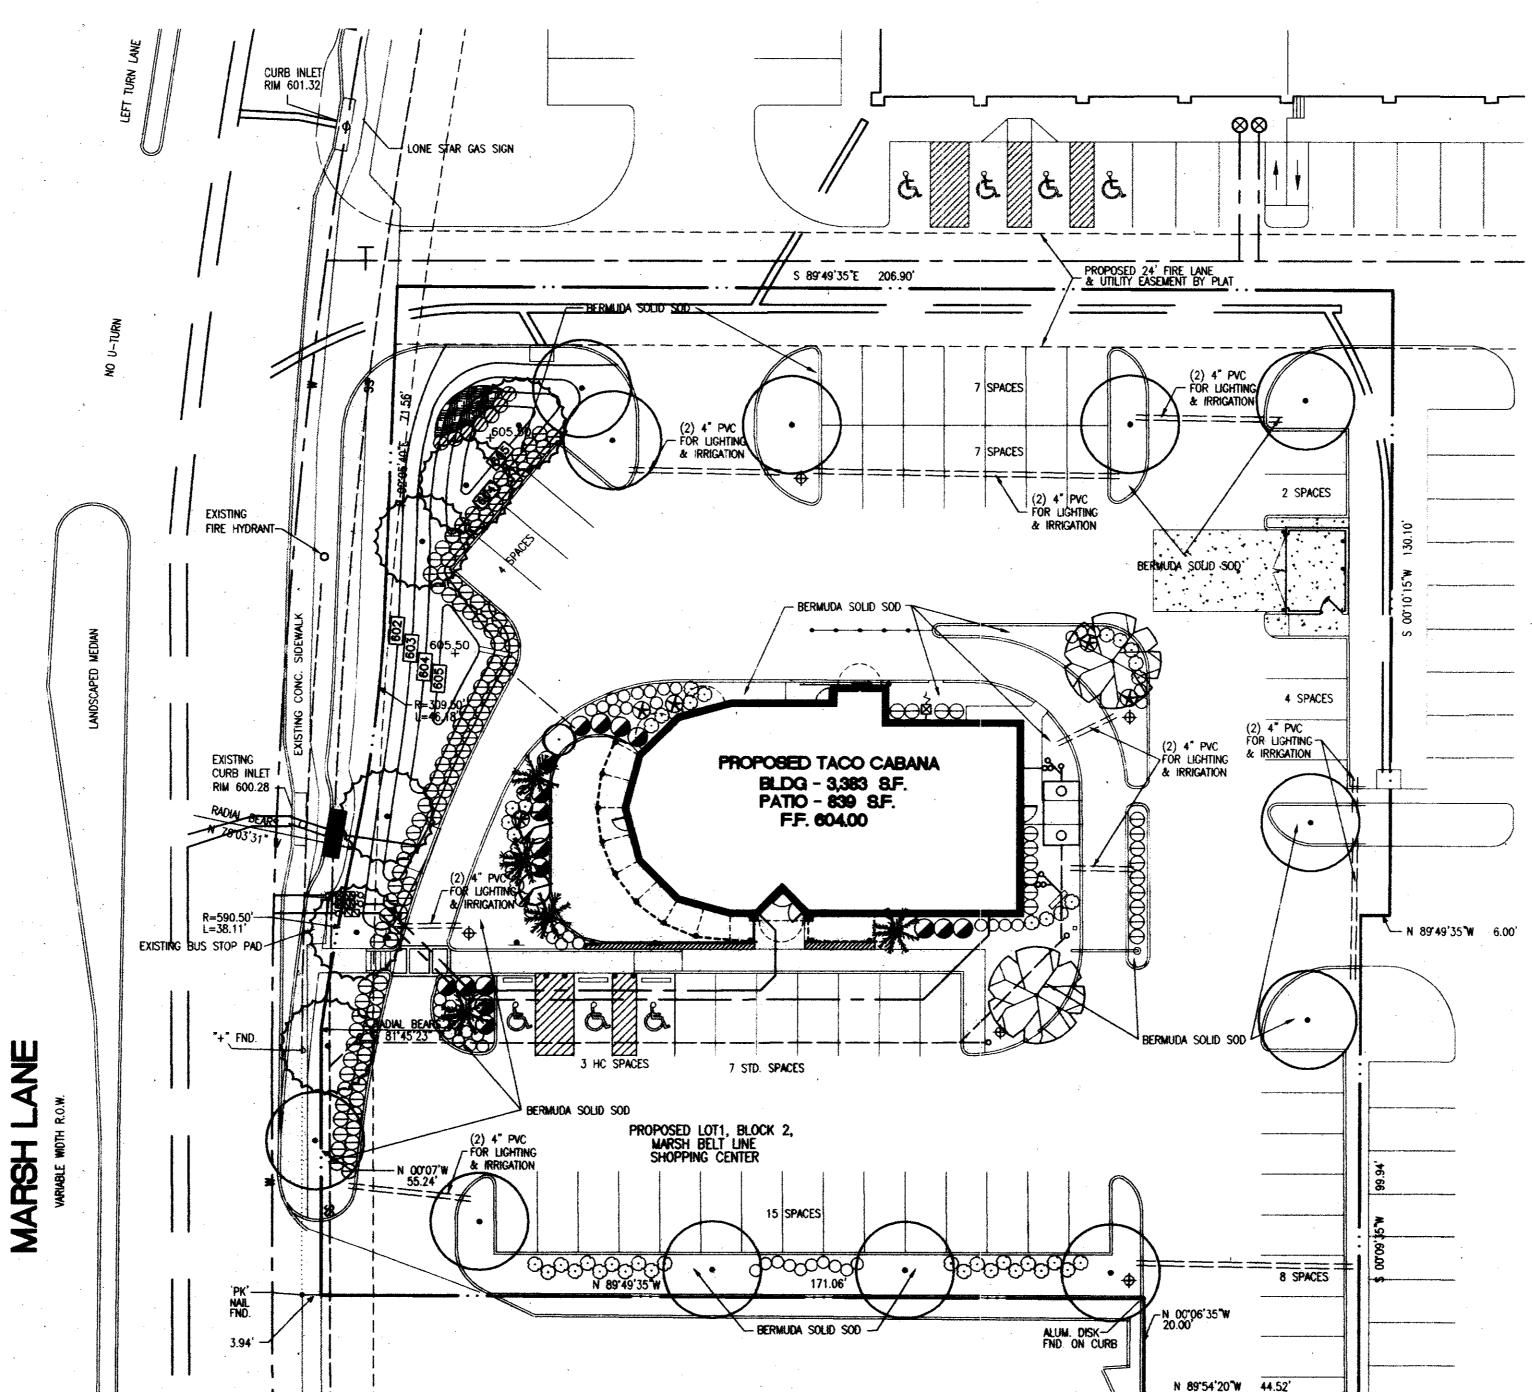

LANDSCAPE NOTES

- Refer to drawings in this set.
- 2. The General Contractor is responsible for grading all landscape areas four inches below required finish grades. General Contractor shall rake all landscape areas prior to addition of topsoil in those areas and is responsible for removal of all construction debris. Landscape contractor shall remove all rocks, clods and other material greater than one inch in diameter. Landscape contractor shall remove all noxious weeds and other plant material not shown in landscape plan. Landscape contractor shall provide all topsoil and other amendments to bring to finish grade. The Landscape contractor shall revise grades to ensure smooth transitions between planting beds and lawn areas.
- Examine finish surface, grades, topsoil quality and depth.
 Do not start any work until unsatisfactory conditions have been corrected. Verify limits of work before starting.
- Contractor to repair all damages to existing conditions and is responsible for satisfactory performance.
- Contractor shall maintain positive drainage in lawn areas and fine grade lawn areas to provide a smooth and continual grade free of irregularities or depressions.
- 6. All plant masses to be contained within a mulch bed.
- Plant Material: All plants shall be healthy and vigorous and representative of the species specified. All plants shall be well branched, proportioned, free of all insects, diseases, bark bruises, scrapes, cracked branches and physical damage.
- 8. Contractor shall guarantee all plant material including turf to be alive and be in a healthy, vigorous condition for a period of one year from the date of completion of the entire project or other date(s) established by the Landscape Architect, except as may result from neglect or damage by the owner, damage by others or unusual phenomena beyond the contractors control.
- 9. Contractor shall replace all dead, unhealthy, and plant materials that have partially died pursuant to the condition of the warranty at no expense to the owner. Re-warrant replacement plants for an additional one year under the same terms as the original warranty. Plant materials used for replacement shall be the same species,
- Planting Period: Execute all lawnwork and planting prior to request for Certificate of Occupancy or as otherwise directed by the owner.
- 11. Installation of plant material shall be in accordance with the American Association of Nurserymen landscape standards, with the general planting specifications as set forth by the City of Austin and with these plans.
- 12. The branches of deciduous trees and shrubs may be selectively thinned by up to 1/3 in accordance with good horticultural practice; however, in no case shall trimming result in reducing the overall size of the plant below that specified.
- Contractor to familiarize himself with all underground utilities.
 Contractor to notify Consort, Inc. of any underground obstructions and receive approval if necessary to move plants from locations shown on plans.
- 14. Landscape materials shall be located so as not to obstruct visual or physical access to fire hydrants. Locate all landscape materials in conformance with utility company requirements at transformers, meters, overhead lines, etc. See utilities plan.
- Remove all excess organic material from the site and dispose of it in conformance with all local, state and federal requirements.
- Fertilize all plant areas according to good horticultural practice for each plant type and soil condition.
- 17. The General Contractor is responsible for existing tree removal.
- Fill all new ground cover and shrub beds within limits of construction with mulch three inches deep. Refer mulch specification below.
- 19. Quantities shown are intended to assist contractors in evaluating their own take offs and are not guaranteed as accurate representations of required materials. The contractor shall be responsible for his bid quantities and is required to reflect the design intent with full landscape beds according to specifications.
- Coordinate landscape installation with installation of underground sprinkler system.
- Where proposed tree locations occur under existing overhead utilities or crowd existing trees notify the Landscape Architect to adjust tree locations.
- 22. Contractor shall provide steel edging at all locations where shrub beds meet
- 23. Specification Topsoil: Clean, fertile, friable natural loam free of stones and lumps (over 1" diameter), clay weeds, weed seeds, sticks, caliche, plants, debris and substances which will be harmful to plants, characteristic of productive soils in the vicinity and from one site only.
- 24. Specification Steel Edging: 1/8" gauge x 4" painted steel edging free from rust with steel stakes spaced at 4' O.C. and at butt intersections and no further than 6" from ends, with interlocking end configuration and integral deformations to hold stakes.
- 25. Specification Mulch; Fine grind hardwood mulch by "Living Earth" (shredded) or equivalent approved by Landscape Architect.
- Specification Backfill Mixture: 75% topsoil with 25% compost as manufactured by "Back to Earth, Inc.", Dallas, Texas or equal approved in advance by Landscape Architect.
- 27. An automatic irrigation system must be provided. The irrigation system must provide 100% coverage with turf zones separated from shrub planting zones, reflect the landscape design and distribute appropriate amounts of water to each specified plant type. Contractor will submit shop drawings to the design Landscape Architect for review prior to installation. Refer irrigation guidelines this sheet.
- 28. The landscape contractor is responsible for all landscape maintenance and weed control until a maintenance contract is awarded by the owner.
- 29. All areas between property line and adjoining streets shall be moved.

LEGEND

INV INVERT
FL FLOW LINE
HP HIGH POINT
BC BOTTOM OF CURB
TC TOP OF CURB
TW TOP OF WALL
BOC BACK OF CURB
FOC FACE OF CURB
RETAINING WALL
MORTAR STACK ROCK WALL
— — WATER LINE
— — WASTE WATER LINE
— — STORM SEWER LINE

TOP OF GRATE

FIRE HYDRANT

WATER METER

POWER POLE

OVERHEAD ELECTRIC

+ 100.00 EXISTING SPOT ELEVATION

TOO.00 PROPOSED SPOT ELEVATION

MISC. CONCRETE PAVING

LIMITS OF CONSTRUCTION

PROPERTY LINE

SILT FENCE

DRAINAGE AREA

DRAINAGE AREA BOUNDARY

FILTER DIKE

TREE PROTECTION FENCE

TREE PROTECTION FEI

EXISTING CONTOUR
PROPOSED CONTOUR

EXISTING TREE
TO REMAIN

TRAFFIC GUARD RAIL
FIRE LANE DESIGNATION


- HAND RAILS

EXISTING TREE

IRRIGATION NOTES

Automatic irrigation systems shall comply with the following guidelines. These guidelines (1-7) shall be noted on the Site Development Permit (refer to Appendix 0) and shall be implemented as part of the landscape inspection:

- Adjustable flow controls shall be required on circuit remote control valves.
 Pressure regulation component(s) shall be required where static pressure exceeds manufacturer's recommended operating range.
- Valves and circuits shall be separated based on water use, so that turf areas can be watered separately from shrub and ground cover areas.
- Sprinkler heads shall have matched precipitation rates within each control valve circuit.
- 4. Serviceable check valves shall be required where elevation differential may cause low head drainage adjacent to paving areas.
- 5. Sprinkler head spacing shall be designed for head—to—head coverage or heads shall be spaced as per manufacturer's recommendations and adjusted for prevailing winds. The system shall be designed for minimum run—off and minimum overspray onto non—irrigated areas, (i.e. paving and structures).
- 6. All automatic irrigation systems shall be equipped with a controller capable of dual or multiple programming. Controllers shall have multiple cycle start capacity and a flexible calendar program, including the capability of being set to water every five days. All automation irrigation systems shall be equipped with a rain sensor shut-off device.
- 7. All irrigation systems shall be equipped with a freeze sensor.

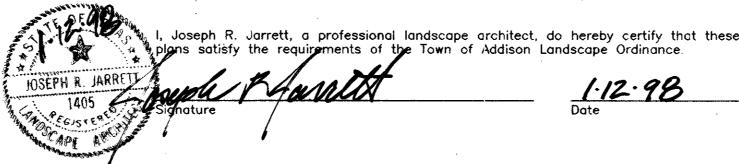





TACO CABANA
3801 BELT LINE ROAD

SCALE: 1" = 20'


OF 10
DRAWN BY: BB

SHT.

9-23-97 SCALE: 1" = 20' DRAWN BY: BB

ONS:
11-14-97
1-12-98
315 Bowie / Austin, TX 78703 / (512) 469-05

nse ND

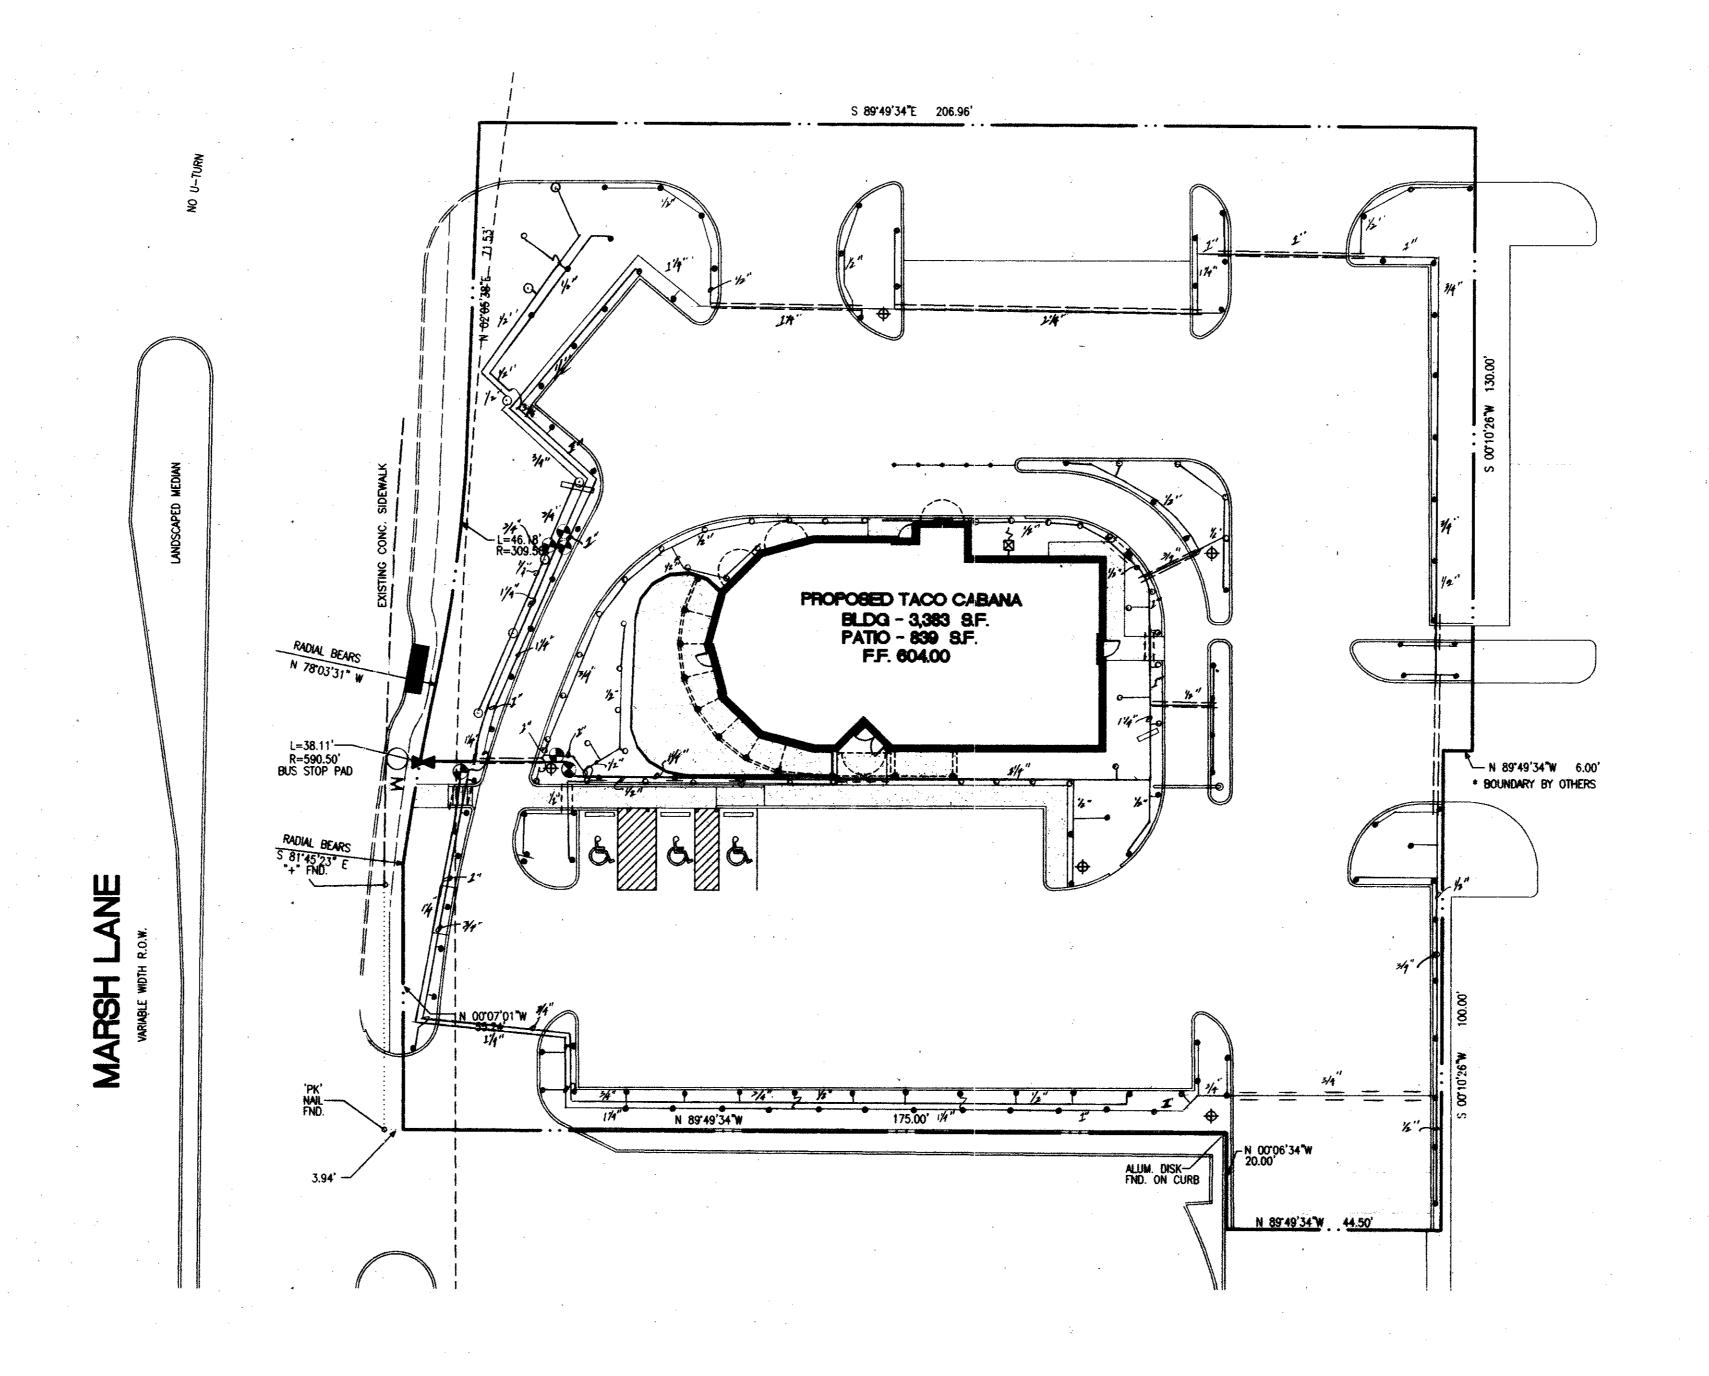

LEGEND


- IRRITROL HS4 POP UP SPRAY HEADS
- O IRRITROL HS12 POP UP SPRAY HEADS
- RAINBIRD R50 ROTARY HEADS
- RAIN BIRD 100 DV ELECTRIC VALVES
- WILKINS DOUBLE CHECK VALVE ASSEMBLY --- PVC SDR-21 PIPE


IRRIGATION PLAN AS BUILT


TACO CABANA 3801 BELT LINE ROAD SHT. OF DRAWN BY:



SCALE: 1" = 20' DATE: 9-23-97 **REVISIONS:**

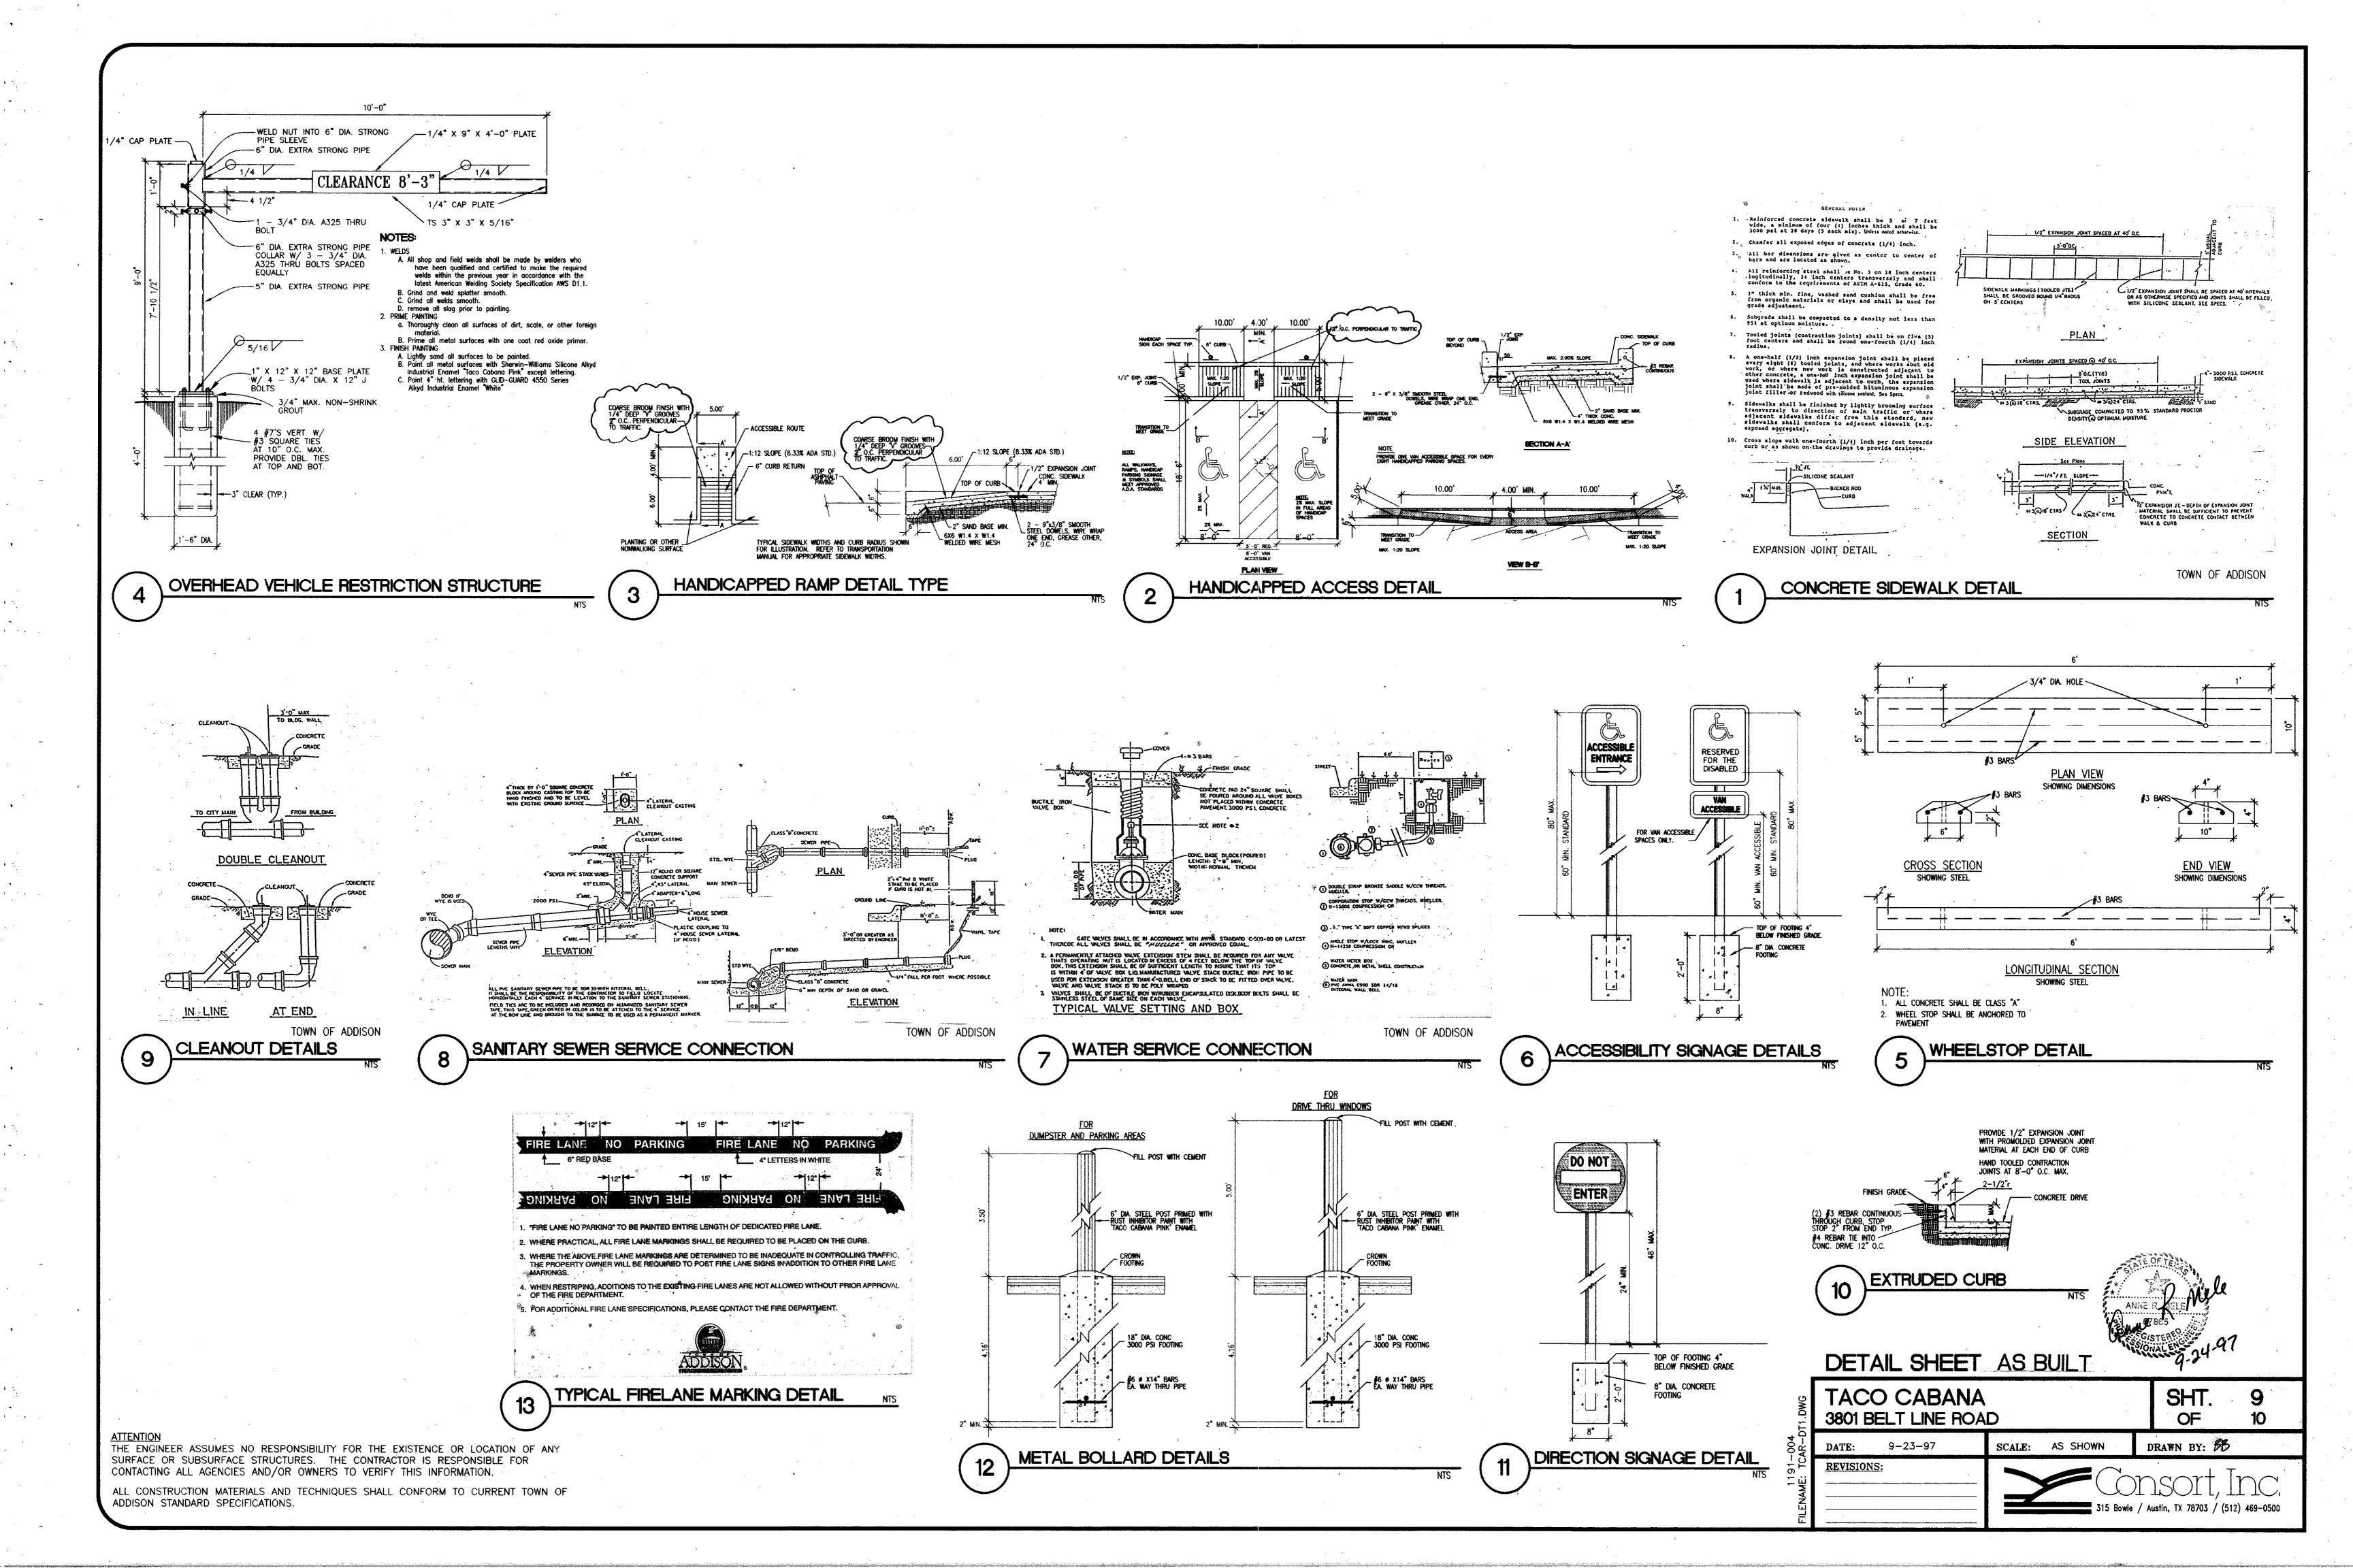

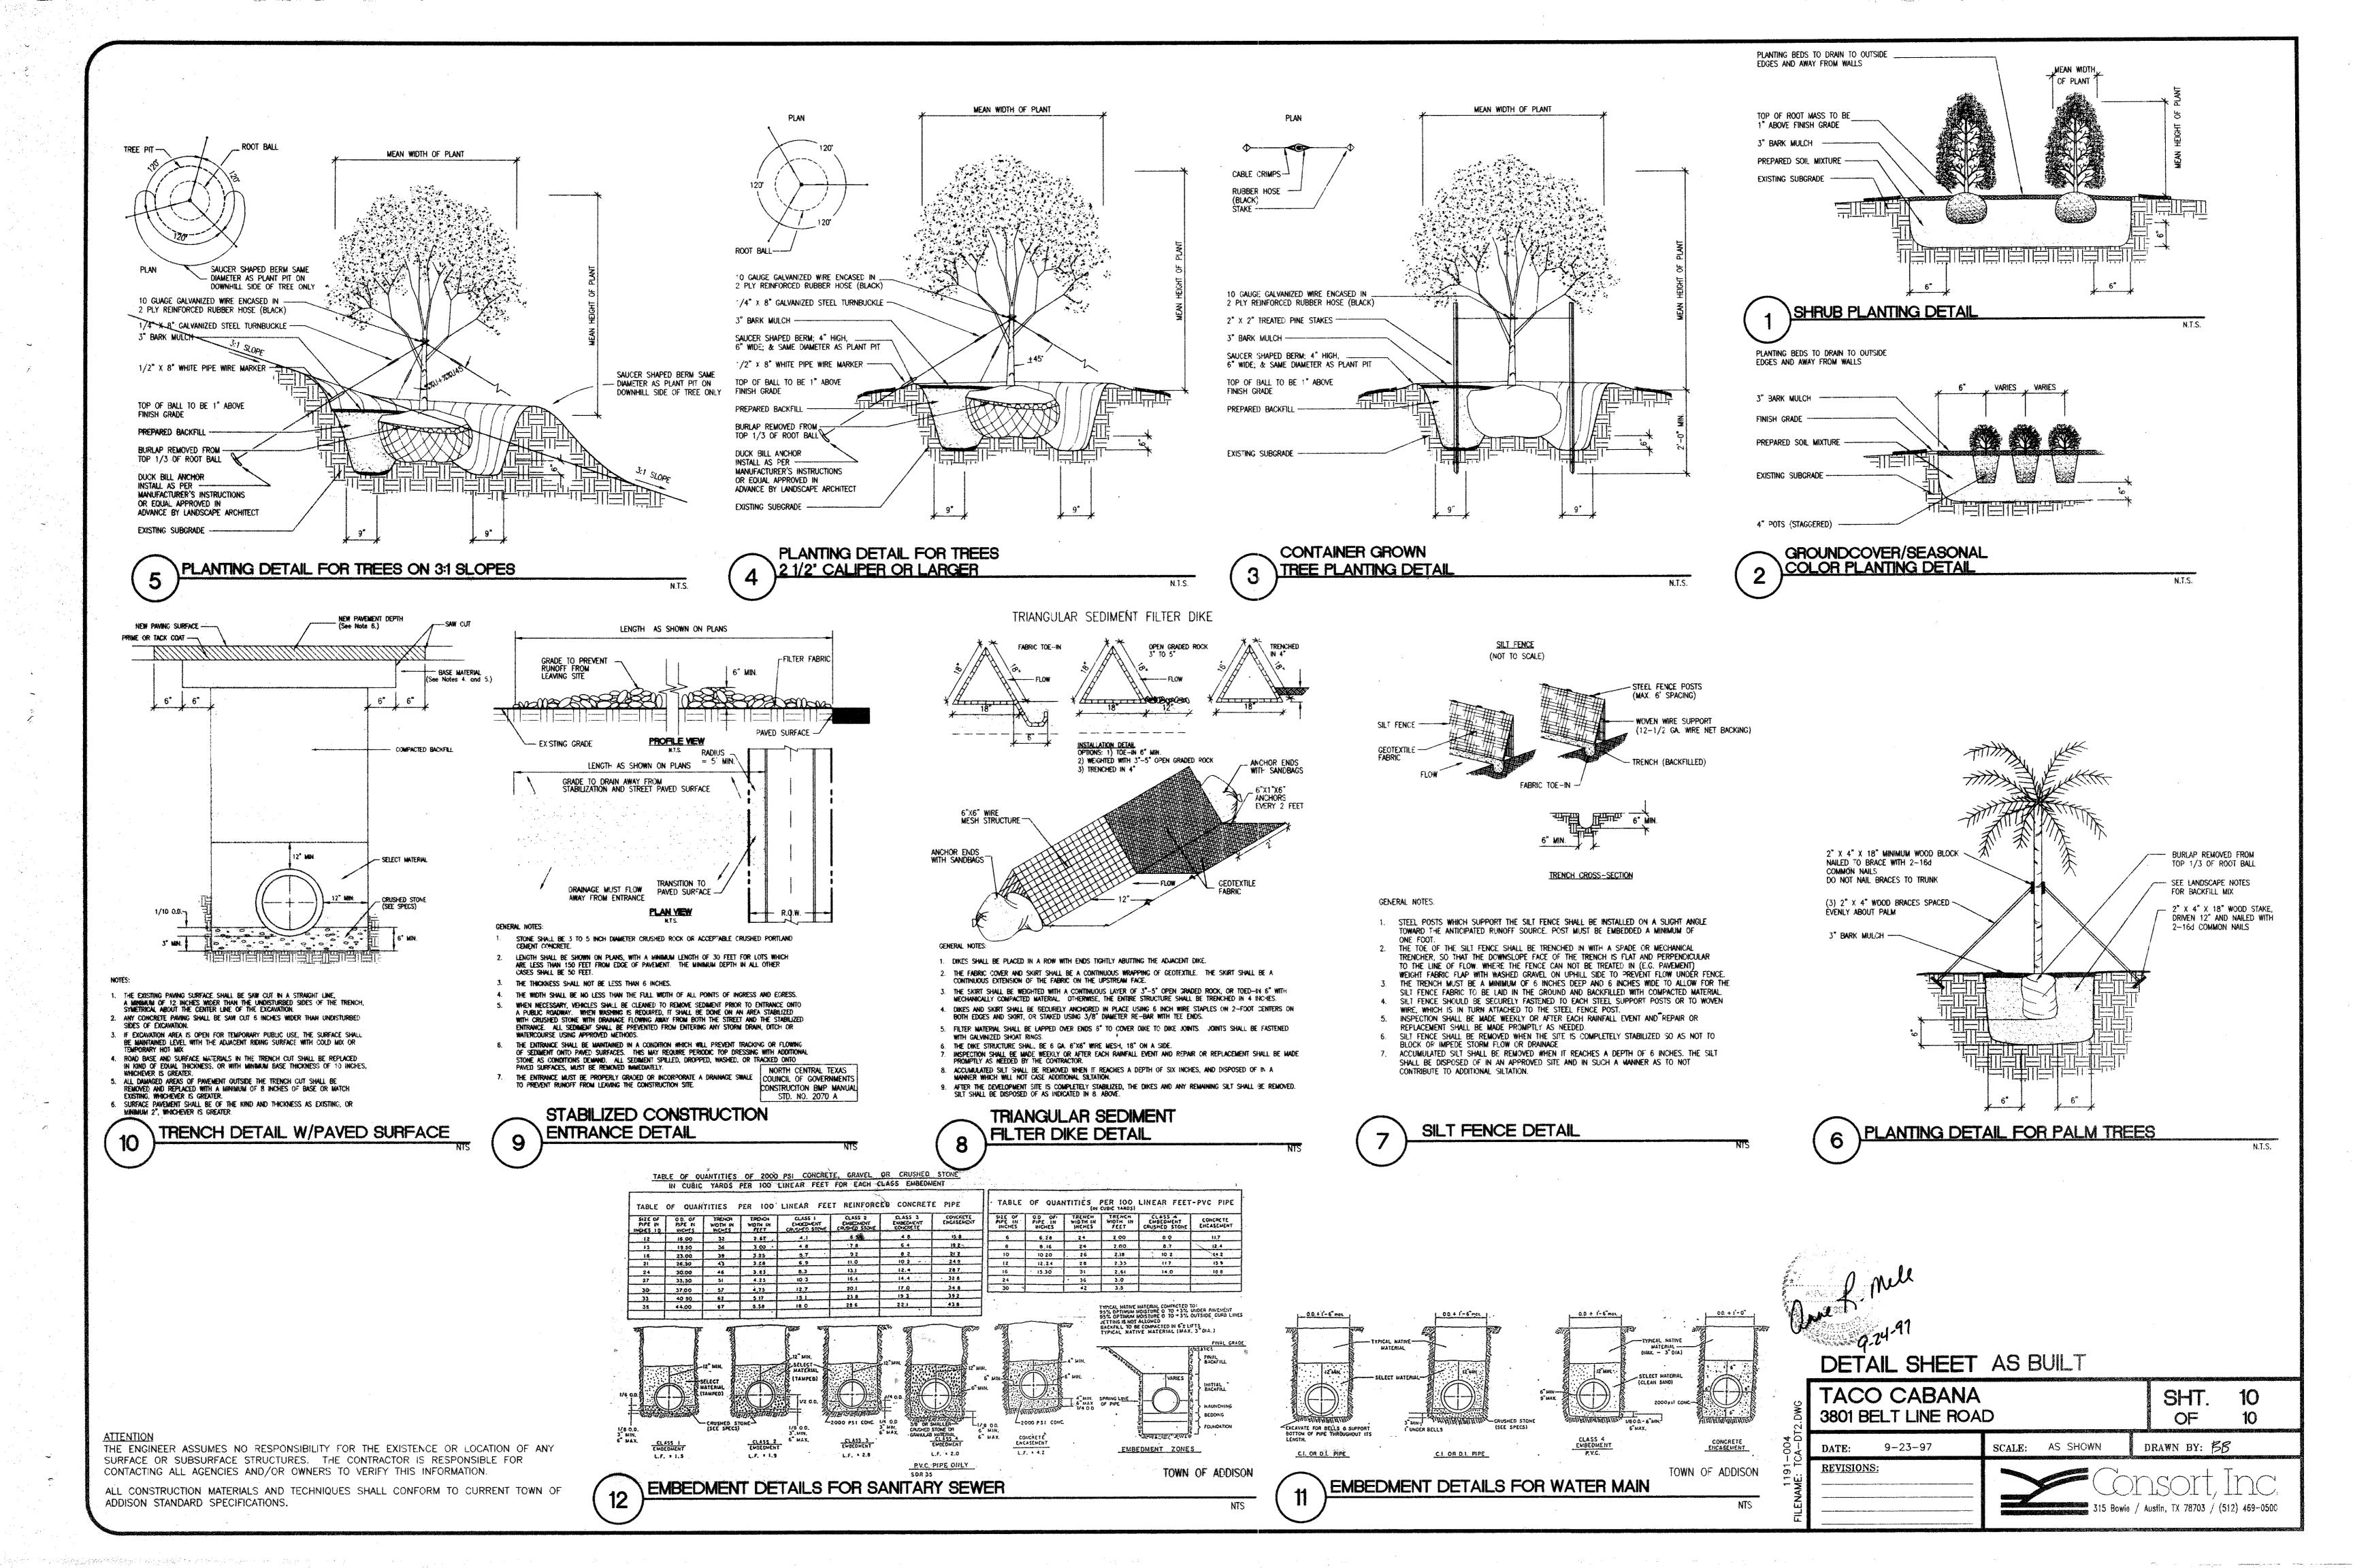

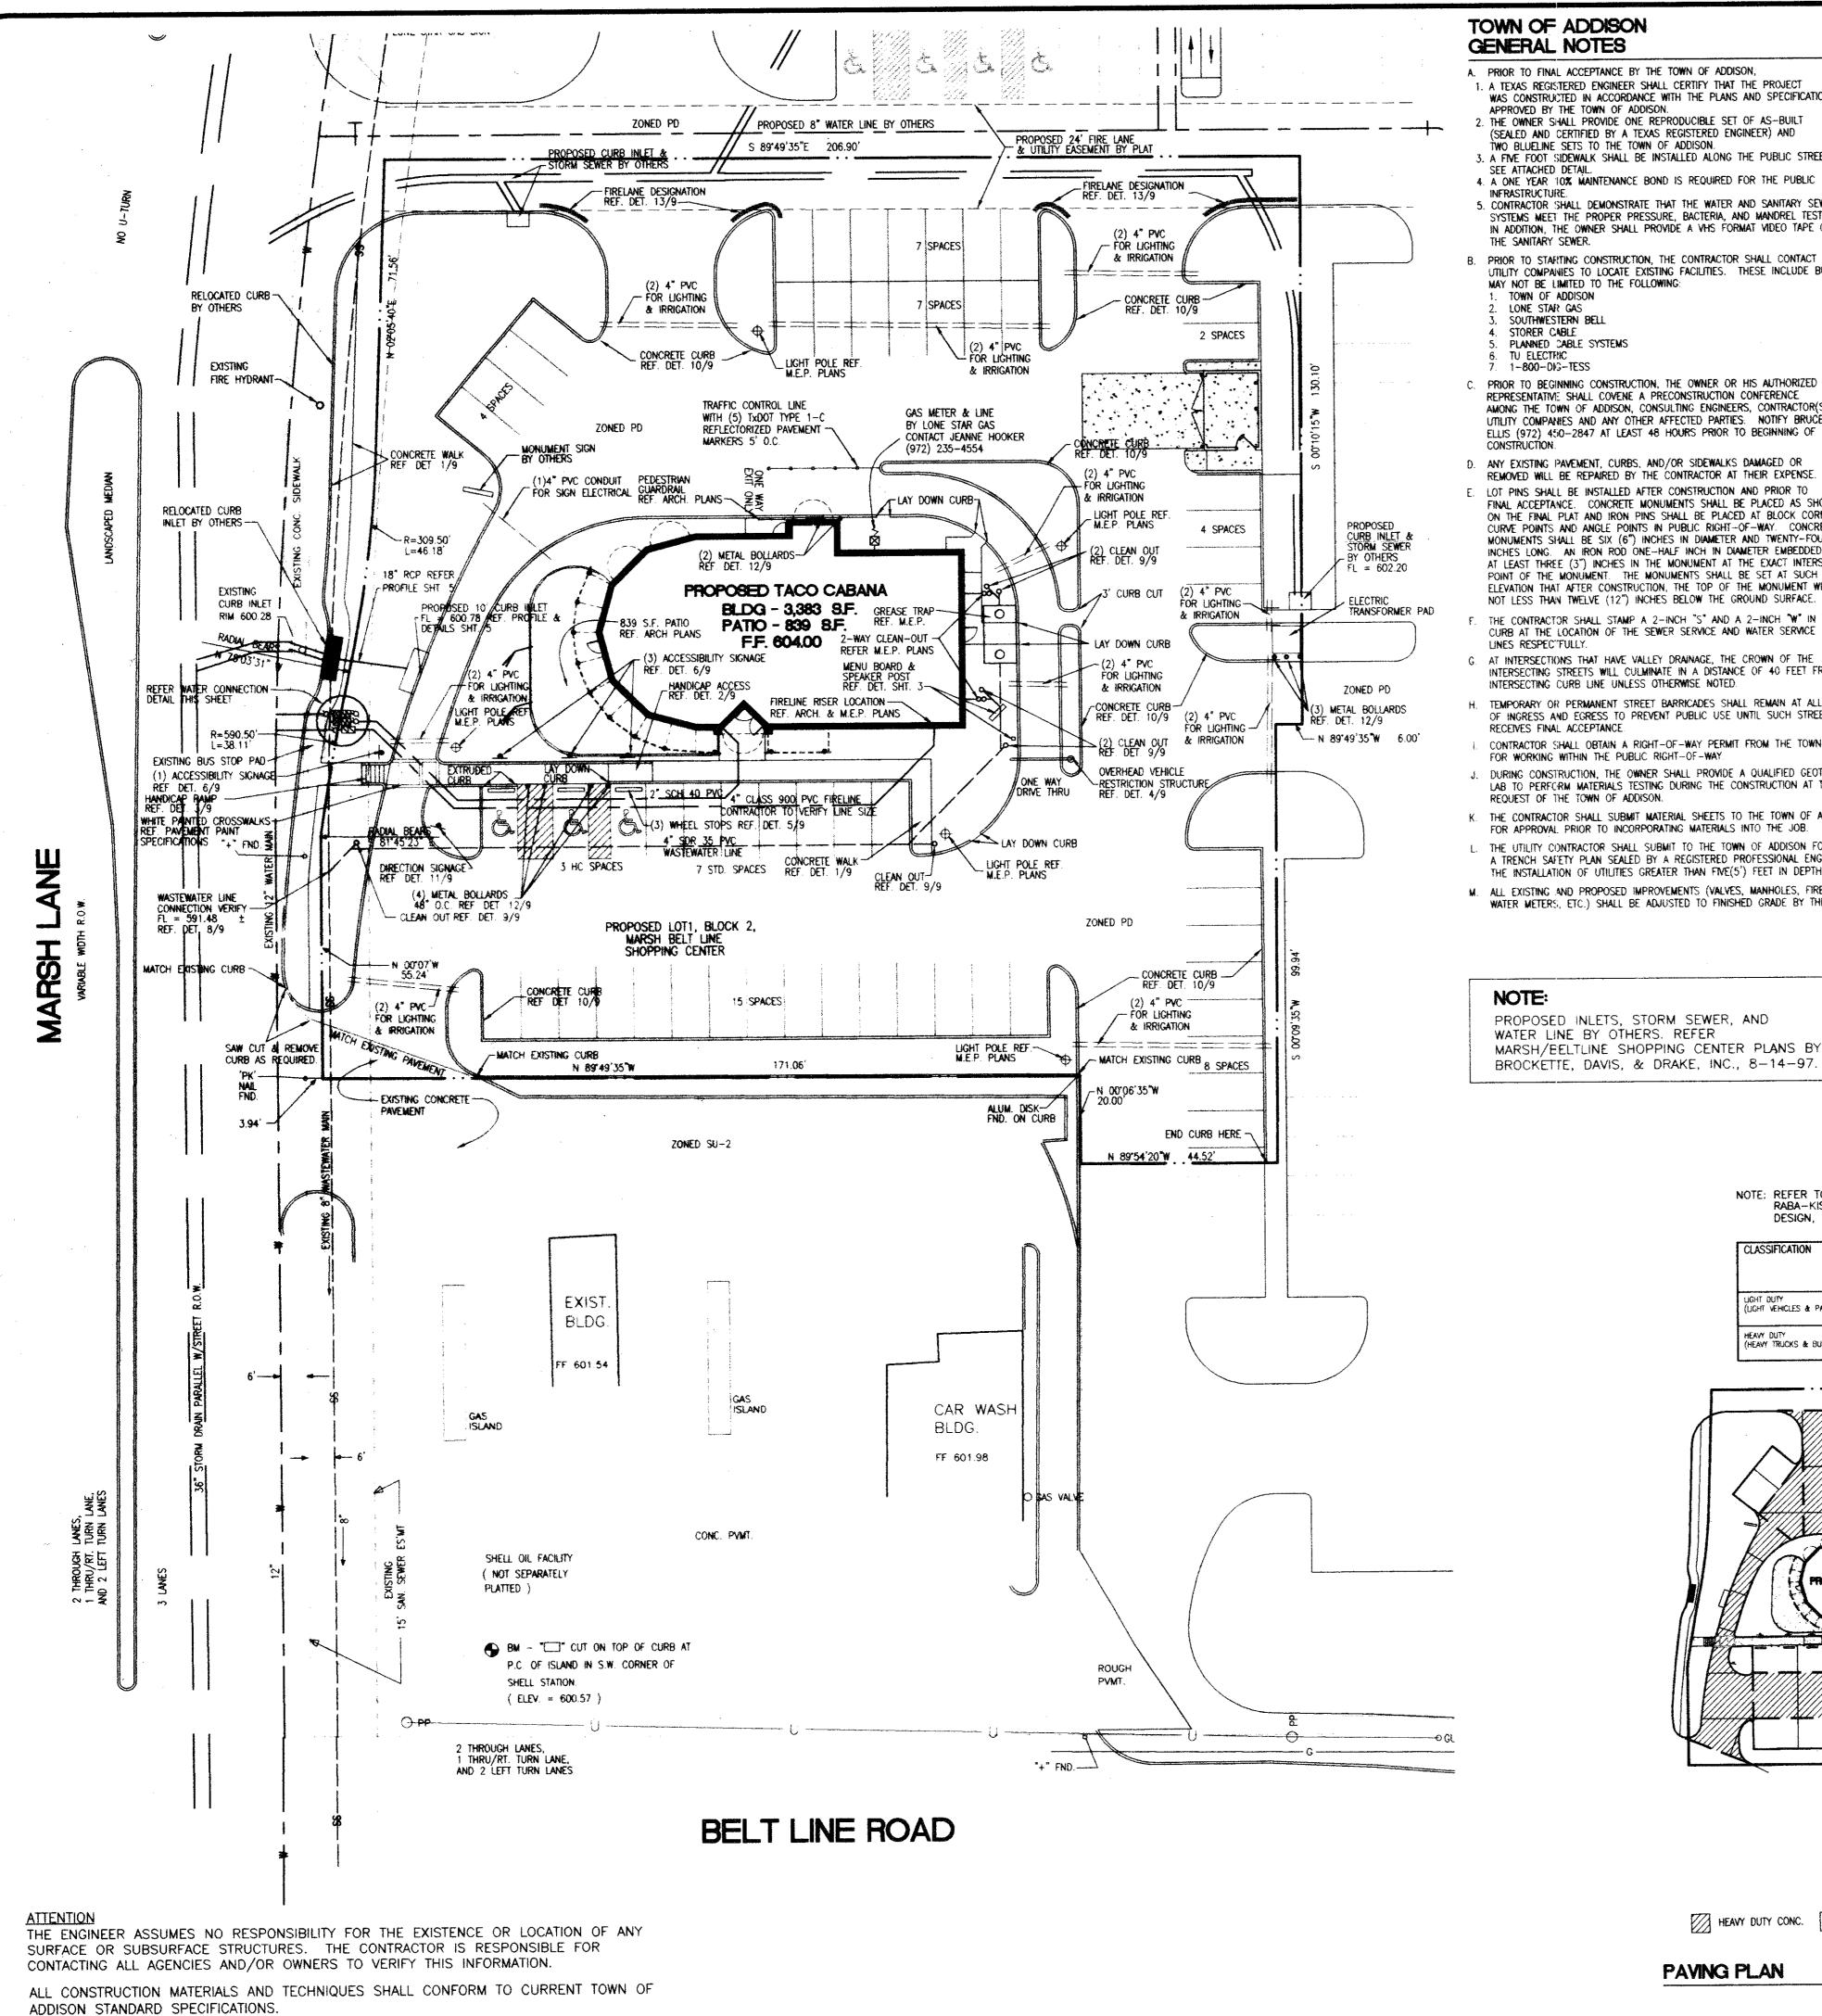

TOWN OF ADDISON

- A. PRIOR TO FINAL ACCEPTANCE BY THE TOWN OF ADDISON,
- 1. A TEXAS REGISTERED ENGINEER SHALL CERTIFY THAT THE PROJECT WAS CONSTRUCTED IN ACCORDANCE WITH THE PLANS AND SPECIFICATIONS APPROVED BY THE TOWN OF ADDISON.
- . THE OWNER SHALL PROVIDE ONE REPRODUCIBLE SET OF AS-BUILT (SEALED AND CERTIFIED BY A TEXAS REGISTERED ENGINEER) AND TWO BLUELINE SETS TO THE TOWN OF ADDISON.
- 3. A FIVE FOOT SIDEWALK SHALL BE INSTALLED ALONG THE PUBLIC STREETS.
- INFRASTRUCTURE. 5. CONTRACTOR SHALL DEMONSTRATE THAT THE WATER AND SANITARY SEWER SYSTEMS MEET THE PROPER PRESSURE, BACTERIA, AND MANDREL TESTS. IN ADDITION, THE OWNER SHALL PROVIDE A VHS FORMAT VIDEO TAPE OF
- PRIOR TO STAFFTING CONSTRUCTION, THE CONTRACTOR SHALL CONTACT THE UTILITY COMPANIES TO LOCATE EXISTING FACILITIES. THESE INCLUDE BUT MAY NOT BE LIMITED TO THE FOLLOWING:
- LONE STAR GAS SOUTHWESTERN BELL
- STORER CABLE PLANNED CABLE SYSTEMS
- PRIOR TO BEGINNING CONSTRUCTION, THE OWNER OR HIS AUTHORIZED REPRESENTATIVE SHALL COVENE A PRECONSTRUCTION CONFERENCE AMONG THE TOWN OF ADDISON, CONSULTING ENGINEERS, CONTRACTOR(S) UTILITY COMPANIES AND ANY OTHER AFFECTED PARTIES: NOTIFY BRUCE ELLIS (972) 450-2847 AT LEAST 48 HOURS PRIOR TO BEGINNING OF
- D. ANY EXISTING PAVEMENT, CURBS, AND/OR SIDEWALKS DAMAGED OR REMOVED WILL BE REPAIRED BY THE CONTRACTOR AT THEIR EXPENSE.
- E. LOT PINS SHALL BE INSTALLED AFTER CONSTRUCTION AND PRIOR TO FINAL ACCEPTANCE. CONCRETE MONUMENTS SHALL BE PLACED AS SHOWN ON THE FINAL PLAT AND IRON PINS SHALL BE PLACED AT BLOCK CORNERS, CURVE POINTS AND ANGLE POINTS IN PUBLIC RIGHT-OF-WAY. CONCRETE MONUMENTS SHALL BE SIX (6") INCHES IN DIAMETER AND TWENTY-FOUR (24") INCHES LONG. AN IRON ROD ONE-HALF INCH IN DIAMETER EMBEDDED AT LEAST THREE (3") INCHES IN THE MONUMENT AT THE EXACT INTERSECTION POINT OF THE MONUMENT. THE MONUMENTS SHALL BE SET AT SUCH AN ELEVATION THAT AFTER CONSTRUCTION, THE TOP OF THE MONUMENT WILL BE NOT LESS THAN TWELVE (12") INCHES BELOW THE GROUND SURFACE.
- THE CONTRACTOR SHALL STAMP A 2-INCH "S" AND A 2-INCH "W" IN THE CURB AT THE LOCATION OF THE SEWER SERVICE AND WATER SERVICE
- AT INTERSECTIONS THAT HAVE VALLEY DRAINAGE, THE CROWN OF THE INTERSECTING STREETS WILL CULMINATE IN A DISTANCE OF 40 FEET FROM THE INTERSECTING CURB LINE UNLESS OTHERWISE NOTED.
- TEMPORARY OR PERMANENT STREET BARRICADES SHALL REMAIN AT ALL POINTS OF INGRESS AND EGRESS TO PREVENT PUBLIC USE UNTIL SUCH STREET RECEIVES FINAL ACCEPTANCE.
- CONTRACTOR SHALL OBTAIN A RIGHT-OF-WAY PERMIT FROM THE TOWN OF ADDISON FOR WORKING WITHIN THE PUBLIC RIGHT-OF-WAY.
- J. DURING CONSTRUCTION, THE OWNER SHALL PROVIDE A QUALIFIED GEOTECHNICAL LAB TO PERFORM MATERIALS TESTING DURING THE CONSTRUCTION AT THE
- K. THE CONTRACTOR SHALL SUBMIT MATERIAL SHEETS TO THE TOWN OF ADDISON FOR APPROVAL PRIOR TO INCORPORATING MATERIALS INTO THE JOB.
- L. THE UTILITY CONTRACTOR SHALL SUBMIT TO THE TOWN OF ADDISON FOR APPROVAL A TRENCH SAFETY PLAN SEALED BY A REGISTERED PROFESSIONAL ENGINEER FOR THE INSTALLATION OF UTILITIES GREATER THAN FIVE(5") FEET IN DEPTH.
- M. ALL EXISTING AND PROPOSED IMPROVEMENTS (VALVES, MANHOLES, FIRE HYDRANTS, WATER METERS, ETC.) SHALL BE ADJUSTED TO FINISHED GRADE BY THE CONTRACTOR.

SITE PLAN NOTES

- 1 ALL DIMENSIONS ARE TAKEN TO FACE OF CURB OR BUILDING UNLESS OTHERWISE NOTED.
- CONTRACTOR SHALL VERIFY DIMENSIONS AND NOTIFY ENGINEER OF ANY DISCREPANCIES.
- 3 USE DIMENSIONAL INFORMATION GIVEN.
- DO NOT SCALE DRAWINGS.
- CONTRACTOR SHALL VERIFY EXACT LOCATIONS AND PROTECT ALL EXISTING SITE IMPROVEMENTS AND
- UTILITIES DURING CONSTRUCTION OPERATIONS. 5 ALL WALKWAYS LEADING TO ENTRANCES ARE TO BE
- AT LOCATIONS WHERE EXISTING PAVEMENT ABUTS NEW PAVEMENT, CONTRACTOR SHALL BLEND NEW PAVEMENT TO EXISTING CONDITIONS. PAVEMENTS SHALL ALIGN BOTH VERTICALLY AND HORIZONTALLY PONDING AT JOINTS WILL NOT BE ACCEPTABLE.

CENTERED ON DOORWAYS UNLESS OTHERWISE NOTED.

- PROVIDE MINIMUM 1/8" PER FOOT CROSS SLOPE IN DIRECTION OF SURFACE DRAINAGE ON ALL WALKWAYS.
- 8 WHERE NEW CONCRETE PAVEMENT MEETS EXISTING CONCRETE OR VERTICAL SURFACES PROVIDE 1/2" EXPANSION JOINT. WHERE NEW CONCRETE PAVEMENT MEETS EXISTING ASPHALT, SAW CUT EDGE OF ASPHALT AND BUTT NEW PAVEMENT TIGHT SCORING JOINTS SHALL MATCH EXISTING CONDITION WHERE NEW CONCRETE PAVEMENT REPLACES EXISTING OR ABUTS EXISTING CONCRETE PAVEMENT.
- FINISH ON CONCRETE SHALL BE PERPENDICULAR TO
- WHERE NEW ASPHALT PAVEMENT MEETS EXISTING ASPHALT, SAW CUT EXISTING ASPHALT. ALL NEW PAVEMENTS SHALL MEET EXISTING FLUSH.
- PARKING LOT LINES AND TRAFFIC CONTROL MARKINGS SHALL BE PAINTED ON PAVEMENT WITH MINIMUM 4" WIDE LINES OR AS SHOWN ON PLANS
- 12 PROVIDE EXPANSION JOINT MATERIAL AT ALL LOCATIONS WHERE CURB AND GUTTER ABUTS OR IS ADJACENT
- 13 AUTOMATIC UNDERGROUND IRRIGATION SYSTEM WILL BE PROVIDED. CONTRACTOR TO PROVIDE SLEEVING FOR UNDERGROUND IRRIGATION SYSTEM AND COORDINATE WITH IRRIGATION PLAN.
- 14 ALL HANDICAP PARKING SPACES SHALL HAVE SIGNS AS INDICATED ON THE PLANS AND AS PER DETAILS.
- LIGHT POLES OR SIGN POLES ARE NOT ALLOWED IN PARKING OR DRIVEWAY PAVEMENT AREAS. COORDINATE LOCATIONS WITH LANDSCAPE PLAN.
- 16 PIERS FOR LIGHT ROLES SHALL NOT BE ABOVE CURB.
- ALL LIGHT POLES WILL BE A MINIMUM THREE (3) FEET BEHIND ANY CURB.
- CONTRACTOR TO ADJUST ALL EXISTING MANHOLES. PULLBOXES, AND OTHER UTILITIES WHERE NECESSARY TO BE FLUSH WITH FINISH GRADE.

REINFORCED PORTLAND CEMENT CONCRETE, IN.

FOR PAVEMENT DESIGN AND CONSTRUCTION REF. TO GEOTECHNICAL STUDY PREPARED FOR TACO CABANA BY RABA-KISTNER-BRYTEST INC. PROJECT NO. AAA97-047-00. CONCRETE PAVING IS REQUIRED.

PAVEMENT PAINT SPECIFICATION: FIRE LANE PAVEMENT PAINT SHALL BE GLIDDEN #4520 OIL ENAMEL "SAFETY RED" TRAFFIC ARROW PAVEMENT PAINT SHALL BE GLIDDEN #22693 OIL ENAMEL "TRAFFIC WHITE" CROSSWALK PAVEMENT PAINT SHALL BE GLIDDEN #22693 OIL ENAMEL "TRAFFIC WHITE" YELLOW TRAFFIC STRIPE PAVEMENT PAINT SHALL BE GLIDDEN #22692 OIL ENAMEL "TRAFFIC YELLOW"

SITE DATA

TOTAL LOT AREA	45,460 S.F.
	1.0436 ac.
IMPERVIOUS COVER	34,738 S.F.
% OF SITE AREA	76 %
BUILDING AREA	3,383 S.F.
PROPOSED USE	RESTAURANT W DRIVE-THROUGH
STORIES	1
HEIGHT	16'-8"
FINISH FLOOR	604.00
ZONING	PD

— — — WATER LINE — — WASTE WATER LINE --- STORM SEWER LINE FIRE HYDRANT WATER METER POWER POLE ----P--- OVERHEAD ELECTRIC + 100.00 EXISTING SPOT ELEVATION 100.00 PROPOSED SPOT ELEVATION MISC. CONCRETE PAVING

LEGEND

INV

BOC

FOC

TOP OF GRATE

BOTTOM OF CURB

TOP OF CURB

BACK OF CURB

FACE OF CURB

MORTAR STACK ROCK WALL

TOP OF WALL

INVERT

RETAINING WALL

FLOW LINE

HIGH POINT

LIMITS OF CONSTRUCTION SILT FENCE DRAINAGE AREA DRAINAGE AREA BOUNDARY +++++++ FILTER DIKE -X TREE PROTECTION FENCE --- 704 --- EXISTING CONTOUR PROPOSED CONTOUR EXISTING TREE TO REMAIN EXISTING TREE


TO BE REMOVED TRAFFIC GUARD RAIL FIRE LANE DESIGNATION - HAND RAILS

PARKING

	REQUIRED	PROVIDED		
USE		STANDARD	HANDICAP	TOTAL
RESTAURANT (3,383 S.F.) © 1 SPACE/70S.F.	48	46	2	48
PATIO (839 S.F.) © 1 SPACE/70S.F.	12	11	1	. 12
TOTAL	60	57	3	60 .

FOR METER VAULT PRODUCTS CONTACT:

BROOKS PRODUCTS, INC. 2001 W. MAYFIELD ARLINGTON, TEXAS 76015 (817) 467-2783 or (817) 465-0080 FAX (817) 465-6909

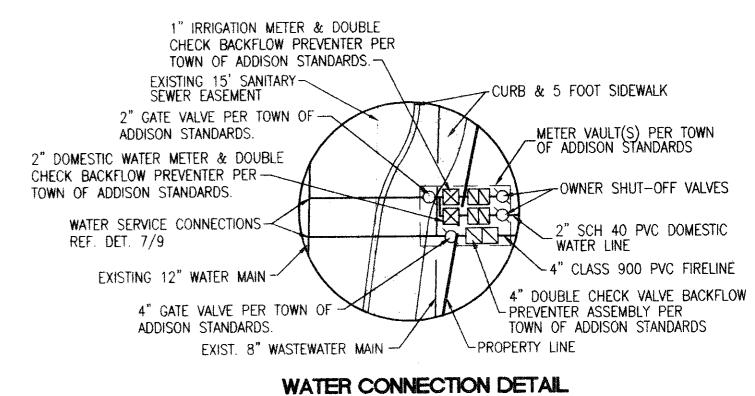



SITE, PAVING, AND UTILITY PLAN AS BUILT

DATE: NORTH REVISIONS:

TACO CABANA 3801 BELT LINE ROAD 9-23-97

SHT. DRAWN BY:

SCALE: 1" = 20'11-14-97

HEAVY DUTY CONC. LIGHT DUTY CONC. CONTROL JOINT

PAVING PLAN

NOTE: REFER TO GEOTECHNICAL STUDY PREPARED BY RABA-KISTNER-BRYTEST INC. FOR ALL PAVEMENT

LIGHT DUTY (LIGHT VEHICLES & PARKING)

HEAVY DUTY (HEAVY TRUCKS & BUS DRIVES

DESIGN, SPECIFICATIONS, AND CONSTRUCTION.

STRUCTURAL F

CLAY SOILS

SCALE: 1" = 50'

