

**PARKING**  
 LEVEL 1 641.5  
 LEVEL 2 641.0  
 LEVEL 3 640.5  
 LEVEL 4 640.0

**OFFICE BUILDING**  
 F.F. ELEV. 641.00

**QUORUM DRIVE**


CITY OF ADDISON  
**APPROVED**  
 FOR CONSTRUCTION

DATE: \_\_\_\_\_  
 NOTE: CONTRACTOR IS HEREBY INSTRUCTED TO EXERCISE CARE IN MEETING OR EXCEEDING ALL REQUIREMENTS OF DISTRICT, STATE AND LOCAL CODES AND/OR ORDINANCES APPLICABLE TO HIS WORK. APPROVAL OF THESE PLANS SHALL NOT BE CONSTRUED TO RELIEVE CONTRACTOR OF ANY LIABILITY OR IMPLY WARRANTY TO ANY OTHER PARTY.


▲ REVISED 11-9-83

12-5-83 CONTRACT DOCUMENTS


GRADING PLAN						
QUORUM 14881						
ADDISON PUBLIC WORKS DEPARTMENT						
CITY OF ADDISON, TEXAS						
DESIGN	DRAWN	DATE	SCALE	NOTES	FILE	NO.
I.E. Tr.	J.P.L.	02/80		I.E. Tr.		C-1

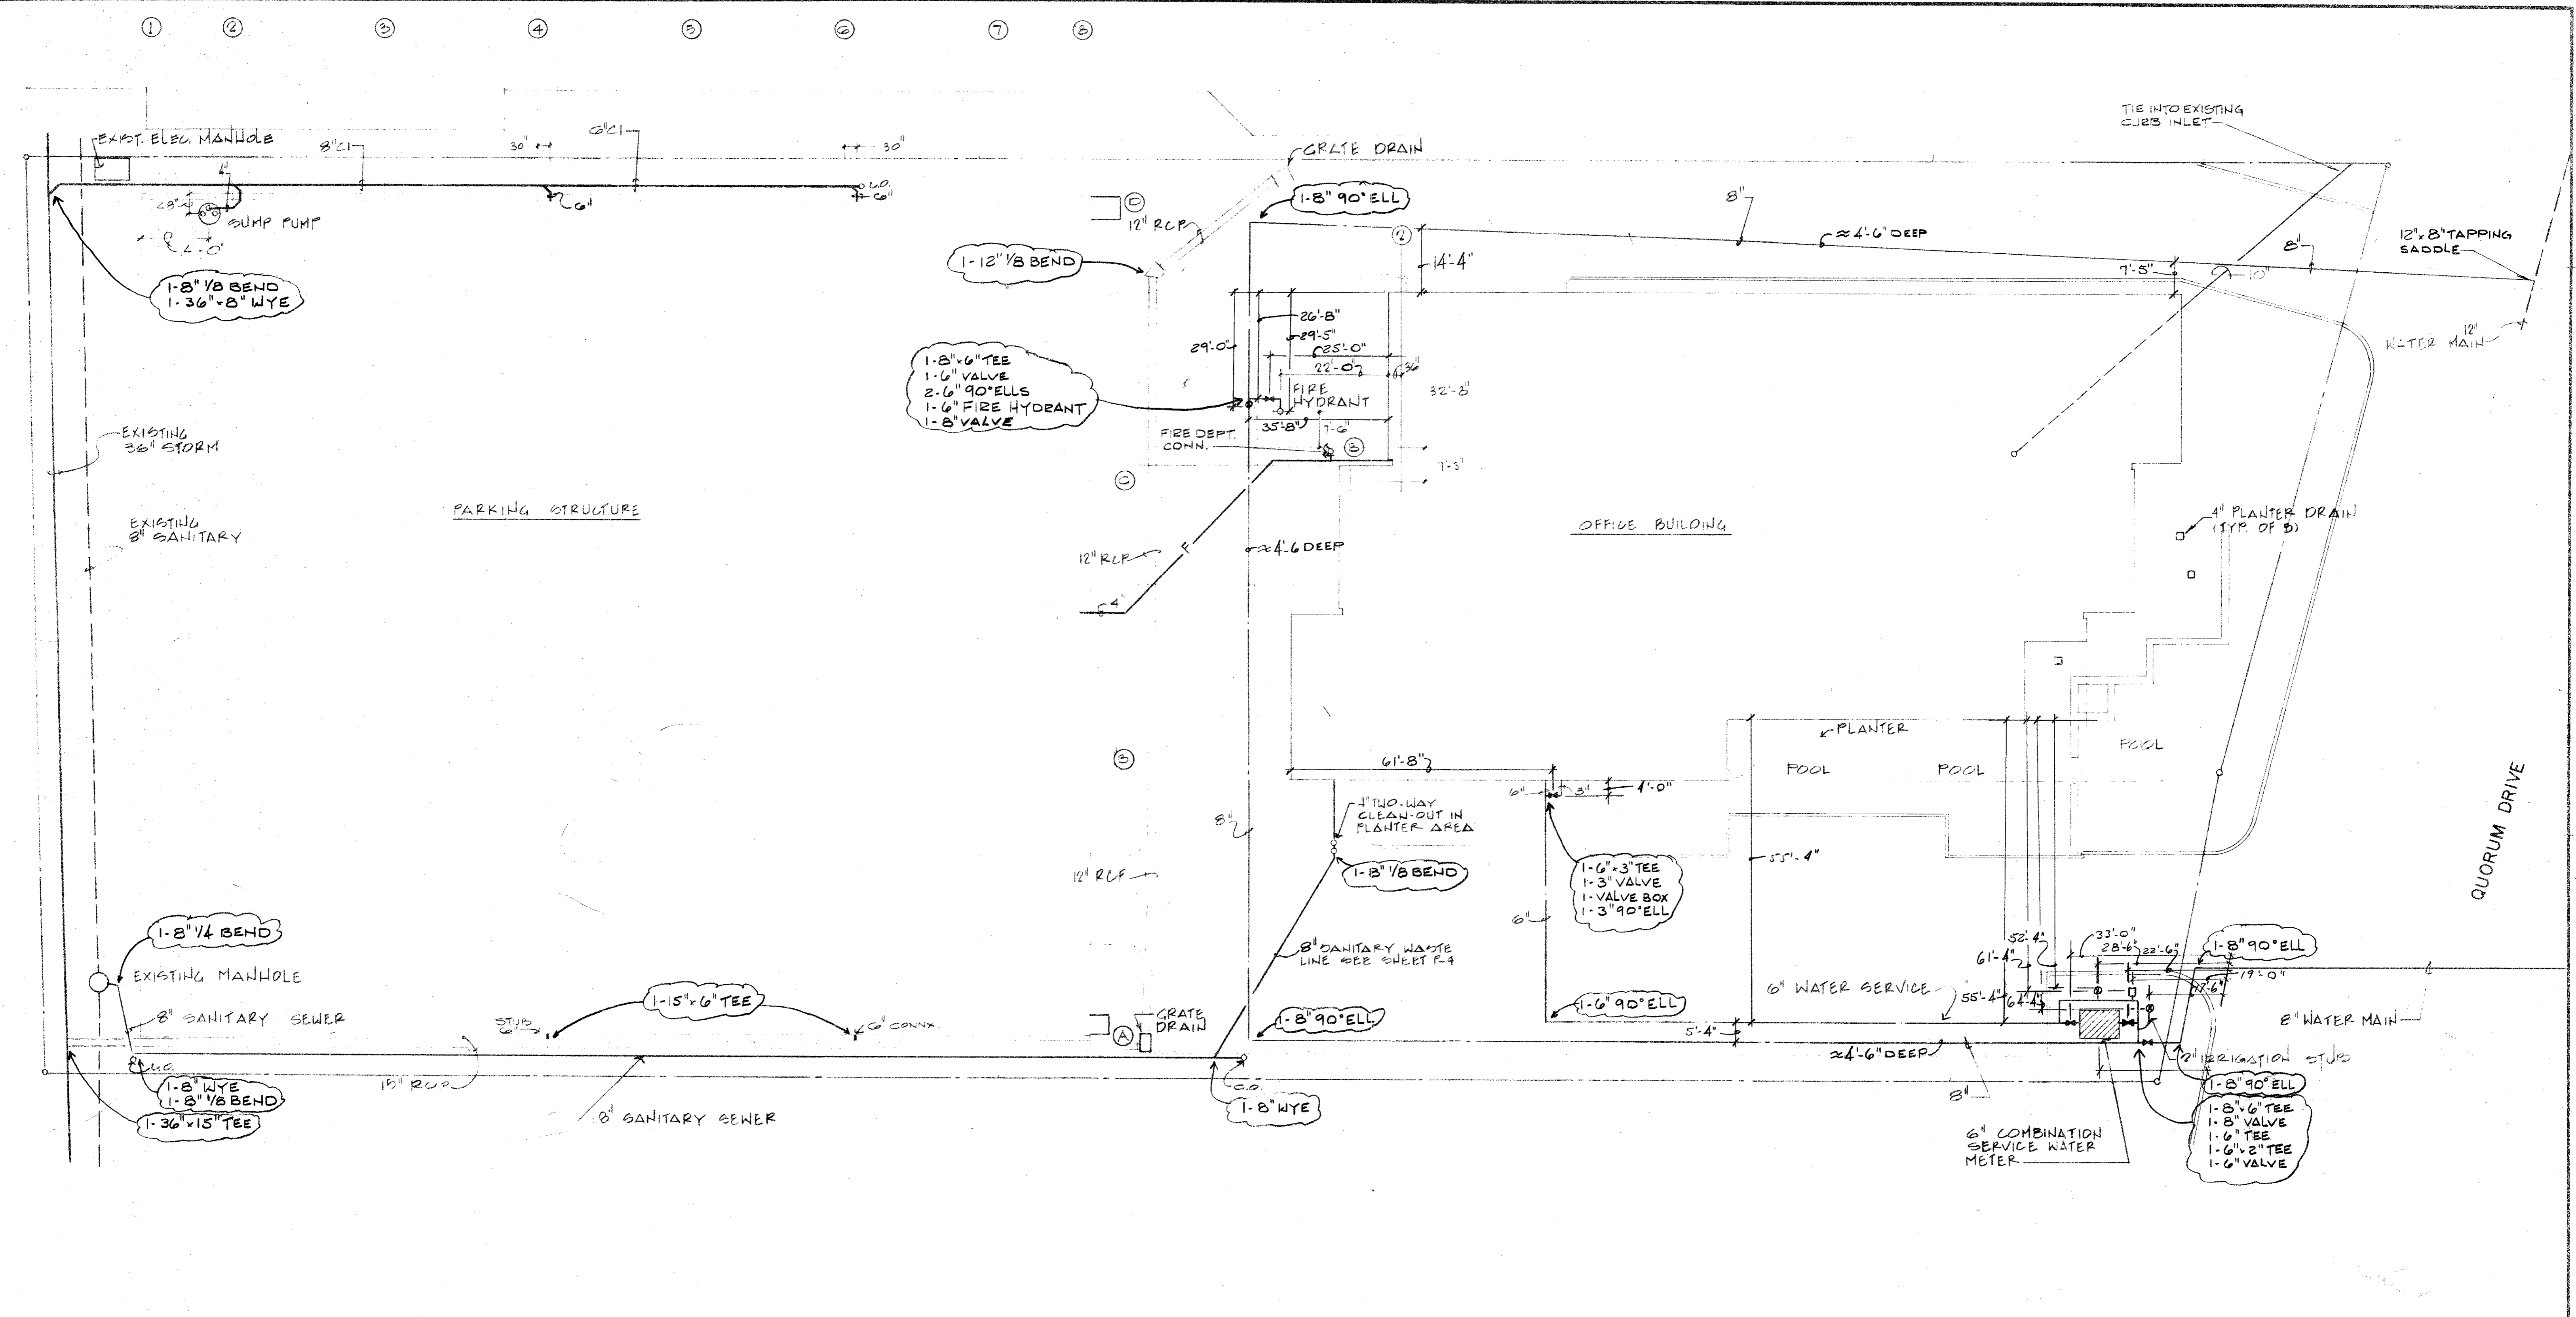


**SITE PLAN**  
SCALE: 1/16" = 1'-0"

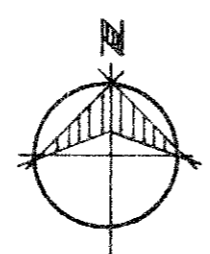


NO.	REVISION	TITLE	DATE
		PLUMBING - SITE PLAN	12-26-24
JOB NUMBER	14881 QUORUM BUILDING		
83138	ADDISON, TEXAS		
DESIGNED BY	MILTON B. LEVY & SON PLUMBING, INC.		DATE
LEVY & SON PLUMBING			SHEET NUMBER
DRAWN BY			C-1
LEVY & SON PLUMBING			
CHECKED BY	11024 INDIAN TRAIL DALLAS, TEXAS 241-8003	OF SHEETS	
STEVE DUNN ENGINEERS			

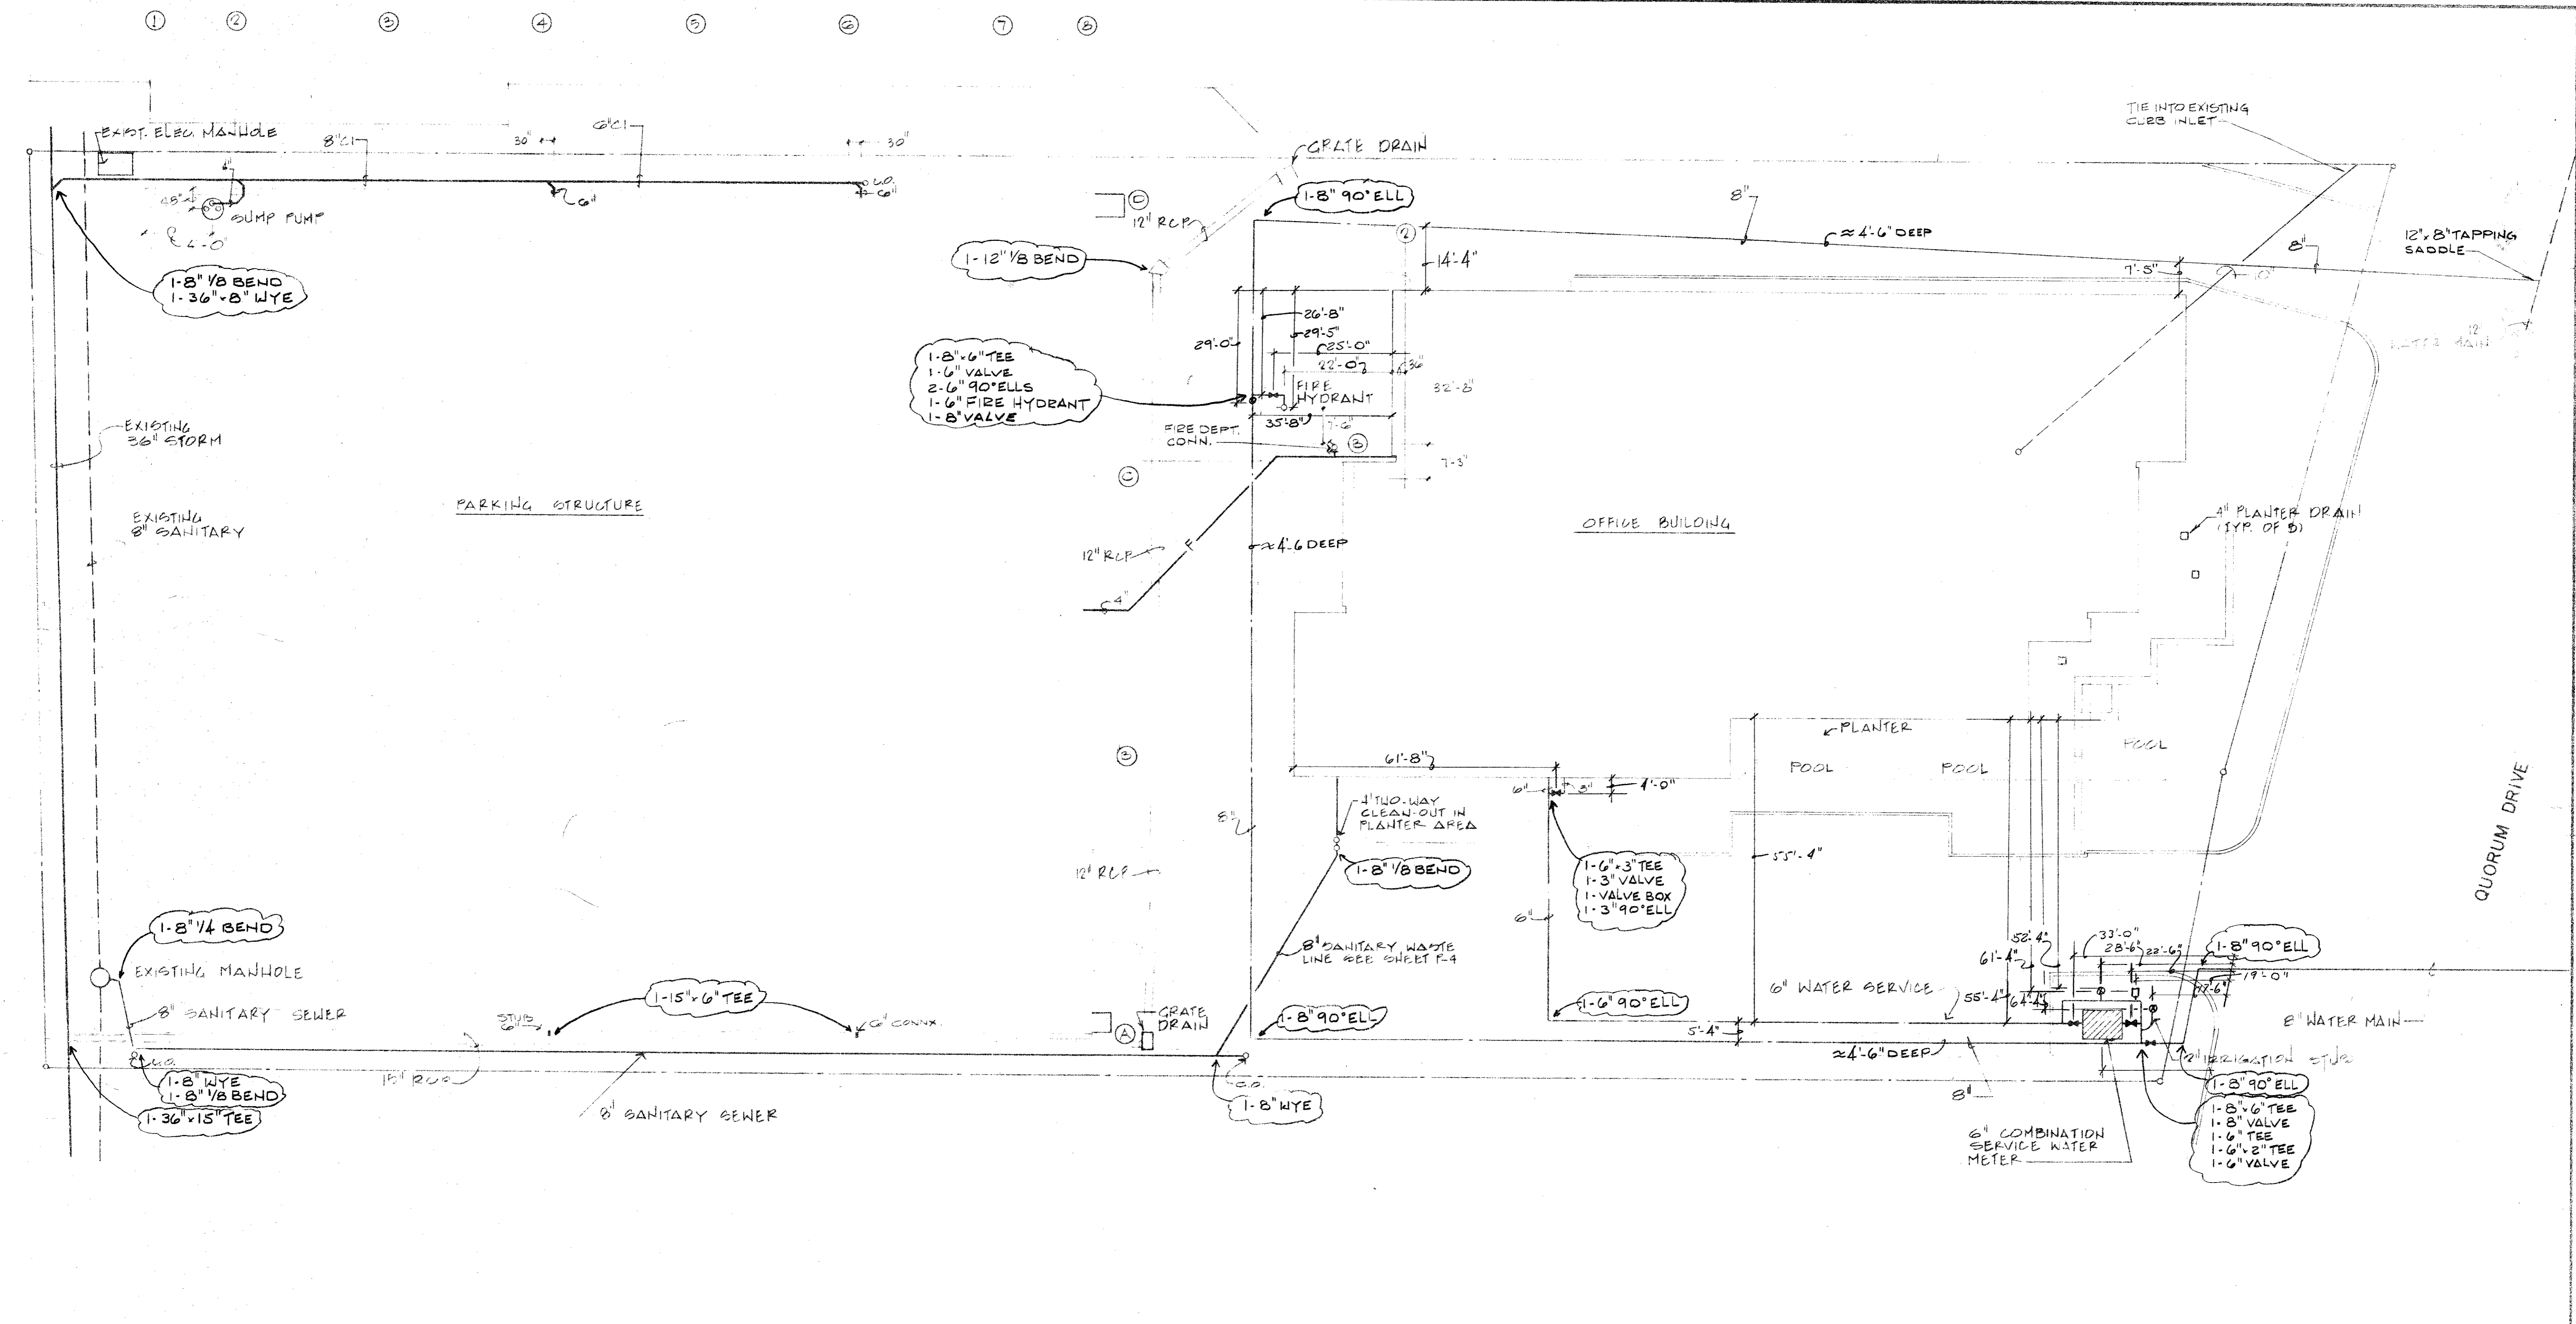


**SITE PLAN**  
SCALE: 1/16" = 1'-0"

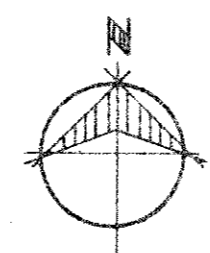

NO.	REVISION	TITLE	DATE
		PLUMBING - SITE PLAN	2-6-84
JOB NUMBER	14881 QUORUM BUILDING		
83138			
DESIGNED BY	ADDISON,	TEXAS	DATE
LEVY & SON			
PLUMBING			
DRAWN BY	MILTON B. LEVY & SON		SHEET NUMBER
LEVY & SON	PLUMBING, INC.		C-1
CHECKED BY	11024 MOJAN TRAIL DALLAS, TEXAS 241-9803		OF SHEETS
STEVE DUNN			

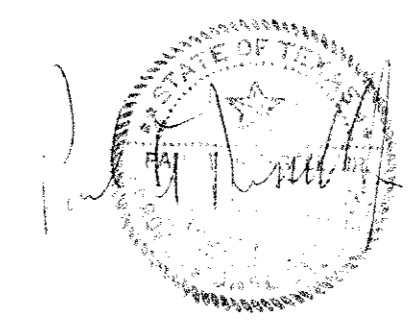

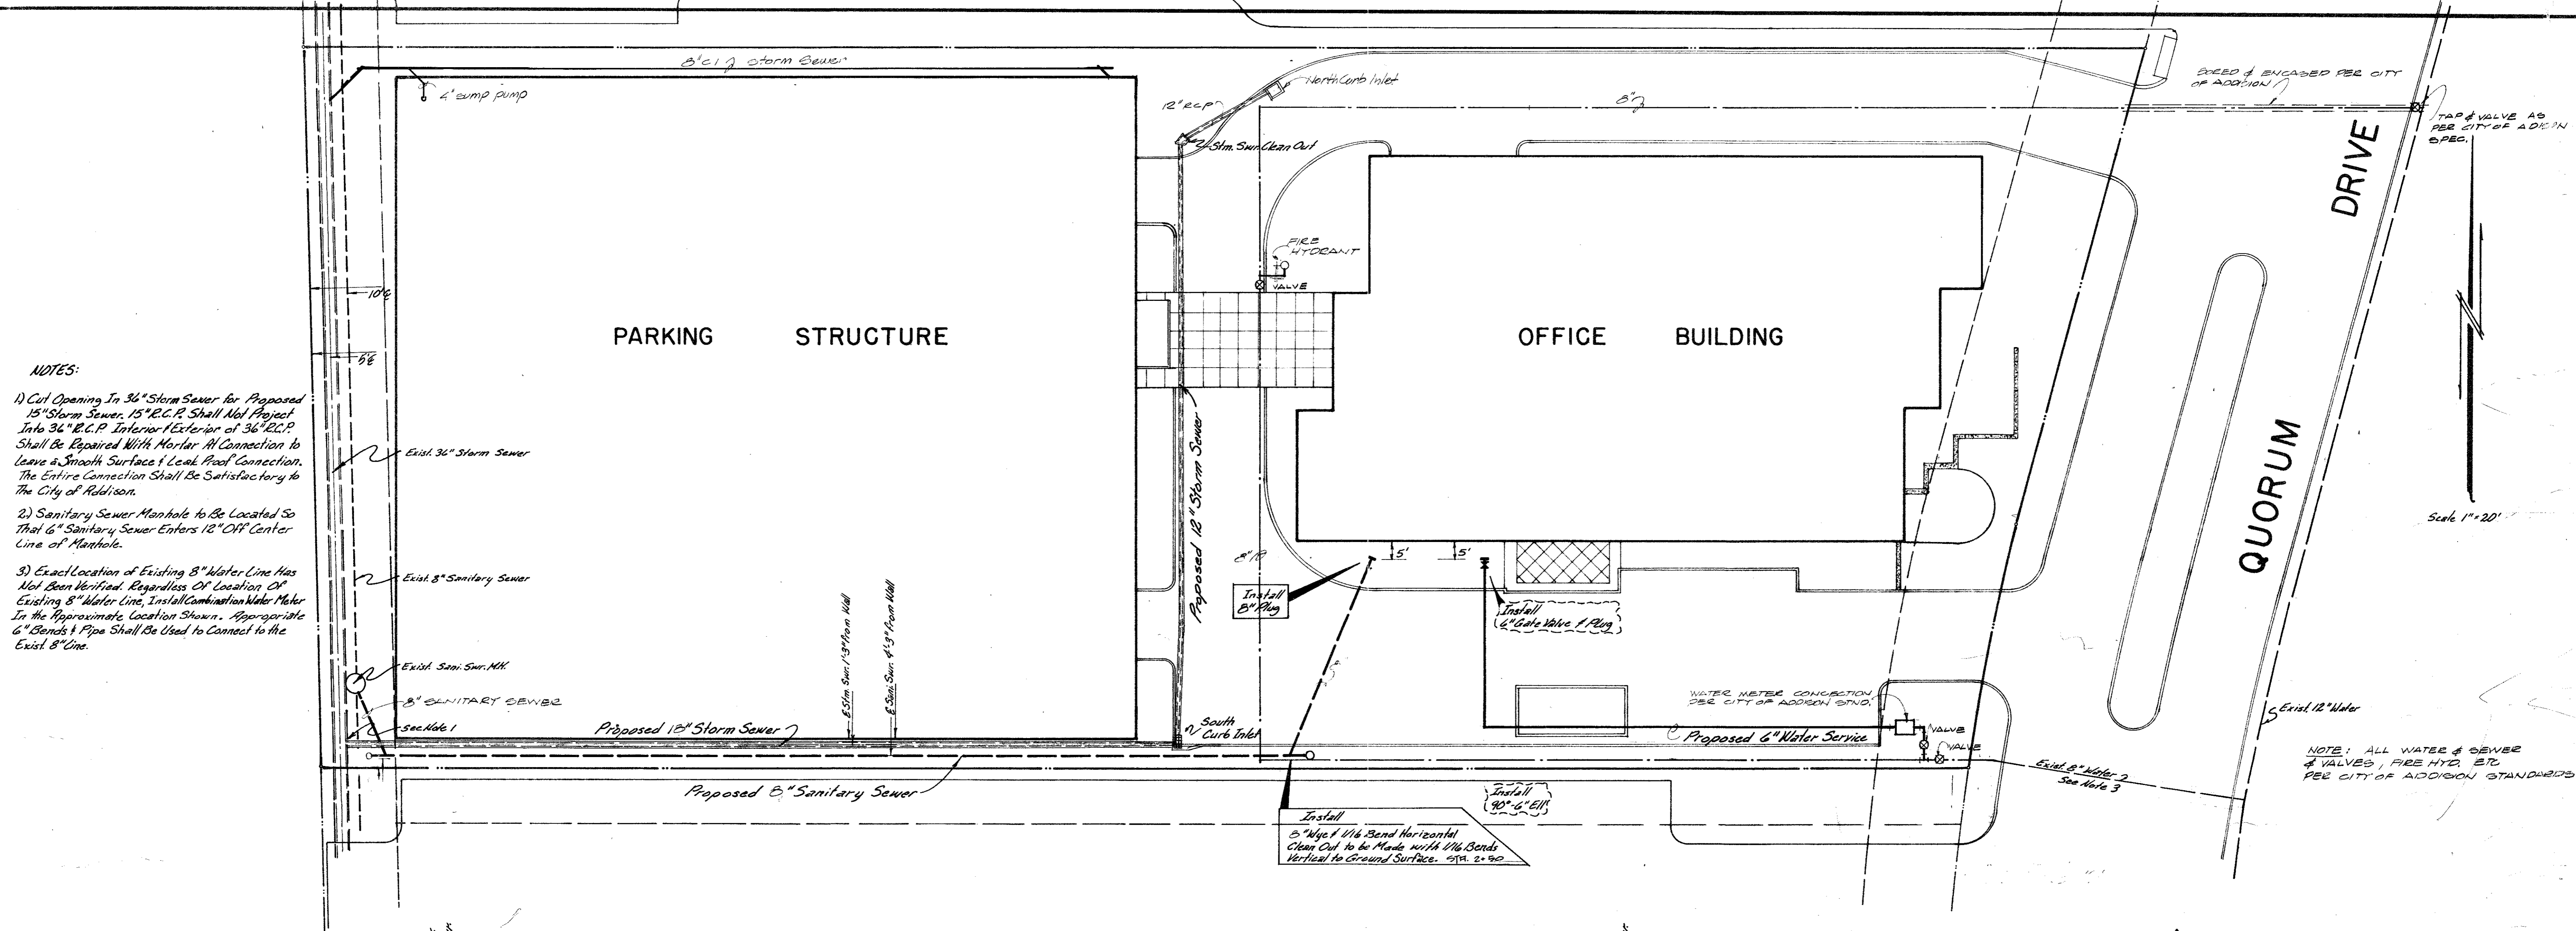

- NOTES:**
- 1) Cut Opening In 36" Storm Sewer for Proposed 15" Storm Sewer. 15" R.C.P. Shall Not Project Into 36" R.C.P. Interior Exterior of 36" R.C.P. Shall Be Repaired With Mortar. All Connection To Leave a Smooth Surface & Leak Proof Connection. The Entire Connection Shall Be Satisfactory to The City of Addison.
  - 2) Sanitary Sewer Manhole to Be Located So That 6" Sanitary Sewer Enters 12" Off Center Line of Manhole.
  - 3) Exact Location of Existing 8" Water Line Has Not Been Verified. Regardless Of Location Of Existing 8" Water Line, Install Combination Water Meter In the Approximate Location Shown. Appropriate 6" Bends & Pipe Shall Be Used to Connect to the Exist. 8" Line.


SEE CITY OF ADDISON SPEC. 12-5-83  
 TOP & VALVE AS PER CITY OF ADDISON SPEC.

Scale 1" = 20'

NOTE: ALL WATER & SEWER & VALVES, FIRE HYD. ETC PER CITY OF ADDISON STANDARDS

REVISION 11-9-83


**CITY OF ADDISON APPROVED**  
 BUILDING DEPARTMENT  
 DATE: 5-13-84  
 NOTE: CONTRACTOR IS HEREBY INSTRUCTED TO PROVIDE CASE IN REPAIR OR EXCEEDING ALL REPAIRS AND LOCAL CODES AND LOCAL ORDINANCES. APPROVAL OF THESE DRAWINGS SHALL NOT BE CONSTRUED TO RELIEVE RESPONSIBILITY OR IMPLY WAIVER TO SUCH CODES.

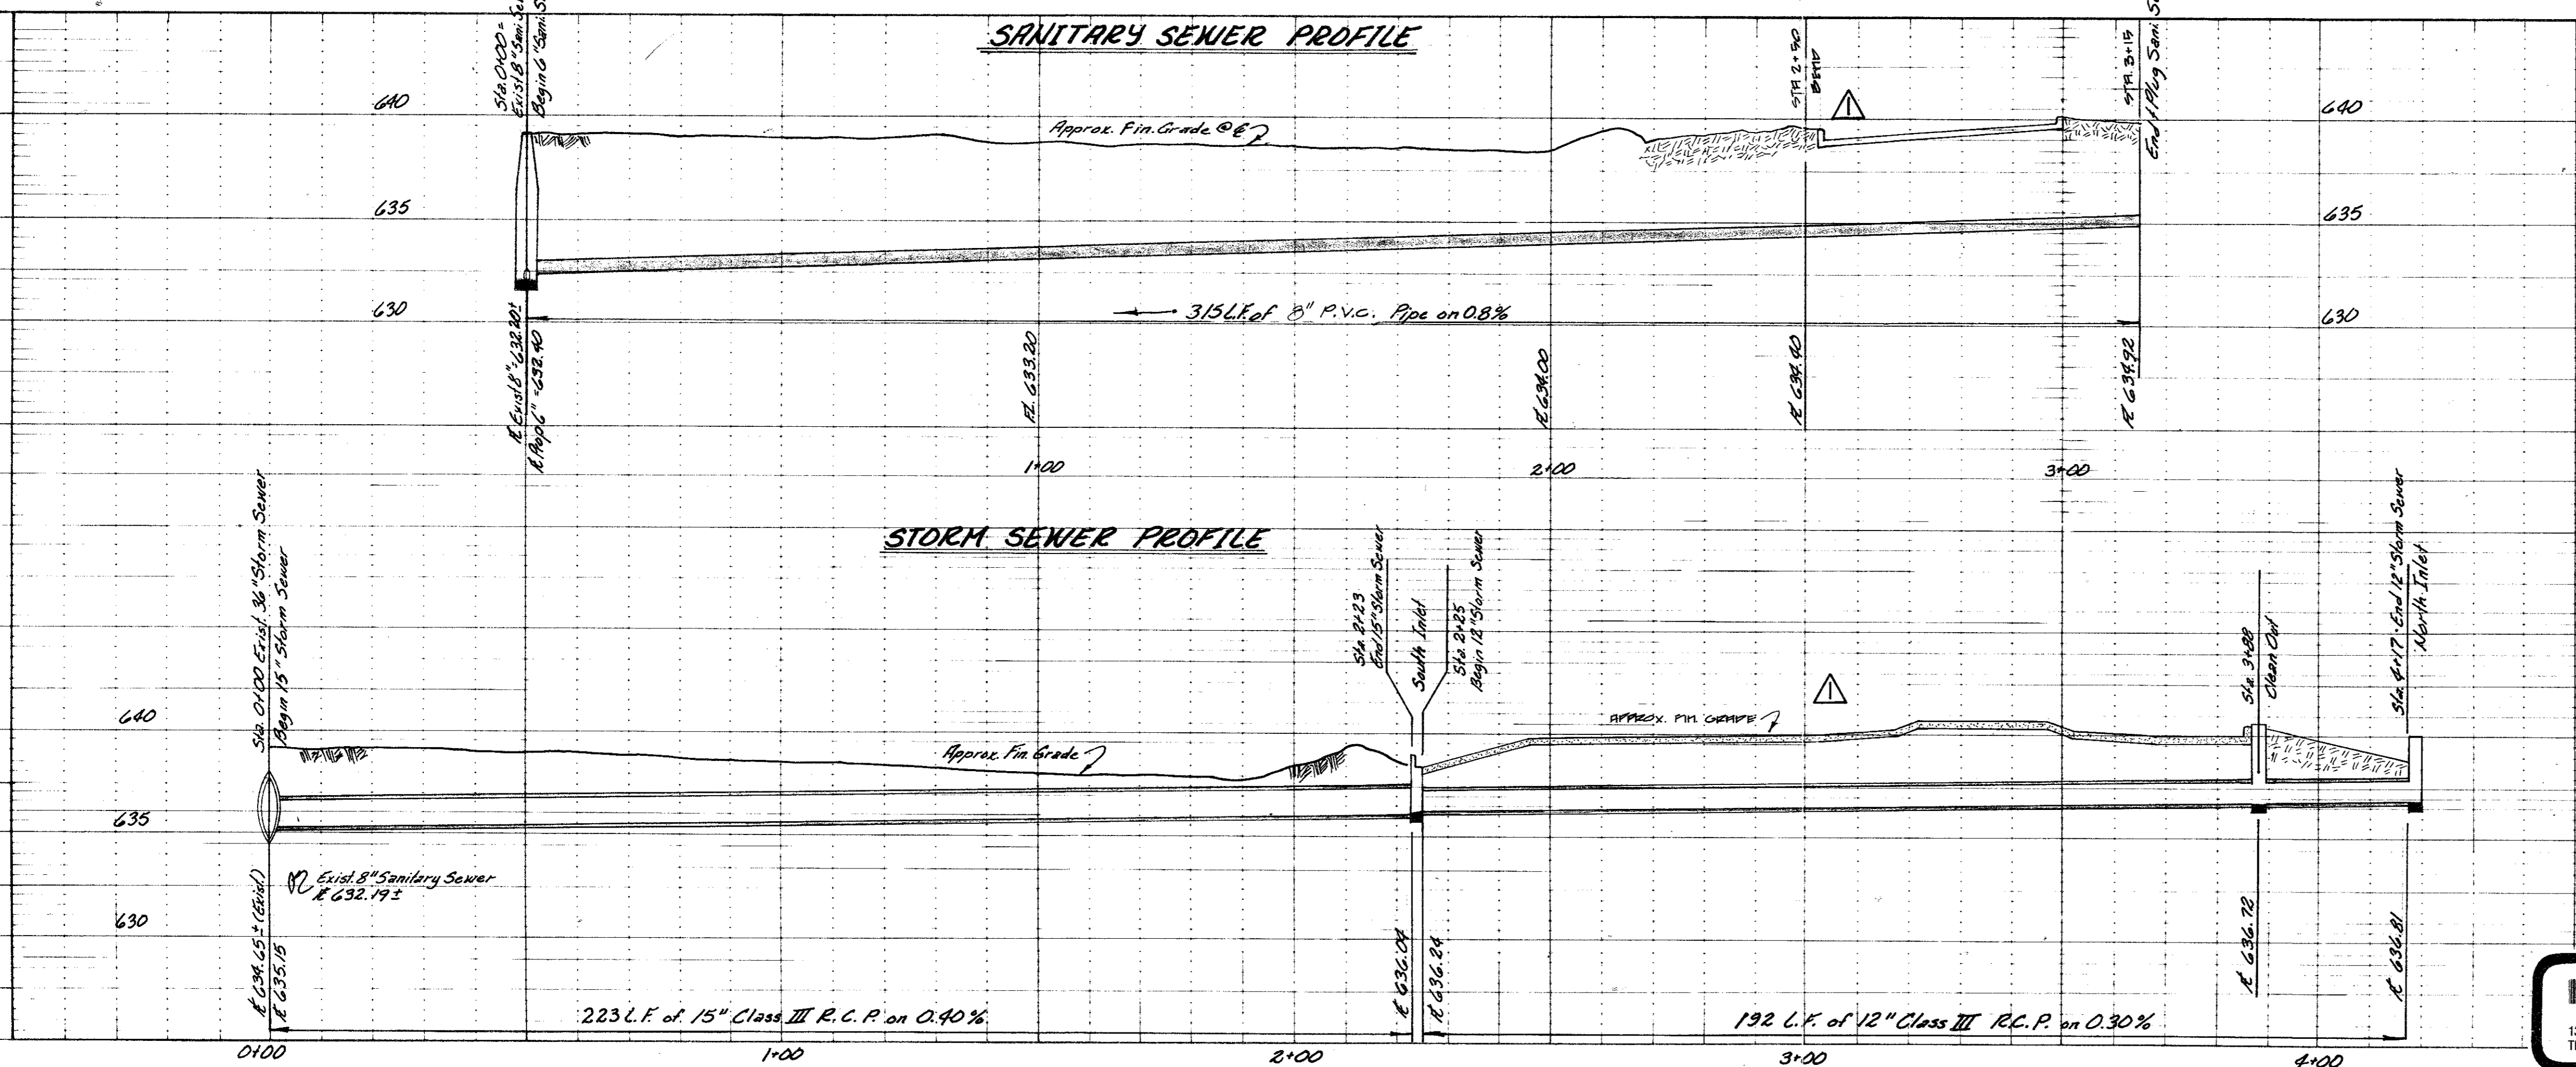


1-15-84 REVISED  
 12-5-83 CONTRACT DOCUMENTS




UTILITIES LAYOUT PLAN & PROFILE QUORUM 14881						
ADDISON PUBLIC WORKS DEPARTMENT CITY OF ADDISON, TEXAS						
DESIGN	DRAWN	DATE	SCALE	NOTES	FILE	NO.
I.E.Inc.	J.P.L.	Oct 83	1"=20' 1"=5' V	I.E.Inc.		C-2

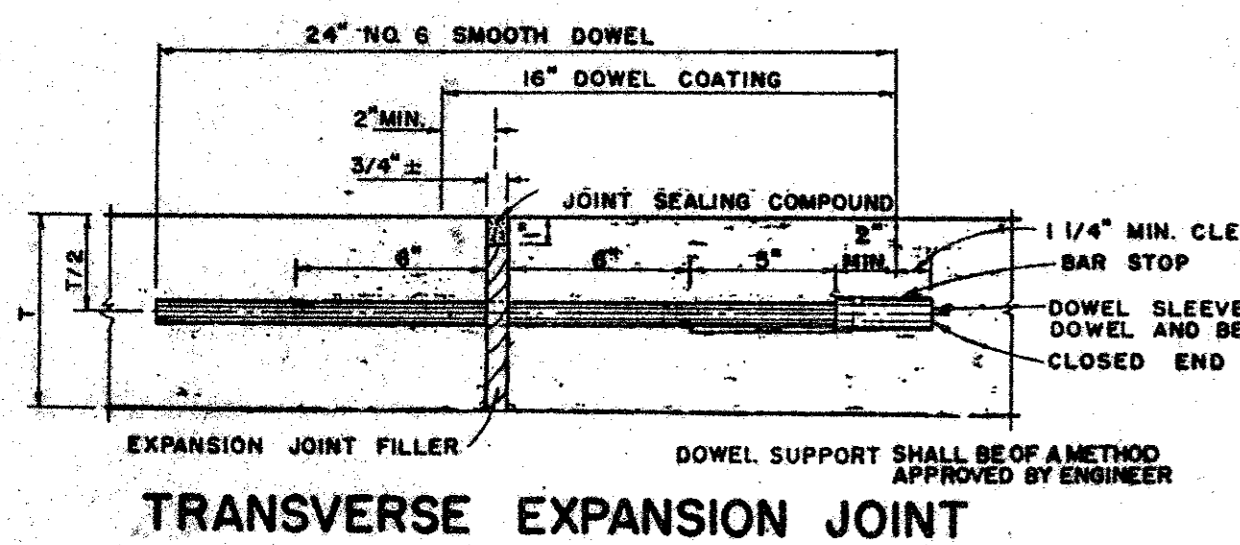


**TRANSVERSE EXPANSION JOINT**

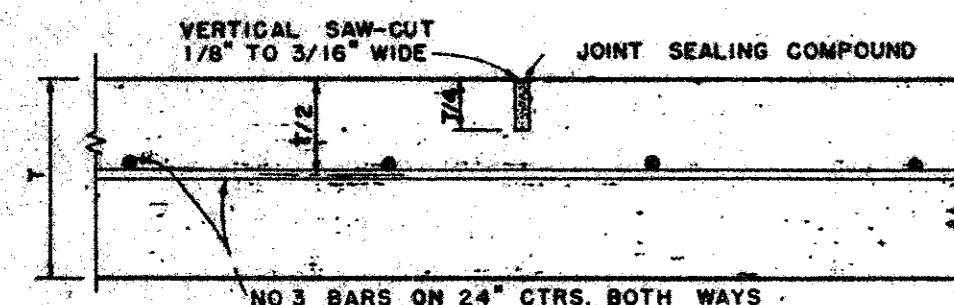


**SAWED DUMMY JOINT**

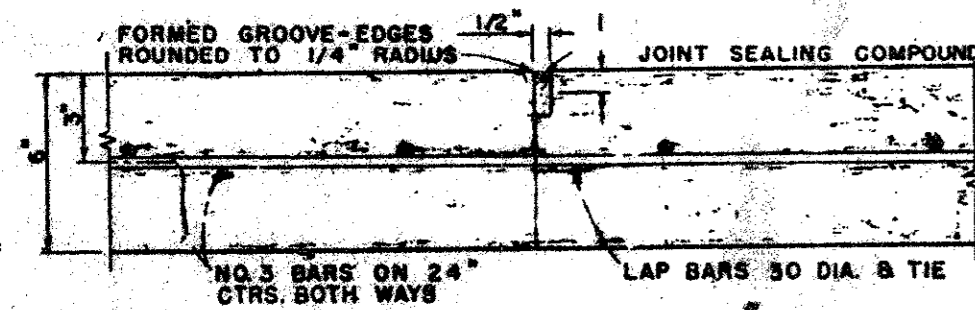


**CONSTRUCTION JOINT**

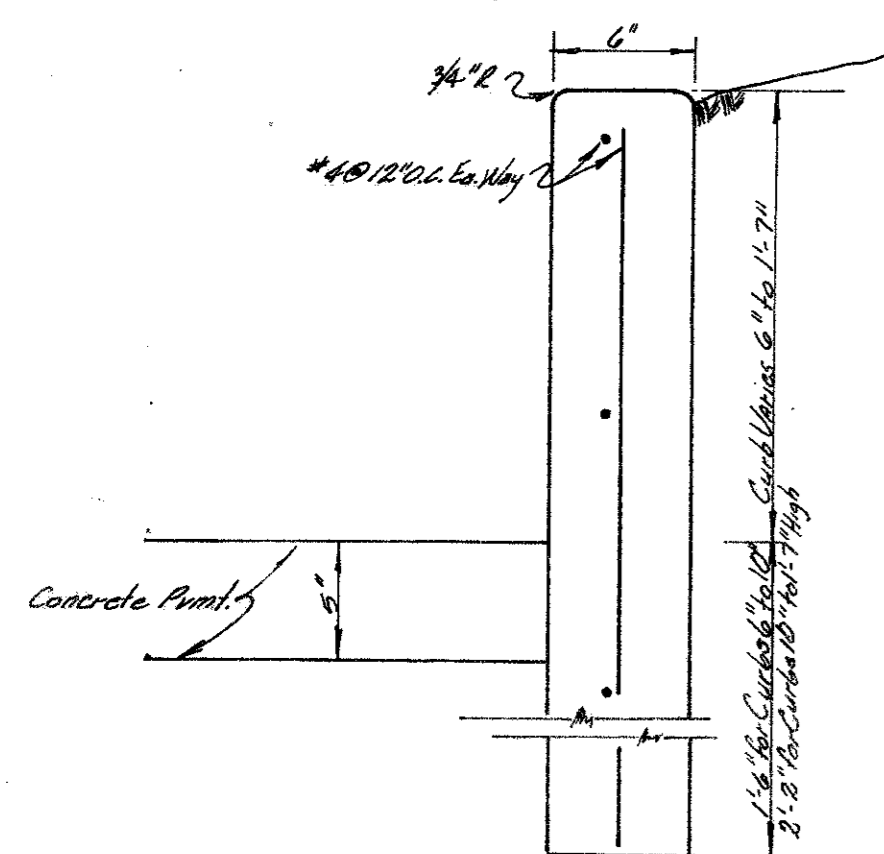


**VARIABLE HEIGHT CURB DETAIL**  
N.T.S.

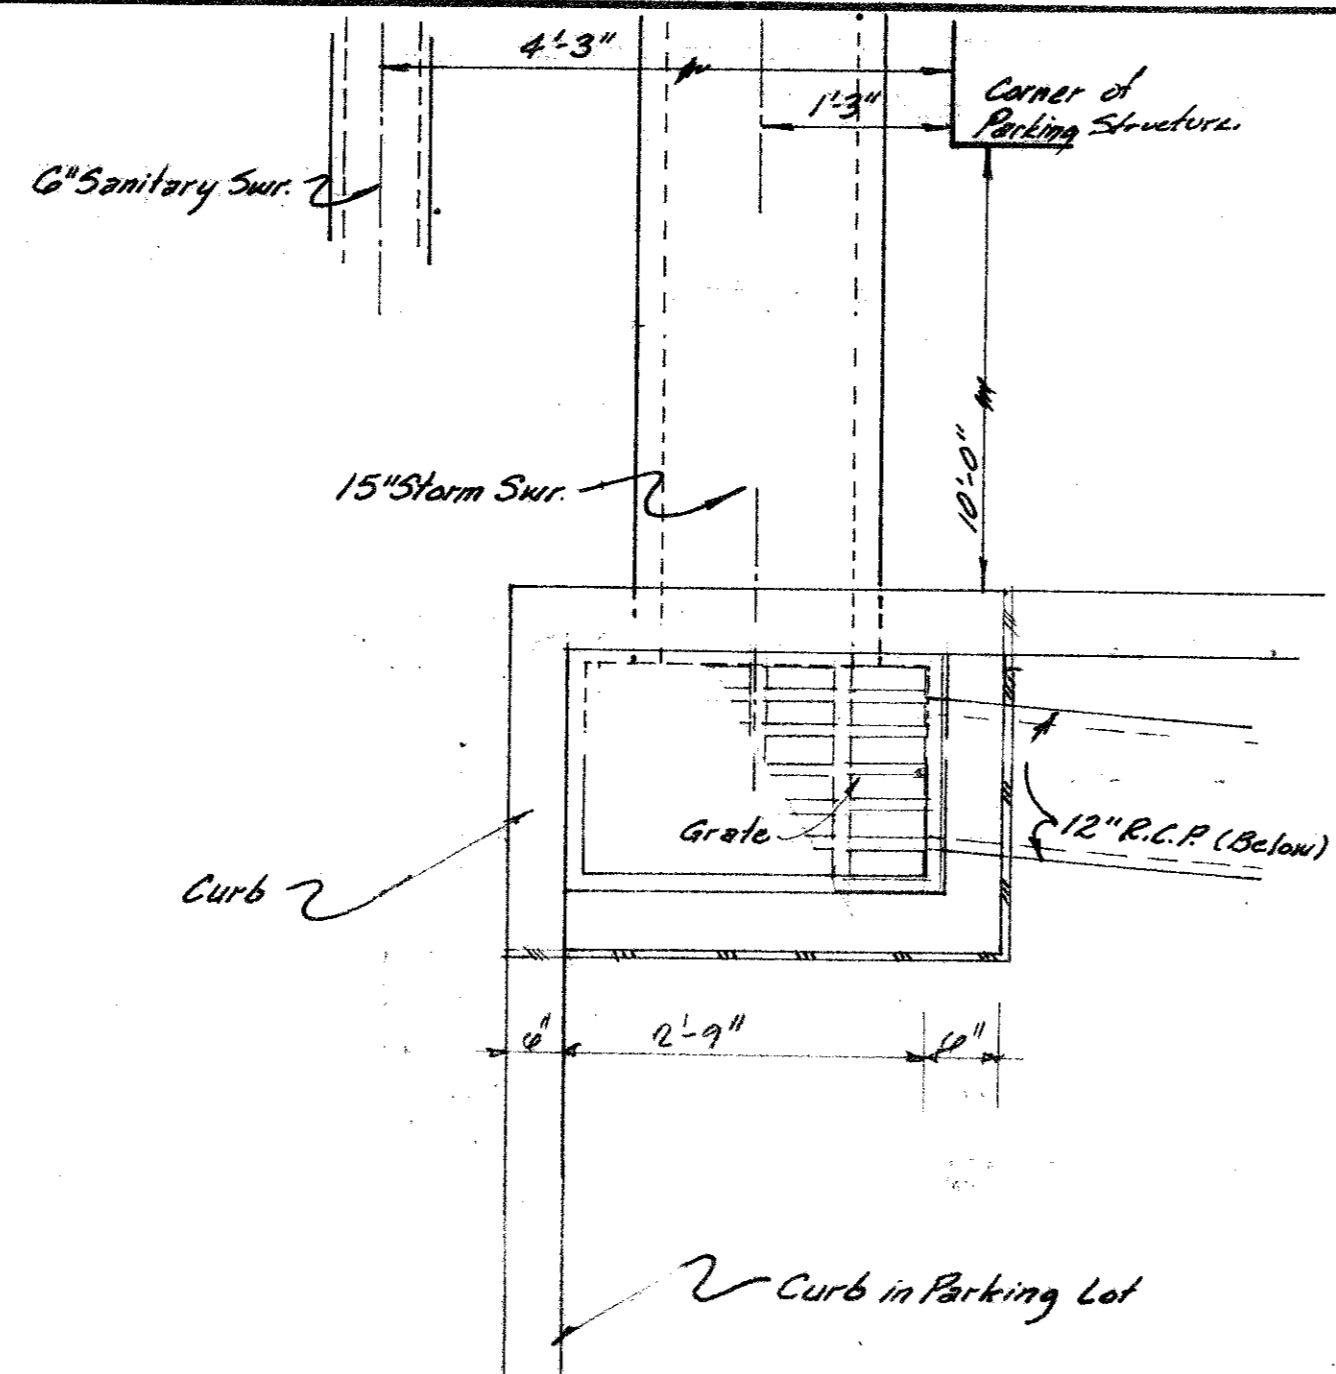


**SOUTH INLET DETAILS**  
Not to Scale

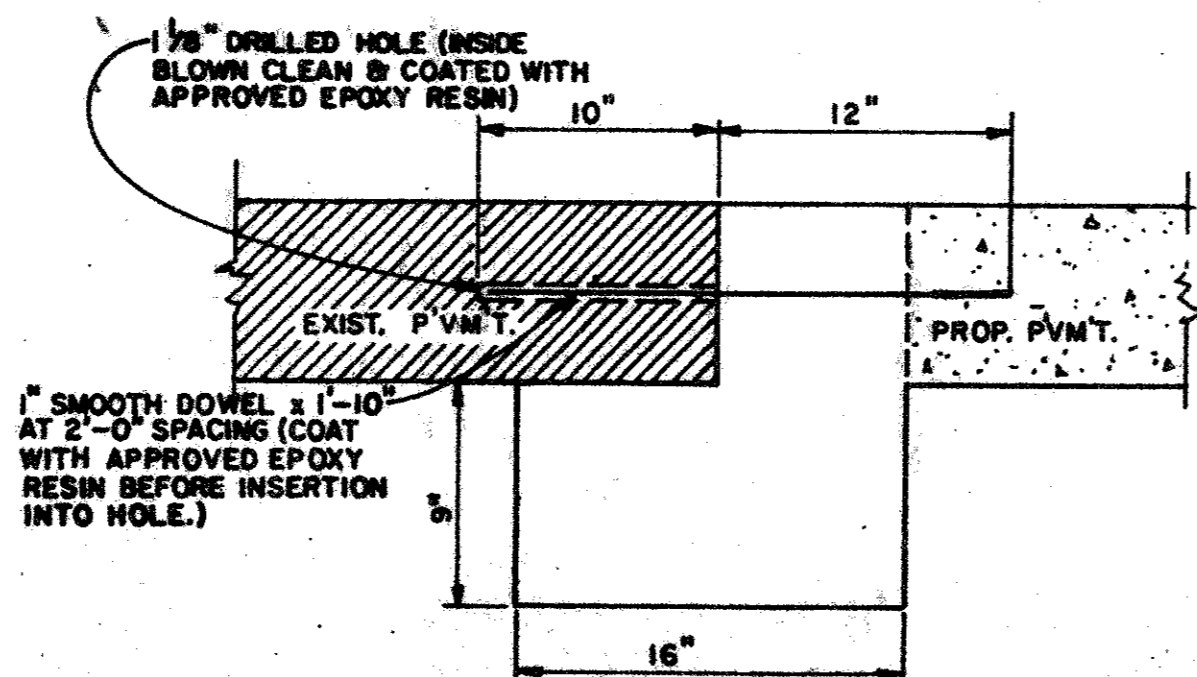


**STREET HEADER DETAIL**

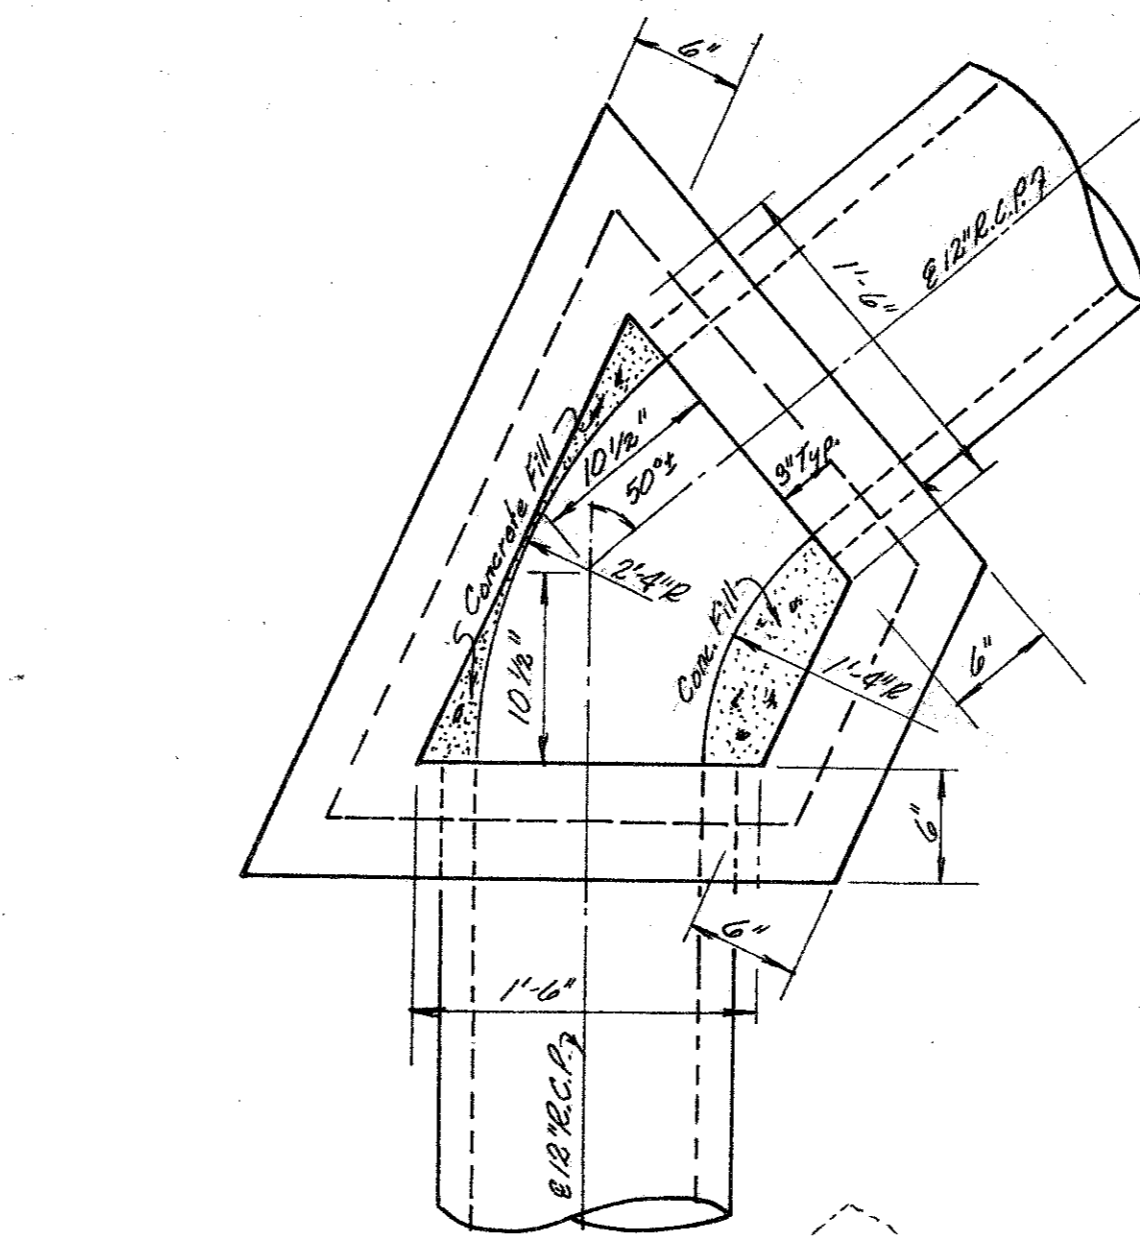


**CLEAN OUT DETAILS**  
N.T.S.

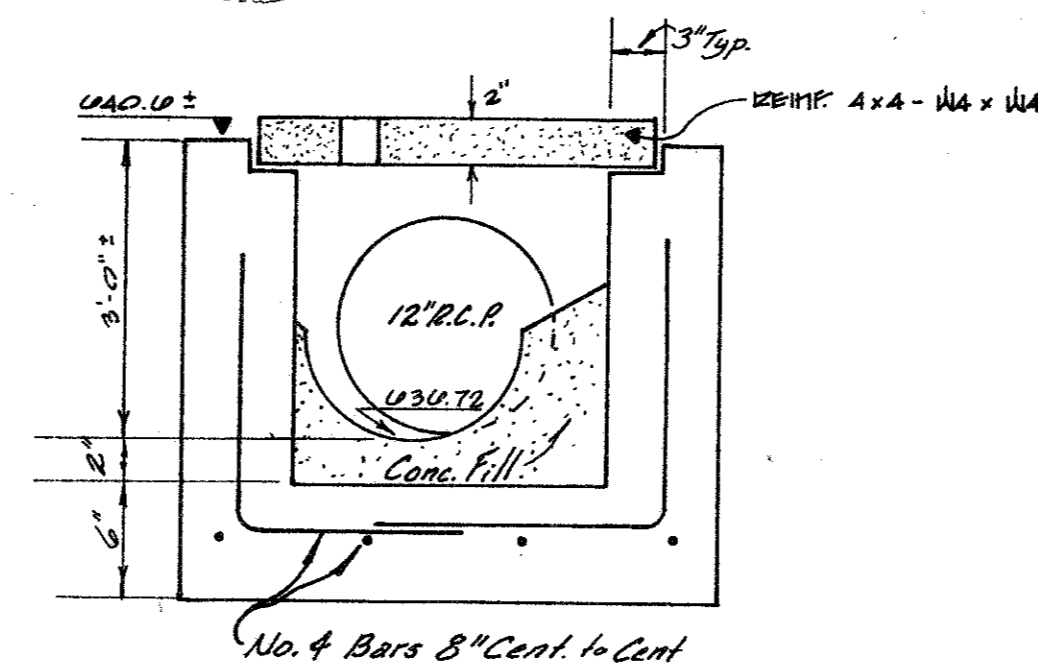

REVISER 11-9-83

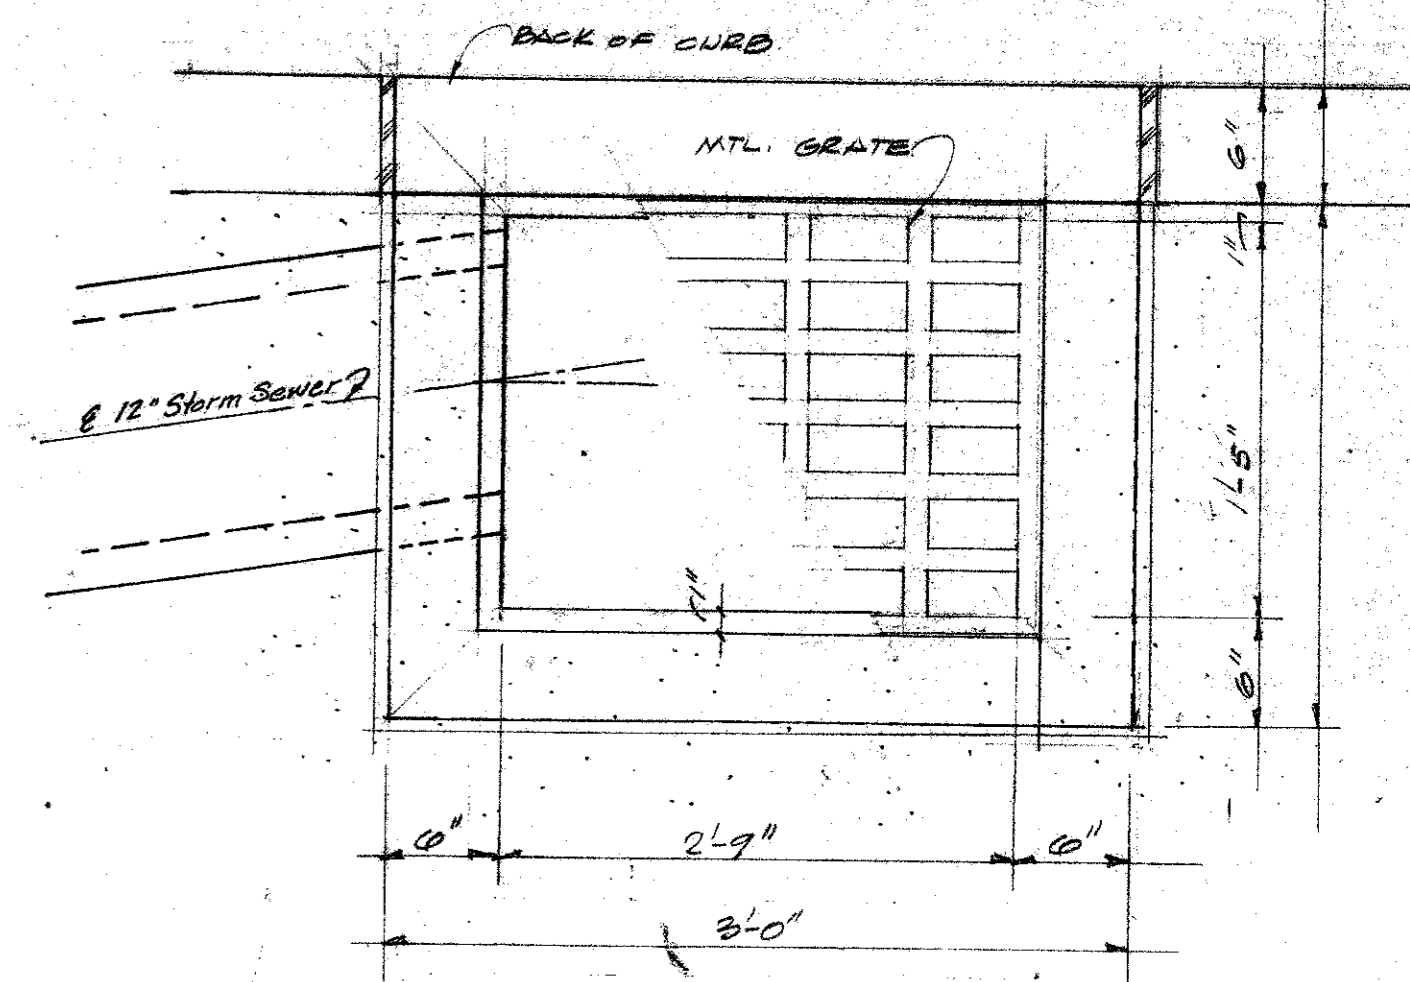


**PLAN**

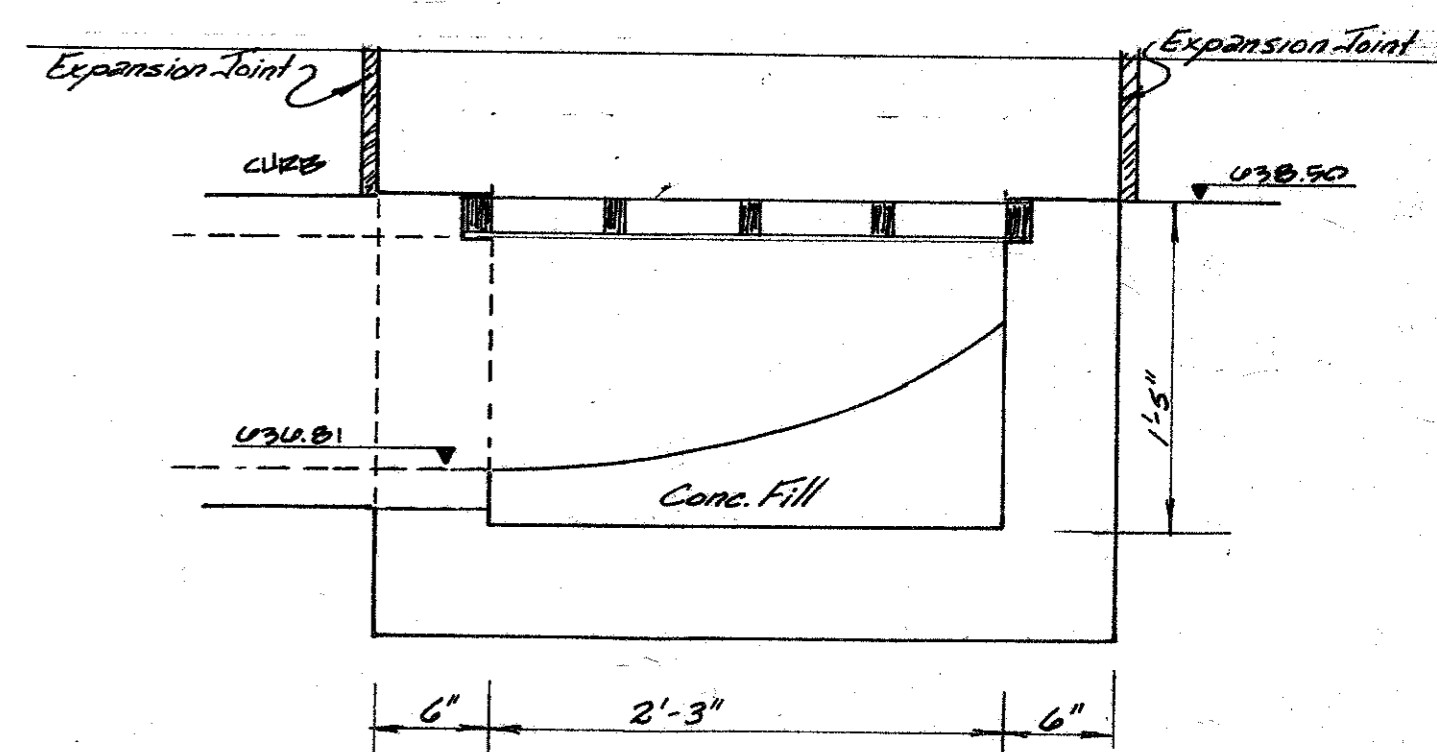


**SECTION**

**NORTH INLET DETAILS**  
N.T.S.

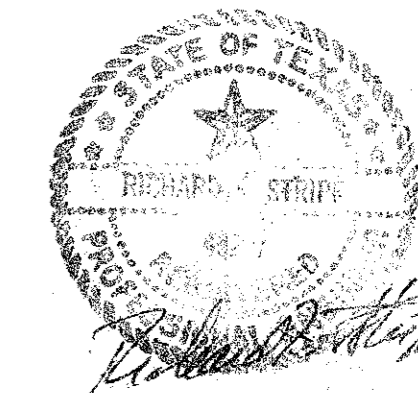

1-18-84 REVISED  
12-5-83 CONTRACT DOCUMENTS  
**Intertech**  
ENGINEERS INC  
13150 COIT ROAD SUITE 125 DALLAS TEXAS 75240  
TELEPHONE 214/699-8000 TELEFAX 73-0455


STANDARD DETAILS						
QUORUM 14881						
ADDISON PUBLIC WORKS DEPARTMENT						
CITY OF ADDISON, TEXAS						
DESIGN	DRAWN	DATE	SCALE	NOTES	FILE	NO.
J.E. Inc.	J.P.L.	Oct. 83	As Noted	I.E. Inc.		C-3

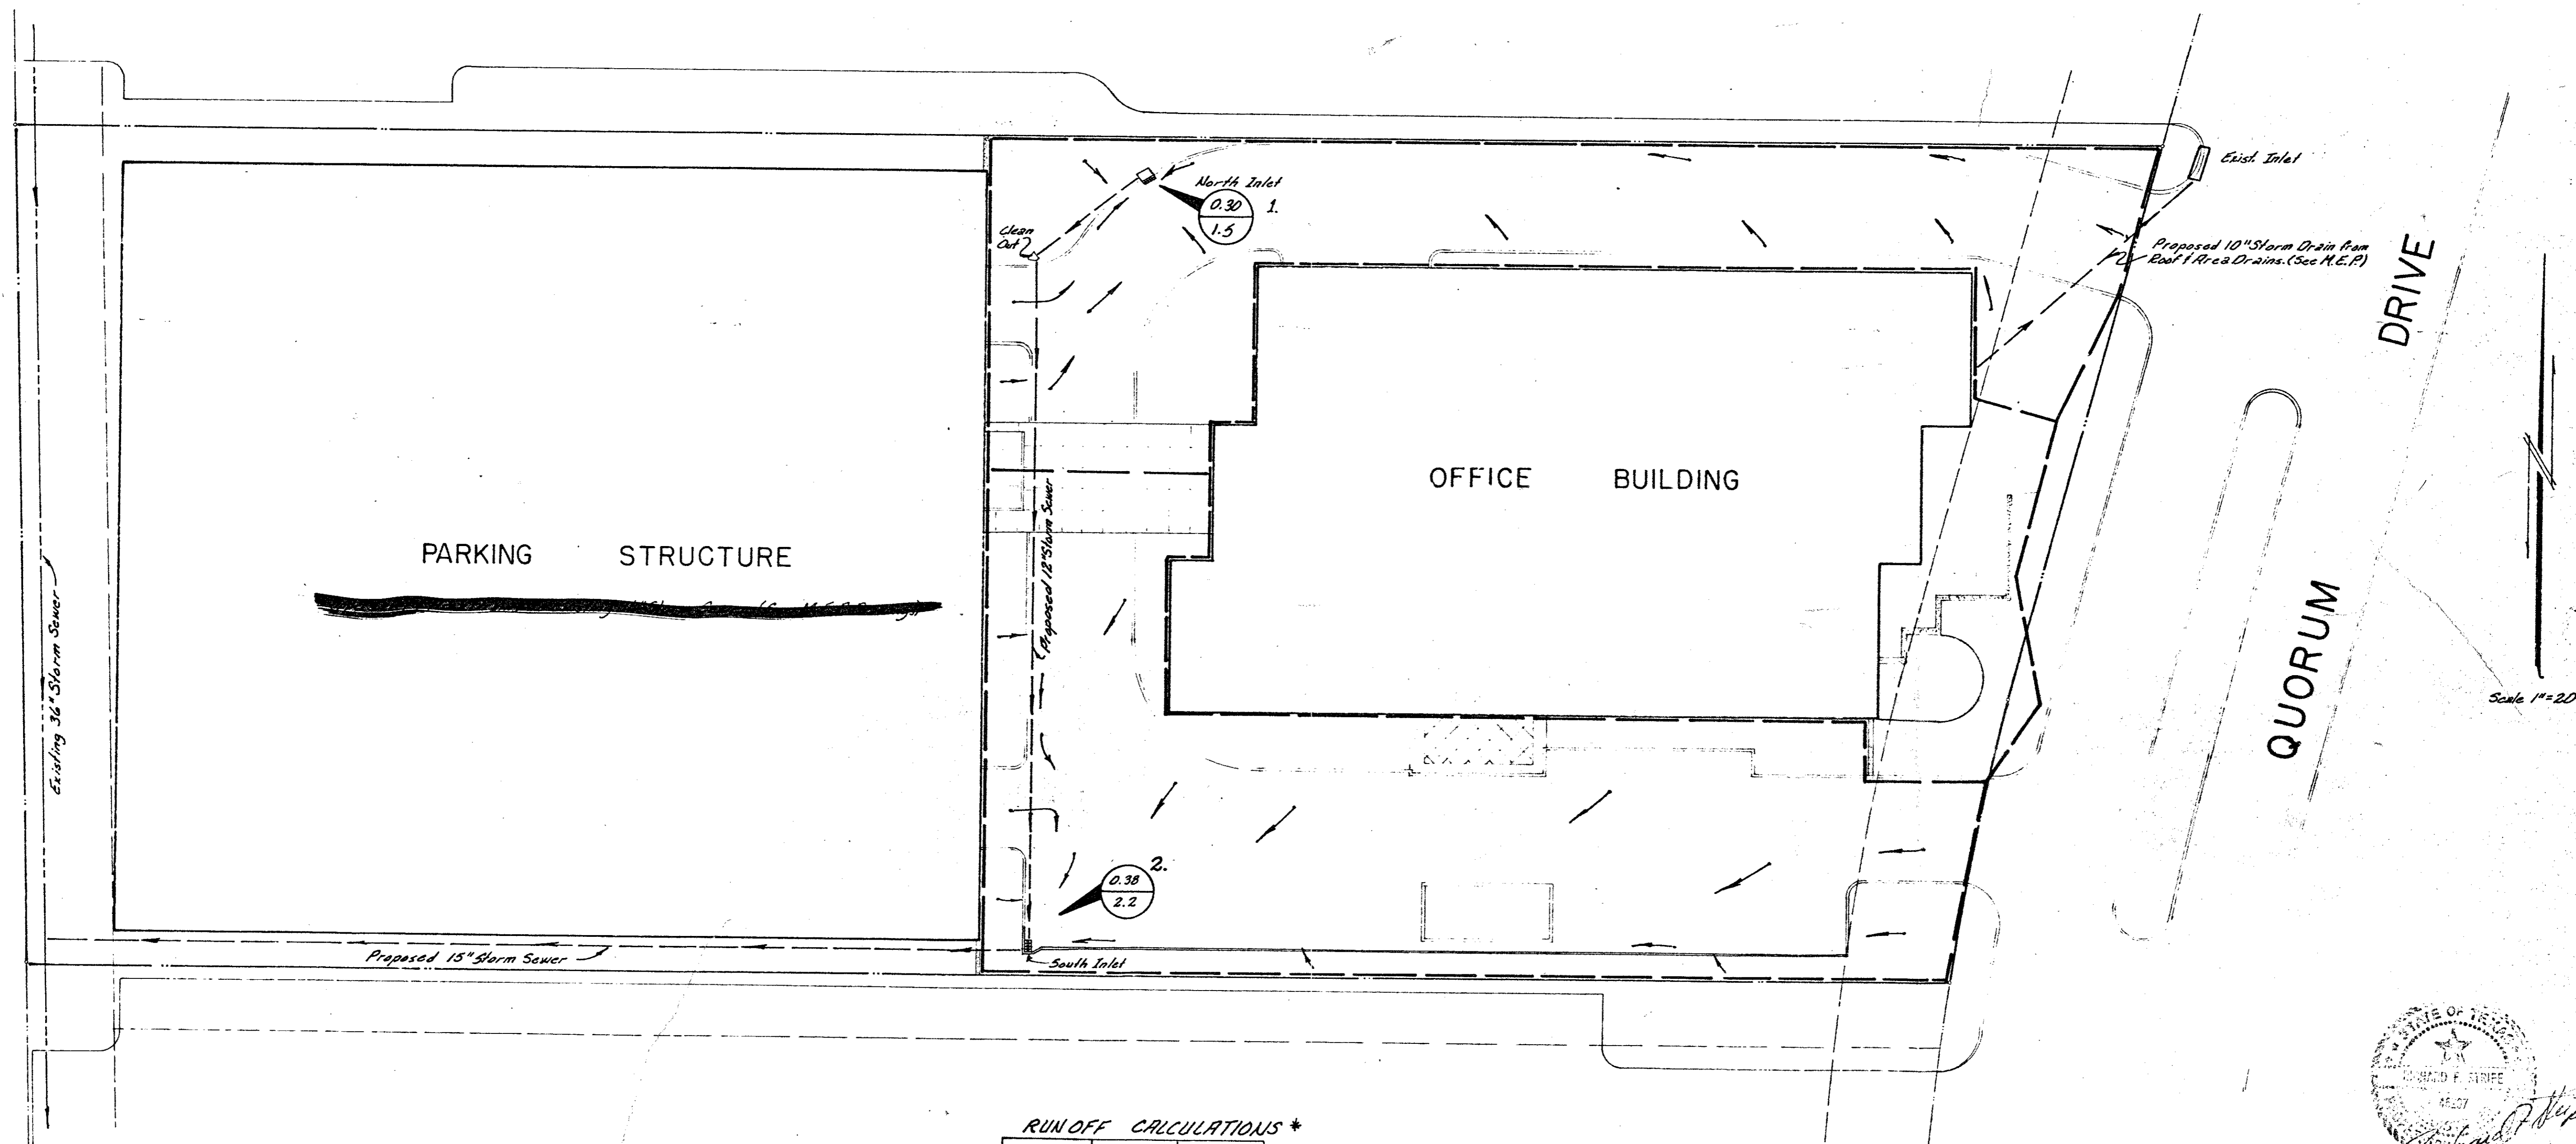

**RUN OFF CALCULATIONS \***

Drainage Area No.	Area (Acres)	Q <sub>25</sub> (c.f.s.)
1	0.26	1.5
2	0.38	2.2

\* Based on Mannings Equation (Q=C.I.R)  
 C= Runoff Coefficient = 0.90  
 I= In./Hr. for 25 yr. Storm & 10 min. Time of Concentration = 6.50

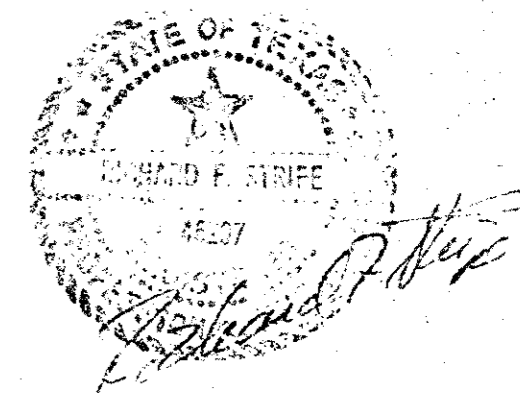

2 21 84 FIELD ORDER #1

**DRAINAGE AREA MAP**

QUORUM 14881

ADDISON PUBLIC WORKS DEPARTMENT  
 CITY OF ADDISON, TEXAS

DESIGN	DRAWN	DATE	SCALE	NOTES	FILE	NO.
J.E.Inc.	JPL	Oct. '83	1"=20'	J.E.Inc.		C4

**Intertech** ENGINEERS INC.  
 13150 COIT ROAD SUITE 125 DALLAS, TEXAS 75240  
 TELEPHONE 214-699-8000 TELEFAX 73-0455