
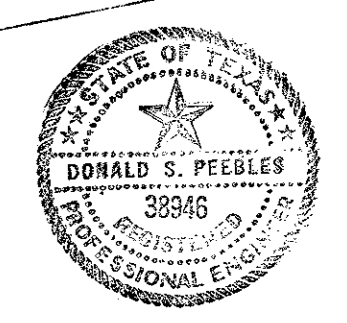
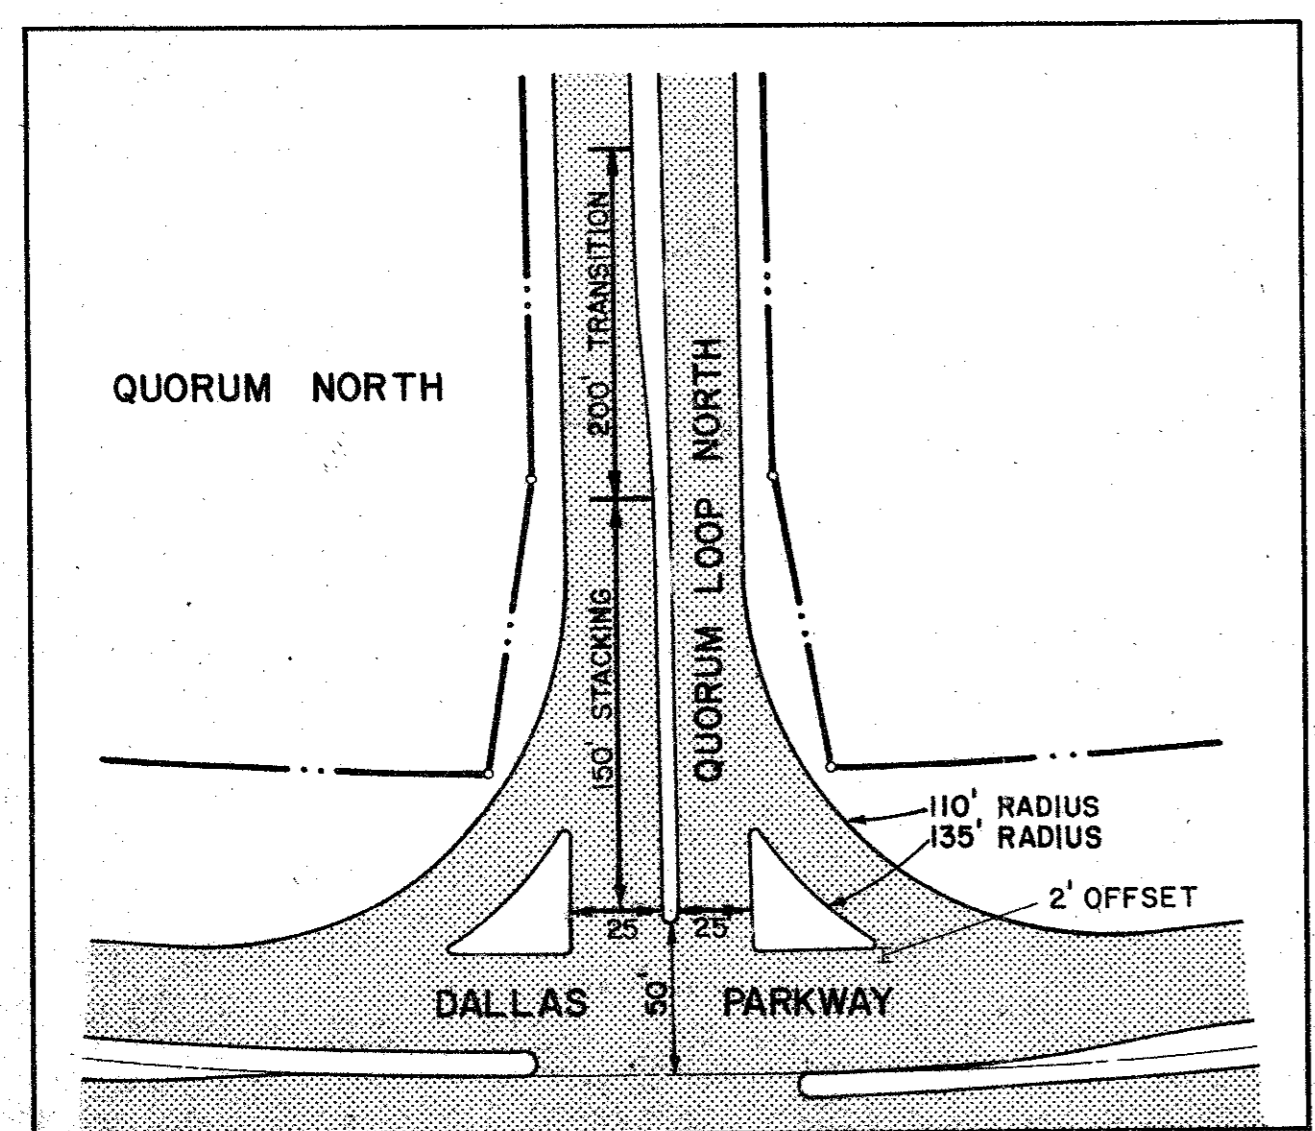


☉ CURVE DATA

C-1	$\Delta = 80^\circ 15' 39''$	C-2	$\Delta = 64^\circ 21' 46''$
	R = 375.19'		R = 230.42'
	T = 316.28'		T = 145.00'
	L = 525.58'		L = 258.84'
	L.C. = 463.65'		L.C. = 245.45'

C-3	$\Delta = 21^\circ 28' 35''$
	R = 790.96'
	T = 150.00'
	L = 296.48'
	L.C. = 294.75'

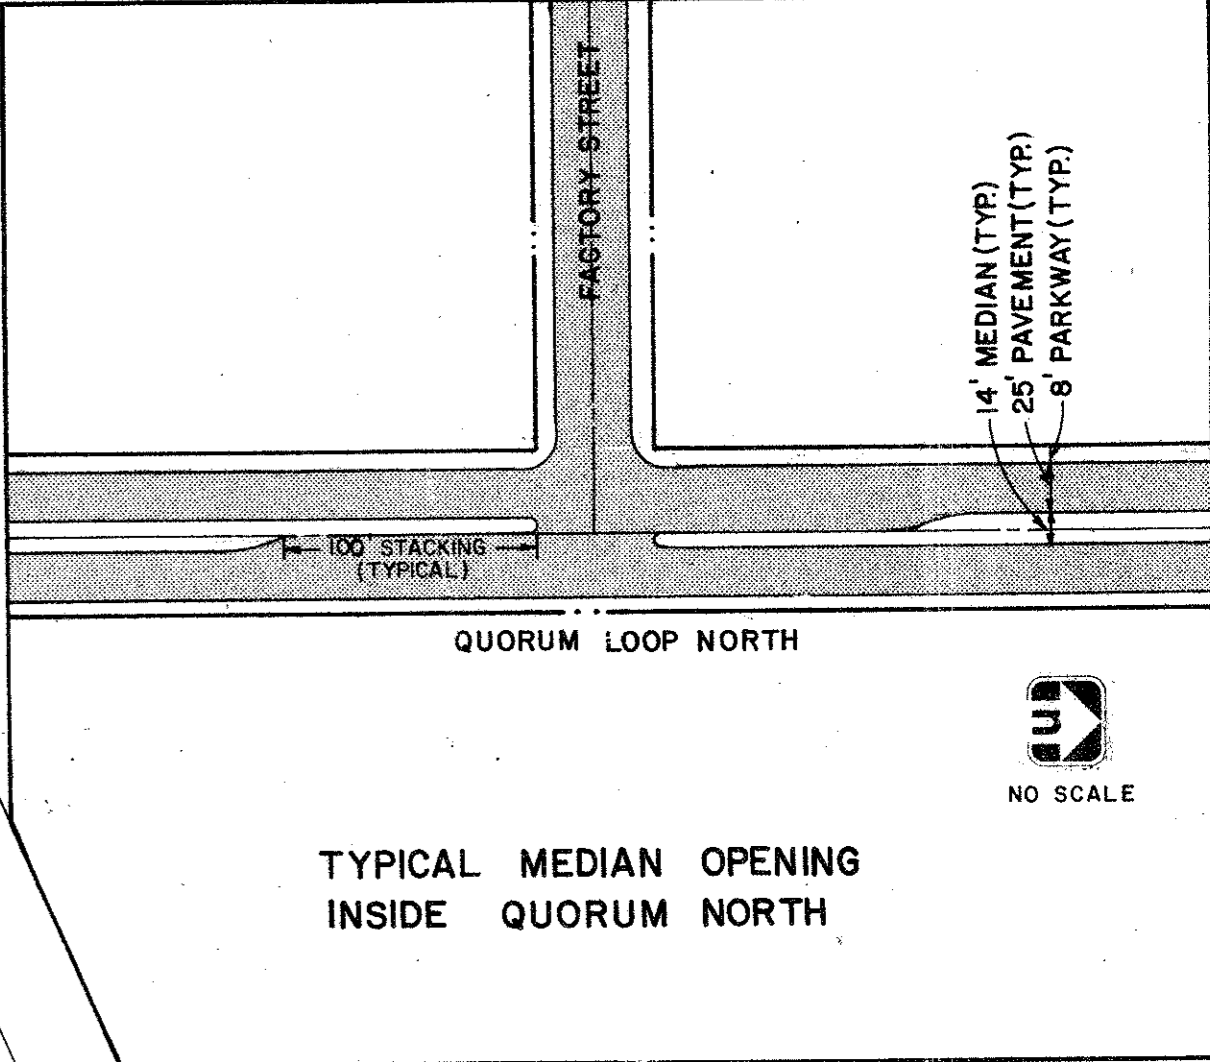

SCALE 1"=100'

PAVING PLAN - QUORUM LOOP NORTH
QUORUM NORTH
 CITY OF ADDISON, TEXAS

Graham Associates, Inc. CONSULTING ENGINEERS & PLANNERS	Date	9-20-79
	File	314-1441
Drawn By: G.A.I.	Sheet 3 Of 19	