



INSTALL 6" MJ GATE VALVE BETWEEN FIRE HYDRANT AND WATER MAIN.

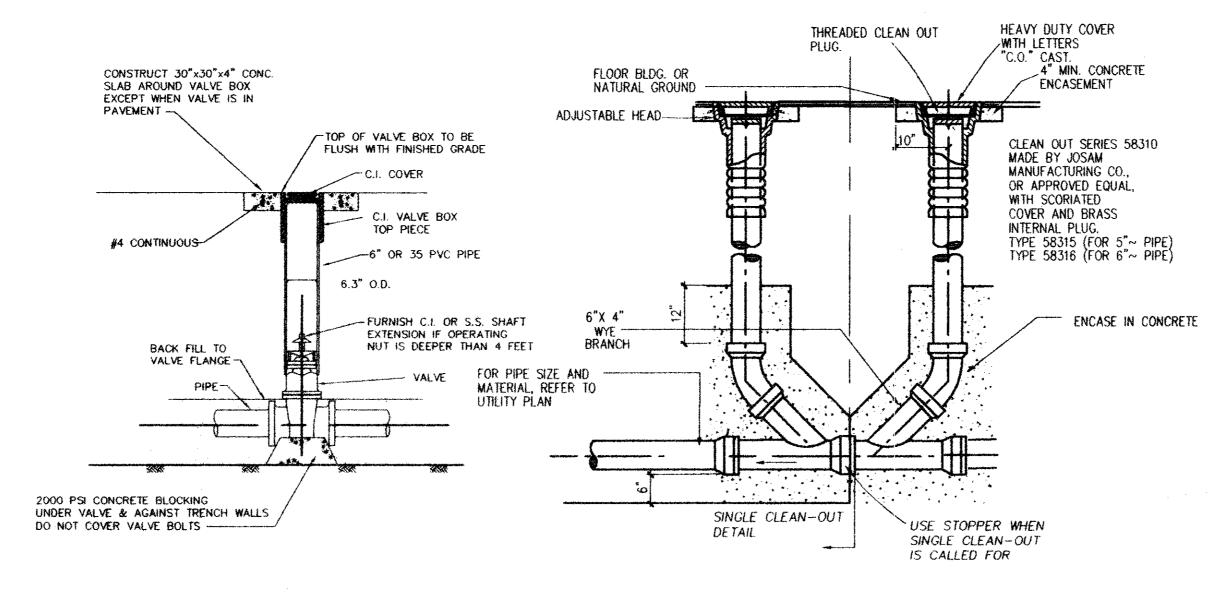


VALVE INSTALLATION DETAIL

SANITARY SEWER DOUBLE CLEAN-OUT SINGLE / DOUBLE

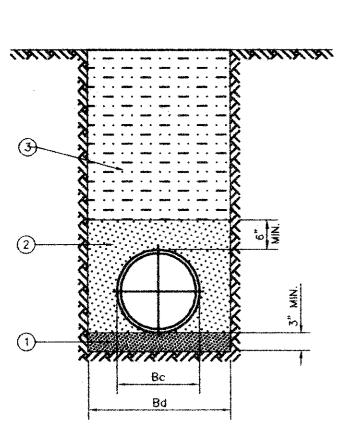


- GRANULAR MATERIAL (SAND) TOP OF LAYER IS TO BE PLACED TO GRADE TO PROVIDE UNIFORM SUPPORT OF PIPE BARREL, EXCAVATE BELL HOLES. COMPACT TO 95% PROCTOR DENSITY.
- GRANULAR MATERIAL (SAND) COMPACT TO 90% STANDARD PROCTOR DENSITY EXCEPT UNDER STRUCTURES, ROADWAYS AND PAVEMENT WHERE 95% DENSITY IS REQUIRED.
- SELECT MATERIAL FREE OF ROCKS, CLUMPS OR DEBRIS LARGER THAN 6" IN GREATEST DIMENSION, COMPACT TO 90% STANDARD PROCTOR DENSITY. UNDER STRUCTURES, ROADWAYS AND PAVEMENT, COMPACT TO 95% STANDARD PROCTOR DENSITY.

CLASS "C-2" EMBEDMENT

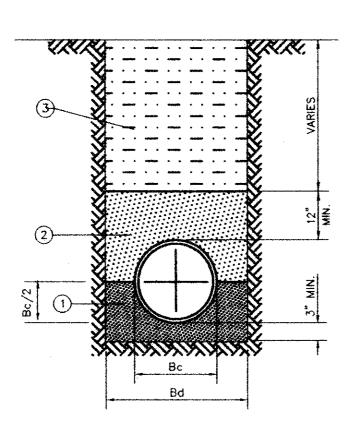


- FINE GRADATION CRUSHED STONE TOP LAYER IS TO BE PLACED TO GRADE TO PROVIDE UNIFORM SUPPORT OF PIPE BARREL. EXCAVATE BELL HOLES.
- SELECT MATERIAL FREE OF ROCKS, CLUMPS OR DEBRIS LARGER THAN 6" IN GREATEST DIMENSION. COMPACT TO 90% STANDARD PROCTOR DENSITY. UNDER STRUCTURES, ROADWAYS AND PAVEMENT, USE GRANULAR MATERIAL (SAND) COMPACTED TO 95% STANDARD PROCTOR DENSITY.
- SELECT MATERIAL FREE OF ROCKS, CLUMPS OR DEBRIS LARGER THAN 6" IN GREATEST DIMENSION. COMPACT TO 90% STANDARD PROCTOR DENSITY. UNDER STRUCTURES, ROADWAYS AND PAVEMENT, COMPACT TO 95% STANDARD PROCTOR DENSITY.

CLASS "B+" ENBEDMENT SANITARY SEWER AND STORM SEWER

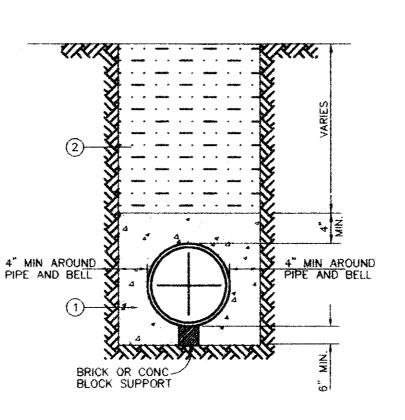


- 3,000 P.S.I. CONCRETE. CONCRETE ENCASEMENT SHALL BEGIN AND END 6 INCHES FROM THE END OF A JOINT
- SELECT MATERIAL FREE OF ROCKS, CLUMPS OR DEBRIS LARGER THAN 6" IN GREATEST DIMENSION. COMPACT TO 90% STANDARD PROCTOR DENSITY. ROADWAYS AND PAVEMENT, COMPACT TO 95% STANDARD PROCTOR DENSITY.

CONCRETE ENCASEMENT DETAIL

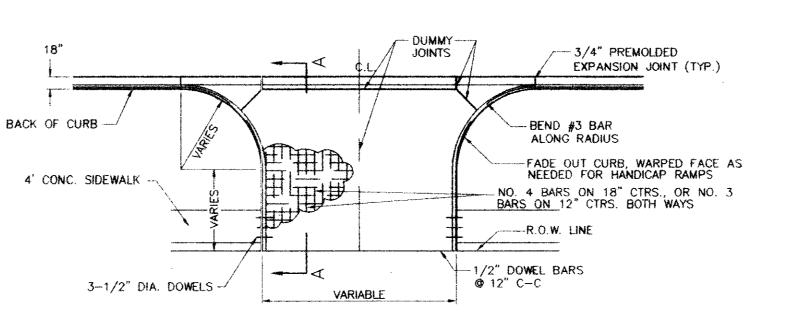


TYPICAL DRIVE APPROACH

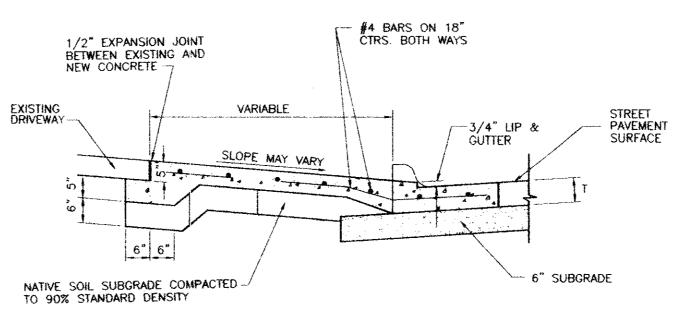


SECTION A-A (FOR TYPICAL DRIVE APPROACH)

SITE DETAILS AS SHOWN

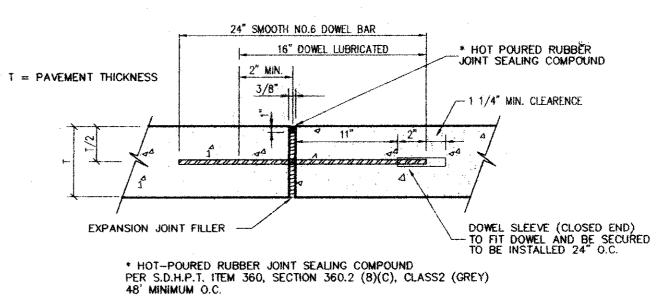


TRANSVERSE EXPANSION JOINT

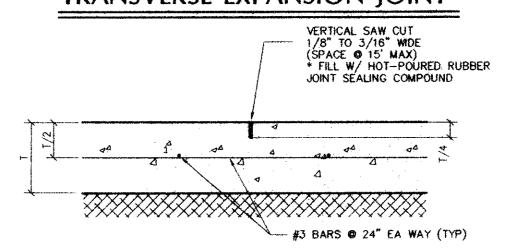


* HOT-POURED RUBBER JOINT SEALING COMPOUND PER S.D.H.P.T. ITEM 360, SECTION 360.2 (8)(C), CLASS2 (GREY)

SAWED DUMMY JOINT DETAIL

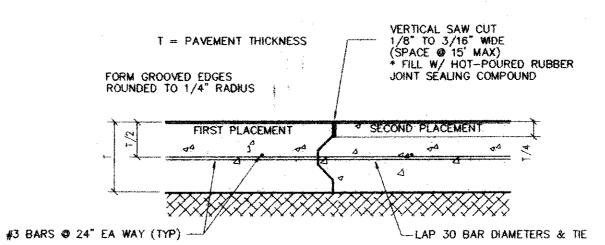


* HOT-POURED RUBBER JOINT SEALING COMPOUND PER S.D.H.P.T. ITEM 360, SECTION 360.2 (8)(C), CLASS2 (GREY)

CONSTRUCTION JOINT DEAIL

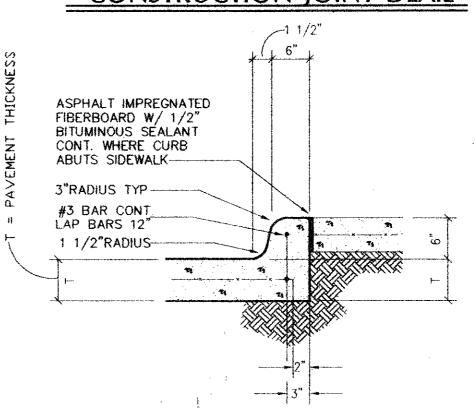

6" MONOLITHIC CONCRETE CURB DETAIL

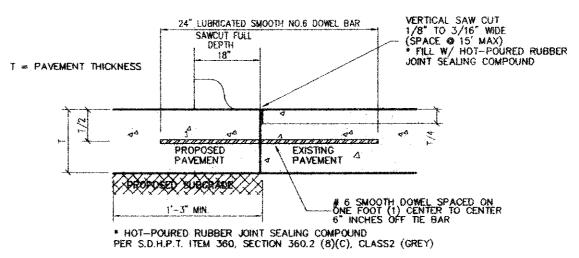

LONGITUDINAL BUTT DETAIL TO BE USED WHERE PROPOSED CONCRETE PAVEMENT

MEETS EXISTING CONCRETE PAVEMENT

- 1. NO. 5 SMOOTH DOWEL BAR MAY BE USED IN 5", 6" AND 7" PAVEMENT THICKNESS.
- 2. LONGITUDINAL BUTT CONSTRUCTION MAY BE UTILIZED IN PLACE OF LONGITUDINAL HINGED (KEYWAY) JOINT AT CONTRACTOR'S OPTION.
- 3. DOWEL BARS SHALL BE DRILLED INTO PAVEMENT HORIZONTALLY BY USE OF A MECHANICAL RIG. DRILLING BY HAND IS NOT APPLICABLE, PUSHING DOWEL BARS INTO GREEN CONCRETE IS NOT ACCEPTABLE.

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Revisions:

Issue Dates:

Review. Permit:

Construction:

AS SHOWN Scale: Drawn By: R. HOWMAN

Checked by: RAH

Project No. 99-590.40

Sheet SP-10

UTILITY NOTES

- 1. PROVIDE GRANULAR FILL FROM BOTTOM OF GREASE TRAP TO PIPE BED.
- 2. INSTALL TWO COMPARTMENT LINT TRAP PER THE TOWN OF ADDISON
- 3. INSTALL 4" PVC SANITARY SEWER LATERAL FROM EXIST. MANHOLE
- 4. DOUBLE CLEAN OUT WITH TRAFFIC LIDS LOCATED AS SHOWN.
- 5. GENERAL CONTRACTOR TO INSTALL 6" TAP PER TOWN OF ADDISON
- 6. INSTALL 1" WATER METER FOR DOMESTIC, 1" WATER METER FOR IRRIGATION, AND BACKFLOW VALVE PER REQUIREMENTS OF THE TOWN OF ADDISON.
- 7. RUN 1" WATER SERVICE LINE FROM METER TO BUILDING.
- 8. ELECTRICAL PANELS.
- 9. INSTALL UNDERGROUND ELECTRICAL SERVICE PER REQUIREMENTS OF
- 10. TRANSFORMER AND TRANSFORMER PAD BY T.U. ELECTRIC. CONTACT T.U
- 11. SERVICE TO METER BY LONE STAR GAS COMPANY. CONTACT LONE STAR GAS 48 HOURS PRIOR TO CONSTRUCTION AND FOR LINE LOCATIONS CONTACT DIG TEST # 1-800-344-8377.
- 12, GAS METER BY LONE STAR GAS COMPANY, CONTACT COMM. SALES FOR METER @ (817) 285-0930.
- 13. GENERAL CONTRACTOR TO INSTALL 4" PVC IN 27.0' L.F. BORE UNDER ACCESS DRIVE FOR T.U. ELCTRIC SERVICE.
- 14. CONTRACTOR TO PROVIDE ELECTRICAL SERVICE TO FOR VACUUMS.
- SEE ARCHITECTURAL PLANS FOR SIZE AND LOCATIONS.
- 15. CONTRACTOR TO PROVIDE ELECTRIC FOR SIGN. SEE ARCHITECTURAL PLANS FOR SIZE AND LOCATION.
- 16. 4" P.V.C. SLEEVES INSTALLED BY GENERAL CONTRACTOR.
- 17. GENERAL CONTRACTOR TO INSTALL 2" P.V.C. SLEEVE FOR IRRIGATION TIME CLOCK, STUB UP IN MECHANICAL ROOM.
- 18. GENERAL CONTRACTOR TO INSTALL 4" TAPPING SLEEVE PER THE CITY OF ADDISON REQUIREMENTS.
- 19 RUN UNDERGROUND TELEPHONE LINE PER THE REQUIREMENTS OF SOUTHWESTERN BELLTELEPHONE COMPANY OR LOCAL UTILITY COMPANY.
- 20. GENERAL CONTRACTOR TO INSTALL 6" DOUBLE CHECK VALVE PER CITY OF
- 21. GENERAL CONTRACTOR TO INSTALL 6" PVC FIRE LINE PER CITY OF ADDISON REQUIREMENTS. STUB OUT 2 FEET INSIDE BUILDING.
- 22. GENERAL CONTRACTOR TO INSTALL 6" TAPPING SLEEVE AND VALVE PER THE
- CITY OF ADDISON REQUIREMENTS. 23. GENERAL CONTRACTOR TO INSTALL 6" WATER LINE IN 29.0' L.F. BORE UNDER
- ACCESS DRIVE FOR WATER SERVICE.
- 24. GENERAL CONTRACTOR TO INSTALL 2-45 BENDS UNDER EXISTING STORM SEWER.
- 25. GENERAL CONTRACTOR TO INSTALL 1" WATER LINE IN 18.0' L.F. CONCRETE ENCASEMENT. SEE DETAIL SHEET SP-10.

SANITARY SEWER NOTES

CONTRACTOR SHALL NOTIFY ALL UTILITY COMPANIES AND OTHERS WHO MAY HAVE BURIED EQUIPMENT OR PIPELINES IN THE VICINITY OF CONSTRUCTION PRIOR TO COMMENCING CONSTRUCTION. DAMAGE TO EXISTING UTILITIES SHALL BE REPAIRED AT THE CONTRACTOR'S EXPENSE.

CONTRACTOR SHALL VERIFY THE LOCATION AND DEPTH OF TIE-IN TO EXISTING SEWER SYSTEM PRIOR TO CONSTRUCTION OF LINES.

RELATED APPURTENANCES SHALL CONFORM TO THE MATERIAL AND UNLESS OTHERWISE REQUIRED, ALL SANITARY SEWER PIPE, MANHOLES, AND CONSTRUCTION SPECIFICATIONS AS SET FORTH IN THE TOWN OF ADDISON STANDARD SPECIFICATIONS.

PARTICULAR ATTENTION SHALL BE PAID TO THE INSTALLATION, EMBEDMENT, AND BACK FILL OF SEWER PIPE.

SEWER PIPE SHALL BE 4" PVC SDR 35.


CONTRACTOR SHALL MEET ALL O.S.H.A. REQUIREMENTS REGARDING TRENCH SAFETY IN THE CONSTRUCTION OF THIS SEWER MAIN.

WATER DISTRIBUTION SYSTEM MATERIAL AND CONSTRUCTION SHALL CONFORM TO THE TOWN OF ADDISON STANDARDS.

ALL LINES SHALL BE BURIED A MINIMUM DEPTH OF 42" BELOW TOP OF ADJACENT CURB OR AS DIRECTED BY THE ENGINEER.

WATER PIPE SHALL BE PVC GLASS 150 (C-900). CONTRACTOR SHALL EXTEND SERVICE AS SHOWN, PROVIDE CURB STOPS AS

CONTRACTOR SHALL NOTIFY ALL UTILITY COMPANIES PRIOR TO COMMENCING CONSTRUCTION. DAMAGE TO EXISTING UTILITIES SHALL BE REPAIRED AT CONTRACTOR'S EXPENSE.

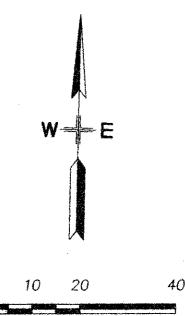

Scale 1" = 20'

UTILITIES HAVE BEEN PLOTTED FROM AVAILABLE MAPS AND RECORDS AND THEREFORE, THIER LOCATIONS ARE APPROXIMATE ONLY. ELEVATIONS SHOWN ARE BASE ON FIELD MEASUREMENTS. THERE MAY BE OTHER UTILITIES, THE EXISTENCE OF WHICH ARE NOT KNOWN TO THE UNDERSIGNED. SIZE AND LOCATION OF ALL UNDERGROUND UTILITIES MUST BE VARIFIED PRIOR TO ANY CONSTRUCTION.

UTILITY PLAN









Revisions:

Issue Dates

Construction

Scale 1" - 20" Drawn By: RHOWMAN

Checked by: RAH.

Project No. 99-590.40

Sheet SP-2