


- General Notes:
- Contractors Are Responsible For Keeping The Existing Pavement Of Proton Drive & Les Lacs Ave. Clean During Construction.
 - Greenbelt Area To Be Restored To Original Condition Or Better If Disturbed By Construction.

CONSTRUCTION NOTES:


- Hay bales shall be installed a minimum of 4" into the ground.
- Contractor will install additional erosion control where erosion protection is needed as per the owners engineers, or the Town of Addison Inspector.
- The existing vegetation along existing parkways and medians shall be replaced to its original condition or better.
- All drainage swales shall be grassed as per Town Standards, prior to the City acceptance of project.
- All construction erosion control shall meet Town of Addisons Ordinance.
- Install grass in all new parkway as per Town Standards.

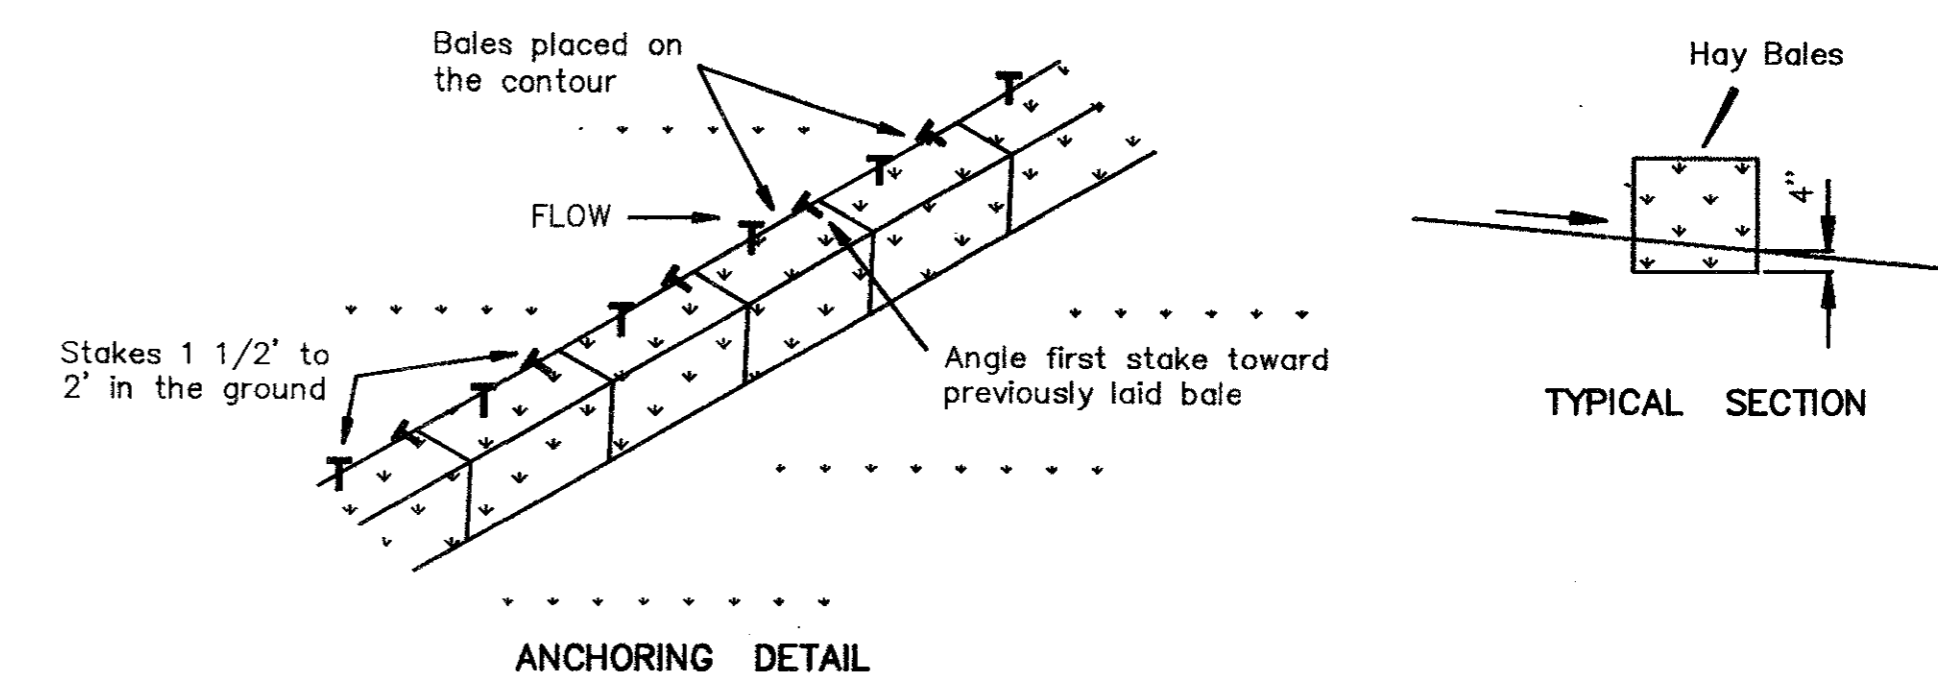

TYPICAL HAY BALE PLACEMENT



Not To Scale

Place Hay Bales As Shown

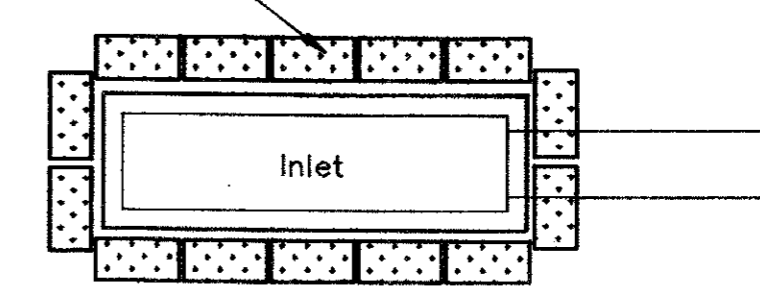

Not To Scale

- Bench Mark 1
" " Top of concrete footing of Southwest corner of tower #12-3W-T291. Elev. 619.46
- Bench Mark 2
" " Top of curb South side of Proton Drive, 400' East of Les Lacs Ave. Elev. 611.31(Set)
- Bench Mark 3
" " Top of concrete footing of Northwest corner of tower #12-3W-T290. Elev. 613.08

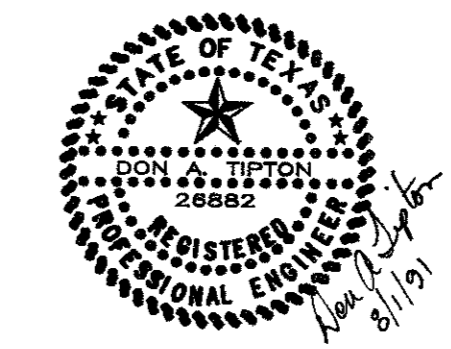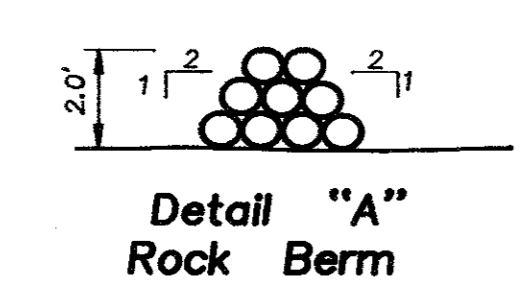

| | | | | | | |
|---|-------------|------|--------|-------|------------------------|-----|
| EROSION CONTROL | | | | | | |
| WATERVIEW ESTATES | | | | | | |
| Town Of Addison, Texas | | | | | | |
| DON A. TIPTON, INC. CONSULTING ENGINEERS | | | | | | |
| 6330 Belt Line Rd. ~ Suite C ~ Garland, Texas 75043 | | | | | | |
| DESIGN | DRAWN | DATE | SCALE | NOTES | FILE | NO. |
| d.a.t. inc. | d.a.t. inc. | 7/91 | 1"=60' | d.b. | Waterview Estates 3626 | 8 |

8RB