

COTTON BELT REGIONAL RAIL SYSTEM SEGMENT 2 BRIDGE & STREET MODIFICATIONS MIDWAY ROAD BRIDGE (#22) MIDWAY ROAD GRADE SEPARATED CROSSING

**PRELIMINARY ENGINEERING - 30% DESIGN
OCTOBER 28, 2019**



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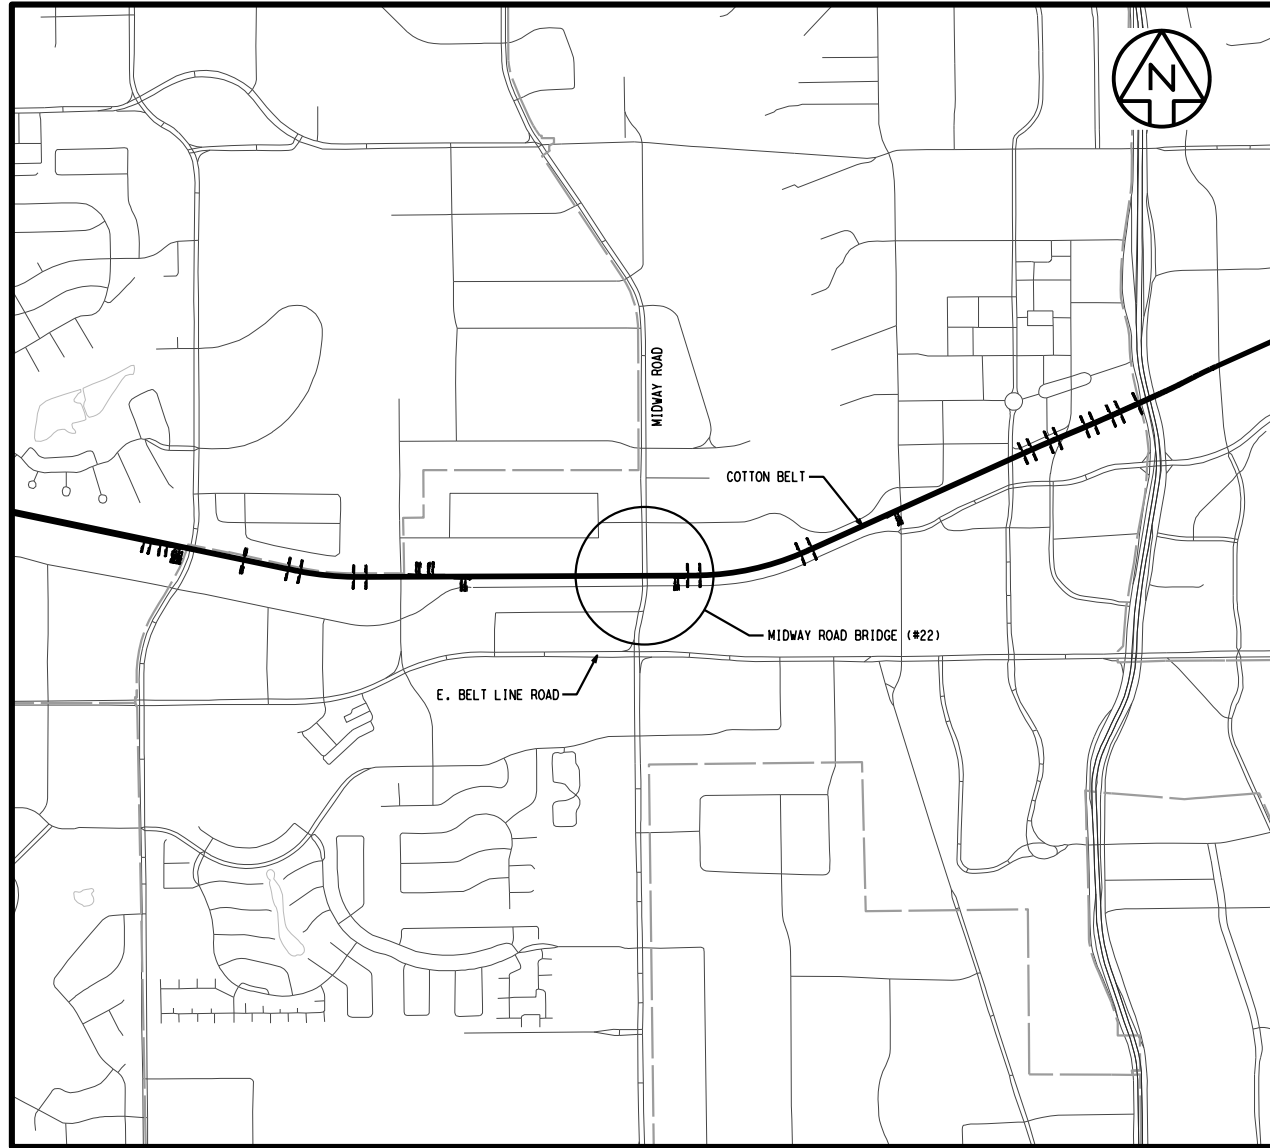
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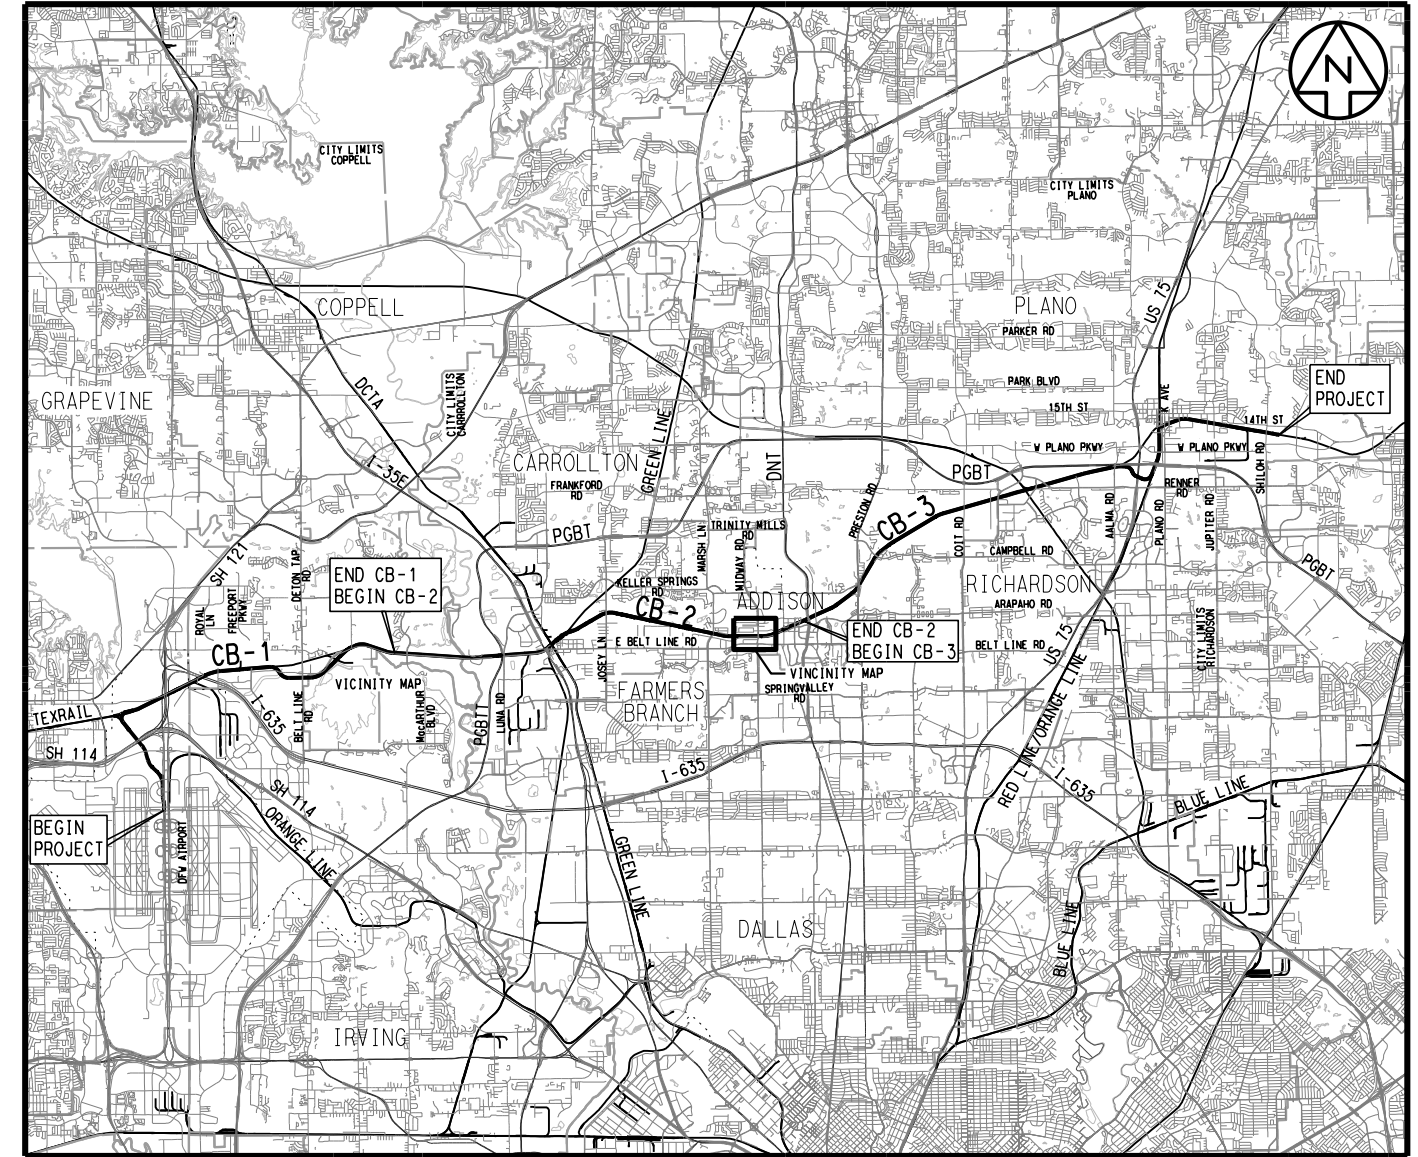
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VICINITY MAP
NO SCALE



KEY MAP
DART RAIL TRANSIT SYSTEM
NO SCALE

COTTON BELT REGIONAL RAIL SYSTEM SEGMENT 2 BRIDGE & STREET MODIFICATIONS MIDWAY ROAD BRIDGE (#22) MIDWAY ROAD GRADE SEPARATED CROSSING

NOT AN APPROVED DRAWING
PRELIMINARY 30% DESIGN

CONTRACT SHEET No.	2 OF 11
COTTON BELT REGIONAL RAIL SYSTEM LINE SECTION CB-2 MIDWAY ROAD BRIDGE (#22) & ROADWAY MODIFICATIONS TITLE SHEET	
CONTRACT	DWG No.
C-2033270-01	GC1-2222
REV	A

10/25/2019
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REV	AMEND	CR	DATE	DESCRIPTION	BY	ENG	CHK	APP

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DESIGNED	M. KHAN
CHECKED	J. MORRIS
IN CHARGE	C. HOOD
DATE	28 OCT 19



INDEX OF DRAWINGS

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| 3 | A | GC2-2221 | INDEX OF DRAWINGS
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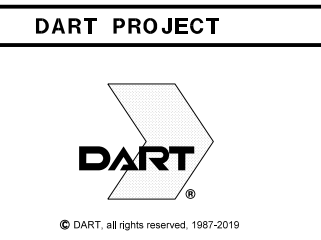
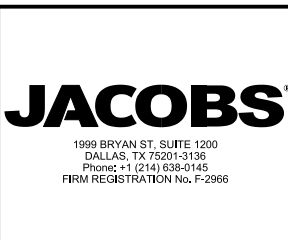
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CONTRACT SHEET No. 3 OF 11

COTTON BELT REGIONAL RAIL SYSTEM
LINE SECTION CB-2
MIDWAY ROAD BRIDGE (#22) &
ROADWAY MODIFICATIONS
INDEX OF DRAWINGS
SHEET 1 OF 1

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IN CHARGE	C. HOOD
DATE	28 OCT 19

CONTRACT C-2033270-01	DWG No. GC2-2221	REV A
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SYMBOLS

	PROFILE GRADE LINE / ELEVATION CONTROL POINT		SANITARY (DIRECTION OF FLOW) , PLUG		T (UG) UNDERGROUND TELEPHONE LINE		POINT OF SWITCH
	DIRECTION OF FLOW		GRID OF THE STATE PLANE COORDINATE SYSTEM		UG(E) UNDERGROUND ELECTRIC LINE		LEFT HAND TURNOUT
	C OR B CENTERLINE OR BASELINE		BILLBOARD		OH AERIAL UTILITY		RIGHT HAND TURNOUT
	FUTURE OR NOT IN CONTRACT		TOTAL CENTRAL ANGLE OF SPIRAL AND CIRCULAR CURVES		UTILITY FACILITY LESS THAN 24"		DERAIL SWITCH
	CENTERLINE		SUFFIX (1) AT THE SYMBOL DENOTES DATA FOR THE FIRST CIRCULAR CURVE OF A COMPOUND CURVE		MAJOR UTILITY FACILITY 24" OR LARGER IN PLAN VIEW		CENTERLINE
	BASELINE		SUFFIX (2) AT THE SYMBOL DENOTES DATA FOR THE SECOND CIRCULAR CURVE OF A COMPOUND CURVE		FACILITY TO BE ABANDONED		GAUGE LINE
	PROPERTY LINE		CENTRAL ANGLE OF SPIRAL OR SPIRAL ANGLE		DOUBLE CROSSOVER		LEFT HAND CURVE
	DIMENSION LINE CONTINUES		CENTRAL ANGLE OF COMPOUND SPIRAL OR COMPOUND ANGLE (CS1 TO CS2)		POINT OF SWITCH		RIGHT HAND CURVE
	MATCH LINE		TOTAL CENTRAL ANGLE OF COMPOUND SPIRAL OR TOTAL COMPOUND SPIRAL ANGLE (FROM SPO TO SC2)		EXISTING DITCH		SINGLE CROSSOVER, LH SHOWN
	CONTOUR LINE		WASTEWATER MANHOLE		PROPOSED SPECIAL DITCH		CONTINUOUS WELDED RAIL
	TRACK (TRANSIT) CENTER LINE		STORM SEWER MANHOLE		STORM DRAIN/CULVERT		PI/PVI/PITO
	EXISTING FENCE LINE		ELECTRICAL, TELEPHONE, OR WESTERN UNION MANHOLE		UNDERDRAIN		NON-INSULATED JOINT
	PROPOSED FENCE LINE		REDUCER		WASTEWATER		INSULATED RAIL JOINT-BOTH RAILS
	STRUCTURE OUTLINE		WATER METER		GAS LINE		INSULATED RAIL JOINT - L RAIL
	RAILROAD TRACKS		WATER VALVE		TRAFFIC SIGNALIZATION LINE		INSULATED RAIL JOINT - R RAIL
	CLEANOUT		FIRE HYDRANT		ELECTRIC POWER LINE		INSULATED RAIL JOINT
	MANHOLE		CAP OR PLUG		ESL ELECTRIC LINE, STREET LIGHTING		RESTRAINING RAIL
	SIDEWALK AND MISC. LINES		GAS VALVE		TELEPHONE LINE		PRE-CURVED RAIL
	DROP INLET, CATCH BASIN OR DRAIN		GAS METER		TELEGRAPH LINE		STANDARD RAIL, GIRDER RAIL
	CULVERT HEADWALLS		PULL BOX OR SPLICING CHAMBER		CABLEVISION LINE		PREMIUM RAIL
	SPOT ELEVATION		LIGHT POLE		PROPOSED CASING		SWITCH NUMBERING "F" INDICATES FUTURE
	CURB LINE		FIRE SERVICE STAND PIPE		PROPOSED STREET CLOSING		136#/115# TRANSITION RAIL
	EXISTING BARRIER/RETAINING WALL		EXISTING TRAFFIC SIGN		PROPOSED STREET CONSTRUCTION		CURVE NUMBER
	PROPOSED RETAINING WALL		PROPOSED TRAFFIC SIGN		EXISTING STREET/RAILROAD RIGHT-OF-WAY LINE		BLUE FLAG
	PROPOSED BALLAST WALL		POLE GUY AND ANCHOR		EXISTING PROPERTY LINE		BUMPING POST
	NOISE IMPACT AREA		TRANSMISSION LINE TOWER		DART PROPOSED RIGHT-OF-WAY LINE		EQUILATERAL TURNOUT
	GUARD RAIL		TRAFFIC CONTROL GATE		EXISTING EASEMENT LINE		POWER POINT POLE
	HAND RAIL		CANTILEVERED RAILROAD CROSSING SIGNAL		DART PROPOSED EASEMENT LINE		PROPOSED FIRE HYDRANT
	UNPAVED ROAD		TEST BORING LOCATION		EXIST SET COPPER, IRON PIN, PIPE IRON ROD MARKERS OR ANY PROPERTY CORNER		REMOVE AND REPLACE MANHOLE
	CONCRETE GUARD FENCE		OVERHEAD LINES		RIGHT-OF-WAY, CONTROL MONUMENT OR MARKERS		RAILROAD GATE/CANTILEVER LOCATION
	VEGETATION LINE		OVERHEAD ELECTRIC LINES		EXISTING INTERSECTION OF PROPERTY LINES		HEADWATER ELEVATION
	TREE		DART PRIMARY CONTROL POINT		INTERSECTION OF PROPOSED DART RIGHT-OF-WAY LINES		TAILWATER ELEVATION
	SHRUB		OTHER SURVEY MONUMENTS		PROPOSED DART RIGHT-OF-WAY MONUMENT		CORROSION CONTROL TEST STATION
	POLE						CONDUIT RUN NUMBER
	UTILITY POLE						

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CONTRACT SHEET No. 4 OF 11

COTTON BELT REGIONAL RAIL SYSTEM
LINE SECTION CB-2

SYMBOLS

IN-PROGRESS REVIEW

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ARCHER WESTERN HERZOG

DART PROJECT

DART

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DESIGNED	V. ESCAND
CHECKED	J. MORRIS
IN CHARGE	C. HOOD
DATE	28 OCT 19

CONTRACT C-2033270-01 DWG No. GC3-0201 REV A

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REV	AMEND	CR	DATE	DESCRIPTION	BY	ENG	CHK	APP

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Table with multiple columns listing abbreviations and their corresponding full names. Columns include: AASHTO, AREA, AMERICAN ASSOCIATION OF STATE HIGHWAY & TRANSPORTATION OFFICIALS, ABUT, ABUTMENT, ABOVE, ABOVE NET, AC, ACRE, AMERICAN CONCRETE INSTITUTE, ACP, ASBESTOS CEMENT PIPE, AD, AREA DRAIN, ADA, AMERICANS WITH DISABILITIES ACT, ADD, ADDENDUM, ADJ, ADJACENT, A/E, ARCHITECT/ENGINEER, AFF, ABOVE FINISHED FLOOR, A/G, AT GRADE, AGG, AGGREGATE, AHD, AHEAD, AISC, AMERICAN INSTITUTE OF STEEL CONSTRUCTION, INC, AISI, AMERICAN IRON AND STEEL INSTITUTE, AL, ALUMINUM, ALT, ALTERNATE, ANC, ANCHOR, ANSI, AMERICAN NATIONAL STANDARDS INSTITUTE, APPROX, APPROXIMATE, APP, APPROACH, APT, AUTOMATED PERSONAL TRANSIT, ARCH., ARCHITECT, ARCHITECTURE, AREMA, AMERICAN RAILWAY ENGINEERING AND MAINTAINANCE OF WAY ASSOCIATION, ASA, AMERICAN STANDARDS ASSOCIATION, ASPH, ASPHALT, ASSY, ASSEMBLY, ASTM, AMERICAN SOCIETY FOR TESTING AND MATERIALS, ATR, ABOVE TOP OF RAIL, ATT/D, ATT (TEXAS), ATT/TCG, ATT (LOCAL SERVICE), AUX, AUXILIARY, AVE, AVENUE, AVG, AVERAGE, AWG, AMERICAN WIRE GAUGE, AWS, AMERICAN WELDING SOCIETY, BAS, BRIDGE APPROACH SLAB, B/B, BACK TO BACK, B/C, BACK OF CURB, BCCP, BITUMINOUS COATED CORRUGATED PIPE, BD, BOARD, BALLAST DRAIN, BEG., BEGINNING, BF, BOTH FACES, BH, BORED HOLE, BIT., BITUMINOUS, BJF, BITUMINOUS JOINT FILLER, BK, BACK, BKF, BACKFILL, BKWL, BACKWALL, B/L, BUILDING LINE, BLDG, BUILDING, BLKG, BLOCKING, BLVD, BOULEVARD, BM, BEAM, B.M., BENCH MARK, BOT, BOTTOM, BNSF, BURLINGTON NORTHERN SANTA FE RAILWAY, BPA, BRIDGE PROTECTIVE ASSEMBLY, BRG, BEARING, BRKT, BRACKET, BS, BOTH SIDES, B/S, BOTTOM OF SLOPE, BTWN, BETWEEN, BVL, BEVELED, BW, BOTH WAYS, BOTTOM WIDTH, C.X., AMERICAN STANDARD CHANNEL, _X_ = SIZE BY WEIGHT, RUNOFF COEFFICIENT, CAB., CABINET, CANT, CANTILEVER, CAT, CATENARY, CATF, CATENARY FOUNDATION, CATP, CATENARY POLE, CB, CATCH BASIN, C, RUNOFF COEFFICIENT, CC, CENTER OF CURVE, CCOM, CONSOLIDATED COMMUNICATIONS, C TO C, CENTER TO CENTER, CEM, CEMENT, CF, CUBIC FEET, CFL, COUNTERFLASHING, CFS, CUBIC FEET PER SECOND, CG, CONCRETE GUTTER, C & G, CURB AND GUTTER, C/G, CORNER GUARD, CHAM, CHAMFER, CHD, CHORD, CHDPE, CORRUGATED HIGH DENSITY PLOYETHYLENE, CI, CAST IRON, CURB INLET, CIH, CENTRAL INSTRUMENT HOUSE, CIP, CAST-IN-PLACE, CAST IRON PIPE, CJ, CONSTRUCTION JOINT, L, CENTERLINE, CL, CLASS, C/L, CURB LINE, CLF, CHAIN LINK FENCE, CLR, CLEARANCE, CLEAR, CMB, CHANGEABLE MESSAGE BOARD, CMP, CORRUGATED METAL PIPE, CMU, CONCRETE MASONRY UNIT, CO, CLEAN OUT, COD, CITY OF DALLAS, COI, CITY OF IRVING, COL, COLUMN, COMB, COMBINATION, COMM, COMMUNICATIONS, COMP, COMPRESSED, COMPRESSION, CON, CONSTRUCTION LINES, CONC, CONCRETE, CONN, CONNECT, CONNECTOR, CONNECTION, CONST, CONSTRUCTION, CONSTRUCT, CONT, CONTINUATION, CONTINUOUS, CORR, CORRUGATED, CRS, COLD ROLLED STEEL, CS, CURVE TO SPIRAL POINT, CSMH, CONTROL SYSTEMS MANHOLE, CTB, CEMENT TREATED BASE, CONCRETE TRAFFIC BARRIER, CTR, CENTER, CULV, CULVERT, CWR, CONTINUOUS WELDED RAIL, CY, CUBIC YARD, D, DEG, DEGREE OF CURVE, DART, DALLAS AREA RAPID TRANSIT, DBL, DOUBLE, DCURD, DALLAS COUNTY UTILITY & RECLAMATION DISTRICT, DEFL, DEFLECTION, DEG, DEGREE, DEP, DEPRESSED, DET, DETAIL, DFW, DALLAS/FORT WORTH, DF, DIRECT FIXATION, DG, DOWNGUY, DI, DROP INLET, DUCTILE IRON, DIA, DIAMETER, DIM, DIMENSION, DIP, DUCTILE IRON PIPE, DIST, DISTANCE, DL, DEAD LOAD, DN, DOWN, DP, DAMPPROOFING, DPL, DALLAS POWER & LIGHT COMPANY, DR, DOOR, DRIVE, DERAILMENT LOAD, DRN, DRAIN, DRAINAGE, DRWY, DRIVEWAY, DS, DOWNSPOUT, D.S., DRILLED SHAFT, DWG, DRAWING, DWU, DALLAS WATER UTILITY, E, EXPANSION BEAM END, EAST, ELECTRIC, Eo, SUPERELEVATION IN INCHES, EA, EACH, EB, EAST BOUND, EBFR, EAST BOUND FRONTAGE ROAD, EBML, EAST BOUND MAINLINE, EF, EACH FACE, EFC, EXPOSED FINISH CONCRETE, E.G., FOR EXAMPLE, EL, ELEV, ELEVATION, ELEC, ELECTRICAL, EMBED, EMBELEMNT, EMH, ELECTRICAL MANHOLE, ENCSMT, ENCASEMENT, E/P, EOP, EDGE OF PAVEMENTS, EO, EQUAL, EQUIV, EQUIVALENT, E/S, EDGE OF SHOULDER, ESMT, EASEMENT, EST, ESTIMATE, Es, EXTERNAL DISTANCE OF SPIRAL CURVE, Eu, SUPERELEVATION UNBALANCED IN INCHES, ETC, ET CETERA, EWF, EACH WAY, EWF, EACH WAY, EACH FACE, Ex, EXIST., EXISTING, EXP, EXPANSION, EXPJT, EXPANSION JOINT, EXPO, EXPOSED, EXT, EXTERIOR, EXPWY, EXPRESSWAY, F, FIXED BEAM END, FAHRENHEIT, F TO F, FACE TO FACE, FBR OPT, FIBER OPTIC, F/C, FACE OF CURVE, FD, FLOOR DRAIN, FDN, FOUNDATION, FF, FINISH FLOOR, FAR FACE, FFBW, FRONT FACE BACKWALL, FG, FINISH GRADE, FH, FIRE HYDRANT, FIG, FIGURE, FIN, FINISH, FL, FLOW LINE, FLEX, FLEXIBLE, FLG, FLANGE, FLR, FLOOR, FOF, FACE OF FINISH, FRWY, FREEWAY, FS, FAR SIDE, FT, FOOT OR FEET, FTG, FOOTING, FURN, FURNISH, FUT, FUTURE, FWD, FORWARD, FW, FORT WORTH, G, GAS (NATURAL), GA, GAUGE, GAL, GALLON, GALV, GALVANIZED, GB, GROUND BOX, GEC, GENERAL ENGINEERING CONSULTANT, GEN, GENERAL, GI, GALVANIZED IRON, GRATE INLET, G/L, GROUND LINE, GM, GAS METER, GND, GROUND, GSC, GAUGE PLATE, GRAND PRAIRIE, GR, GRADE, G/R, GUARD RAIL, GRAN, GRANITE, GRANULAR, G/R PL, GUARD RAIL PLATE, GRIG, GRATING, GV, GAS VALVE, GVL, GATE VALVE, H, HEIGHT, H.C., HANDICAP, H/D, HEAVY DUTY, HDWL, HEADWALL, HEX, HEXAGONAL, HH, HAND HOLE, HMAC, HOT MIX ASPHALTIC CONCRETE, HMLP, HIGH MAST LIGHT POLE, HORIZ, HORIZONTAL, HP_X, BEARING PILE SHAPE, _X_ = SIZE BY WEIGHT, HPT, HIGH POINT, HR, HOUR, HSB, HIGH STRENGTH BOLT, HSS_X_X, HOLLOW STRUCTURAL SHAPE, X(X_) = DIMENSION X DIMENSION X THICKNESS, HSS, HIGH STRENGTH STEEL, HWL, HIGH WATER LINE, HWY, HIGHWAY, I, RAINFALL INTENSITY, ICLRT, INTERMEDIATE CAPACITY LIGHT RAIL TRANSIT, ID, INSIDE DIAMETER, IF, INSIDE FACE, IH, INTERSTATE HIGHWAY, IJ, INSULATED JOINT, IN, INCH, INC, INCORPORATED, INCL, INCLUDE, INT, INTERIOR, INV, INVERT, IRR, IRRIGATION, ISF, INSIDE FACE, ITS, INTELLIGENT TRANSPORTATION SYSTEMS, JT, JOINT, K, KIP, RATE OF VERTICAL CURVATURE, KV, KILOVOLT, L, TOTAL CURVE LENGTH, LENGTH, LEFT (DEFLECTION), LB, POUND, LC, TOTAL LENGTH OF CIRCULAR CURVE, LF, LINEAR FEET, LG, LENGTH, LONG, LH, LEFT HAND, LIN, LINEAR, LINEAL, LL, LIVE LOAD, LN, LANE, LOC, LOCATION, LONG, LONGITUDINAL, LPT, LOW POINT, LRT, LIGHT RAIL TRANSIT, LTD, LIMITED, Ls, TOTAL LENGTH OF SPIRAL, LSG, LONE STAR GAS, LT, LEFT, LTL, LINTEL, LVC, LENGTH OF VERTICAL CURVE, LVL, LEVEL, LVL 3, LEVEL (3) COMMUNICATION, INC, M_X, MISCELLANEOUS PILE SHAPE, _X_ = SIZE BY WEIGHT, MATL, MATERIAL, MAX, MAXIMUM, MBGR, METAL BEAM GUARD RAIL, MBR, MEMBER, MC_X, MISCELLANEOUS CHANNEL, _X_ = SIZE BY WEIGHT, MCI, MCI TELECOMMUNICATIONS, MEAS, MEASURE, MEMB, MEMBRANE, MET, METAL, MFR, MANUFACTURER, MH, MANHOLE, MIN, MINUTES, MINIMUM, MISC, MISCELLANEOUS, MKT, MISSOURI-KANSAS-TEXAS RAILROAD COMPANY, ML, MAINLINE, MOD, MODULAR, MODIFIED, MON, MONUMENT, MSE, MECHANICALLY STABILIZED EARTH, MT, MOUNTED, MTG, MOUNTING, MULT, MULTIPLE, N, NORTH, N/A, NOT APPLICABLE, NAT, NATURAL, NB, NORTHBOUND, NBFR, NORTHBOUND FRONTAGE ROAD, NBML, NORTHBOUND MAINLINE, NCTCOG, NORTH CENTRAL TEXAS COUNCIL OF GOVERNMENTS, NG, NAUTRAL GROUND, NF, NEAR FACE, NIC, NOT IN CONTRACT, No, NUMBER, Nos, NUMBERS, NOM, NOMINAL, NS, NEAR SIDE, N/S, NORTH/SOUTH, NTMWD, NORTH TEXAS MUNICIPAL WATER DISTRICT, NTS, NOT TO SCALE, NTTA, NORTH TEXAS TOLLWAY AUTHORITY, OC, ON CENTERS, OCEW, ON CENTER EACH WAY, OCV, OVERHEAD CATENARY SYSTEM, OD, OUTSIDE DIAMETER, OF, OUTSIDE FACE, OFF, OFFSET, OH, OVERHEAD, OHE, OVERHEAD ELECTRIC, O TO O, OUT TO OUT, OPNG, OPENING, OPP, OPPOSITE, ORD, ORDINATE, PB, PULLBOX, PC, POINT OF CURVE, PCC, POINT OF COMPOUND CURVE, P/C, PRECAST, PED, PEDESTRIAN, PEJ, PREFORMED EXPANSION JOINT, PERF, PERFORMED, PERM, PERMANENT, PERMISS, PERMISSIBLE, PERP, PERPENDICULAR, PF, POINT OF FROG, PG, PROFILE GRADE, PAGE, PGL, PROFILE GRADE LINE, PI, POINT OF INTERSECTION, PITO, POINT OF INTERSECTION - TURNOUT, PL, PLATE, PROPERTY LINE, PLAT., PLATFORM, PMDF, PERMANENT METAL DECK FORMS, P/0, PART OF, P/0B, POINT OF BEGINNING, POC, POINT OF CURVE, POE, POINT OF ENDING, POLY, POLYETHYLENE, POS, POINT OF SPIRAL, POT, POINT OF TANGENT, PP, POWER POLE, PREM, PREMOLDED, PROJ., PROJECTION, PROP, PROPOSED, PROT, PROTECTION, PRVT, PRIVATE, P/S, PRE-STRESSED, PS, POINT OF SWITCH, PSF, POUNDS PER SQUARE FOOT, PSI, POUNDS PER SQUARE INCH, PT, POINT OF TANGENT, PTD, PAINTED, PVI, POINT OF VERTICAL INTERSECTION, P/VT, PAVEMENT, PVP, POLYVINYL CHLORIDE PIPE, PVC, POLY VINYL CHLORIDE, POINT OF VERTICAL CURVE, PVRC, POINT OF VERTICAL REVERSE CURVATURE, PVT, POINT OF VERTICAL CURVE, Q, STORM WATER DISCHARGE, QTY, QUANTITY, R, RADIUS, R1, RIGHT (DEFLECTION), RC, REINFORCED CONCRETE, RCB, REINFORCED CONCRETE BOX CULVERT, RCCP, REINFORCED CONCRETE CYLINDER PIPE, RCP, REINFORCED CONCRETE PIPE, RD, ROAD, REFL, REFLECTIVE, REINF, REINFORCE, REINFORCED, REINFORCING, REINFORCEMENT, REOD, REQUIRED, REV, REVISE, REVISION, RH, RIGHT HAND, RO, ROUGH OPENING, ROW, RIGHT OF WAY, RR, RAILROAD, RSC, RAILROAD SIGNAL CABLE, RT, RIGHT, S, SOUTH, SLOPE, S & I, SERVICE & INSPECTION, S.X., I SHAPE, _X_ = SIZE BY WEIGHT, SB, SOUTHBOUND, SBFR, SOUTHBOUND FRONTAGE ROAD, SBML, SOUTHBOUND MAINLINE, SC, SPIRAL TO CURVE, SCHED, SCHEDULE, SCR, SCREW, SD, STORM DRAIN, SDMH, STORM DRAIN MANHOLE, SDWK, SIDEWALK, SEJ, SEALED EXPANSION JOINT, SEL, SELECT, SG, SWITCH GEAR, SH, STATE HIGHWAY, S/H, STRUCTURAL HEIGHT, SHLD, SHOULDER, SHT, SHEET, SIG, SIGNAL, SIM, SIMILAR, SL, STREET LIGHT, SLAB, SLV, SLEEVE, SM, SMOOTH, SMH, SEWER MANHOLE, SP, SOUTHERN PACIFIC TRANS. CORP., SPC, SPACE, SPEC(S), SPECIFICATION, SPECIFICATIONS, SO, SQUARE, SO FT, SQUARE FOOT, SQ IN, SQUARE INCH, SS, SANITARY SEWER, SST, STAINLESS STEEL, ST, STREET, SPIRAL TO TANGENT POINT, STA, STATION, STATIONING, STD, STANDARD, STIFF, STIFFENER, STL, STEEL, STM, STORM, STRGTH, STRENGTH, STRUCT, STRUCTURE, STRUCTURAL, SURF., SURFACE, SWR, SEWER, SY, SQUARE YARD, SYM, SYMMETRICAL, SYS, SYSTEM, T, LENGTH OF TANGENT, TELEPHONE, Tc, TIME OF CONCENTRATION, T(UG), TELEPHONE (UNDERGROUND), T/, TOP OF, T & B, TOP AND BOTTOM, TBM, TEMPORARY BENCH MARK, TBR, TO BE REMOVED, T/C, TOP OF CURB, T/D, TOP OF DITCH, TCO, TERMINAL CLEANOUT, TEM, TEMPORARY, TEMP, TEMPERATURE, TEN, TENSION, TES, TRACTION ELECTRIFICATION SYSTEM, TG, TELEGRAPH, TOP OF GRADE, TGMH, TELEGRAPH MANHOLE, THRU, THROUGH, THK, THICK, THICKNESS, TL, TRAFFIC LIGHT, TMH, TELECOM MANHOLE, TN, TURNOUT, TOC, TOP OF CONCRETE, TOD, TRANSIT ORIENTED DEVELOPMENT, TP, TOP OF PAVEMENT, TPL, TEXAS POWER & LIGHT, TPSS, TRACTION POWER SUBSTATION, T/R, TOP OF RAIL, TRA, TRINITY RIVER AUTHORITY, TRAF SIG, TRAFFIC SIGNAL, TRK, TRACK, TRNSF, TRANSFORMER, TS, TANGENT TO SPIRAL, T/S, TOP OF SLOPE, T/STL, TOP OF STEEL, TUE, TEXAS UTILITIES ELECTRIC COMPANY, T/W, TOP OF WALL, TxDOT, TEXAS DEPARTMENT OF TRANSPORTATION, TXU, TEXAS UTILITY ELECTRIC, TWC, TIME WARNER CABLE, TYP, TYPICAL, TY, TYPE, TWT, TIME WARNER TELECOM, UD, UNDERDRAIN, UG, UNDERGROUND, UGC, UNDERGROUND CABLE, UGE, UNDERGROUND ELECTRIC, UNO, UNLESS NOTED OTHERWISE, UP, UNION PACIFIC RAILWAY, US, UNITED STATES, USC&GS, U.S. COAST & GEODETIC SURVEY, USGS, UNITED STATES GEOLOGICAL SURVEY, UTIL, UTILITY, V, VELOCITY, VAR, VARIABLE, VARIES, W, WEST, WATER, W/, WITH, WB, WESTBOUND, WBFR, WESTBOUND FRONTAGE ROAD, WBML, WESTBOUND MAINLINE, W.X., WIDE FLANGE SHAPE, _X_ = SIZE BY WEIGHT, WI, WROUGHT IRON, W/O, WITHOUT, WL, WATER LINE, WM, WATER METER, WP, WORK POINT, W/P, WEATHERPROOF, WS, WATER SURFACE, WT, WATERTIGHT, WEIGHT, WTR, WATER, WTRPRF, WATERPROOF, WV, WATER VALVE, WW, WASTEWATER, WWF, WELDED WIRE FABRIC, WSEL, WATER SURFACE ELEVATION, X-ING, CROSSING, X-SECT, CROSS SECTION, XO, XO COMMUNICATIONS, 360, 360 NETWORKS, I, LENGTH OF TANGENT, TELEPHONE, Tc, TIME OF CONCENTRATION, T(UG), TELEPHONE (UNDERGROUND), T/, TOP OF, T & B, TOP AND BOTTOM, TBM, TEMPORARY BENCH MARK, TBR, TO BE REMOVED, T/C, TOP OF CURB, T/D, TOP OF DITCH, TCO, TERMINAL CLEANOUT, TEM, TEMPORARY, TEMP, TEMPERATURE, TEN, TENSION, TES, TRACTION ELECTRIFICATION SYSTEM, TG, TELEGRAPH, TOP OF GRADE, TGMH, TELEGRAPH MANHOLE, THRU, THROUGH, THK, THICK, THICKNESS, TL, TRAFFIC LIGHT, TMH, TELECOM MANHOLE, TN, TURNOUT, TOC, TOP OF CONCRETE, TOD, TRANSIT ORIENTED DEVELOPMENT, TP, TOP OF PAVEMENT, TPL, TEXAS POWER & LIGHT, TPSS, TRACTION POWER SUBSTATION, T/R, TOP OF RAIL, TRA, TRINITY RIVER AUTHORITY, TRAF SIG, TRAFFIC SIGNAL, TRK, TRACK, TRNSF, TRANSFORMER, TS, TANGENT TO SPIRAL, T/S, TOP OF SLOPE, T/STL, TOP OF STEEL, TUE, TEXAS UTILITIES ELECTRIC COMPANY, T/W, TOP OF WALL, TxDOT, TEXAS DEPARTMENT OF TRANSPORTATION, TXU, TEXAS UTILITY ELECTRIC, TWC, TIME WARNER CABLE, TYP, TYPICAL, TY, TYPE, TWT, TIME WARNER TELECOM, UD, UNDERDRAIN, UG, UNDERGROUND, UGC, UNDERGROUND CABLE, UGE, UNDERGROUND ELECTRIC, UNO, UNLESS NOTED OTHERWISE, UP, UNION PACIFIC RAILWAY, US, UNITED STATES, USC&GS, U.S. COAST & GEODETIC SURVEY, USGS, UNITED STATES GEOLOGICAL SURVEY, UTIL, UTILITY, V, VELOCITY, VAR, VARIABLE, VARIES, W, WEST, WATER, W/, WITH, WB, WESTBOUND, WBFR, WESTBOUND FRONTAGE ROAD, WBML, WESTBOUND MAINLINE, W.X., WIDE FLANGE SHAPE, _X_ = SIZE BY WEIGHT, WI, WROUGHT IRON, W/O, WITHOUT, WL, WATER LINE, WM, WATER METER, WP, WORK POINT, W/P, WEATHERPROOF, WS, WATER SURFACE, WT, WATERTIGHT, WEIGHT, WTR, WATER, WTRPRF, WATERPROOF, WV, WATER VALVE, WW, WASTEWATER, WWF, WELDED WIRE FABRIC, WSEL, WATER SURFACE ELEVATION, X-ING, CROSSING, X-SECT, CROSS SECTION, XO, XO COMMUNICATIONS, 360, 360 NETWORKS

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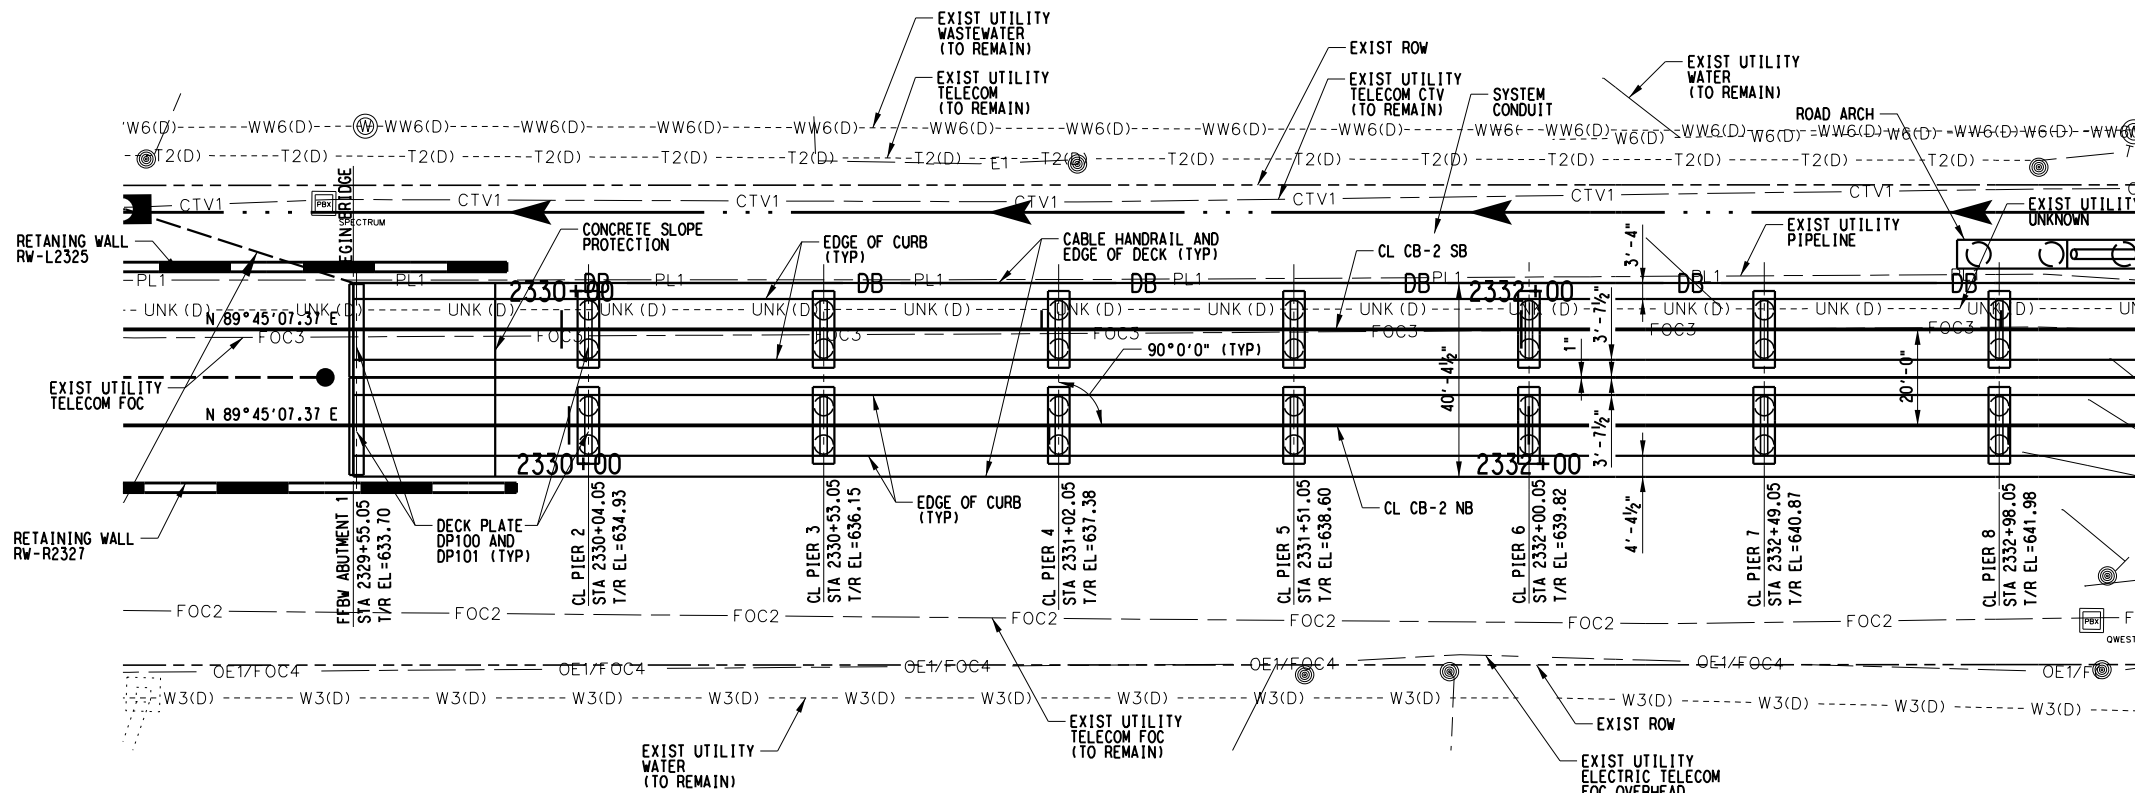
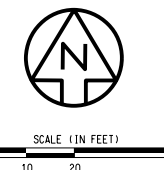
Table with contract and drawing information. Columns include: CONTRACT SHEET No., 5 OF 11, COTTON BELT REGIONAL RAIL SYSTEM LINE SECTION CB-2, ABBREVIATIONS, CONTRACT C-2033270-01, DWG No. GC3-0202, REV A.

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OR
10/25/2019
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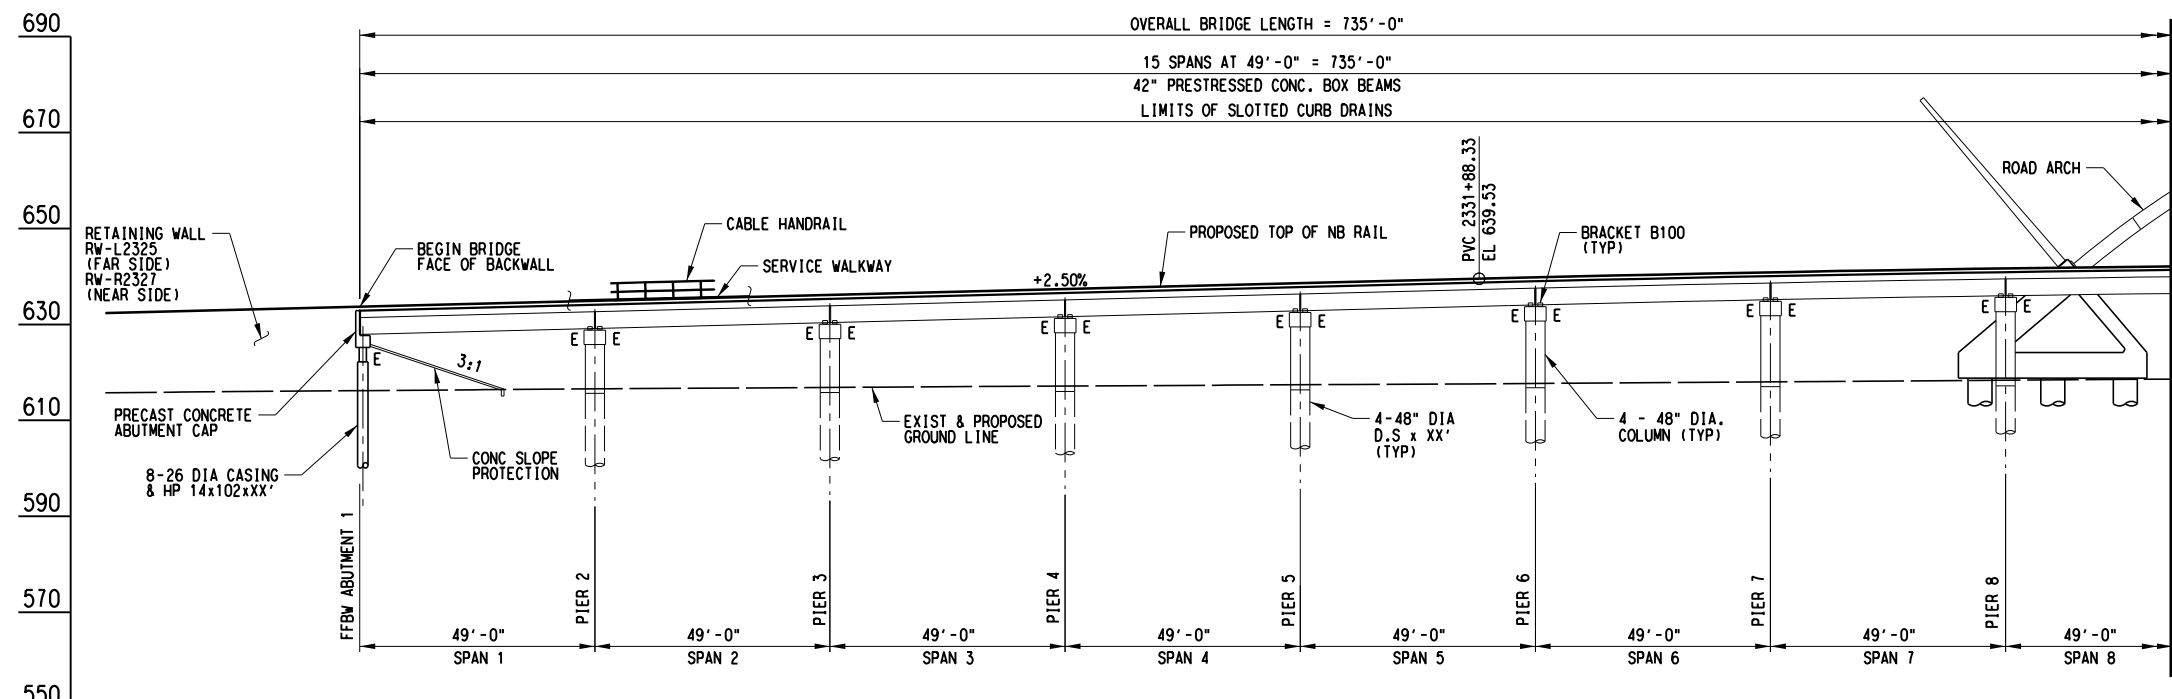
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Phone: +1 (214) 638-0145
FIRM REGISTRATION No. F-2966

ARCHER WESTERN HERZOG
DART
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Table with columns: REV, AMEND, CR, DATE, DESCRIPTION, BY, ENG, CHK, APP.



PLAN SCALE: 1"=20'



ELEVATION SCALE: 1"=20'

MATCH LINE CB-2 NB STA 2333+30.00 SEE DWG No. SC2-1502

MATCH LINE CB-2 NB STA 2333+30.00 SEE DWG No. SC2-1502

- NOTES:
- SPAN LENGTH STATIONING AND VERTICAL PROFILE ARE SHOWN ALONG THE CENTERLINE OF THE CB-2 NB TRACK. TOP OF LOW RAIL IS THE CONTROL AND PROFILE GRADE LINE.
 - FOR SERVICE WALKWAY DETAILS, SEE STANDARD DRAWING NO. SS9-0017.
 - FOR CABLE HANDRAIL DETAILS, SEE STANDARD DRAWING NOS. SS9-0029 & SS9-0030.
 - FOR UTILITY LOCATIONS AND RELOCATION SEE UTILITY DRAWINGS.
 - FOR DECK PLATE DETAILS, SEE STANDARD DRAWING NO. SS9-0022. DECK PLATE IS APPLICABLE AT ALL ABUTMENTS AND INTERIOR PIERS.
 - FOR BALLASTED DECK WATERPROOFING, EXP JOINT, AND DRAINAGE DETAILS, SEE STANDARD DRAWING NOS. SS9-0020 & SS9-0021.
 - FOR SYSTEMS ELEMENTS, SEE SYSTEMS PLANS.
 - FOR EXACT LOCATIONS OF BORING LOGS AND SOIL PARAMETERS, SEE GEOTECHNICAL REPORT.
 - DESIGN LIVE LOAD IS COOPER E80.
 - AT ABUTMENTS FOUNDATION CASING SHALL BE PERMANENT. AT THE PIERS THE FOUNDATION CASING MAY BE TEMPORARY OR PERMANENT AT THE CONTRACTORS OPTION. FOR CASING CONCURRENT OR THE SHAFT CONCRETE WITHIN THE ACTIVE FREIGHT ZONES.
 - FOR SLOPE PROTECTION, SEE STANDARD DRAWING NO. SS9-0037.
 - FOR NOTES AND STANDARDS NOT SHOWN, SEE GENERAL NOTES AND STANDARD PACKAGE.
 - SEE PROTECTION ASSEMBLY AND CLEARANCE SIGN STANDARD DRAWING NO. SS9-0014 FOR BMCS & BPA DETAILS.
 - "E" ON THE ELEVATION VIEW REPRESENTS AN EXPANSION BEARING.
 - FOR GUARDRAIL LIMITS AND LOCATIONS SEE TRACK GUIDEWAY DRAWINGS.
 - FOR SLOTTED DRAIN WINDOW DETAILS SEE DRAWING NO. SSX-XXXX.

NOT AN APPROVED DRAWING PRELIMINARY 30% DESIGN

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REV	AMEND	CR	DATE	DESCRIPTION	BY	ENG	CHK	APP

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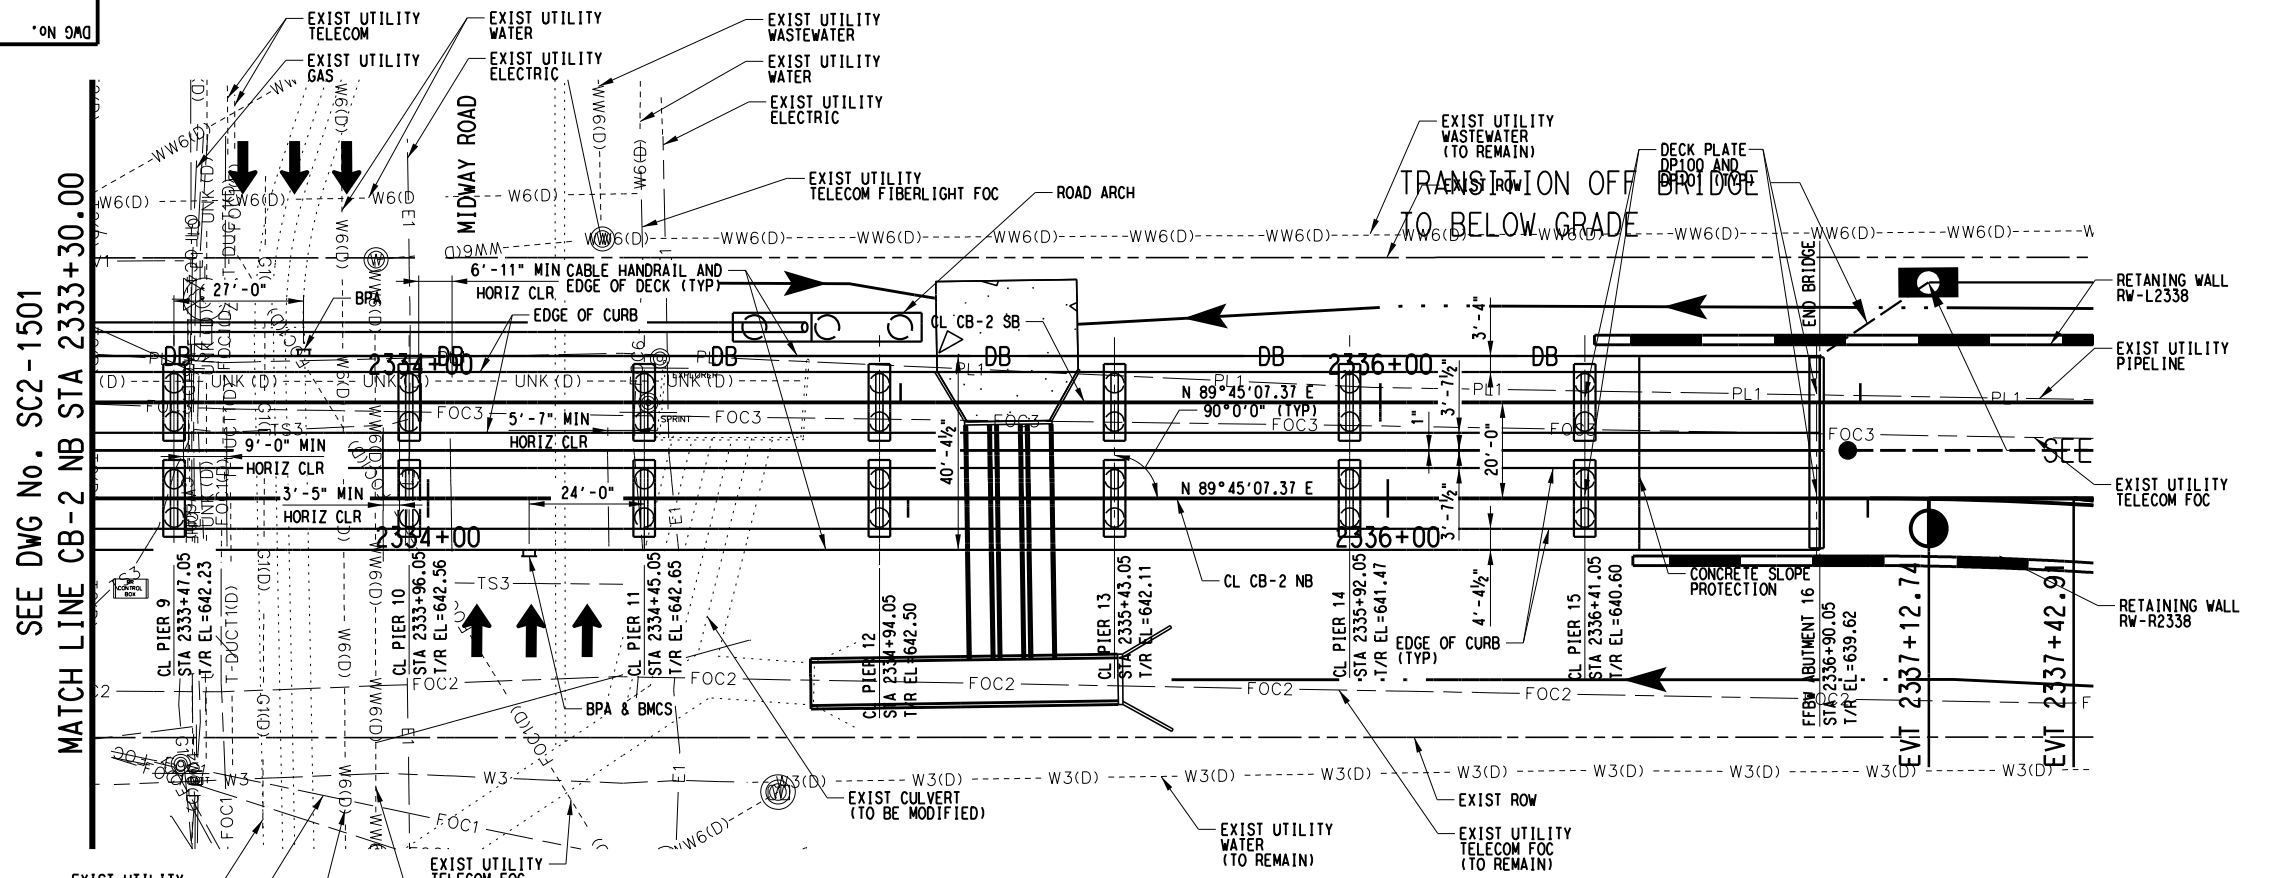
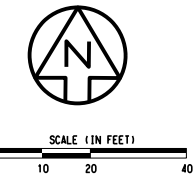


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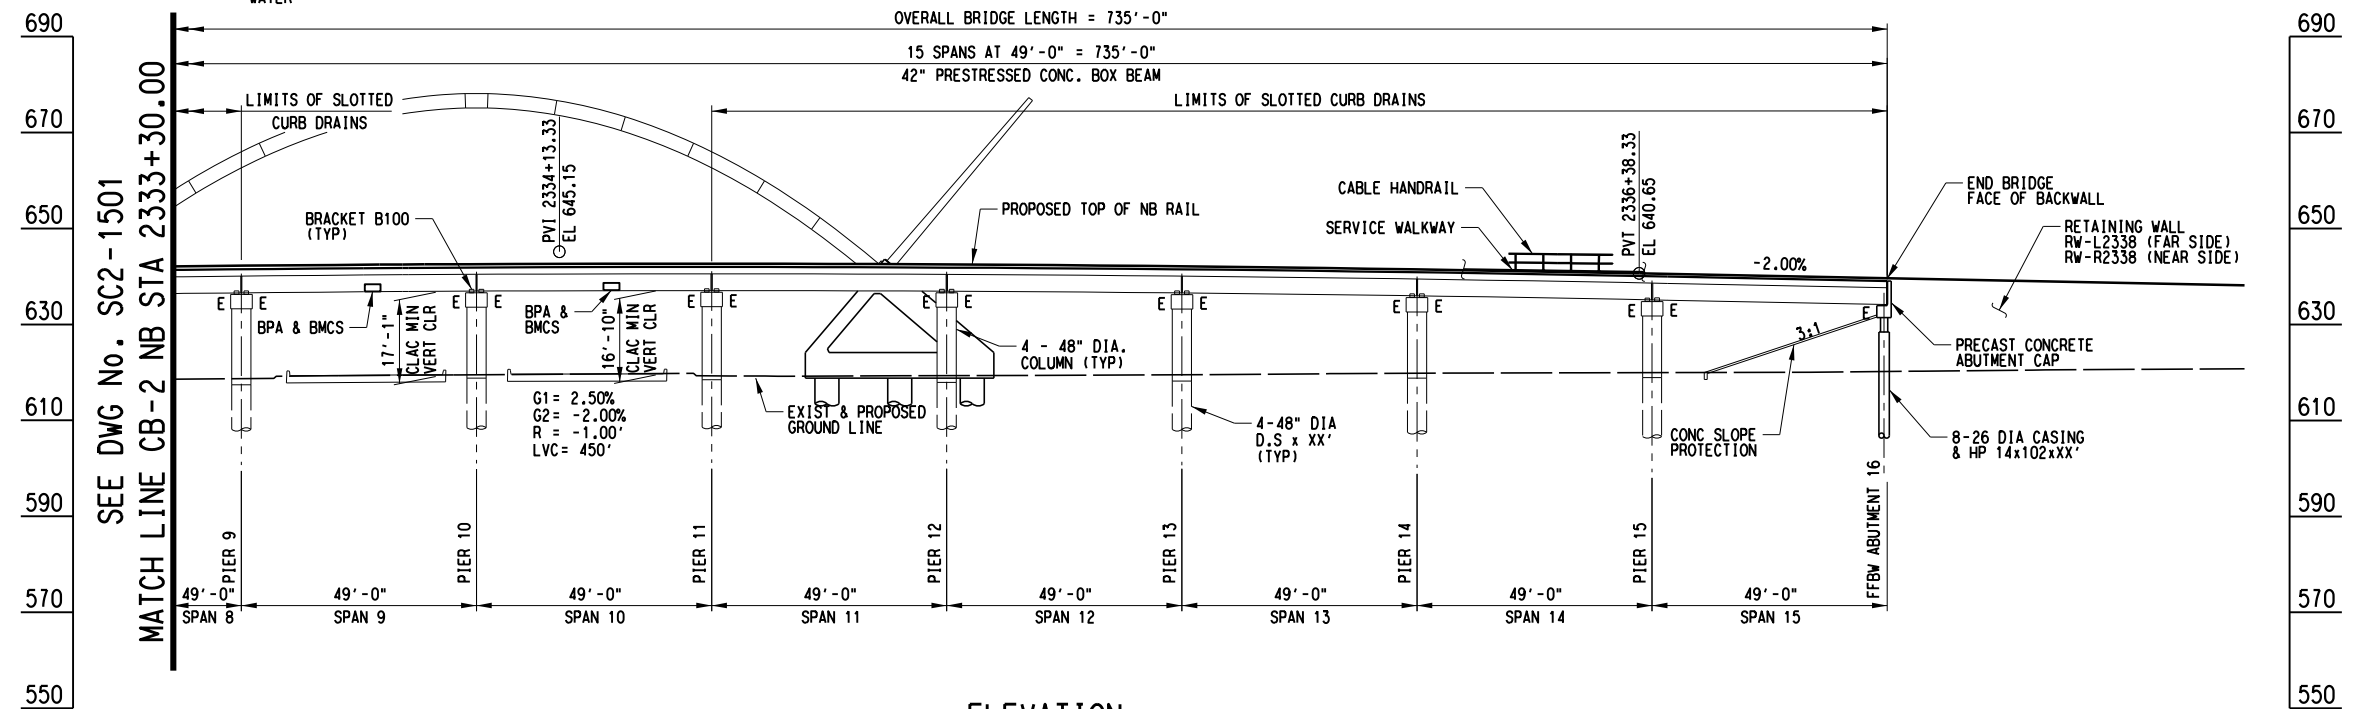
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SCALE	1" = 20'-0"
DRAWN	K. CASTIANO
DESIGNED	M. KHAN
CHECKED	J. MORRIS
IN CHARGE	C. HOOD
DATE	28 OCT 19

CONTRACT SHEET No. 6 OF 11	
COTTON BELT REGIONAL RAIL SYSTEM LINE SECTION CB-2 MIDWAY ROAD BRIDGE (#22) PLAN AND ELEVATION SHEET 1 OF 2	
CONTRACT C-2033270-01	DWG No. SC2-1501
REV A	



PLAN
SCALE: 1"=20'



ELEVATION
SCALE: 1"=20'

SEE DRAWING SC2-1501 FOR SHEET NOTES.

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PRELIMINARY 30% DESIGN

CONTRACT SHEET No. 7 OF 11

COTTON BELT REGIONAL RAIL SYSTEM
LINE SECTION CB-2
MIDWAY ROAD BRIDGE (#22)
PLAN AND ELEVATION
SHEET 2 OF 2

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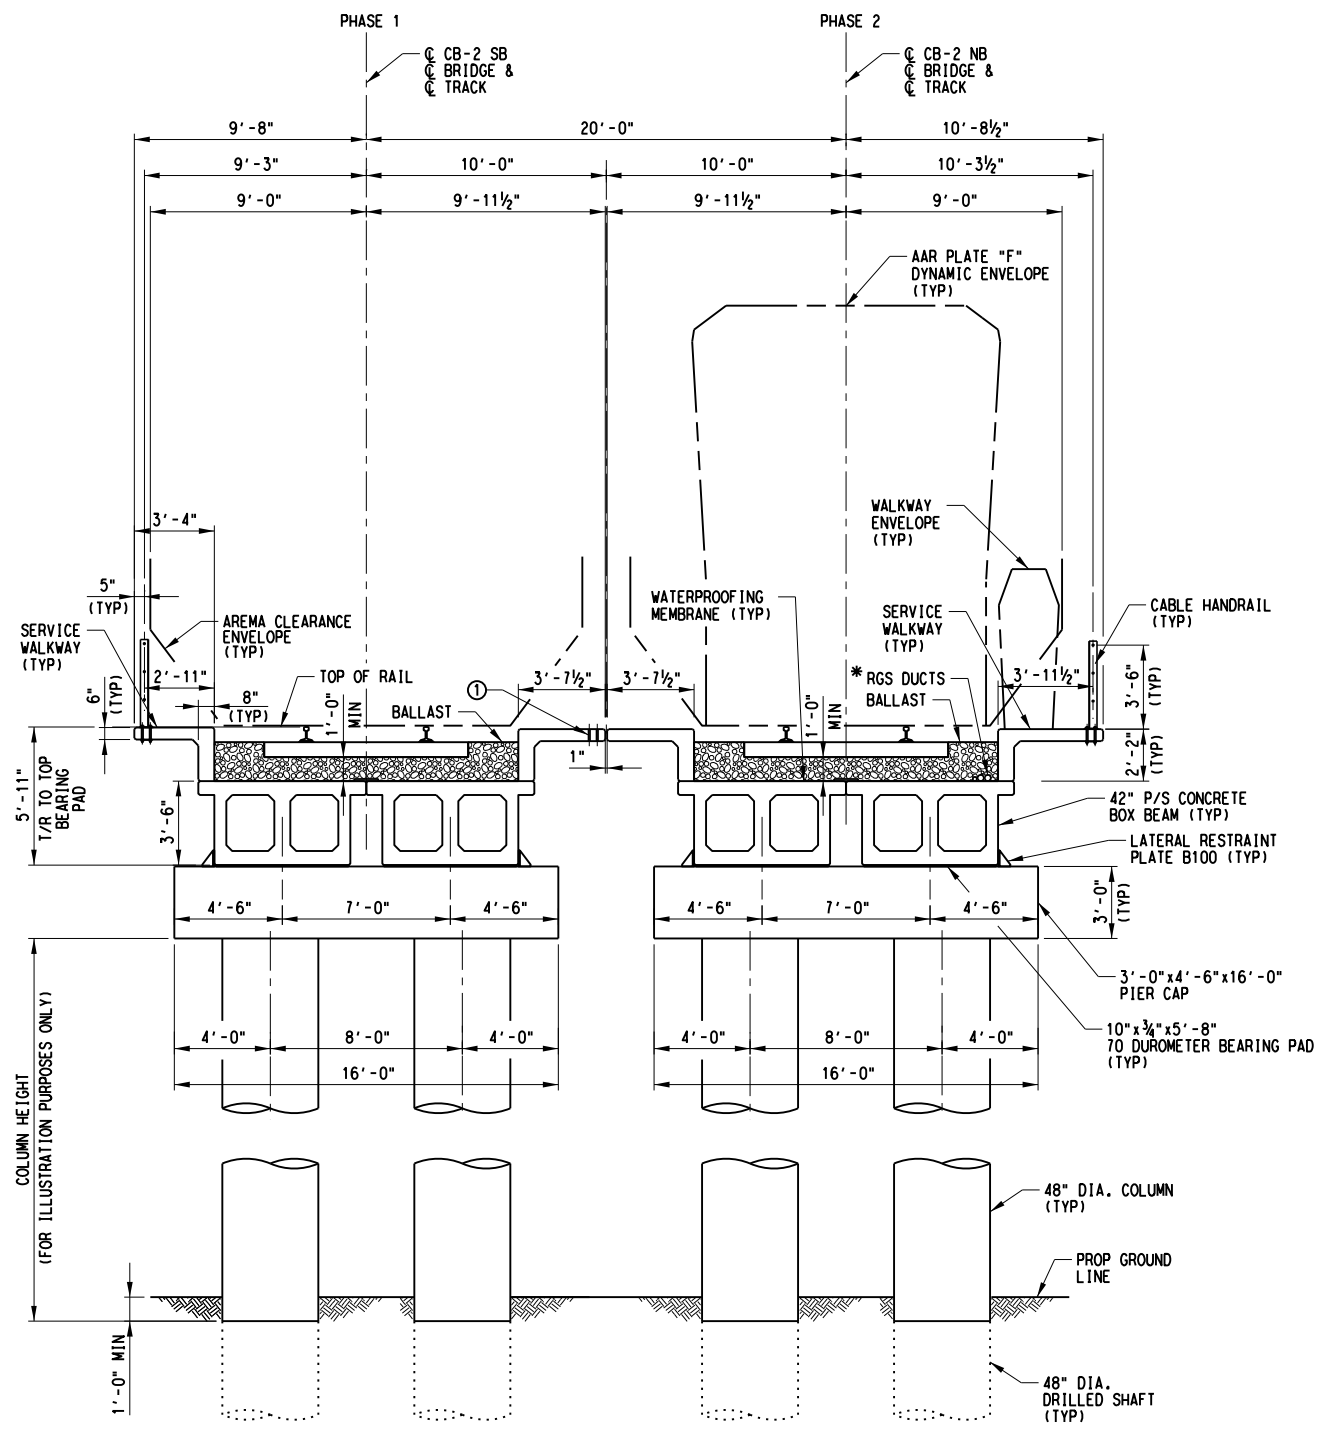


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DRAWN	K. CASTIANO
DESIGNED	M. KHAN
CHECKED	J. MORRIS
IN CHARGE	C. HOOD
DATE	28 OCT 19



CONTRACT	C-2033270-01	DWG No.	SC2-1502	REV	A
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① FOR TEMPORARY CABLE HANDRAIL PLACEMENT HOLES DUE TO PHASING SEE STANDARD DRAWING NO. SS9-0017 AND SS9-0018. FOR CABLE HANDRAIL CONNECTION DETAILS SEE STANDARDS DRAWING NO. SS9-0027 THROUGH SS9-0030.

* FO CONDUIT MAY ALSO BE LINE BORED AT CONTRACTOR'S OPTION.

**TYPICAL SECTIONS
(ALL PIERS)**

CAP AND COLUMN SIZE ARE PRELIMINARY AND ARE SUBJECT TO CHANGE

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CONTRACT SHEET No. 9 OF 11

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SCALE	1/8" = 1'-0"
DRAWN	K. CASTIANO
DESIGNED	M. KHAN
CHECKED	J. MORRIS
IN CHARGE	C. HOOD
DATE	28 OCT 19


**COTTON BELT REGIONAL RAIL SYSTEM
LINE SECTION CB-2
MIDWAY ROAD BRIDGE (#22)
TYPICAL SECTION
SHEET 1 OF 1**

CONTRACT	DWG No.	REV
C-2033270-01	SC8-1501	A

REV	AMEND	CR	DATE	DESCRIPTION	BY	ENG	CHK	APP

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MIDWAY ROAD EXISTING TYPICAL SECTION


NOT TO SCALE

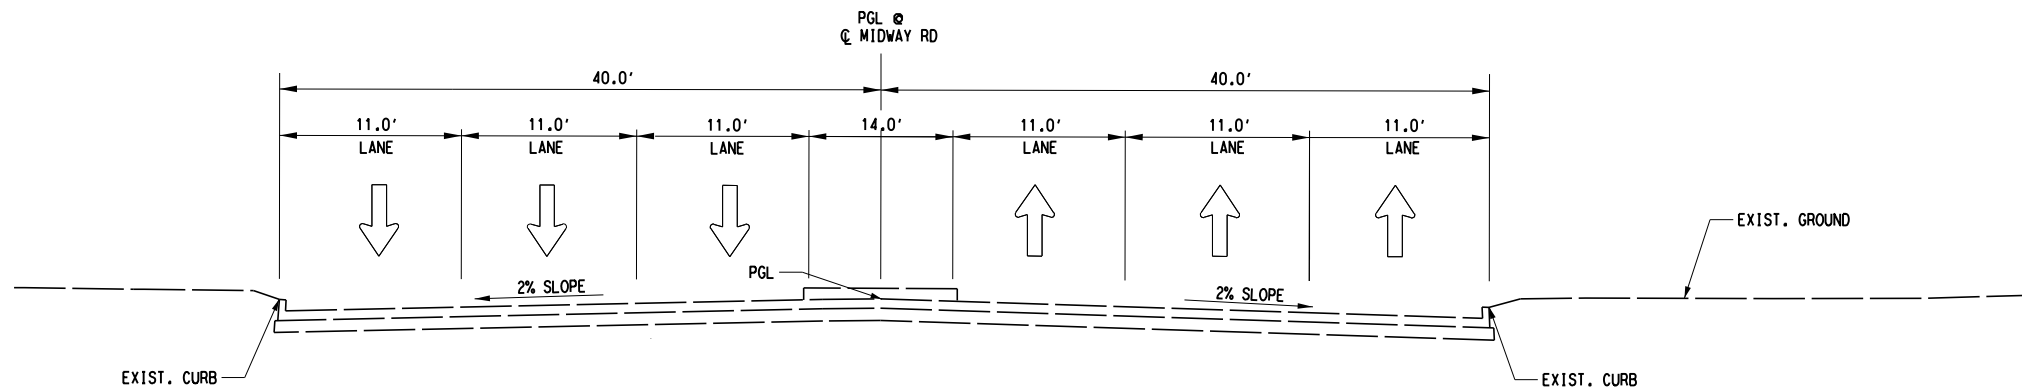STA 100+78.62 TO STA 100+93.07 EXISTING MEDIAN
 STA 100+93.07 TO STA 101+06.25 NO MEDIAN
 STA 100+78.62 TO STA 101+20.53 EXISTING MEDIAN

CONSTRUCTION LIMITS FALL ENTIRELY WITHIN DART CORRIDOR.

HORIZONTAL ALIGNMENT DATA						
Alignment Name: MIDWAY RD						
DESCRIPTION:						
POINT TYPE	STATION	NORTHING	EASTING	RADIUS	LENGTH	TANGENT
START	100+00.00	7035831.9813	2478411.4388			
HPI	102+25.00	7036056.9511	2478407.7505			
Tangential Direction: N00°56'21.37"W						
Tangential Length: 225.000						

- NOTES:
- SEE TOWN OF ADDISON PAVING DETAILS SD-P06 FOR CURB AND GUTTER DETAILS.
 - SEE TOWN OF ADDISON PAVING DETAIL SD-P14 FOR MEDIAN NOSE DIMENSIONS AND INSTALLATION DETAILS.
 - EXISTING PAVEMENT STRUCTURE IS ASSUMED TO CORRESPOND WITH THE TOWN OF ADDISON STANDARD CONSTRUCTION DETAILS FOR PAVING WHICH CALL FOR A 10" 4000 PSI CONCRETE WITH #4 BARS AT 18" SPACING CENTER TO CENTER WITH A 6" HYDRATED LIME SUBGRADE.

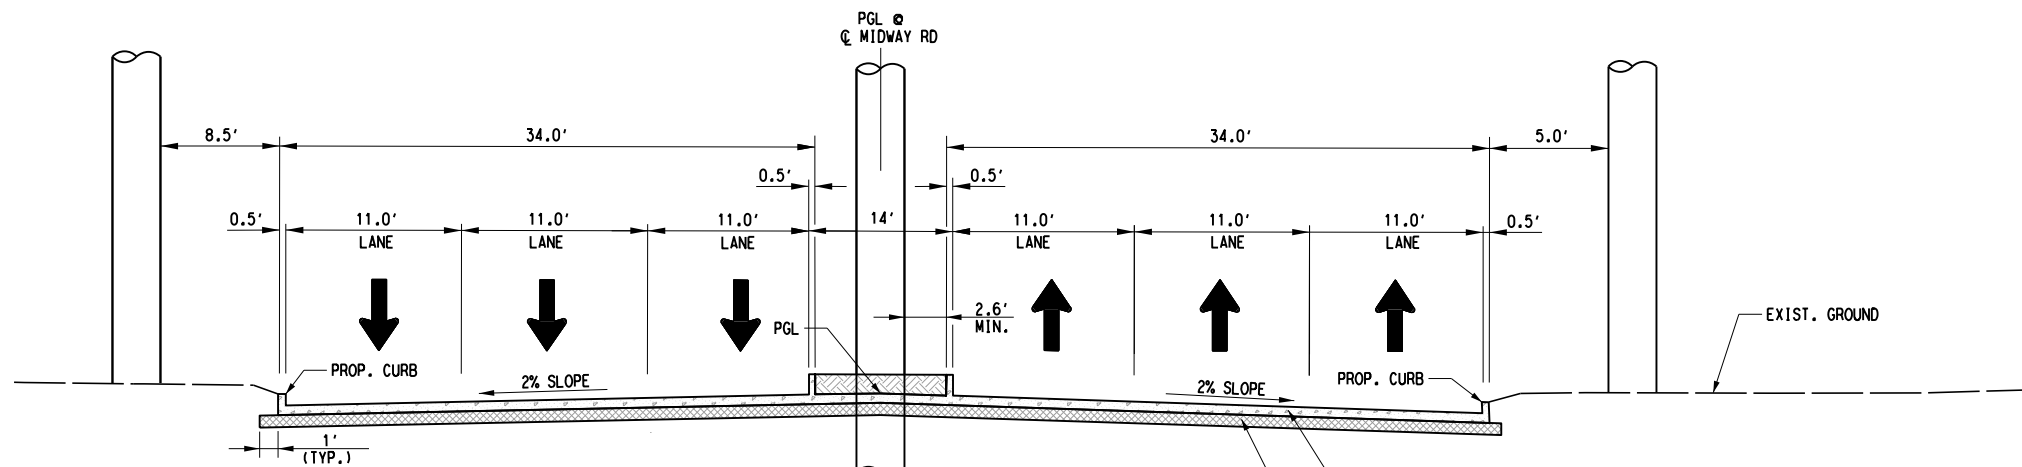

MIDWAY ROAD PROPOSED TYPICAL SECTION

NOT TO SCALE

STA 100+78.62 TO STA 101+20.53

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CONTRACT SHEET No.	10 OF 11
COTTON BELT REGIONAL RAIL SYSTEM LINE SECTION CB-2 MIDWAY ROAD MODIFICATIONS TYPICAL SECTIONS AND HORIZONTAL DATA SHEET 1 OF 1	
SCALE	NO SCALE
DRAWN	R. KPOCHAN
DESIGNED	R. KPOCHAN
CHECKED	A. SULLIVAN
IN CHARGE	D. KELLY
DATE	30 SEP 19
CONTRACT	DWG No.
C-2033270-01	CC7-1101
REV	A

REV	AMEND	CR	DATE	DESCRIPTION	BY	ENG	CHK	APP

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 FIRM REGISTRATION No. F-10997





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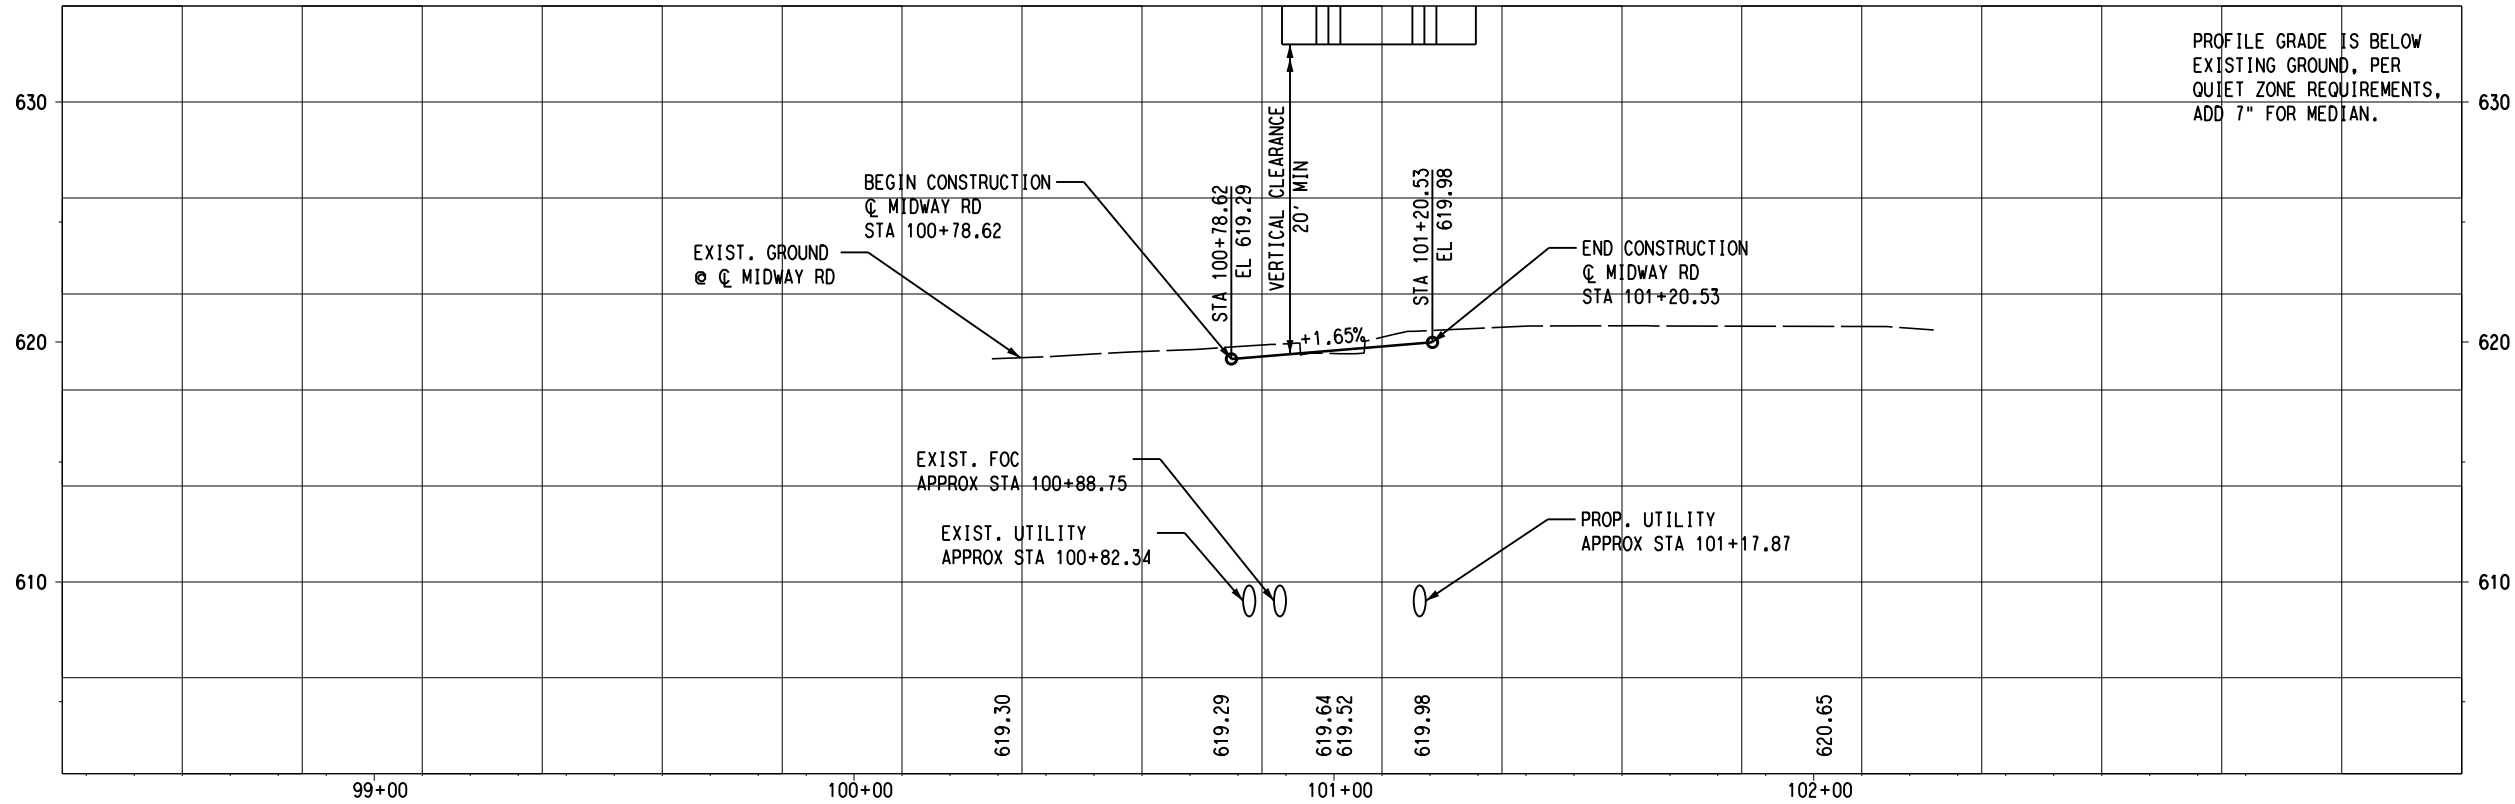


LEGEND

- CONCRETE PAVEMENT
- CONCRETE GRADE CROSSING PANELS
- ASPHALT OR ASPHALIC CONCRETE GRADE CROSSING BUFFER
- CONCRETE SIDEWALK, CONCRETE MEDIAN
- CONCRETE DRIVEWAY
- BRICK MEDIAN
- GRASS MEDIAN

NOTES:

1. DESIGN SPEED = 40 MPH
2. SEE TRACK (DWG NO. XXX-XXXX), DRAINAGE (DWG NO. XXX-XXXX), AND UTILITIES (DWG NO. XXX-XXXX) SHEETS FOR ADDITIONAL INFORMATION.
3. SEE TOWN OF ADDISON TRANSPORTATION TECHNICAL STANDARDS P-9 PAVING DETAILS AND P-17 CURB DETAILS FOR ADDITIONAL INFORMATION.

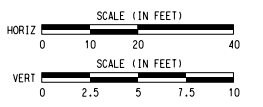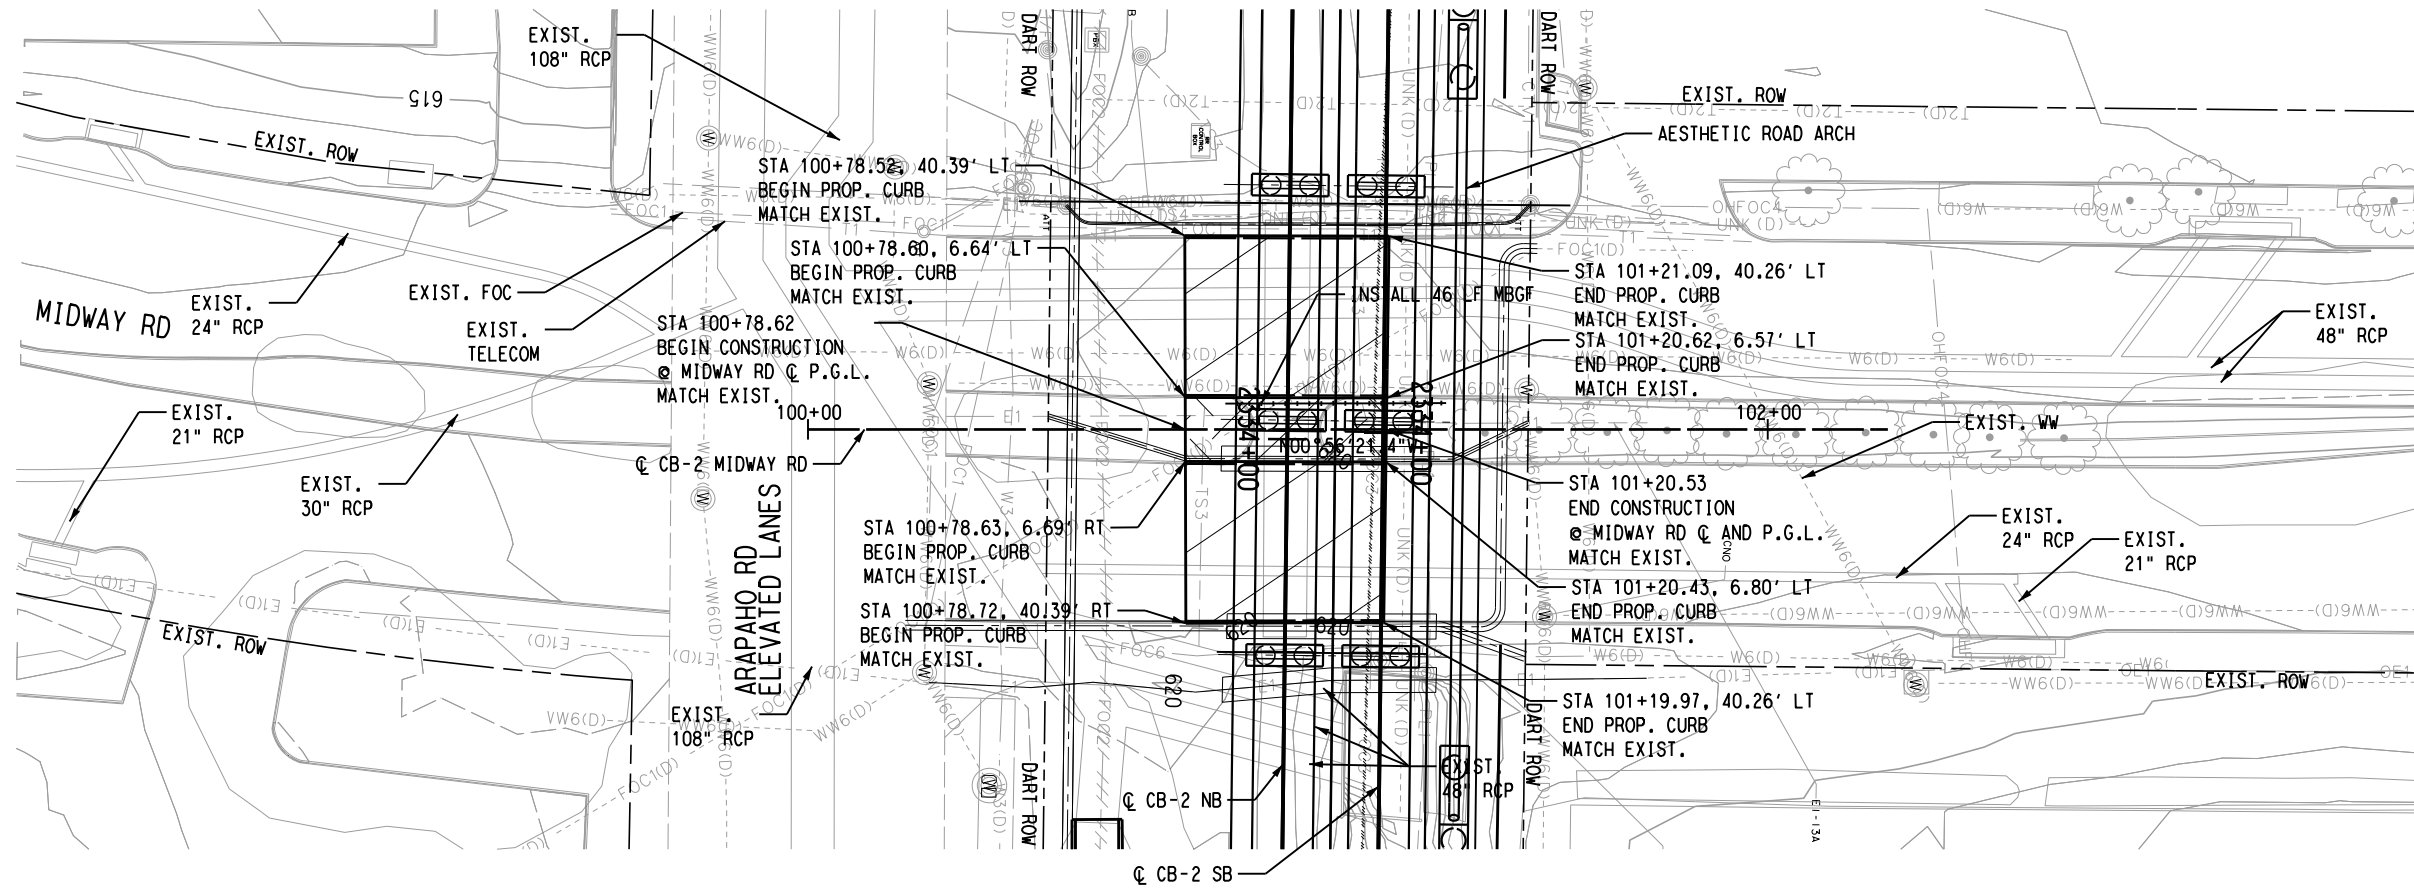

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CONTRACT SHEET No. 11 OF 11

COTTON BELT REGIONAL RAIL SYSTEM
LINE SECTION CB-2
MIDWAY ROAD MODIFICATIONS
PLAN AND PROFILE
SHEET 1 of 1

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FIRM REGISTRATION No. F-10997



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SCALE	1" = 20'
DRAWN	D. TATUM
DESIGNED	D. TATUM
CHECKED	A. SULLIVAN
IN CHARGE	D. KELLY
DATE	30 SEP 19

CONTRACT	C-2033270-01	DWG No.	CC4-1101	REV	A
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REV	AMEND	CR	DATE	DESCRIPTION	BY	ENG	CHK	APP