# ENGINEERING PLANS

# 4551 SUNBELT DRIVE

# Addison, Texas

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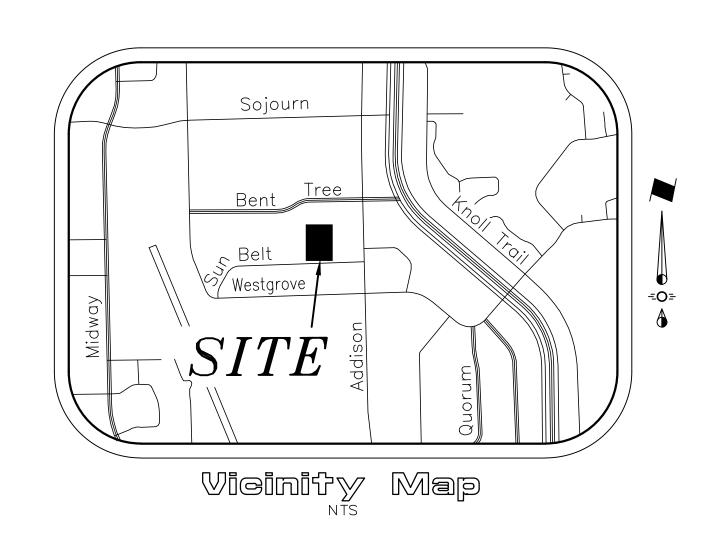
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Prepared For

# Water Tower Park, LLC.

15842 Addison Rd. Addison, Texas 75001

Engineer

S ENGINEERING CONSULTANTS **CONSULTANTS** 

1720 W. Virginia Street 972.562.4409

McKinney, Texas 75069 Texas P.E. Firm No. F-5935

This Record Drawing is a combination of the sealed engineering contract drawings for this project, modified by revision, change order, field order and information furnished by the contractor. The information shown on the Record Drawings is believed to be accurate based on information furnished by the contractor. The original sealed drawings are on file at the office of:

Cross Engineering Consultants 131 S. Tennessee Street McKinney, Texas 75069 (972) 562-4409 Record Drawings Prepared On: 12/10/2024

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#### **OWNER:**

Water Tower Park, LLC 15842 Addison Road Addison, Texas 75001 Phone (972) 239-1324 Contact: Mike Hope

#### **SURVEYOR:**

Texas Heritage Surveying, LLC 10610 Metric Drive, Suite 124 Dallas, Texas 75243 Phone (214) 340-9700

The seal that originally appeared on this

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a sealed document without proper notification of the responsible

Engineer is an offense

under the Texas

Engineering Practice Act.

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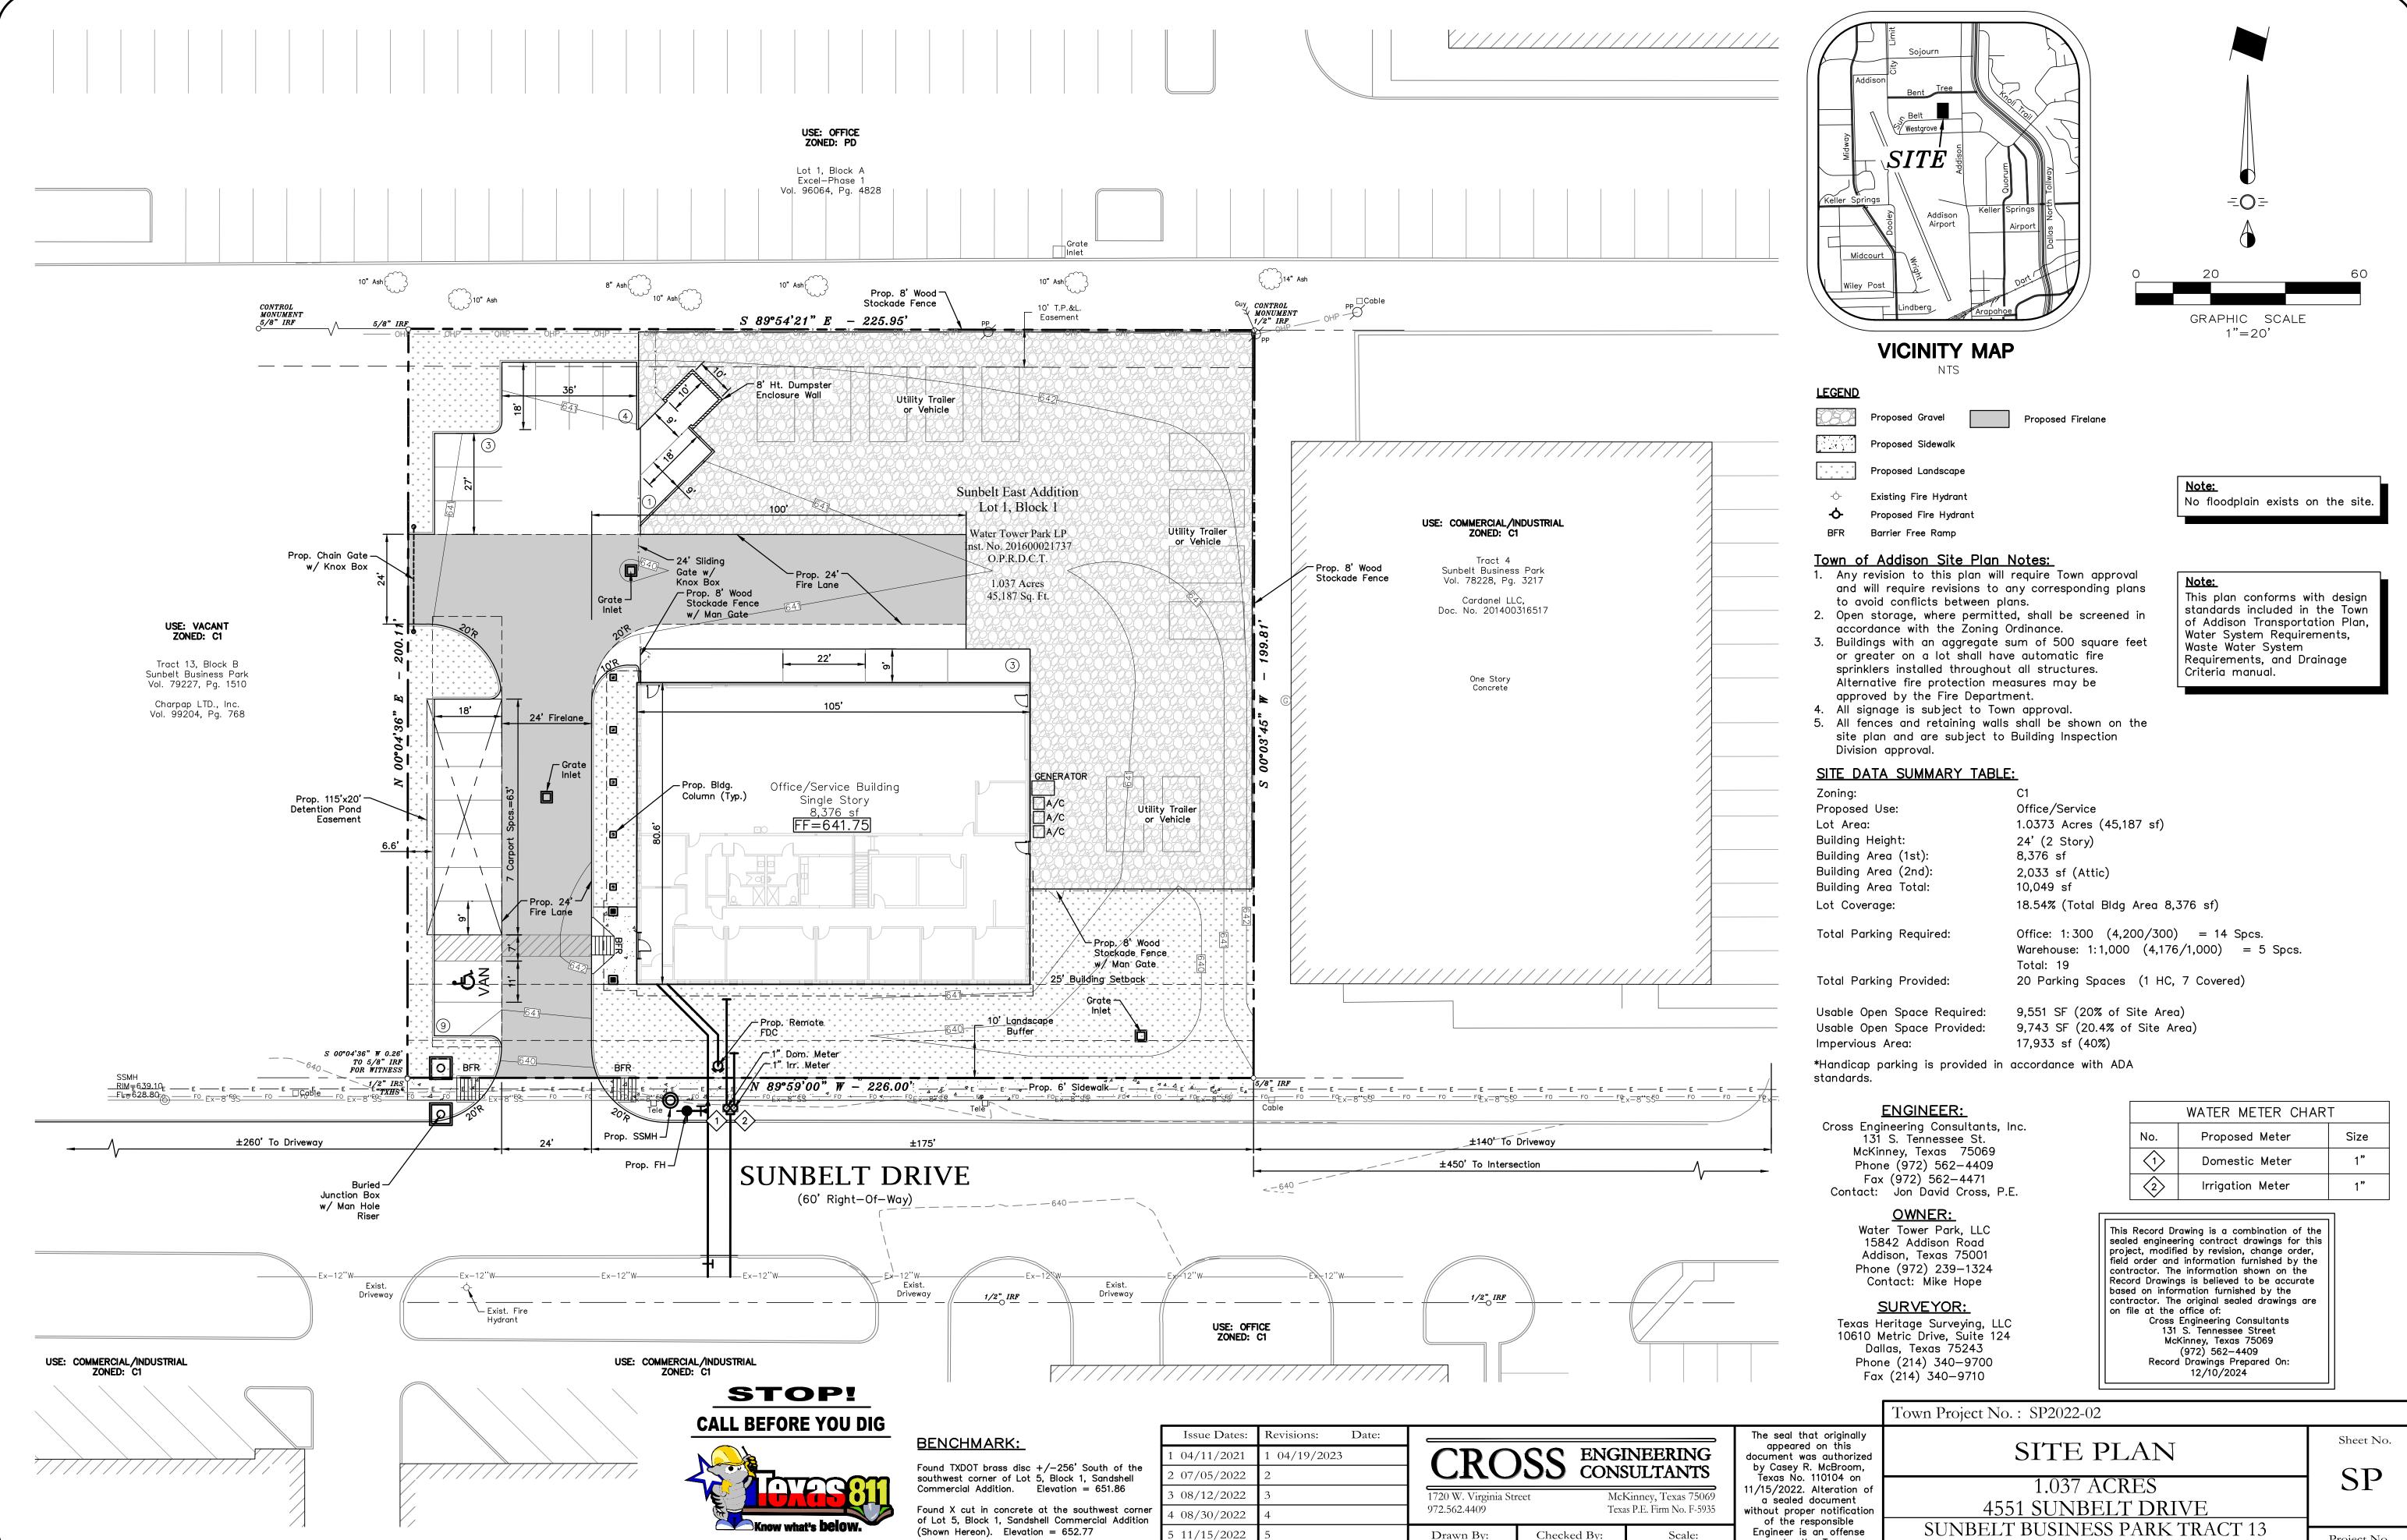
Batten Architects.

P.O. Box

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RCS Enterprises, LP 400 N. Allen Drive Allen, Texas 75013 Phone (972) 727-8572 Contact: Spencer Montgomery, P.E.

ISSUE DATES:	REVISIONS:	DATE	BY
04/11/2022	01 Existing Utility Conflicts	04/19/23	CRI
07/05/2022			
08/12/2022			
08/30/2022			
11/15/2022			



(@ least 72 hours prior to digging)

Project No. 19121

TOWN OF ADDISON, DALLAS COUNTY, TEXAS

under the Texas

Engineering Practice Act.

C.E.C.I.

C.E.C.I.

1"=20'

#### 1. GENERAL NOTES FOR ALL CONSTRUCTION ACTIVITIES

- 1.1.ALL CONSTRUCTION, TESTING, AND MATERIALS SHALL BE IN ACCORDANCE WITH THE TOWN'S CURRENT STANDARDS, DETAILS, AND SPECIFICATIONS. IF NOT EXPLICITLY SPECIFIED IN TOWN DOCUMENTS, NCTCOG OR THE APPROPRIATE GOVERNING BODY'S, STANDARDS AND DETAILS SHALL REGULATE CONSTRUCTION, TESTING, AND
- 1.2. CONTRACTOR IS RESPONSIBLE FOR OBTAINING ALL NECESSARY PERMITS AND APPROVALS PRIOR TO BEGINNING ANY CONSTRUCTION. CONTACT PUBLIC WORKS & ENGINEERING SERVICES DEPARTMENT FOR A PERMIT TO WORK WITHIN TOWN ROW.
- 1.3. ALL SHOP DRAWINGS, WORKING DRAWINGS OR OTHER DOCUMENTS WHICH REQUIRE REVIEW BY THE TOWN, SHALL BE SUBMITTED BY THE CONTRACTOR SUFFICIENTLY IN ADVANCE OF SCHEDULED CONSTRUCTION TO ALLOW NO LESS THAN 21 CALENDAR DAYS FOR REVIEW AND RESPONSE BY THE TOWN.
- 1.4. CONTRACTOR SHALL NOTIFY THE TOWN AT LEAST 48 HOURS PRIOR TO BEGINNING
- 1.5. CONTRACTORS ARE ALLOWED TO MAKE CONNECTIONS TO THE TOWN WATER SYSTEM BY OPENING AN ACCOUNT THROUGH THE ADDISON FINANCE DEPARTMENT AND RENTING A FIRE HYDRANT METER. THE COMPANY OR INDIVIDUAL IS SOLELY RESPONSIBLE FOR THE COST, MAINTENANCE, PROPER USE, AND SECURITY OF THE RENTAL EQUIPMENT. THE COMPANY OR INDIVIDUAL IS ALSO RESPONSIBLE FOR THE COST OF THE WATER USED.
- 1.6. CONTRACTOR MUST KEEP AVAILABLE ONSITE, AT ALL TIMES, APPROVED CONSTRUCTION PLANS AND COPIES OF ANY/ALL REQUIRED PERMITS ALONG WITH THE APPROPRIATE VERSIONS OF THE FOLLOWING APPLICABLE REFERENCES:
- 1.6.1. TOWN OF ADDISON ENGINEERING STANDARDS & DETAILS 1.6.2. NCTCOG STANDARDS & SPECIFICATIONS
- 1.6.3. TCEQ STANDARDS & SPECIFICATIONS
- 1.6.4. TXDOT SPECIFICATIONS & STANDARD DRAWINGS, AS APPLICABLE.
- 1.7. CONTRACTOR SHALL BE RESPONSIBLE FOR ALL REQUIRED CONSTRUCTION SURVEYING AND STAKING AND SHALL NOTIFY THE DESIGN ENGINEER OF ANY DISCREPANCIES PRIOR TO PROCEEDING WITH ANY WORK.
- 1.8. CONTRACTOR SHALL BE RESPONSIBLE FOR PROTECTING ALL SURVEY MARKERS INCLUDING IRON RODS, PROPERTY CORNERS, OR SURVEY MONUMENTS WITHIN THE LIMITS OF CONSTRUCTION AND OUTSIDE ROW DURING CONSTRUCTION. ANY SURVEY MARKERS DISTURBED DURING CONSTRUCTION SHALL BE REPLACED BY THE CONTRACTOR AT NO COST TO THE TOWN.
- 1.9. TESTING AND INSPECTION OF MATERIALS SHALL BE PERFORMED BY A COMMERCIAL TESTING LABORATORY SPECIFIED BY OR APPROVED BY THE TOWN. CONTRACTOR SHALL FURNISH MATERIALS OR SPECIMENS FOR TESTING AND SHALL FURNISH SUITABLE EVIDENCE THAT THE MATERIALS PROPOSED TO BE INCORPORATED INTO

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THE WORK ARE IN ACCORDANCE WITH THE SPECIFICATIONS. COPIES OF TESTING REPORTS SHALL BE FURNISHED TO THE TOWN IMMEDIATELY UPON RECEIPT BY THE CONTRACTOR.

- 1.10. FOR PUBLIC PROJECTS, CONTRACTOR SHALL PROVIDE A CONSTRUCTION SCHEDULE AND WEEKLY PROGRESS REPORTS.
- 1.11. CONTRACTOR IS RESPONSIBLE FOR KEEPING STREETS AND DRIVEWAYS ADJACENT TO THE PROJECT FREE OF DIRT, MUD, AND DEBRIS AT ALL TIMES. CONTRACTOR SHALL CLEAN UP AND REMOVE ALL LOOSE MATERIAL RESULTING FROM CONSTRUCTION OPERATIONS. THE CONTRACTOR SHALL TAKE ALL AVAILABLE PRECAUTIONS TO CONTROL DUST.
- 1.12. THE EXISTENCE AND LOCATIONS OF THE PUBLIC AND FRANCHISE UTILITIES SHOWN ON THE DRAWINGS WERE OBTAINED FROM AVAILABLE RECORDS AND ARE APPROXIMATE. THE CONTRACTOR SHALL DETERMINE THE DEPTH AND LOCATION OF EXISTING UNDERGROUND UTILITIES PRIOR TO EXCAVATING, TRENCHING, OR DRILLING AND SHALL BE REQUIRED TO TAKE ANY PRECAUTIONARY MEASURES TO PROTECT ALL LINES SHOWN AND / OR ANY OTHER UNDERGROUND UTILITIES NOT OF RECORD OR NOT SHOWN ON THE PLANS. THE CONTRACTOR SHALL BE RESPONSIBLE FOR CONTACTING ALL PUBLIC AGENCIES AND FRANCHISE UTILITIES 48 HOURS PRIOR TO CONSTRUCTION. THE CONTRACTOR MAY BE REQUIRED EXPOSE THESE FACILITIES AT NO COST TO THE TOWN. THE CONTRACTOR WILL BE RESPONSIBLE FOR DAMAGES TO UTILITIES IF THE DAMAGE IS CAUSED BY NEGLIGENCE OR FAILURE TO HAVE LOCATES PERFORMED.
- 1.13. CONTRACTOR SHALL BE RESPONSIBLE FOR ANY DAMAGE TO EXISTING FACILITIES OR ADJACENT PROPERTIES DURING CONSTRUCTION. ANY REMOVAL OR DAMAGE TO EXISTING FACILITIES SHALL BE REPLACED OR REPAIRED TO EQUAL OR BETTER CONDITION BY THE CONTRACTOR.
- 1.14. CONTRACTOR SHALL NOT STORE MATERIALS, EQUIPMENT OR OTHER CONSTRUCTION ITEMS ON ADJACENT PROPERTIES OR RIGHT-OF-WAY WITHOUT THE PRIOR WRITTEN CONSENT OF THE PROPERTY OWNER AND/OR THE TOWN, AS
- APPLICABLE. 1.15. TEMPORARY FENCING SHALL BE INSTALLED PRIOR TO THE REMOVAL OF EXISTING FENCING. TEMPORARY FENCING SHALL BE REMOVED AFTER PROPOSED FENCING IS APPROVED BY THE TOWN. ALL TEMPORARY AND PROPOSED FENCING LOCATIONS SHALL BE SUBJECT TO FIELD REVISIONS AS DIRECTED BY THE TOWN.
- 1.16. UNUSABLE EXCAVATED MATERIAL, OR CONSTRUCTION DEBRIS SHALL BE IMMEDIATELY REMOVED AND DISPOSED OF OFFSITE AT AN APPROVED DISPOSAL FACILITY BY THE CONTRACTOR AT HIS EXPENSE.
- 1.17. IT IS THE CONTRACTOR'S RESPONSIBILITY TO MAINTAIN A NEAT AND ACCURATE RECORD OF CONSTRUCTION FOR THE TOWN'S RECORDS.

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#### 2. GENERAL NOTES FOR PAVING SYSTEMS

- 2.1. ALL PAVING CONSTRUCTION, TESTING, AND MATERIALS, INCLUDING CONCRETE, REINFORCEMENT, JOINTING, AND SUBGRADE PREPARATION AND TREATMENT SHALL BE IN ACCORDANCE WITH THE TOWN'S CURRENT STANDARDS, DETAILS, AND CONSTRUCTION SPECIFICATIONS UNLESS OTHERWISE NOTES.
- 2.2.NO EARTHWORK, LIME APPLICATION, OR OTHER PREPARATION OF THE SUBGRADE FOR PAVING OF STREETS, ALLEYS, OR FIRE LANES SHALL BE INITIATED WITHOUT AUTHORIZATION FROM THE TOWN. THE TOWN WILL AUTHORIZE THE SUBGRADE ENGINEERING STANDARDS WORK IN PREPARATION FOR PAVING AFTER UTILITY TRENCH BACKFILL TESTING HAS BEEN COMPLETED AND VERIFIED TO MEET THE TOWN REQUIREMENTS.
- 2.3. SUBGRADE 2.3.1. SHALL EXTEND 12" MIN. BEHIND THE BACK OF CURB.
- 2.3.2. SUBGRADE UNDER ALL PAVEMENT SHALL BE 6" THICK AND SHALL BE STABILIZED HTH AT LEAST 30 LBS. PER SQ. YD. HYDRATED LIME, COMPACTED TO A DENSITY NOT LESS THAN 95 PERCENT.
- 2.3.3. LABORATORY TESTS MUST BE SUBMITTED TO THE PUBLIC WORKS DEPARTMENT FOR APPROVAL TO DETERMINE AMOUNT OF LIME REQUIRED. LABORATORY TEST MAY BE WAIVED PROVIDED AT LEAST 36 LBS. OF LIME PER SQ. YD. IS USED. SEE NCTCOG ITEM 301.2 "LIME TREATMENT".
- 2.3.4. FLEXIBLE BASE (CRUSHED STONE/CONCRETE) PER NCTCOG ITEM 301.5 MAY BE SUBSTITUTED FOR LIME TREATMENT WITH THE APPROVAL OF THE TOWN
- 2.4. REINFORCING STEEL
- 2.4.1. BAR LAPS SHALL BE THIRTY DIAMETERS.
- 2.4.2. REINFORCING STEEL SHALL BE #3 REBAR (3/8') ON 18' CENTERS FOR 8" OR LESS PAVEMENT THICKNESS, #4 FOR 10" OR MORE PAVEMENT THICKNESS. 2.4.3. REBAR SHALL BE SUPPORTED BY BAR CHAIRS OR OTHER DEVICES APPROVED BY TOWN ENGINEER.
- 2.4.4. NO TRAFFIC ON FINISHED SUBGRADE SHALL BE PERMITTED AFTER REINFORCING STEEL IS INSTALLED ABOVE SUBGRADE. NO TRAFFIC SHALL BE PERMITTED BEFORE OR DURING THE PLACING OF CONCRETE.
- 2.5. CONCRETE PAVEMENT:

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- 2.5.1. ALL CONCRETE STRENGTH AND MIX DESIGN SHALL BE AS SHOWN IN LATEST EDITION OF NCTCOG SECTION 303.3
- 2.5.2. CLASS P1 PAVEMENT: MACHINE FINISHED: A SLIP-FORM PAVING MACHINE SHALL BE USED FOR ALL PUBLIC STREETS AND ALLEYS UNLESS OTHERWISE APPROVED BY THE DIRECTOR OF PUBLIC WORKS & ENGINEERING SERVICES. MIN. 4000 PSI 28-DAY COMPRESSIVE STRENGTH.

2.5.3. CLASS P2 PAVEMENT : HAND FINISHED: HAND FINISHED PAVEMENT IS PERMITTED FOR TURN LANES, DECELERATION LANES, DRIVEWAY APPROACHES, OR PANEL REPLACEMENT OF PUBLIC STREETS OR ALLEYS. MIN. 4500 PSI 28-DAY COMPRESSIVE STRENGTH

- 2.5.4. MINIMUM PAVEMENT THICKNESS SHALL BE AS FOLLOWS:
- 2.5.4.1. MAJOR ARTERIAL 10" CLASS "P1" OR "P2"
- MINOR ARTERIAL 8" CLASS "P1" OR "P2" COMMERCIAL/ INDUSTRIAL COLLECTOR - 8" CLASS "P1" OR "P2"
- RESIDENTIAL COLLECTOR 8" CLASS "P1" OR "P2"
- RESIDENTIAL LOCAL 8" CLASS "P1" OR "P2" 2.5.4.5.
- 2.5.4.6. SIDEWALK AND BFR'S 4" CLASS "A" 2.5.4.7. DRIVE APPROACH 8" – CLASS "P2"
- 2.5.4.8. ALLEY 6" CLASS "P1" OR "P2"
- 2.5.5. CONCRETE FOR ALLEY RETURNS AND DRIVEWAYS SHALL HAVE A MINIMUM COMPRESSIVE STRENGTH AT 28 DAYS IDENTICAL TO THAT SPECIFIED FOR THE STREET PAVEMENT OR BASE WHEN BUILT AS COMPONENTS OF A CONCRETE PAVING PROJECTS. WHEN BUILT SEPARATELY, THE STRENGTH SHALL BE AS SPECIFIED ON THE CONSTRUCTION PLAN.
- 2.5.6. SPACING AND CONSTRUCTION OF JOINTS SHALL CONFORM TO TOWN OF ADDISON STANDARD CONSTRUCTION DETAILS.
- 2.5.7. CONTRACTOR IS RESPONSIBLE FOR ENSURING ALL PEDESTRIAN WORK MEETS OR EXCEEDS THE CURRENT AMERICAN WITH DISABILITIES ACT ACCESSIBILITY GUIDELINES (ADAAG), THE TEXAS ACCESSIBILITY STANDARDS (TAS), AND PUBLIC RIGHTS-OF-WAY ACCESSIBILITY GUIDELINES (PROWAG). THE CONTRACTOR SHALL REMOVE AND REPLACE ANY CONSTRUCTED OR INSTALLED ITEMS NOT MEETING THE CURRENT ADAAG, TAS, & PROWAG REQUIREMENTS AT NO ADDITIONAL COST
- 2.5.8. ALL MEDIANS AND PARKWAYS SHALL BE PROVIDED WITH GROUND COVER. TYPE OF GROUNDCOVER SHALL BE DETERMINED BY THE PARKS & RECREATION DEPARTMENT, OR SHALL BE RESTORED TO MATCH EXISTING PLANT MATERIALS IN EQUAL OR BETTER CONDITION. ALL TURF AREAS SHALL BE SOLID SOD, AND GROUNDCOVER SHALL BE MINIMUM ONE (1) GALLON PLANT MATERIAL.

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#### 3. GENERAL NOTES FOR WATER AND WASTEWATER SYSTEMS

- 3.1.ALL WATER AND WASTEWATER CONSTRUCTION, TESTING, AND MATERIALS SHALL BE IN ACCORDANCE WITH THE MORE RESTRICTIVE OF THE CURRENT TCEQ REGULATIONS OR THE TOWN'S CURRENT STANDARDS, DETAILS, AND SPECIFICATIONS, UNLESS OTHERWISE NOTED.
- 3.2. TRENCH SAFETY

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- 3.2.1. PRIVATE DEVELOPMENT: CONTRACTOR SHALL SUBMIT A TRENCH SAFETY PLAN TO THE DESIGN ENGINEER FOR REVIEW AND APPROVAL PRIOR TO THE PRE-CONSTRUCTION MEETING.
- 3.2.2. PUBLIC PROJECTS: CONTRACTOR AND/OR DESIGN ENGINEER SHALL SUBMIT A TRENCH SAFETY PLAN AS PART OF THE CIVIL CONSTRUCTION DOCUMENTS
- 3.3. CONTRACTOR SHALL NOT OPERATE ANY WATER VALVES THAT ARE PART OF THE ACTIVE TOWN OF ADDISON WATER SYSTEM. CONTACT THE TOWN'S PUBLIC WORKS & ENGINEERING SERVICES TO REQUEST VALVE CHANGES.
- 3.4. ANY EXISTING FIRE HYDRANT THAT IS TO BE MODIFIED AND HAS A DATE THAT EXCEEDS 8 YEARS IN AGE SHALL BE REPLACED AND THE OLD FIRE HYDRANT RETURNED TO THE PUBLIC WORKS & ENGINEERING SERVICES BY THE CONTRACTOR AT HIS EXPENSE.
- 3.5. ANY EXISTING MANHOLE WITH AN OPENING SMALLER THAN 30" DIAMETER THAT IS MODIFIED SHALL HAVE THE CONE SECTION, RING, AND COVER REPLACED WITH A MINIMUM OF 30" DIAMETER CONE SECTION, RING, AND COVER BY THE CONTRACTOR

#### 4. GENERAL NOTES FOR STORM DRAIN SYSTEMS

- 4.1. ALL STORM DRAIN CONSTRUCTION, TESTING, AND MATERIALS SHALL BE IN ACCORDANCE WITH THE LATEST EDITON OF NCTCOG'S SPECIFICATIONS AND DETAILS, AND THE TOWN'S CURRENT STANDARDS, DETAILS, AND SPECIFICATIONS UNLESS OTHERWISE NOTED.
- 4.2. TRENCH SAFETY 4.2.1. PRIVATE DEVELOPMENT: CONTRACTOR SHALL SUBMIT A TRENCH SAFETY PLAN TO THE DESIGN ENGINEER FOR REVIEW AND APPROVAL PRIOR TO THE PRE-
- CONSTRUCTION MEETING. 4.2.2. PUBLIC PROJECTS: CONTRACTOR AND/OR DESIGN ENGINEER SHALL SUBMIT A TRENCH SAFETY PLAN AS PART OF THE CIVIL CONSTRUCTION DOCUMENTS
- 4.3. ALL CONCRETE DRAINAGE STRUCTURES SHALL BE MINIMUM CLASS C CONCRETE.
- 4.4. ALL CRUSHED STONE SHALL BE 3/4", PASSING #4 SIEVE (GRADE 4). 4.5. ALL FIELD JOINTS WILL BE APPROVED BY THE TOWN ENGINEER IF NECESSARY. FIELD JOINTS SHALL BE WIPED ON THE INSIDE AND OUTSIDE AND PROVIDE FOR SMOOTH FLOW OF WATER.
- 4.6. RAMNECK COMPOUND OR APPROVED EQUAL SHALL BE USED FOR JOINT SEALS.
- 4.7. CLEANING & INSPECTION 4.7.1. ALL STORM SEWER PIPE SHALL BE CAMERA INSPECTED AFTER THE INSTALLATION OF ALL PAVING AND UTILITIES AND PRIOR TO FINAL ACCEPTANCE OF THE
- 4.7.2. CONTRACTOR SHOULD INSPECT ALL STORM DRAIN OUTFALLS NO EARLIER THAN ONE WEEK PRIOR TO FINAL INSPECTION AND REMOVE ALL SILT AND DEBRIS.

#### 5. GENERAL NOTES FOR EROSION CONTROL

- 5.1.ALL OPERATORS AND/OR CONTRACTORS SHALL CONFORM TO THE TERMS &
- CONDITIONS OF THE TCEQ TPDES GENERAL PERMIT NO. 150000. 5.1.1. THE NOTICE OF INTENT (NOI), AS REQUIRED BY THE GENERAL PERMIT, MUST BE PROPERLY DISPLAYED ON THE SITE AT ALL TIMES BY EACH OPERATOR. A COPY OF THE NOI MUST BE PROVIDED TO THE PUBLIC WORKS & ENGINEERING SERVICES
- PRIOR TO START OF CONSTRUCTION. 5.1.2. ALL RELEASES OF REPORTABLE OUANTITIES OF HAZARDOUS SUBSTANCES SHALL
- BE REPORTED IMMEDIATELY TO THE FACILITY OPERATOR, EPA, AND TCEQ 5.1.3. IF ANY CONTRACTOR SEES A VIOLATION BY AN OPERATOR OR ANOTHER CONTRACTOR, THAT OPERATOR OR CONTRACTOR IN VIOLATION SHALL BE
- NOTIFIED AS WELL AS THE FACILITY OPERATOR. 5.2. EROSION CONTROL DEVICES SHALL BE INSTALLED ON ALL PROJECTS PRIOR TO ANY SOIL DISTURBANCE AND SHALL BE MAINTAINED THROUGHOUT THE PROJECT IN A CONDITION ACCEPTABLE TO THE TOWN.
- 5.2.1. IT SHALL BE THE CONTRACTOR'S RESPONSIBILITY TO CONTROL AND LIMIT SILT AND SEIDMENT LEAVING THE SITE. SPECIFICALLY, THE CONTRACTOR SHALL PROTECT ALL PUBLIC STREETS, ALLEYS, STREAMS, AND STORM DRANAGE SYSTEMS
- FROM EROSION DEPOSITS. 5.2.1.1. QUALIFIED OPERATOR PERSONNEL MUST INSPECT THE SITE WEEKLY, AND WITHIN 24 HRS (BEFORE AND AFTER) A STORM EVEN OF 0.5 INCHES OR
- 5.2.1.2. ACCUMULATED SILT DEPOSITS SHALL BE REMOVED FROM SILT FENCES AND HAY BALE DIKES WHEN SILT DEPTH REACHES THREE INCHES (3") OF 25% OF THE HEIGHT OF THE DEVICE (WHICHEVER IS LESS). THE SILT SHALL BE DISPOSED OF AT AN APPROVED SITE AND IN SUCH A MANNER SO AS NOT TO CONTRIBUTE TO ADDITIONAL SILTATION.
- 5.2.2. THE CONTRACTOR SHALL ADD OR DELETE EROSION PROTECTION AT THE
- REQUEST AND DIRECTION OF THE OPERATOR OR TOWN. 5.2.3. MODIFICATIONS TO THE SWPPP SHALL BE IMPLEMENTED AND IN-PLACE WITHIN A SEVEN CALENDAR DAY PERIOD. ANY MAJOR MODIFICATIONS SHALL BE REVIEWED AND APPROVED BY THE DESIGN ENGINEER AND PUBLIC WORKS & ENGINEERING SERVICES PRIOR TO IMPLEMENTATION.
- 5.3. CONSTRUCTION ENTRANCES AND WASHOUTS

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- 5.3.1. ASPHALT BAGS SHALL BE PLACED AT CONSTRUCTION ENTRANCES TO PREVENT CURB DAMAGE.
- 5.3.2. GEOTEXTILE FABRIC SHALL BE PLACED ON SUBGRADE PRIOR TO STONE PLACEMENT FOR CONSTRUCTION ENTRANCES.
- 5.3.3. NO EQUIPMENT SHALL BE CLEANED ON-SITE, OR OTHER LIQUIDS DEPOSITED AND ALLOWED TO FLOW OVERLAND OR SUBTERRANEAN WITHIN THE LIMITS OF

PAINT, OIL, SOLVENTS, ASPHALT, CONCRETE, CONCRETE EQUIPMENT WASH WATER, MORTAR OF SIMILAR MATERIALS.

#### 5.4. WASTE DISPOSAL

5.6. SILT FENCE NOTES.

5.4.1. CONTRACTOR SHALL PROVIDE WASTE DISPOSAL CONTAINERS ON THE SITE FOR DISPOSAL OF ALL NON-HAZARDOUS CONSTRUCTION WASTE MATERIALS. THE CONTAINERS SHALL BE HAULED TO THE APPROPRIATE DISPOSAL LOCATION BY THE

THE CRITICAL ROOT ZONE OF TREES THAT REMAIN ON SITE. THIS INCLUDES

- 5.4.2. ALL HAZARDOUS MATERIALS SHALL BE HANDLED AND DISPOSED OF BY THE
- CONTRACTOR IN ACCORDANCE WITH FEDERAL, STATE, AND LOCAL REGULATIONS 5.5.AFTER INSTALLATION OF PAVEMENT, FINAL LOT BENCHING, AND GENERAL CLEANUP, THE CONTRACTOR SHALL ESTABLISH GRASS GROUNDCOVER IN ALL STREET PARKWAYS, LOTS, AND ALL OTHER DISTURBED AREAS. SODDING SHALL BE DONE AS SPECIFIED BY THE MORE RESTRICTIVE OF CURRENT NCTCOG OR TOWN STANDARDS.
- 5.6.1. POSTS WHICH SUPPORT THE SILT FENCE SHALL BE INSTALLED ON A SLIGHT ANGLE TOWARD THE ANTICIPATED RUNOFF SOURCE. THE POST MUST BE EMBEDDED A MINIMUM OF 18". STEEL POSTS SHALL NOT BE USED TO INSTALL EROSION CONTROL MEASURES WITHIN TOWN ROW.
- 5.6.2. THE TOE OF THE SILT FENCE SHALL BE TRENCHED IN WITH A SPADE OR MECHANICAL TRENCHER SO THAT THE DOWNSLOPE FACE OF THE TRENCH IS FLAT AND PERPENDICULAR TO THE LINE OF FLOW.
- 5.6.2.1. THE TRENCH MUST BE A MINIMUM OF SIX INCHES (6") DEEP AND SIX INCHES (6") WIDE TO ALLOW FOR THE SILT FENCE FABRIC TO BE LAID IN THE GROUND AND BACKFILLED WITH COMPACTED MATERIAL. 5.6.2.2. WHERE THE FENCE CANNOT BE TRENCHED IN (E.G. PAVEMENT), WEIGHT

FABRIC FLAP WITH WASHED GRAVEL ON THE UPHILL SIDE TO PREVENT FLOW

- UNDER FENCE. 5.6.3. WIRE REINFORCEMENT SHALL BE USED ON ALL SILT FENCE USED FOR EROSION CONTROL. SILT FENCE SHALL BE SECURELY FASTENED TO EACH SUPPORT POST. THERE SHALL BE A SIX INCH (6") DOUBLE OVERLAP, SECURELY FASTENED, WHERE
- ENDS OF FABRIC MEET. 5.6.4. SILT FENCE SHALL BE REMOVED WHEN THE SITE IS COMPLETELY STABILIZED SO AS NOT TO BLOCK OR IMPEDE STORM FLOW OR DRAINAGE.

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STOP!

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**CALL BEFORE YOU DIG** 



**BENCHMARK:** 

Found TXDOT brass disc  $\pm/-256$  South of the southwest corner of Lot 5, Block 1, Sandshell Commercial Addition. Elevation = 651.86

Found X cut in concrete at the southwest corner of Lot 5, Block 1, Sandshell Commercial Addition (Shown Hereon). Elevation = 652.77

Issue Dates:	Revisions: Date:				
1 04/11/2021	1 04/19/2023	CDOCC	<b>ENGINEERING</b>		
2 07/05/2022	2	CICOS	CONSULTANTS		
3 08/12/2022	3	1720 W. Virginia Street	McKinney, Texas 75069		
4 08/30/2022	4	972.562.4409	Texas P.E. Firm No. F-5935		

The seal that originally appeared on this document was authorized by Casey R. McBroom, Texas No. 110104 on 11/15/2022. Alteration of a sealed document without proper notification of the responsible

Town Project No.: SP2022-02 GENERAL CONSTRUCTION NOTES 1.037 ACRES 4551 SUNBELT DRIVE

GN: Project No. 19121

(@ least 72 hours prior to digging)

Checked By: Scale: Drawn By: 1"=20' C.E.C.I. C.E.C.I.

Engineer is an offense under the Texas Engineering Practice Act.

SUNBELT BUSINESS PARK TRACT 13 TOWN OF ADDISON, DALLAS COUNTY, TEXAS Sheet No.

#### 6. GENERAL NOTES FOR LANDSCAPING

- 6.1.ALL LANDSCAPING CONSTRUCTION, INSTALLATION, TESTING, AND MATERIALS SHALL BE IN ACCORDANCE WITH THE TOWN'S CURRENT STANDARDS, DETAILS, AND SPECIFICATIONS UNLESS OTHERWISE NOTED.
- 6.2. CONTRACTOR SHALL AVOID DAMAGE TO EXISTING TREES. WHEN NECESSARY, TREES AND SHRUB TRIMMING FOR CONSTRUCTION SHALL BE PERFORMED BY CERTIFIED TREE WORKER OR UNDER THE DIRECTION OF A REGISTERED LANDSCAPE ARCHITECT OR CERTIFIED ARBORIST.
- 6.3. CONTRACTOR SHALL LOCATE AND PROTECT ALL EXISTING LANDSCAPE IRRIGATION SYSTEMS. DAMAGE TO EXISTING IRRIGATION SYSTEMS AND LANDSCAPE MATERIALS SHALL BE RESTORED TO EQUAL OR BETTER CONDITION AT NO COST TO TOWN.
- 6.4. EXCAVATION OR GRADE CHANGES BELOW THE DRIPLINE OF EXISTING TREES IS NOT ALLOWED UNLESS A TREE PROTECTION PLAN WHICH CONTAINS SPECIFIC INFORMATION ON THE ROOTS OF EACH TREE IS PROVIDED, AND APPROVED BY THE PARKS & RECREATION DEPARTMENT.
- 6.5. PRIOR TO OBTAINING A GRADING PERMIT OR SCHEDULING A PRE-CONSTRUCTION
- 6.5.1. WHERE TRANSPLANTING OR TREE REMOVAL IS REQUIRED, CONTRACTOR MUST APPLY FOR A TREE PERMIT. CONTACT PARKS & RECREATION DEPARTMENT FOR TREE REMOVAL PERMIT.
- 6.5.2. ALL TREE MARKINGS AND PROTECTIVE FENCING MUST BE INSTALLED BY THE CONTRACTOR AND BE INSPECTED BY THE TOWN'S LANDSCAPE ARCHITECT. 6.5.3. COORDINATE WITH PARKS DEPARTMENT ON ANY TREES THAT REQUIRE BEING TRANSPLANTED OR REMOVED FROM MEDIANS.
- 6.6. ALL TREES WHICH ARE TO REMAIN ON SITE SHALL BE PROTECTED WITH A 4' TALL BRIGHTLY COLORED PLASTIC FENCE PLACED AT THE DRIP LINE OF THE TREES.
- 6.7. TREES TO BE REMOVED MAY BE CHIPPED AND USED FOR MULCH ON SITE OR HAULED OFF-SITE. BURNING OF REMOVED TREES, STUMPS, OR FOLIAGE REQUIRES WRITTEN APPROVAL BY THE FIRE DEPARTMENT.
- 6.8. PLANT MATERIALS SHALL NOT IMPEDE OR OBSTRUCT VISION OR ROUTE OF TRAVEL FOR VEHICULAR, PEDESTRIAN, OR BICYCLE TRAFFIC ALONG TOWN RIGHT-OF-WAY, VISIBILITY EASEMENTS, SIDEWALKS OR OTHER EASEMENTS.
- 6.9. NO SIGNS, WIRES, OR OTHER ATTACHMENTS OTHER THAN THOSE OF A PROTECTIVE NATURE SHALL BE ATTACHED TO ANY TREE TO REMAIN ON SITE.
- 6.10. IF TOPSOIL IS TO BE ADDED TO A ROUGH GRADE, TILL 3 TO 4 INCHES DEEP, THEN ADD TOPSOIL FOR BETTER BINDING AND ELIMINATE LAYING. 6.11. SOD INSTALLATION
- 6.11.1. SPRAY EXISTING WEEDS WITH NON-SELECTIVE HERBICIDE PRIOR TO SOD INSTALLATION.

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- 6.11.2. ON PUBLIC PROJECTS, THE TOWN'S REPRESENTATIVE RESERVES THE RIGHT TO INSPECT SOD FARM TO SELECT SOD TO BE HARVESTED. INSPECTION OF TURFGRASS SOD BY THE TOWN'S REPRESENTATIVE MAY BE MADE AT THE GROWING SITE, BUT SUCH INSPECTION WILL NOT PRECLUDE REJECTIONS AFTER DELIVERY TO THE JOB SITE.
- 6.11.3. NO MORE TURFGRASS SOD SHALL BE DELIVERED TO THE JOB SITE ON ANY DAY THAN CAN BE PLACED AND WATERED ON THAT DAY.
- 6.11.4. THE IRRIGATION SYSTEM SHOULD BE FULLY OPERATIONAL AT THE SITE PRIOR TO INSTALLATION OF THE TURFGRASS SOD.
- 6.11.5. ANY TURFGRASS SOD SO REJECTED SHALL BE REMOVED FROM THE SITE
- IMMEDIATELY AND REPLACED WITH ACCEPTED TURFGRASS SOD. 6.11.6. CONTRACTOR SHALL PROVIDE OPTIMUM INSTALLATION TIME PERIOD FOR
- SOD, NO INSTALLATION ON FROZEN SOIL, NO HARVEST OF FROZEN SOD. 6.12. PLANTING TIME FOR MEDIANS IS MARCH TO SEPTEMBER. OUTSIDE OF THIS TIME
- FRAME THE MEDIAN SHALL BE STABILIZED.
- 6.13. ESCROW FOR THE REMOVAL OF TEMPORARY STABILIZATION AND INSTALLATION OF SOD PER SPEC.

#### 7. GENERAL NOTES FOR IRRIGATION

TOA General Construction Notes | 01/2022

- 7.1.ALL IRRIGATION CONSTRUCTION, INSTALLATION, TESTING, AND MATERIALS SHALL BE IN ACCORDANCE WITH THE TOWN'S CURRENT STANDARDS, DETAILS, AND SPECIFICATIONS UNLESS OTHERWISE NOTED.
- 7.2.A PERMIT FROM THE BUILDING INSPECTION DIVISION IS REQUIRED FOR EACH IRRIGATION SYSTEM.
- 7.3. CONTRACTOR SHALL NOTIFY THE PARKS AND RECREATION DEPARTMENT PRIOR TO ANY MODIFICATIONS TO THE EXISTING IRRIGATION SYSTEM. 7.4. CONTRACTOR SHALL CONTACT THE PARKS AND RECREATION DEPARTMENT TO
- COORDINATE WORK PRIOR TO COMMENCING WORK ON ANY EXISTING IRRIGATION AND PRIOR TO ANY INSTALLATION OF NEW IRRIGATION.
- 7.5. CONTRACTOR SHALL LOCATE AND PROTECT ALL EXISTING LANDSCAPE IRRIGATION SYSTEMS. DAMAGE TO EXISTING IRRIGATION SYSTEMS AND LANDSCAPE MATERIALS SHALL BE RESTORED TO EQUAL OR BETTER CONDITION AT NO COST TO TOWN.
- 7.6. CONTRACTOR SHALL PROGRAM EACH CONTROLLER ZONE BASED ON SPRINKLER TYPE, PLANT VARIETY, SOIL CHARACTERISTIC, SLOPE AND SOLAR ORIENTATION AS DESIGNATED ON THE PLANS. THE CONTRACTOR SHALL COORDINATE WITH THE TOWN PARKS AND RECREATION DEPARTMENT FOR APPROVAL OF THE CONTROLLER SETTINGS.
- 7.7. CONTRACTOR SHALL BE RESPONSIBLE FOR COORDINATING WITH FRANCHISE UTILITY PROVIDER TO PROVIDE POWER TO EACH IRRIGATION CONTROLLER. CONTRACTOR SHALL HAVE UNDERGROUND POWER LINES INSTALLED FROM POWER SOURCE UP TO THE CONTROLLER. CONTRACTOR SHALL MEET CONTROLLER SPECIFICATIONS FOR POWER REQUIREMENTS.
- 7.8. CONTRACTOR SHALL SET TOWN-SPECIFIED/APPROVED CONTROLLER TO ESTABLISH LANDSCAPE.

#### 8. GENERAL NOTES FOR TRAFFIC CONTROL

- 8.1. CONTRACTOR SHALL BE RESPONSIBLE FOR FURNISHING AND INSTALLING ALL TEMPORARY AND PERMANENT TRAFFIC CONTROL IN ACCORDANCE WITH THE MINIMUM REQUIREMENTS OF THE LATEST REVISION OF THE TEXAS MANUAL ON UNIFORM TRAFFIC CONTROL DEVICES (TMUTCD) AND TXDOT BARRICADE AND CONSTRUCTION
- 8.2. CONTRACTOR SHALL NOT IMPEDE TRAFFIC ON EXISTING STREETS, DRIVEWAYS, ALLEYS, OR FIRE LANES OPEN TO THE PUBLIC. IN THE EVENT THE CONSTRUCTION WORK REQUIRES THE CLOSURE OF AN EXISTING STREET, ALLEY, OR FIRE LANE, THE CONTRACTOR SHALL REQUEST THE ROAD CLOSURE THROUGH THE PUBLIC WORKS & ENGINEERING SERVICES A MINIMUM OF 72 HOURS IN ADVANCE OF THE REQUESTED CLOSURE. CLOSURES WILL NOT BE ALLOWED PRIOR TO 9:00 A.M. OR AFTER 3:30 P.M., MONDAY THROUGH FRIDAY UNLESS OTHERWISE APPROVED BY THE TOWN.

TOA General Construction Notes | 01/2022

CONTRACTOR AND WILL REMAIN THE PROPERTY OF THE TOWN. CONTACT THE TRAFFIC DEPARTMENT AT LEAST 24 HOURS IN ADVANCE OF DELIVERY.

- 9.12. DURING THE 30-DAY TRAFFIC SIGNAL TEST PERIOD, CONTRACTOR SHALL RESPOND TO AND DIAGNOSE ALL TROUBLE CALLS WITH QUALIFIED PERSONNEL WITHIN A REASONABLE TRAVEL TIME FROM A DALLAS ADDRESS, BUT NOT MORE THAN TWO (2) HOURS MAXIMUM. CONTRACTOR SHALL REPAIR ANY MALFUNCTIONS OF SIGNAL EQUIPMENT SUPPLIED BY CONTRACTOR ON THE PROJECT. A LOCAL TELEPHONE NUMBER (NOT SUBJECT TO FREQUENT CHANGES) WHERE TROUBLE CALLS ARE TO BE RECEIVED ON A 24-HOUR BASIS SHALL BE PROVIDED TO THE TOWN BY THE CONTRACTOR. APPROPRIATE REPAIRS SHALL BE MADE WITHIN 24 HOURS. THE CONTRACTOR SHALL KEEP A RECORD OF EACH TROUBLE CALL REPORTED IN THE LOGBOOK PROVIDED BY THE TOWN AND SHALL NOTIFY THE TOWN OF EACH TROUBLE CALL. THE ERROR LOG IN THE MALFUNCTION MANAGEMENT UNIT (MMU) SHALL NOT BE CLEARED DURING THE 30-DAY TEST PERIOD WITHOUT THE APPROVAL OF THE
- 9.13. TEXAS STATE LAW, ARTICLE 1436C, MAKES IT UNLAWFUL TO OPERATE EQUIPMENT OR MACHINES WITHIN 10-FEET OF ANY OVERHEAD ELECTRICAL LINES UNLESS DANGER AGAINST CONTACT WITH HIGH VOLTAGE OVERHEAD LINES HAS BEEN EFFECTIVELY GUARDED AGAINST PURSUANT TO THE PROVISIONS OF THIS ARTICLE. WHEN CONSTRUCTION OPERATIONS REQUIRE WORKING NEAR AN OVERHEAD ELECTRICAL LINE, THE CONTRACTOR SHALL CONTACT THE OWNER/OPERATOR OF THE OVERHEAD ELECTRICAL LINE TO MAKE ADEQUATE ARRANGEMENTS AND TO TAKE NECESSARY SAFETY PRECAUTIONS TO ENSURE THAT ALL LAWS, ELECTRICAL LINE OWNER/OPERATOR REQUIREMENTS AND STANDARD SAFETY PRACTICES ARE MET.

TOA General Construction Notes | 01/2022

#### 9. GENERAL NOTES FOR TRAFFIC SIGNALS AND STREET LIGHTING

9.1.ALL TRAFFIC SIGNAL AND STREET LIGHTING CONSTRUCTION, TESTING, AND MATERIALS SHALL BE IN ACCORDANCE WITH THE TOWN'S CURRENT STANDARDS, DETAILS, AND SPECIFICATIONS UNLESS OTHERWISE NOTED. ALL ELECTRICAL WORK SHALL BE IN ACCORDANCE WITH THE MOST CURRENT NATIONAL ELECTRICAL CODE, TOWN AND TXDOT SPECIFICATIONS AND STANDARDS.

12

- 9.2. CONTRACTOR SHALL NOTIFY THE TRAFFIC DEPARTMENT AT LEAST 7 BUSINESS DAYS PRIOR TO ANY WORK, PROVIDE A CONSTRUCTION SCHEDULE AND WEEKLY PROGRESS REPORTS TO THE TRAFFIC DEPARTMENT, AND NOTIFY THE TRAFFIC DEPARTMENT AT LEAST 48 HOURS PRIOR TO SIGNAL TURN-ON.
- 9.3. CONTRACTOR SHALL COORDINATE ELECTRICAL SERVICES WITH THE TOWN AND
- 9.4. CONTRACTOR SHALL COORDINATE WITH THE ELECTRIC COMPANY TO DE-ENERGIZE ANY OVERHEAD OR UNDERGROUND POWER LINES. ANY COST ASSOCIATED WITH DE-ENERGIZING THE POWER LINE AND/OR ANY OTHER PROTECTIVE MEASURES REQUIRED
- 9.5. THE CONTRACTOR SHALL COORDINATE WITH THE APPROPRIATE UTILITY COMPANY AND TXDOT/NTTA (IF WITHIN TXDOT/NTTA ROW) PRIOR TO BEGINNING ERECTION OF POLES, LUMINARIES AND STRUCTURES LOCATED NEAR ANY OVERHEAD OR
- 9.6. PROPOSED CONCRETE FOUNDATION AND CONDUIT ALIGNMENT SHALL BE STAKED BY THE CONTRACTOR AND APPROVED BY THE TOWN PRIOR TO INSTALLATION.
- TECHNICIAN ON THE PROJECT SITE TO PLACE THE TRAFFIC SIGNALS IN OPERATION.
- 9.10. THE CONTRACTOR SHALL NOT PLACE PEDESTRIAN CROSSWALK AND STOP BAR
- 9.11. ALL LIGHTING POLES, FIXTURES, AND ARMS WHICH ARE REMOVED SHALL BE

TOA General Construction Notes | 01/2022

- EITHER ONCOR OR COSERV REPRESENTATIVES (ACCORDING TO THEIR RESPECTIVE
- SHALL BE AT NO COST TO TOWN.
- UNDERGROUND UTILITIES.
- 9.7. CONTRACTOR SHALL CONTACT THE TOWN TRAFFIC DEPARTMENT (BETWEEN 8 AM -5PM) FOR INSPECTION PRIOR TO POURING ANY CONCRETE FOUNDATION AND DIGGING FOR CONDUIT RUNS AT LEAST 48 HOURS IN ADVANCE.
- 9.8. CONTRACTOR SHALL HAVE A QUALIFIED IMSA LEVEL II OR A TRF453 CERTIFIED
- 9.9. ELECTRICAL WORK SHALL BE PERFORMED BY CERTIFIED PERSONS IN ACCORDANCE WITH THE REQUIREMENTS OF THE CONTRACT AND MAY BE REJECTED AS UNSUITABLE FOR USE DUE TO POOR WORKMANSHIP. THE REQUIRED ELECTRICAL CERTIFICATION COURSE IS AVAILABLE AND IS SCHEDULED PERIODICALLY BY TEEX. ALTERNATIVELY, THE CONTRACTOR MAY PURCHASE AN ENTIRE COURSE FOR THEIR PERSONNEL TO BE HELD AT A TIME AND LOCATION OF THEIR CHOICE AS NEGOTIATED THROUGH TEEX. FOR MORE INFORMATION, CONTACT: TEXAS ENGINEERING EXTENSION SERVICE (TEEX), TXDOT ELECTRICAL SYSTEM COURSE.
- PAVEMENT MARKINGS UNTIL SIGNAL IS OPERATIONAL.
- DELIVERED TO THE TOWN PUBLIC WORKS & ENGINEERING SERVICES FACILITY BY THE

## STOP! **CALL BEFORE YOU DIG**



**BENCHMARK:** 

Found TXDOT brass disc  $\pm/-256$  South of the southwest corner of Lot 5, Block 1, Sandshell Commercial Addition. Elevation = 651.86

Found X cut in concrete at the southwest corner of Lot 5, Block 1, Sandshell Commercial Addition (Shown Hereon). Elevation = 652.77

1 04/11/2021	1 04/19/2023			NEERING		
2 07/05/2022	2		CONS	SULTANTS		
3 08/12/2022	3	1720 W. Virginia Str		Kinney, Texas 75069		
4 08/30/2022	4	972.562.4409	Texa	Texas P.E. Firm No. F-5935		
5 11/15/2022	5	Drawn By:	Checked By:	Scale:		
6	6	C.E.C.I.	C.E.C.I.	1"=20'		

Date:

Issue Dates: Revisions:

The seal that originally appeared on this document was authorized by Casey R. McBroom, Texas No. 110104 on 11/15/2022. Alteration of a sealed document without proper notification


of the responsible Engineer is an offense under the Texas TOWN OF ADDISON, DALLAS COUNTY, TEXAS Engineering Practice Act.


Town Project No.: SP2022-02 GENERAL CONSTRUCTION NOTES 1.037 ACRES 4551 SUNBELT DRIVE SUNBELT BUSINESS PARK TRACT 13


Sheet No. GN2


Project No. 19121


(@ least 72 hours prior to digging)

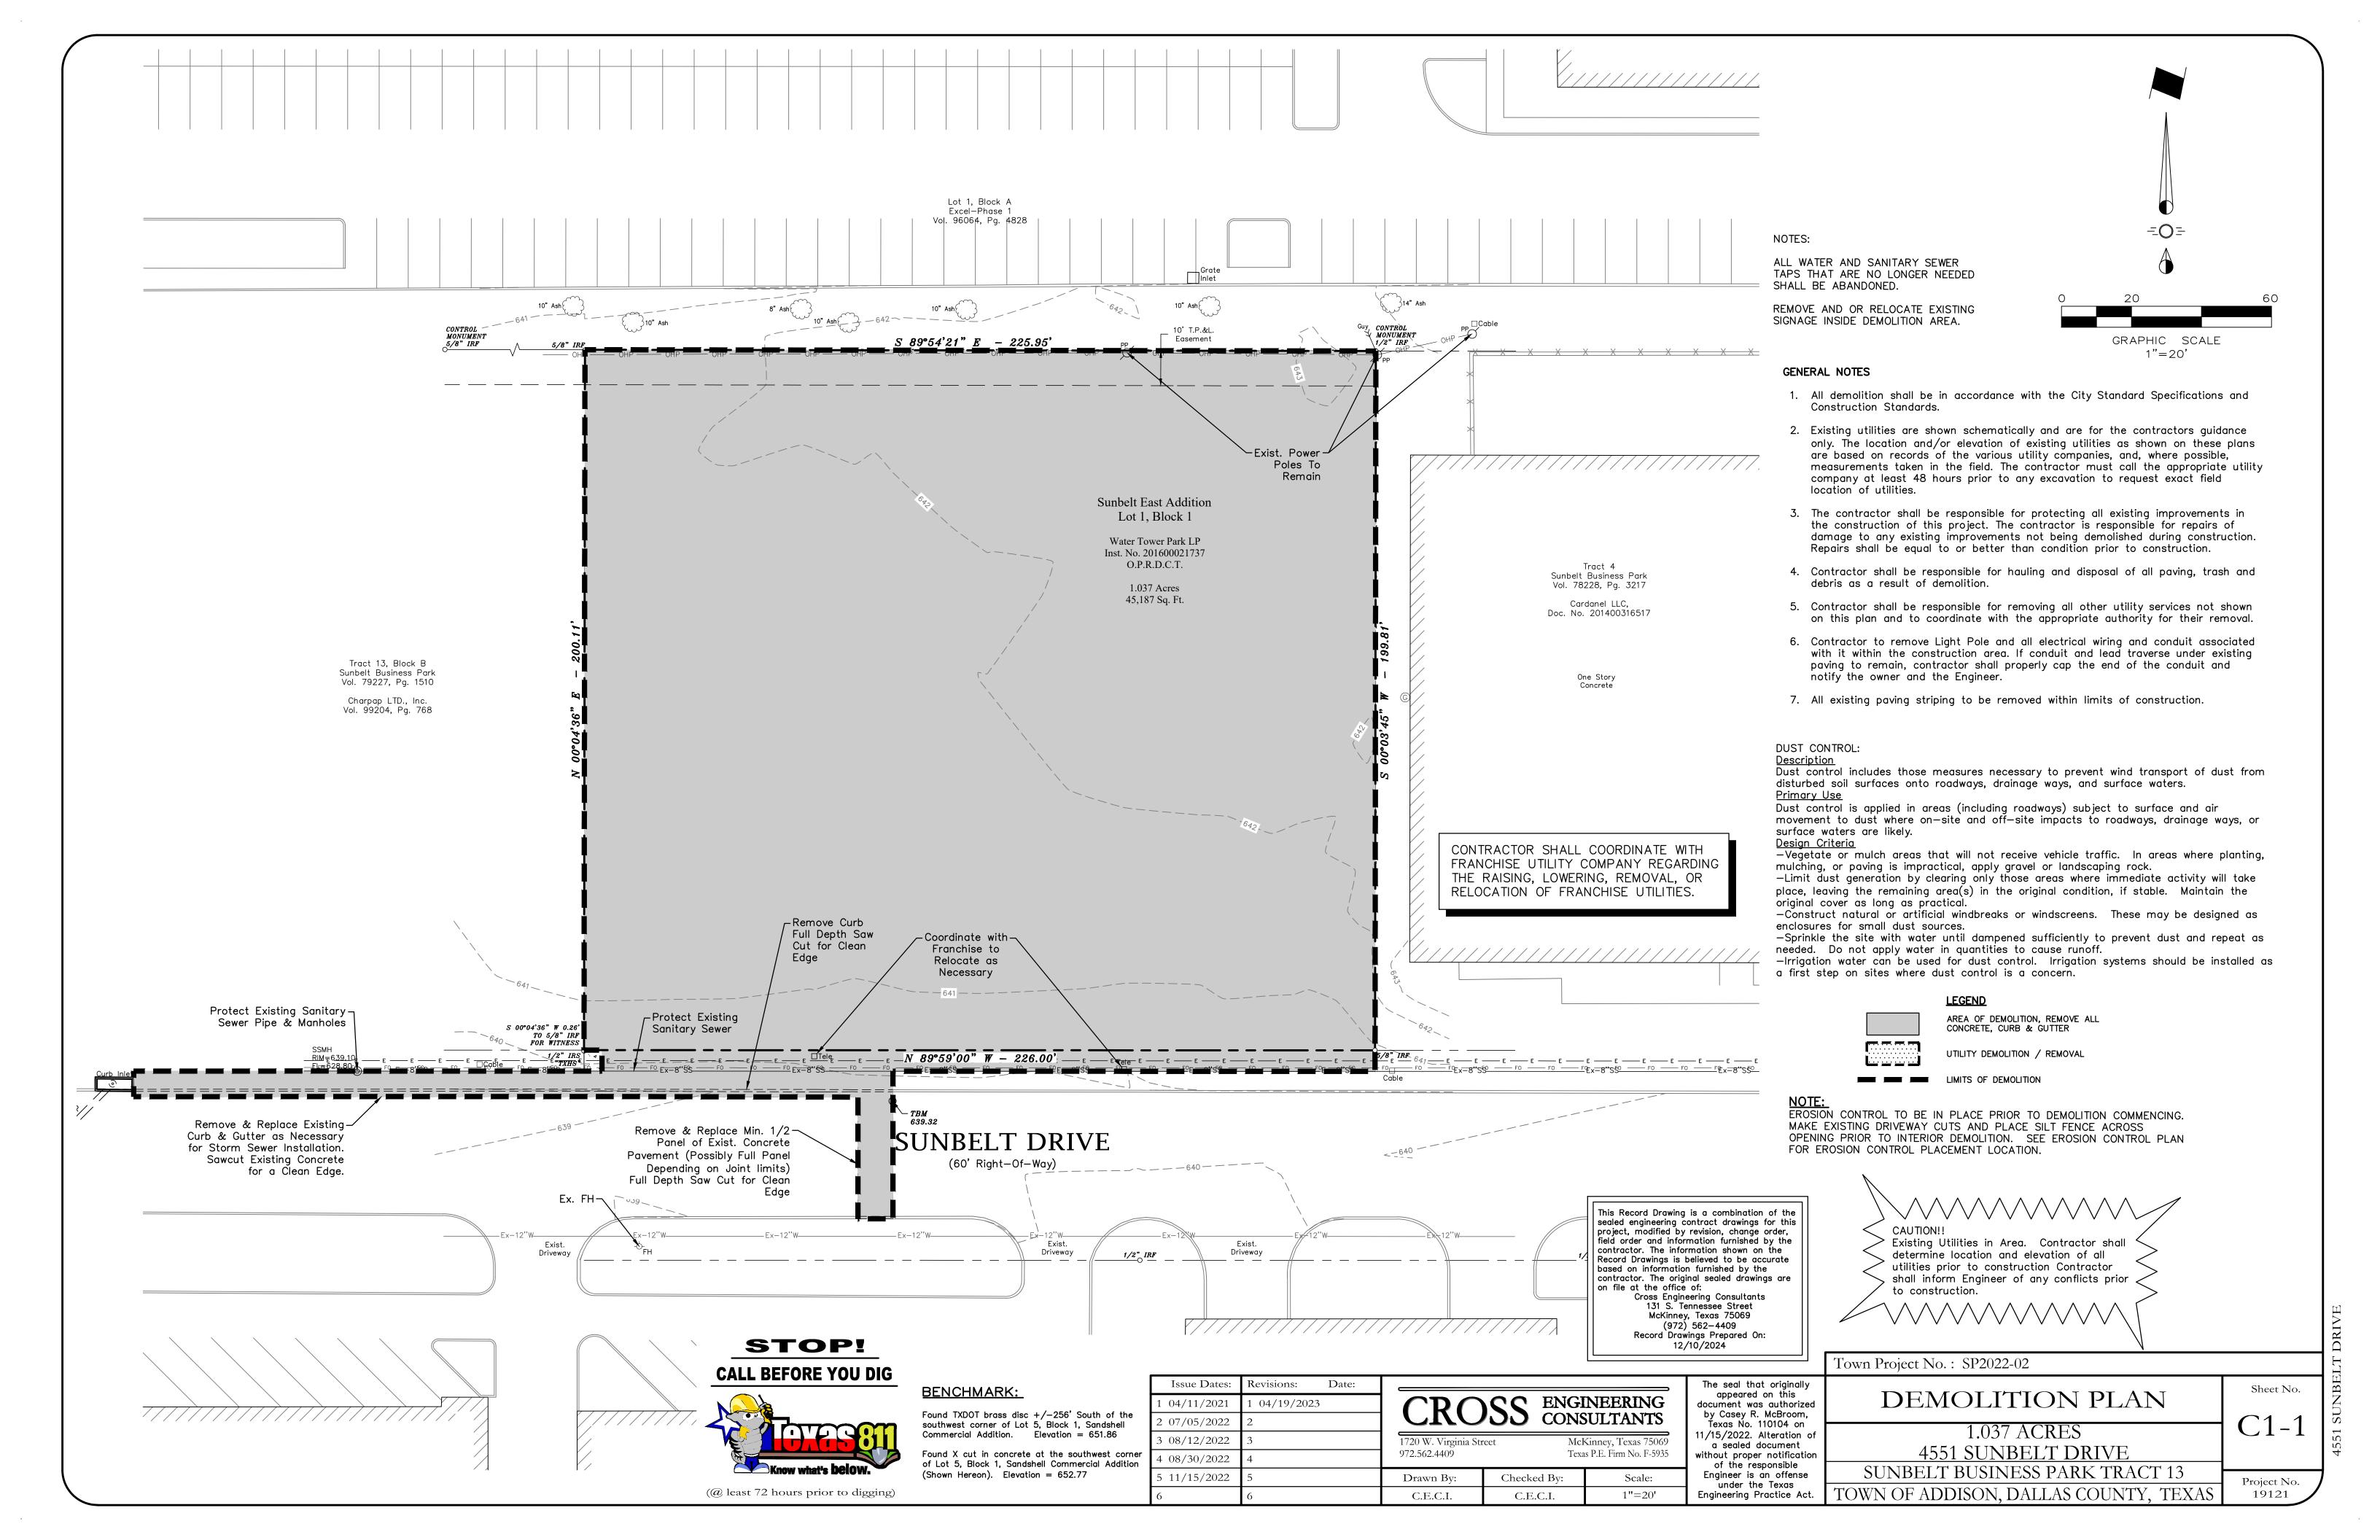

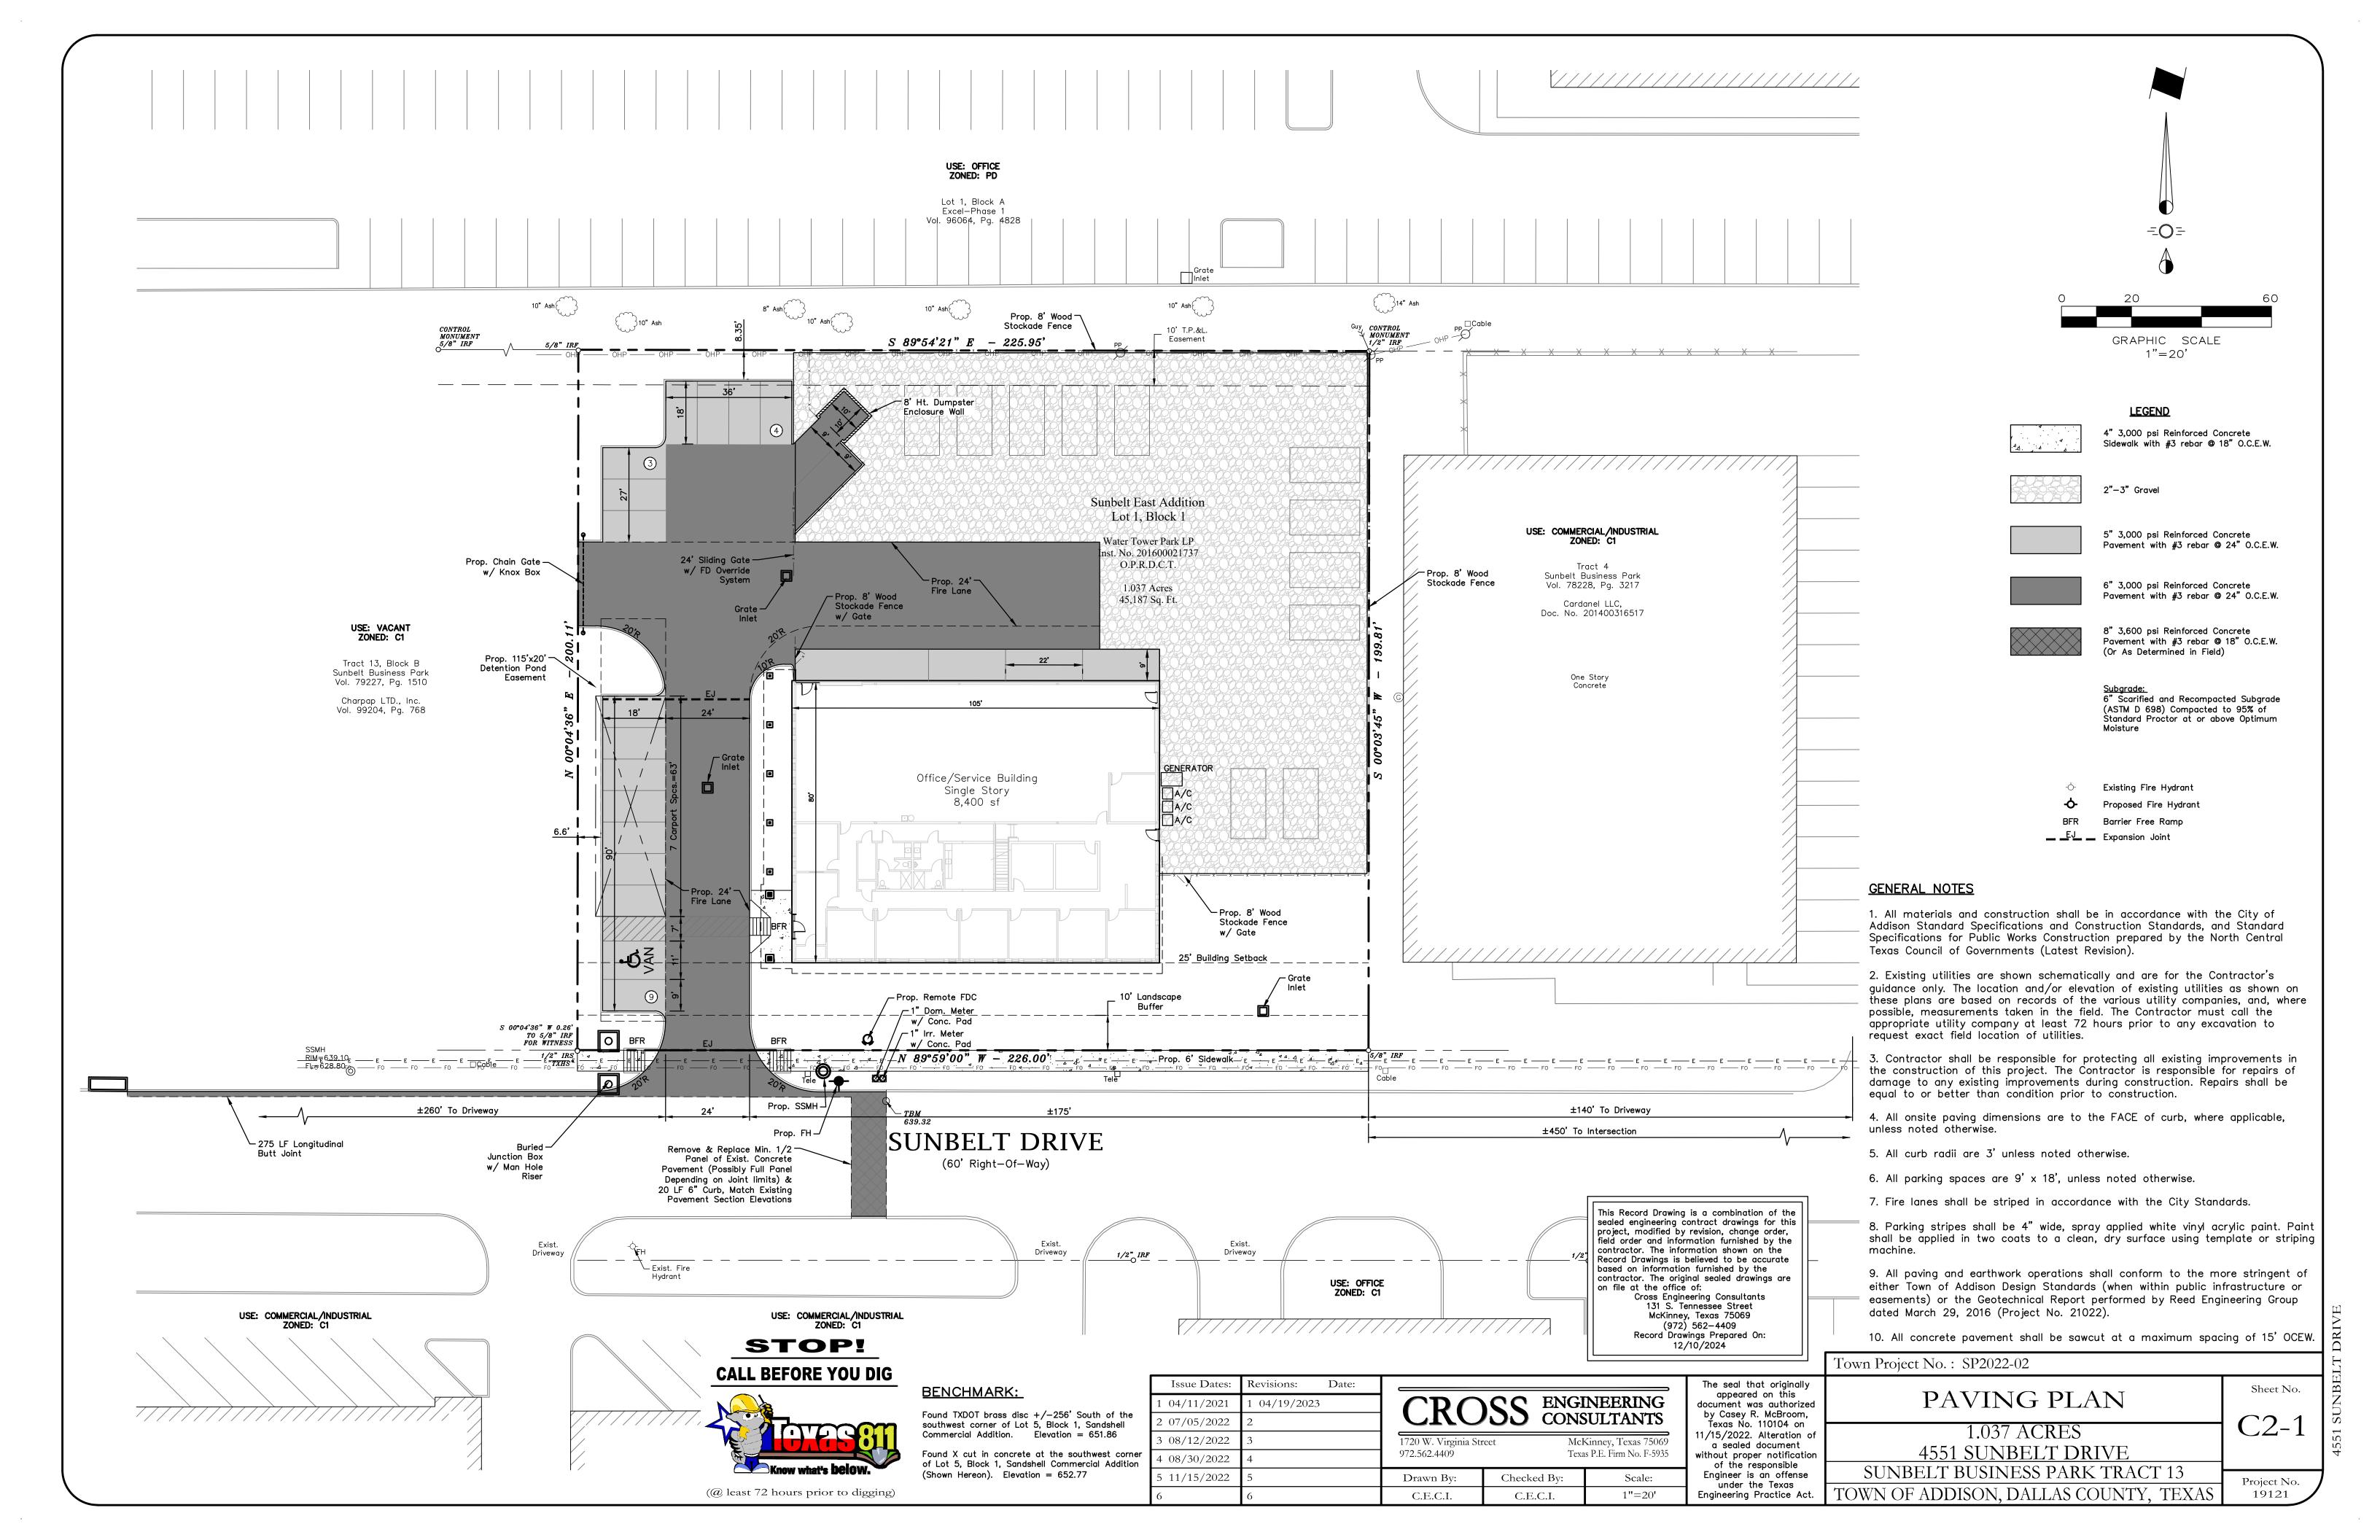

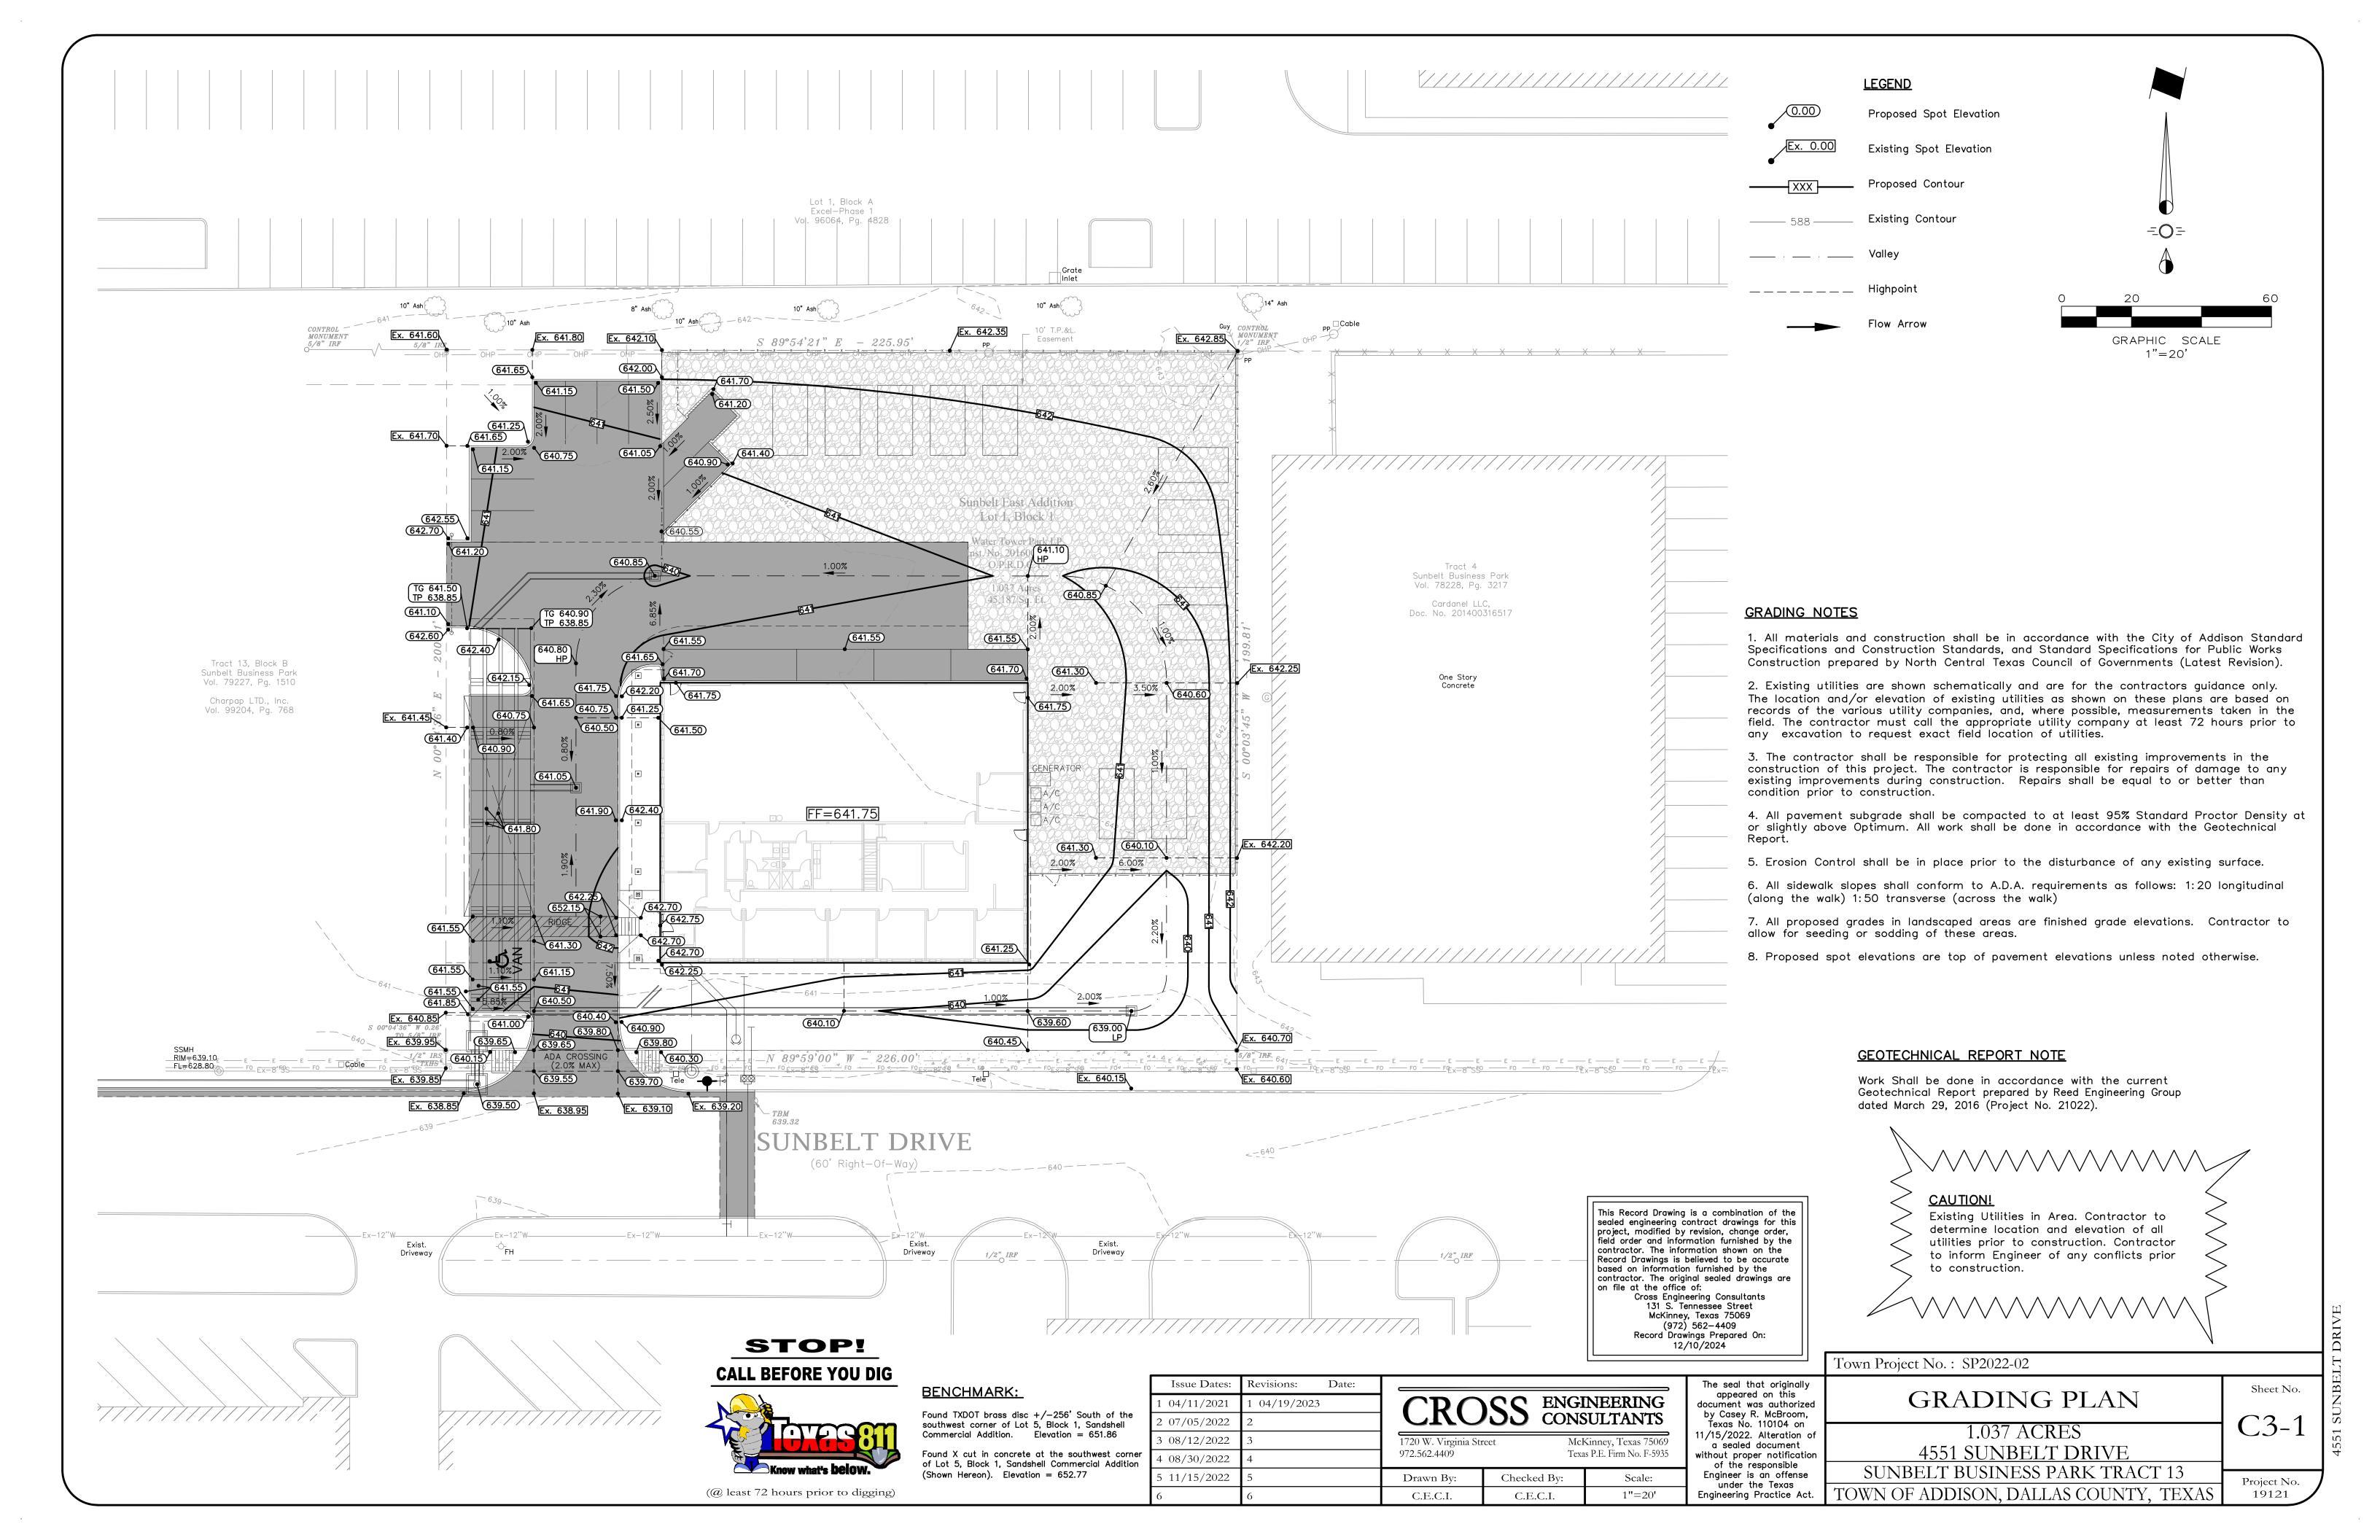

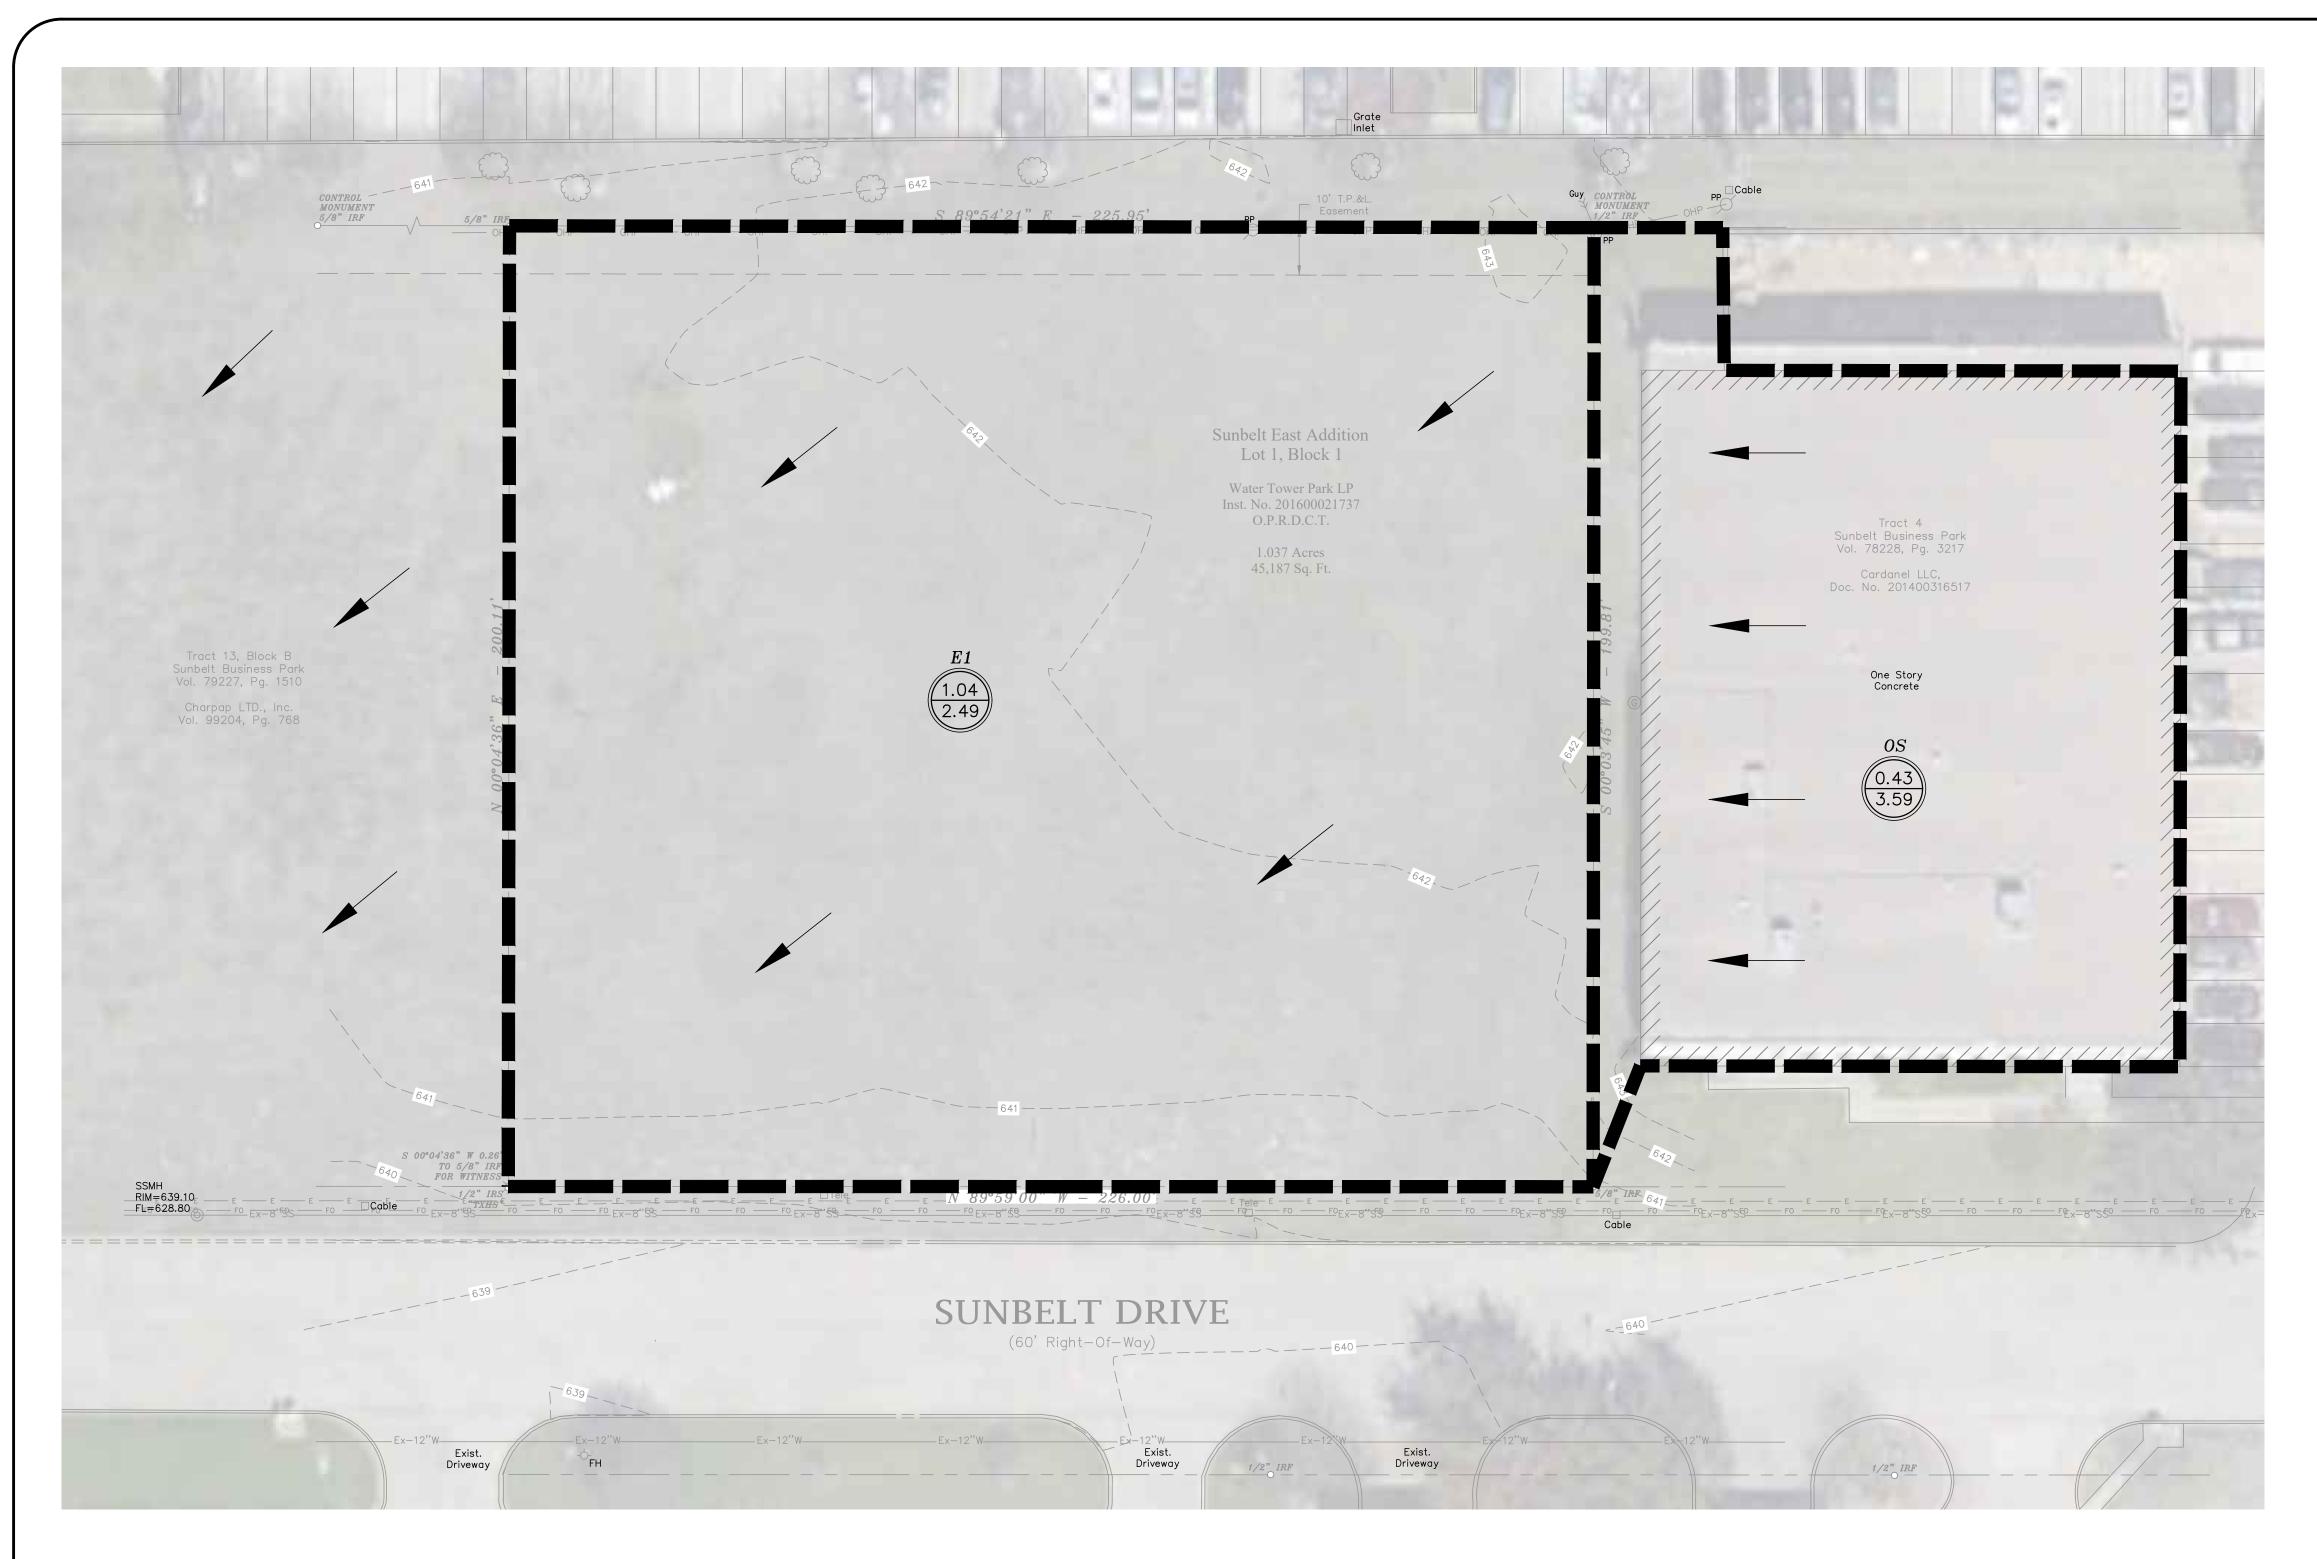

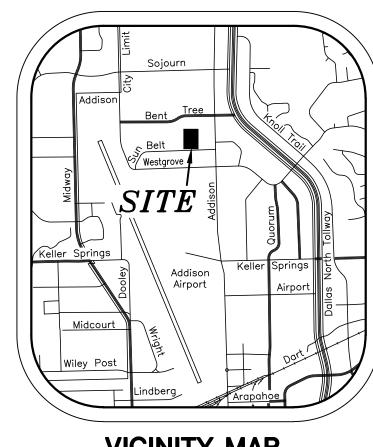

# GRAPHIC SCALE 1"=20' GENERAL/DRAINAGE NOTES

# **VICINITY MAP**

DRAINAGE LEGEND A Drainage Area

X.XX Acres (X.XX)/Q<sub>100</sub>

Proposed Drainage Divide Line → Direction of Flow

- 1. All materials and construction shall be in accordance with the City Standard Specifications and Construction Standards, and Standard Specifications for Public Works Construction prepared by North Central Texas Council of Governments (Latest Revision).
- 2. Existing utilities are shown schematically and are for the contractors guidance only. The location and/or elevation of existing utilities as shown on these plans are based on records of the various utility companies, and, where possible, measurements taken in the field. The contractor must call the appropriate utility company at least 72 hours prior to any excavation to request exact field location of utilities.
- 3. The contractor shall be responsible for protecting all existing improvements in the construction of this project. The contractor is responsible for repairs of damage to any existing improvements during construction. Repairs shall be equal to or better than condition prior to construction.
- 4. All storm sewer pipe 18" and larger shall be Class III RCP. All storm sewer pipe 15" and smaller shall be PVC drainage pipe or approved equal.
- 5. Contractor shall be responsible for maintaining trench safety requirements in accordance with the latest standards of O.S.H.A. or any other agency having jurisdiction for excavation and trenching procedures. Contractor shall provide and implement a trench safety plan complying with O.S.H.A.
- 6. All RCP pipe joints shall have Ram—Neck joint sealer, in the absence of a City Standard for joint sealant.
- 7. All roof drain laterals shall be 0.50% min. slope.

EXISTING DRAINAGE AREA CALCULATIONS											
Drainage	Drainage	Time of	Runoff	100-Yea	ar Event						
Area	Area	Concentration	Coefficient	I <sub>100</sub>	Q <sub>100</sub>	Remarks					
No.	(Acres)	(minutes)	С	(in/hr)	(cfs)						
E1	1.04	15	0.30	7.99	2.49						
os	0.43	10	0.90	9.27	3.59						

WEIGHTED C VALUE (for Determining Required Detention)

Date:

Pavement/Building 17,774 SF Gravel Aréa 18,043 SF Sodded Area 9,369 SF

Issue Dates:

1 04/11/2021

2 07/05/2022

3 08/12/2022

4 08/30/2022

5 11/15/2022

Revisions:

04/19/2023

17,774\*0.95 + 18,043\*0.50 + 9,369\*0.30 = 0.64

CROSS ENGINEERING CONSULTANTS

Checked By:

C.E.C.I.

McKinney, Texas 75069

Texas P.E. Firm No. F-5935

Scale:

1"=20'

1720 W. Virginia Street

972.562.4409

Drawn By:

C.E.C.I.

CAUTION! Existing Utilities in Area. Contractor shall determine location and elevation of all utilities prior to construction. Contractor to inform Engineer of any conflicts prior shall construction.

This Record Drawing is a combination of the sealed engineering contract drawings for this project, modified by revision, change order, field order and information furnished by the contractor. The information shown on the Record Drawings is believed to be accurate based on information furnished by the contractor. The original sealed drawings are on file at the office of:
Cross Engineering Consultants
131 S. Tennessee Street McKinney, Texas 75069 (972) 562-4409 Record Drawings Prepared On: 12/10/2024

This plan conforms with design standards included in the Town of Addison Transportation Plan, Water System Requirements, Waste Water System Requirements, and Drainage Criteria manual.

The seal	that ori
appea	red on t
document	was aut
by Casey	R. McB
Texas N	lo. 11010

ıthorized cBroom, 104 on 11/15/2022. Alteration of a sealed document without proper notification of the responsible Engineer is an offense under the Texas Engineering Practice Act.

Town Project No.: SP2022-02


# EXISTING DRAINAGE AREA MAP 1.037 ACRES


4551 SUNBELT DRIVE SUNBELT BUSINESS PARK TRACT 13


Project No. TOWN OF ADDISON, DALLAS COUNTY, TEXAS 19121

Sheet No.

C4-1

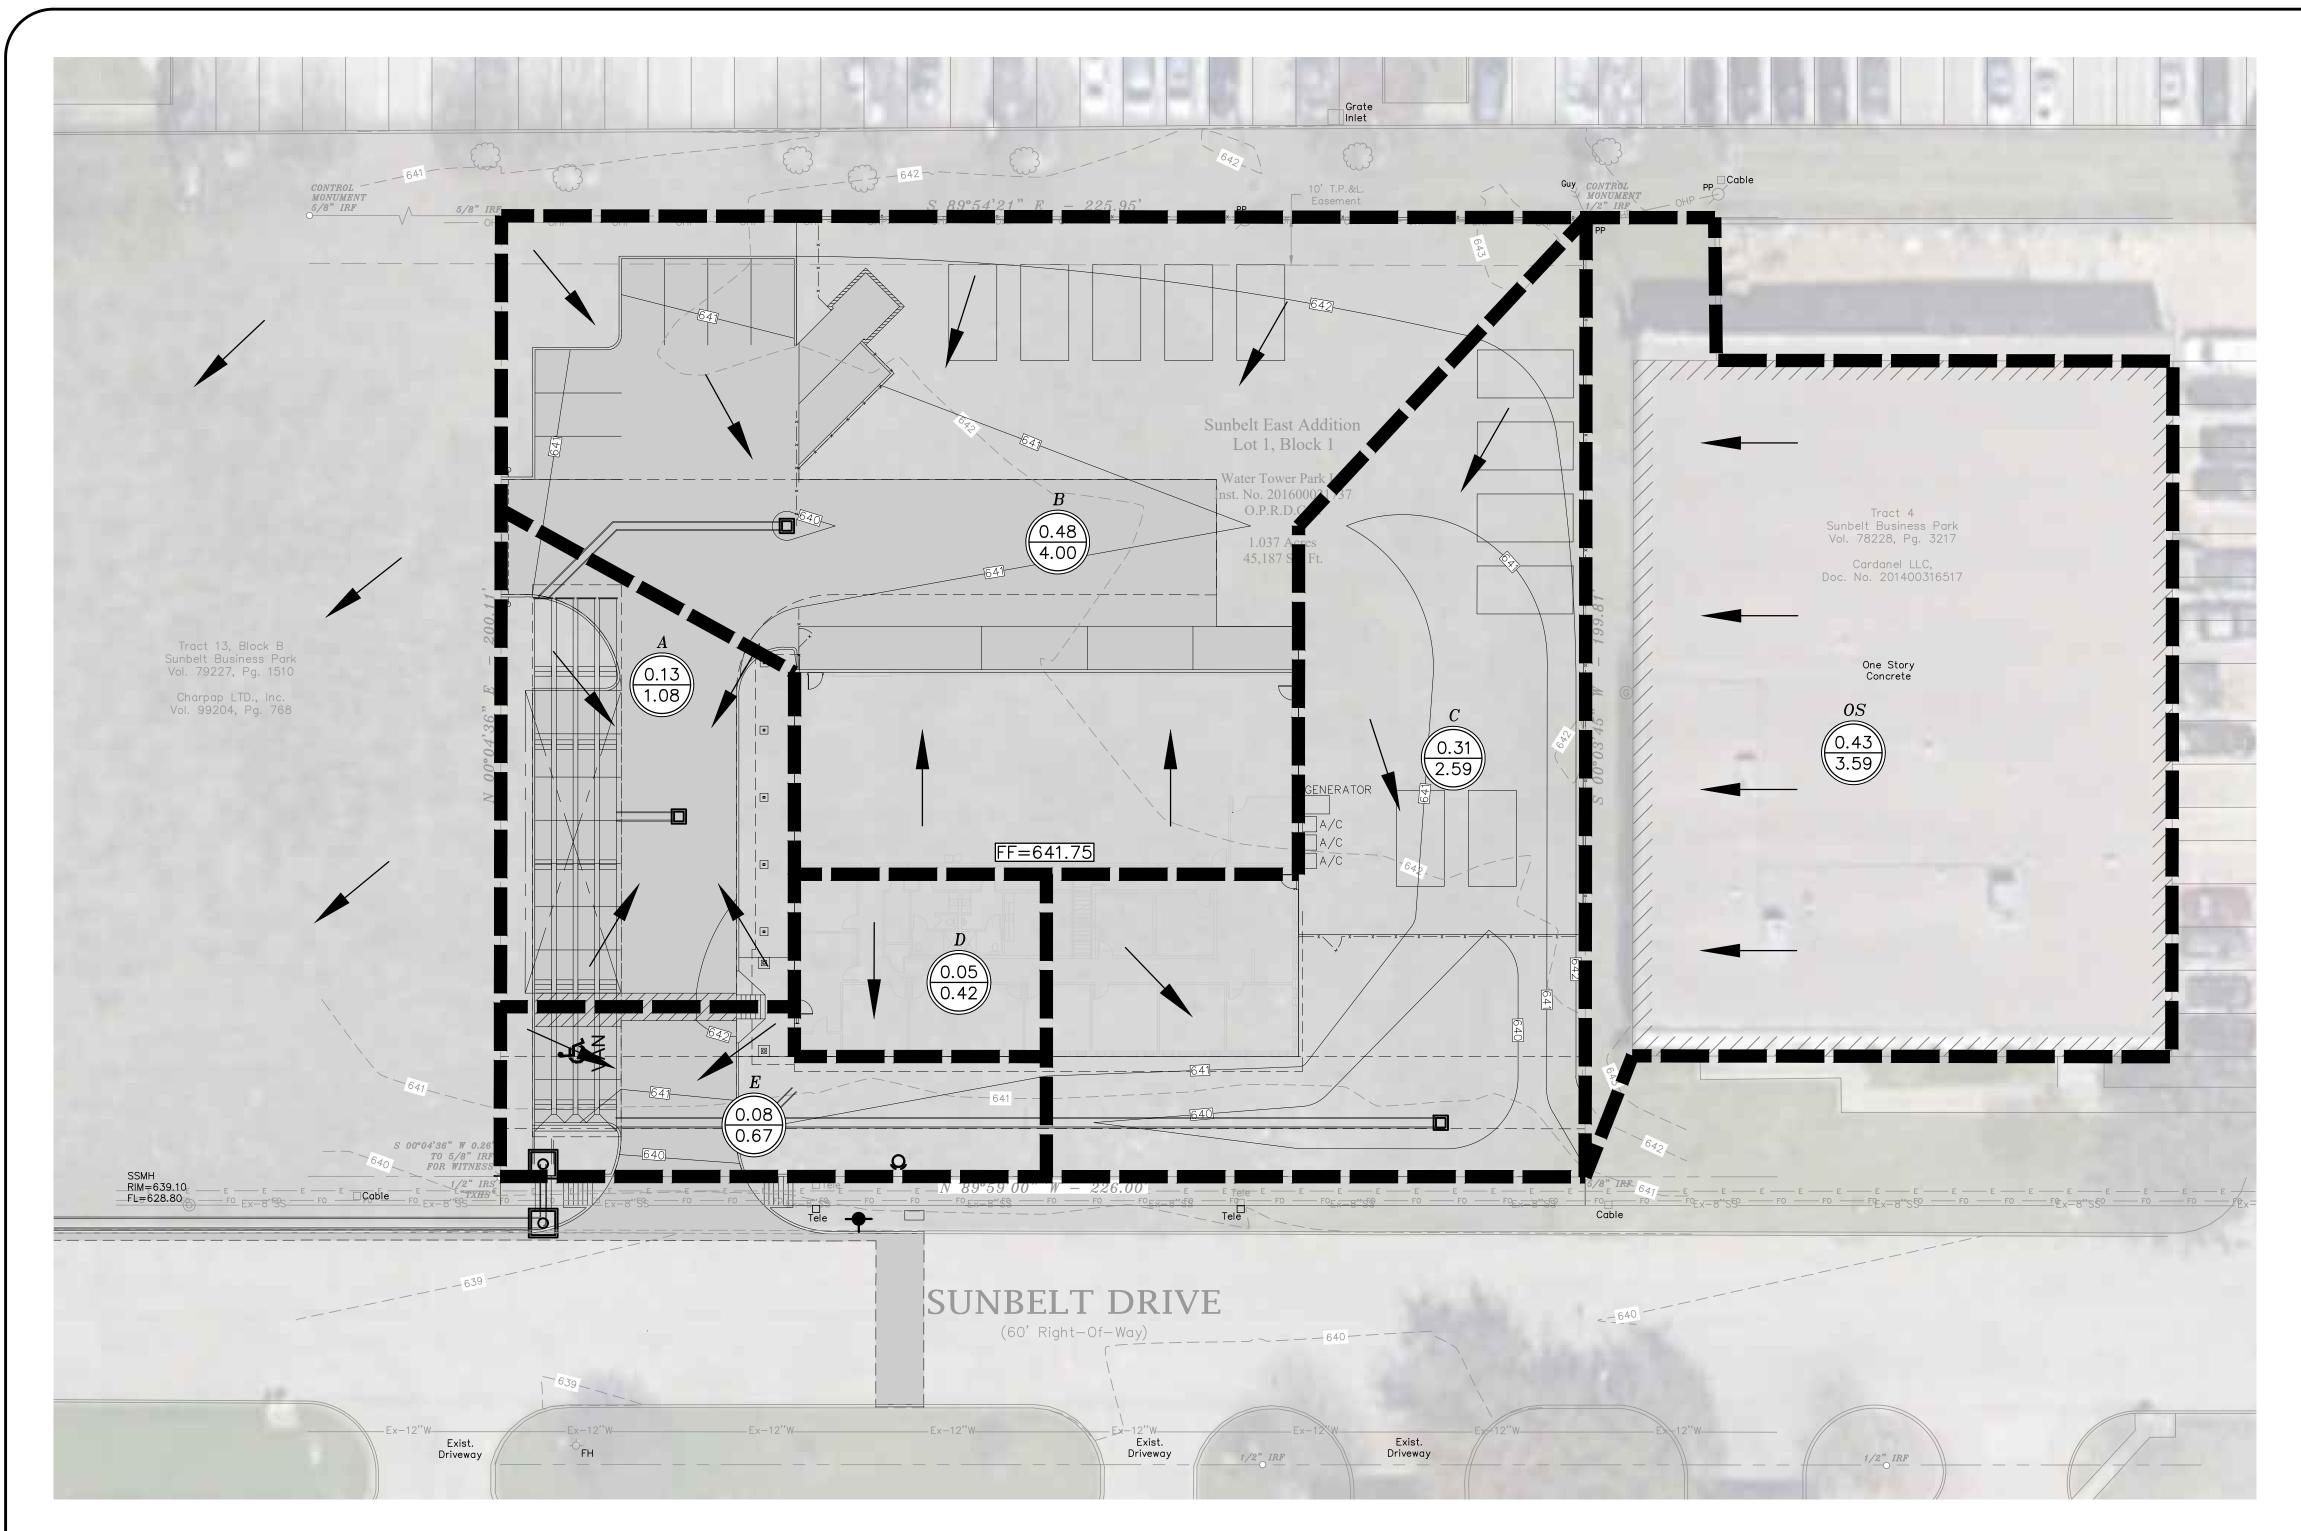

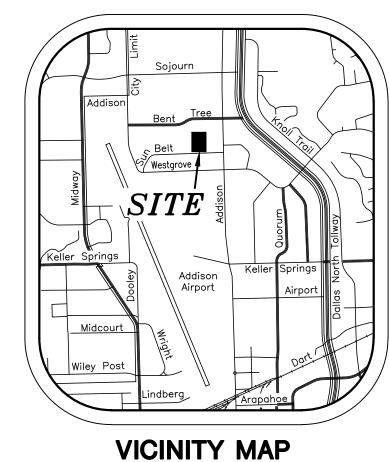

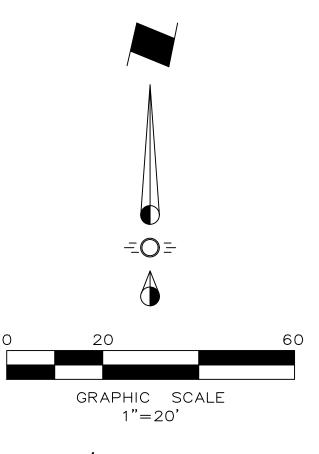

# GENERAL/DRAINAGE NOTES

DRAINAGE LEGEND A Drainage Area X.XX Acres  $(X.XX)Q_{100}$ 

Proposed Drainage Divide Line → Direction of Flow

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- 7. All roof drain laterals shall be 0.50% min. slope.

	FULLY DEVELOPED DRAINAGE AREA CALCULATIONS											
Drainage	Drainage	Time of	Runoff	100-Yea	ar Event							
Area	Area	Concentration	Coefficient	I <sub>100</sub> Q <sub>100</sub>		Remarks						
No.	(Acres)	(minutes)	С	(in/hr)	(cfs)							
Α	0.13	10	0.90	9.27	1.08							
В	0.48	10	0.90	9.27	4.00							
С	0.31	10	0.90	9.27	2.59							
D	0.05	10	0.90	9.27	0.42							
E	0.08	10	0.90	9.27	0.67	Onsite Bypass - See Detention Calcs						
OS	0.43	10	0.90	9.27	3.59	Offsite Bypass - See Detention Calcs						

WEIGHTED C VALUE (for Determining Required Detention)

Pavement/Building 17,774 SF Gravel Aréa 18,043 SF Sodded Area 9,369 SF

Issue Dates:

1 04/11/2021

2 07/05/2022

3 08/12/2022

4 08/30/2022

5 11/15/2022

Revisions:

04/19/2023

17,774\*0.95 + 18,043\*0.50 + 9,369\*0.30 = 0.6445,186

C.E.C.I.

CAUTION! Existing Utilities in Area. Contractor shall determine location and elevation of all utilities prior to construction. Contractor to inform Engineer of any conflicts prior shall

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Cross Engineering Consultants
131 S. Tennessee Street McKinney, Texas 75069 (972) 562-4409 Record Drawings Prepared On: 12/10/2024

This plan conforms with design standards included in the Town of Addison Transportation Plan, Water System Requirements, Waste Water System Requirements, and Drainage Criteria manual.

:			The
	<b>CROSS</b>	ENGINEERING CONSULTANTS	docu by Te
	1720 W. Virginia Street	McKinney, Texas 75069	11/1

C.E.C.I.

972.562.4409 Texas P.E. Firm No. F-5935 Checked By: Drawn By:

Scale:

1"=20'

he seal that originally appeared on this cument was authorized y Casey R. McBroom, Texas No. 110104 on 15/2022. Alteration of a sealed document without proper notification of the responsible Engineer is an offense under the Texas Engineering Practice Act.

construction.

Town Project No.: SP2022-02


# DRAINAGE AREA MAP


1.037 ACRES 4551 SUNBELT DRIVE SUNBELT BUSINESS PARK TRACT 13 TOWN OF ADDISON, DALLAS COUNTY, TEXAS


Project No. 19121

Sheet No.

C4-2

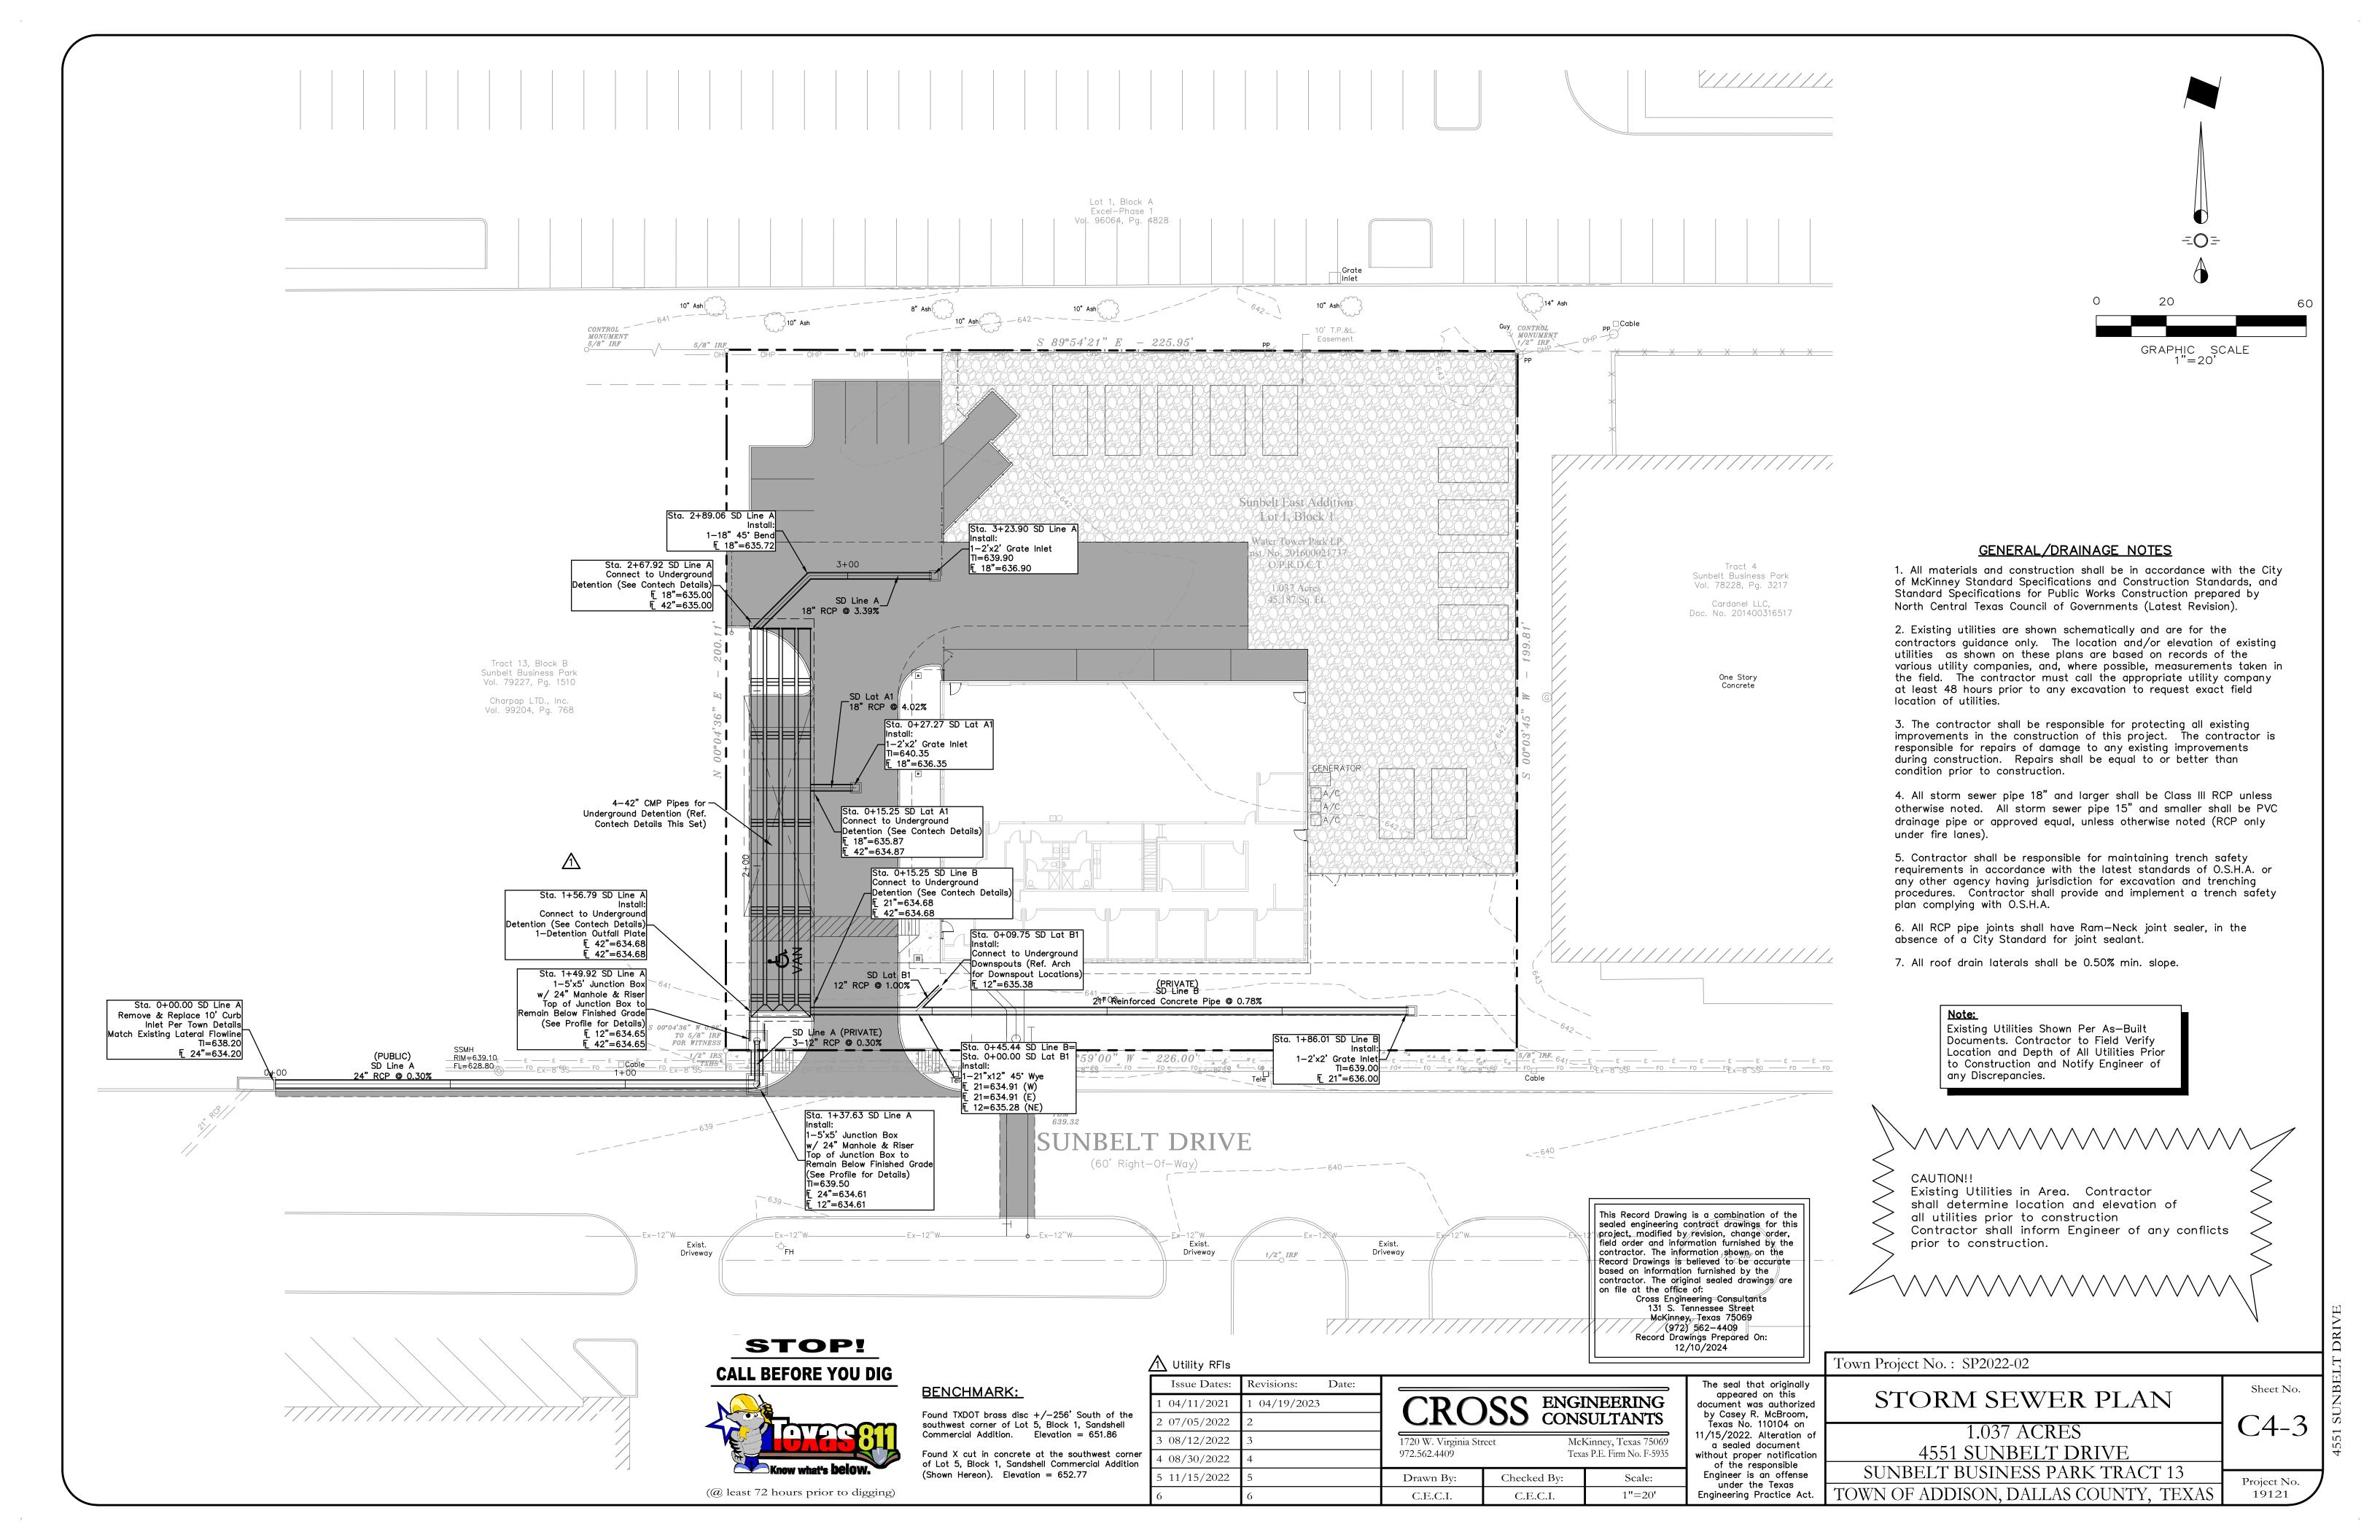

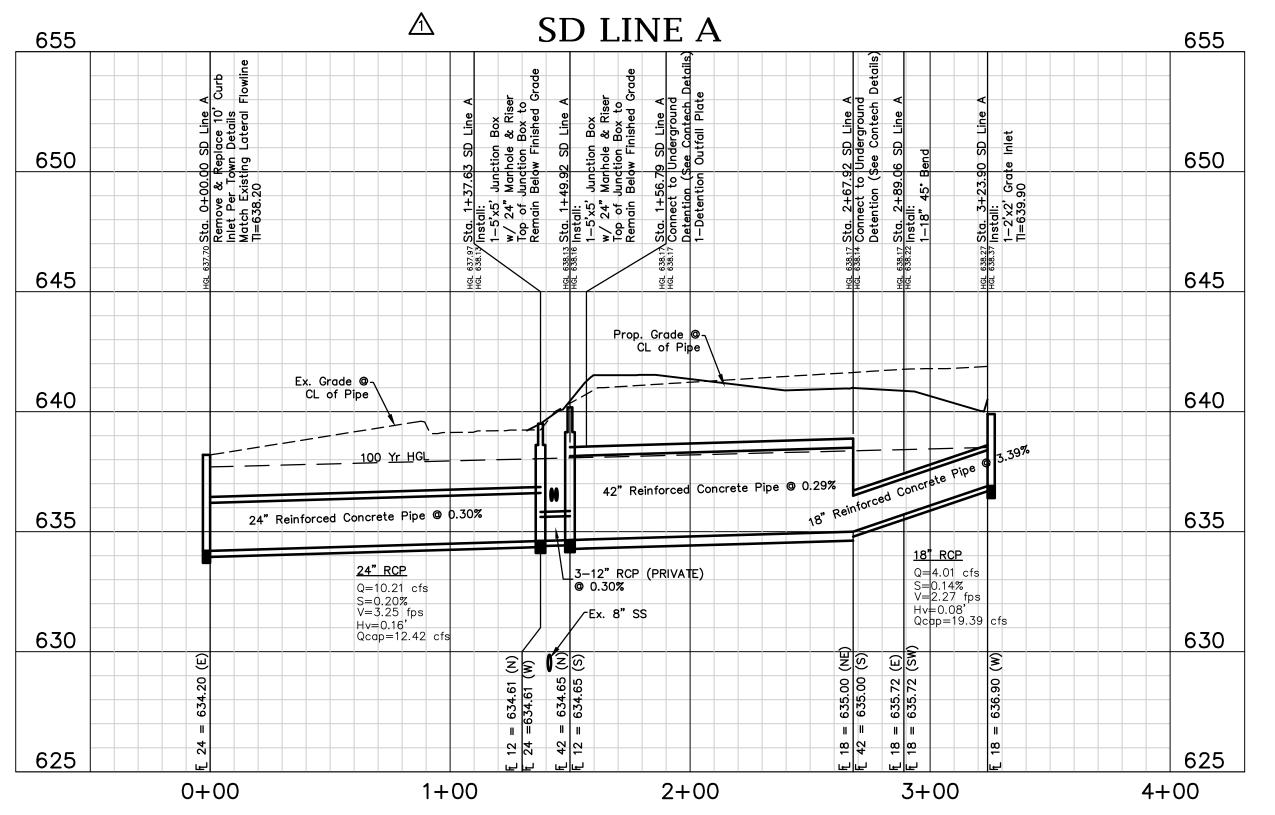

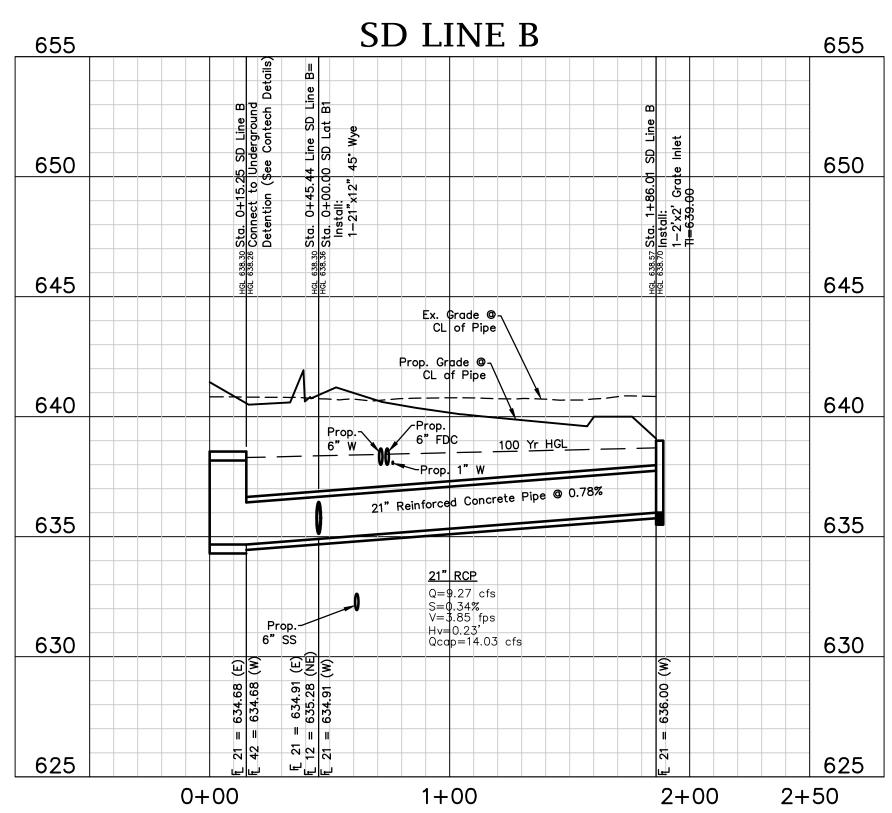

									STO	DMSEW	/ED CAL	CULATIO	MC										
POINT (	COLLECTION INLET OR IHOLE)	Distance Between	INCREM	ENTAL DRA	AINAGE AF	REA	Accumul-	Time at Upstream	Design Storm	Intensity	Storm Water Runoff	Slope of Hydraulic Gradient	Storm Sewer	Box/Pipe	Velocity in Sewer Between	Velocity Head	Structure	Head Loss	Inlet, Manhole, Bends or	Flow Time	Time at Downstream	HGL	Elevation
Upstream Station	Downstream Station	Collection Points	Area No.	Drainage Area "A" (Acres)	Runoff Coeff. "C"	Incremental "CA"	ated "CA"	Station (minutes)	Frequency (years)	(in/hr)	"Q" (cfs)	"S" (ft/ft)	Size (inches)	Area	Connectio n Points "V" (fps)	Loss at Upstream Station	Туре	Coeff. Kj	Junction Box Losses	(minutes)	Station (minutes)	Upstream	Downstream Elevation (ft
1	2	3	4	5	6	8	9	10	11	12	13	14	18	19	20	21	22	23	24	25	26	27	28
STORML	INE "A"		_											•			_	•					
																							638.37
323.90	289.06	34.84	В	0.48	0.90	0.43	0.43	10.00	100	9.27	4.01	0.0014	18	1.77	2.27	0.08	Grate Inlet	1.25	0.10	0.26	10.26	638.27	638.22
289.06	267.92	21.14		0.00	0.90	0.00	0.43	10.26	100	9.19	3.97	0.0014	18	1.77	2.25	0.08	Bend	0.35	0.05	0.16	10.41	638.17	638.14
267.92	222.34	45.58		0.00	0.90	0.00	0.43	10.41	100	9.15	3.95	0.0000	42	9.62	0.41	0.00	Bend	0.35	-0.02	1.85	12.26	638.17	638.17
222.34	156.79	65.55	Α	0.13	0.90	0.12	0.55	12.26	100	8.64	4.74	0.0000	42	9.62	0.49	0.00	Junction	0.25	0.00	2.22	14.48	638.17	638.16
156.79	137.63	19.16	C, D, OS	0.79	0.90	0.71	1.26	14.48	100	8.10	10.21	0.0002	36	7.07	1.44	0.03	Junction	0.25	0.03	0.22	14.70	638.13	638.13
137.63	0.00	137.63		0.00	0.90	0.00	1.26	14.70	100	8.05	10.15	0.0020	24	3.14	3.23	0.16	Junction	0.25	0.15	0.71	15.41	637.97	637.70
			Total:	1.40																			
STORML	INE "B"																						
																							638.56
186.01	45.44	140.57	C,OS	0.74	0.90	0.67	0.67	10.00	100	9.27	6.18	0.0015	21	2.41	2.57	0.10	Catch Basin	1.25	0.13	0.91	10.91	638.43	638.22
45.44	15.25	30.19	D	0.05	0.90	0.05	0.71	10.91	100	9.00	6.40	0.0016	21	2.41	2.66	0.11	Wye	0.50	0.06	0.19	11.10	638.16	638.12
15.25	0.00	15.25		0.00	0.90	0.00	0.71	11.10	100	8.95	6.36	0.0000	42	9.62	0.66	0.01	Size Change	0.50	-0.05	0.38	11.49	638.16	638.16
			Total:	0.79																			

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131 S. Tennessee Street
McKinney, Texas 75069 (972) 562-4409 Record Drawings Prepared On:

12/10/2024

STOP! **CALL BEFORE YOU DIG** 

**BENCHMARK:** 

Found TXDOT brass disc +/-256' South of the southwest corner of Lot 5, Block 1, Sandshell Commercial Addition. Elevation = 651.86 Found X cut in concrete at the southwest corner

(Shown Hereon). Elevation = 652.77

1 04/19/2023 04/11/2021 2 07/05/2022 8 08/12/2022 1 08/30/2022 of Lot 5, Block 1, Sandshell Commercial Addition 5 11/15/2022

Issue Dates: Revisions:

1 Utility RFIs

Date: CROSS ENGINEERING CONSULTANTS

McKinney, Texas 75069 Texas P.E. Firm No. F-5935

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Town Project No.: SP2022-02

STORM SEWER PROFILES

TOWN OF ADDISON, DALLAS COUNTY, TEXAS


C4-4 1.037 ACRES 4551 SUNBELT DRIVE SUNBELT BUSINESS PARK TRACT 13

Project No. 19121

Sheet No.

(@ least 72 hours prior to digging)

1720 W. Virginia Street 972.562.4409 Checked By: Drawn By: Scale: C.E.C.I. C.E.C.I. H: 1"=40', V: 1" Engineering Practice Act.

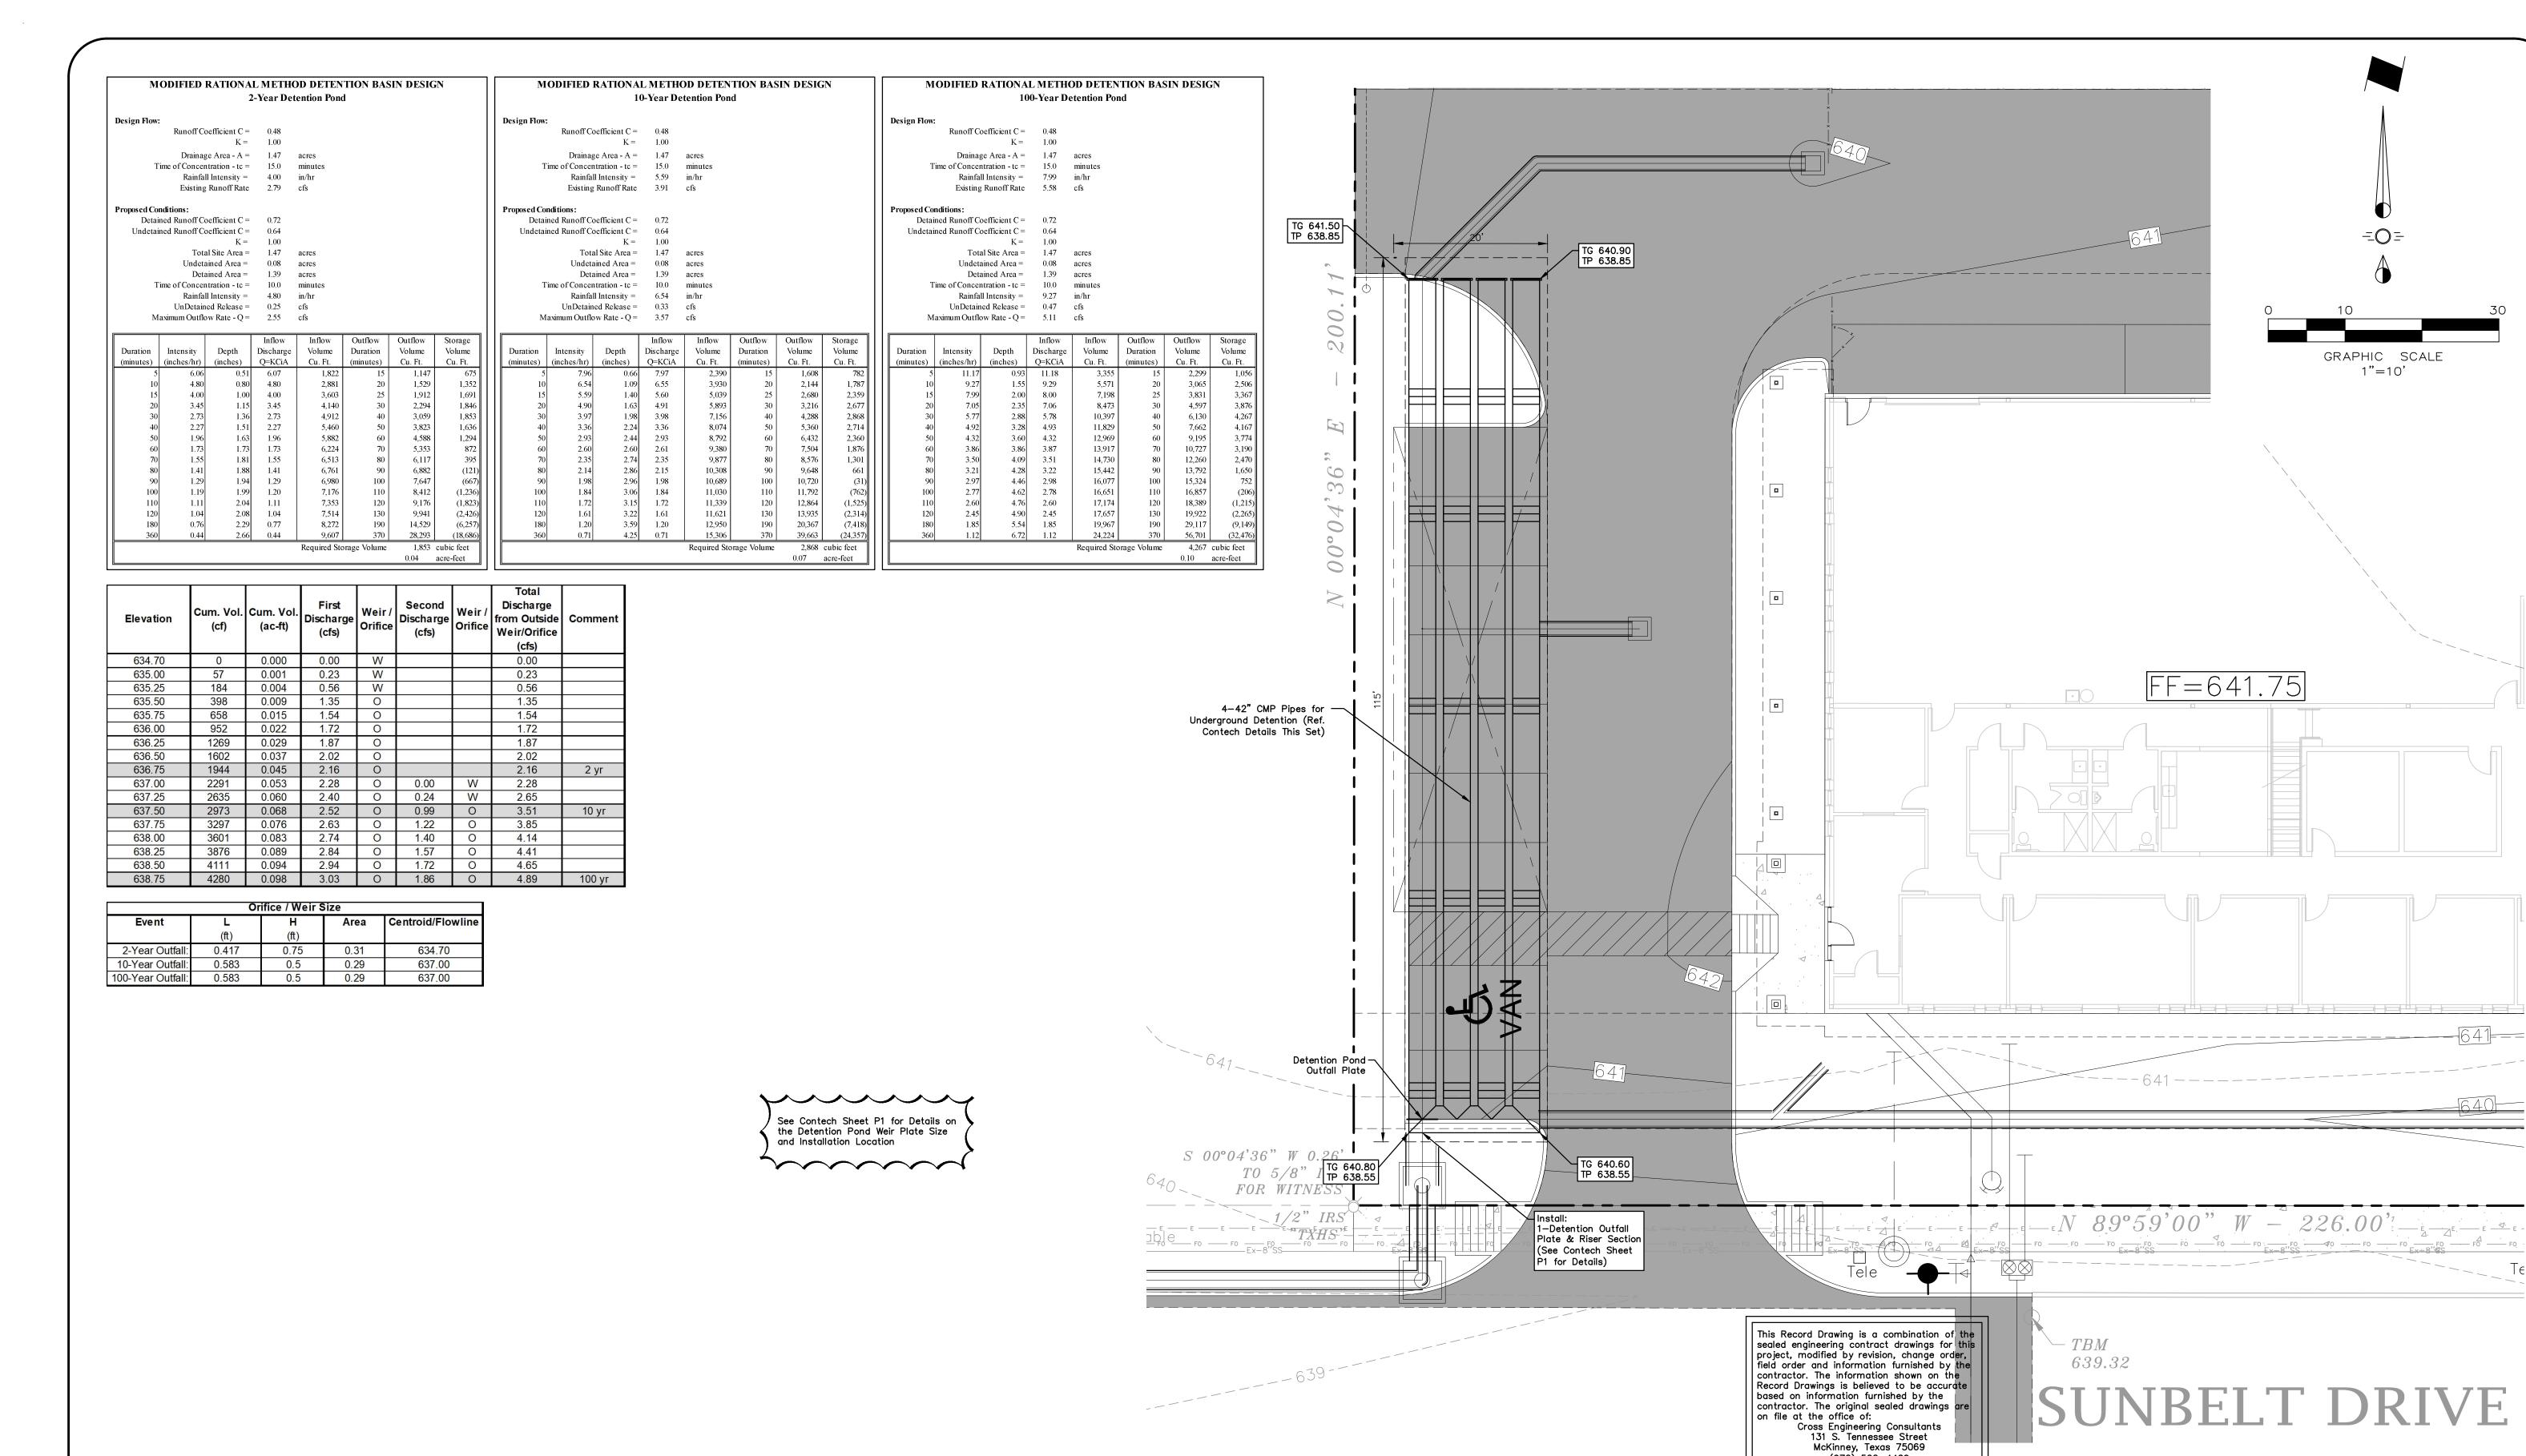

STOP! **CALL BEFORE YOU DIG** 



**BENCHMARK:** 

Found TXDOT brass disc +/-256' South of the southwest corner of Lot 5, Block 1, Sandshell Commercial Addition. Elevation = 651.86

Found 3	X cut	in c	oncrete	at	the	southwe	st c	orner
of Lot	5, BI	ock 1	, Sands	hell	Con	nmercial	Add	ition
(Shown	Here	on).	Elevati	on =	= 65	52.77		

Issue Dates:	Revisions: Date:		
1 04/11/2021	1 04/19/2023	CDOCC	ENGINEERING
2 07/05/2022	2	CICOSS	CONSULTANTS
3 08/12/2022	3	1720 W. Virginia Street	McKinney, Texas 75069
4 08/30/2022	4	972.562.4409	Texas P.E. Firm No. F-5935
•			

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(972) 562-4409 Record Drawings Prepared On: 12/10/2024

1"=10"

DETENTION PLAN

Sheet No. 1.037 ACRES 4551 SUNBELT DRIVE SUNBELT BUSINESS PARK TRACT 13

C4-5

Project No. 19121


(@ least 72 hours prior to digging)

5 11/15/2022 Drawn By: Checked By: C.E.C.I. C.E.C.I.


under the Texas Engineering Practice Act.

Town Project No.: SP2022-02

TOWN OF ADDISON, DALLAS COUNTY, TEXAS

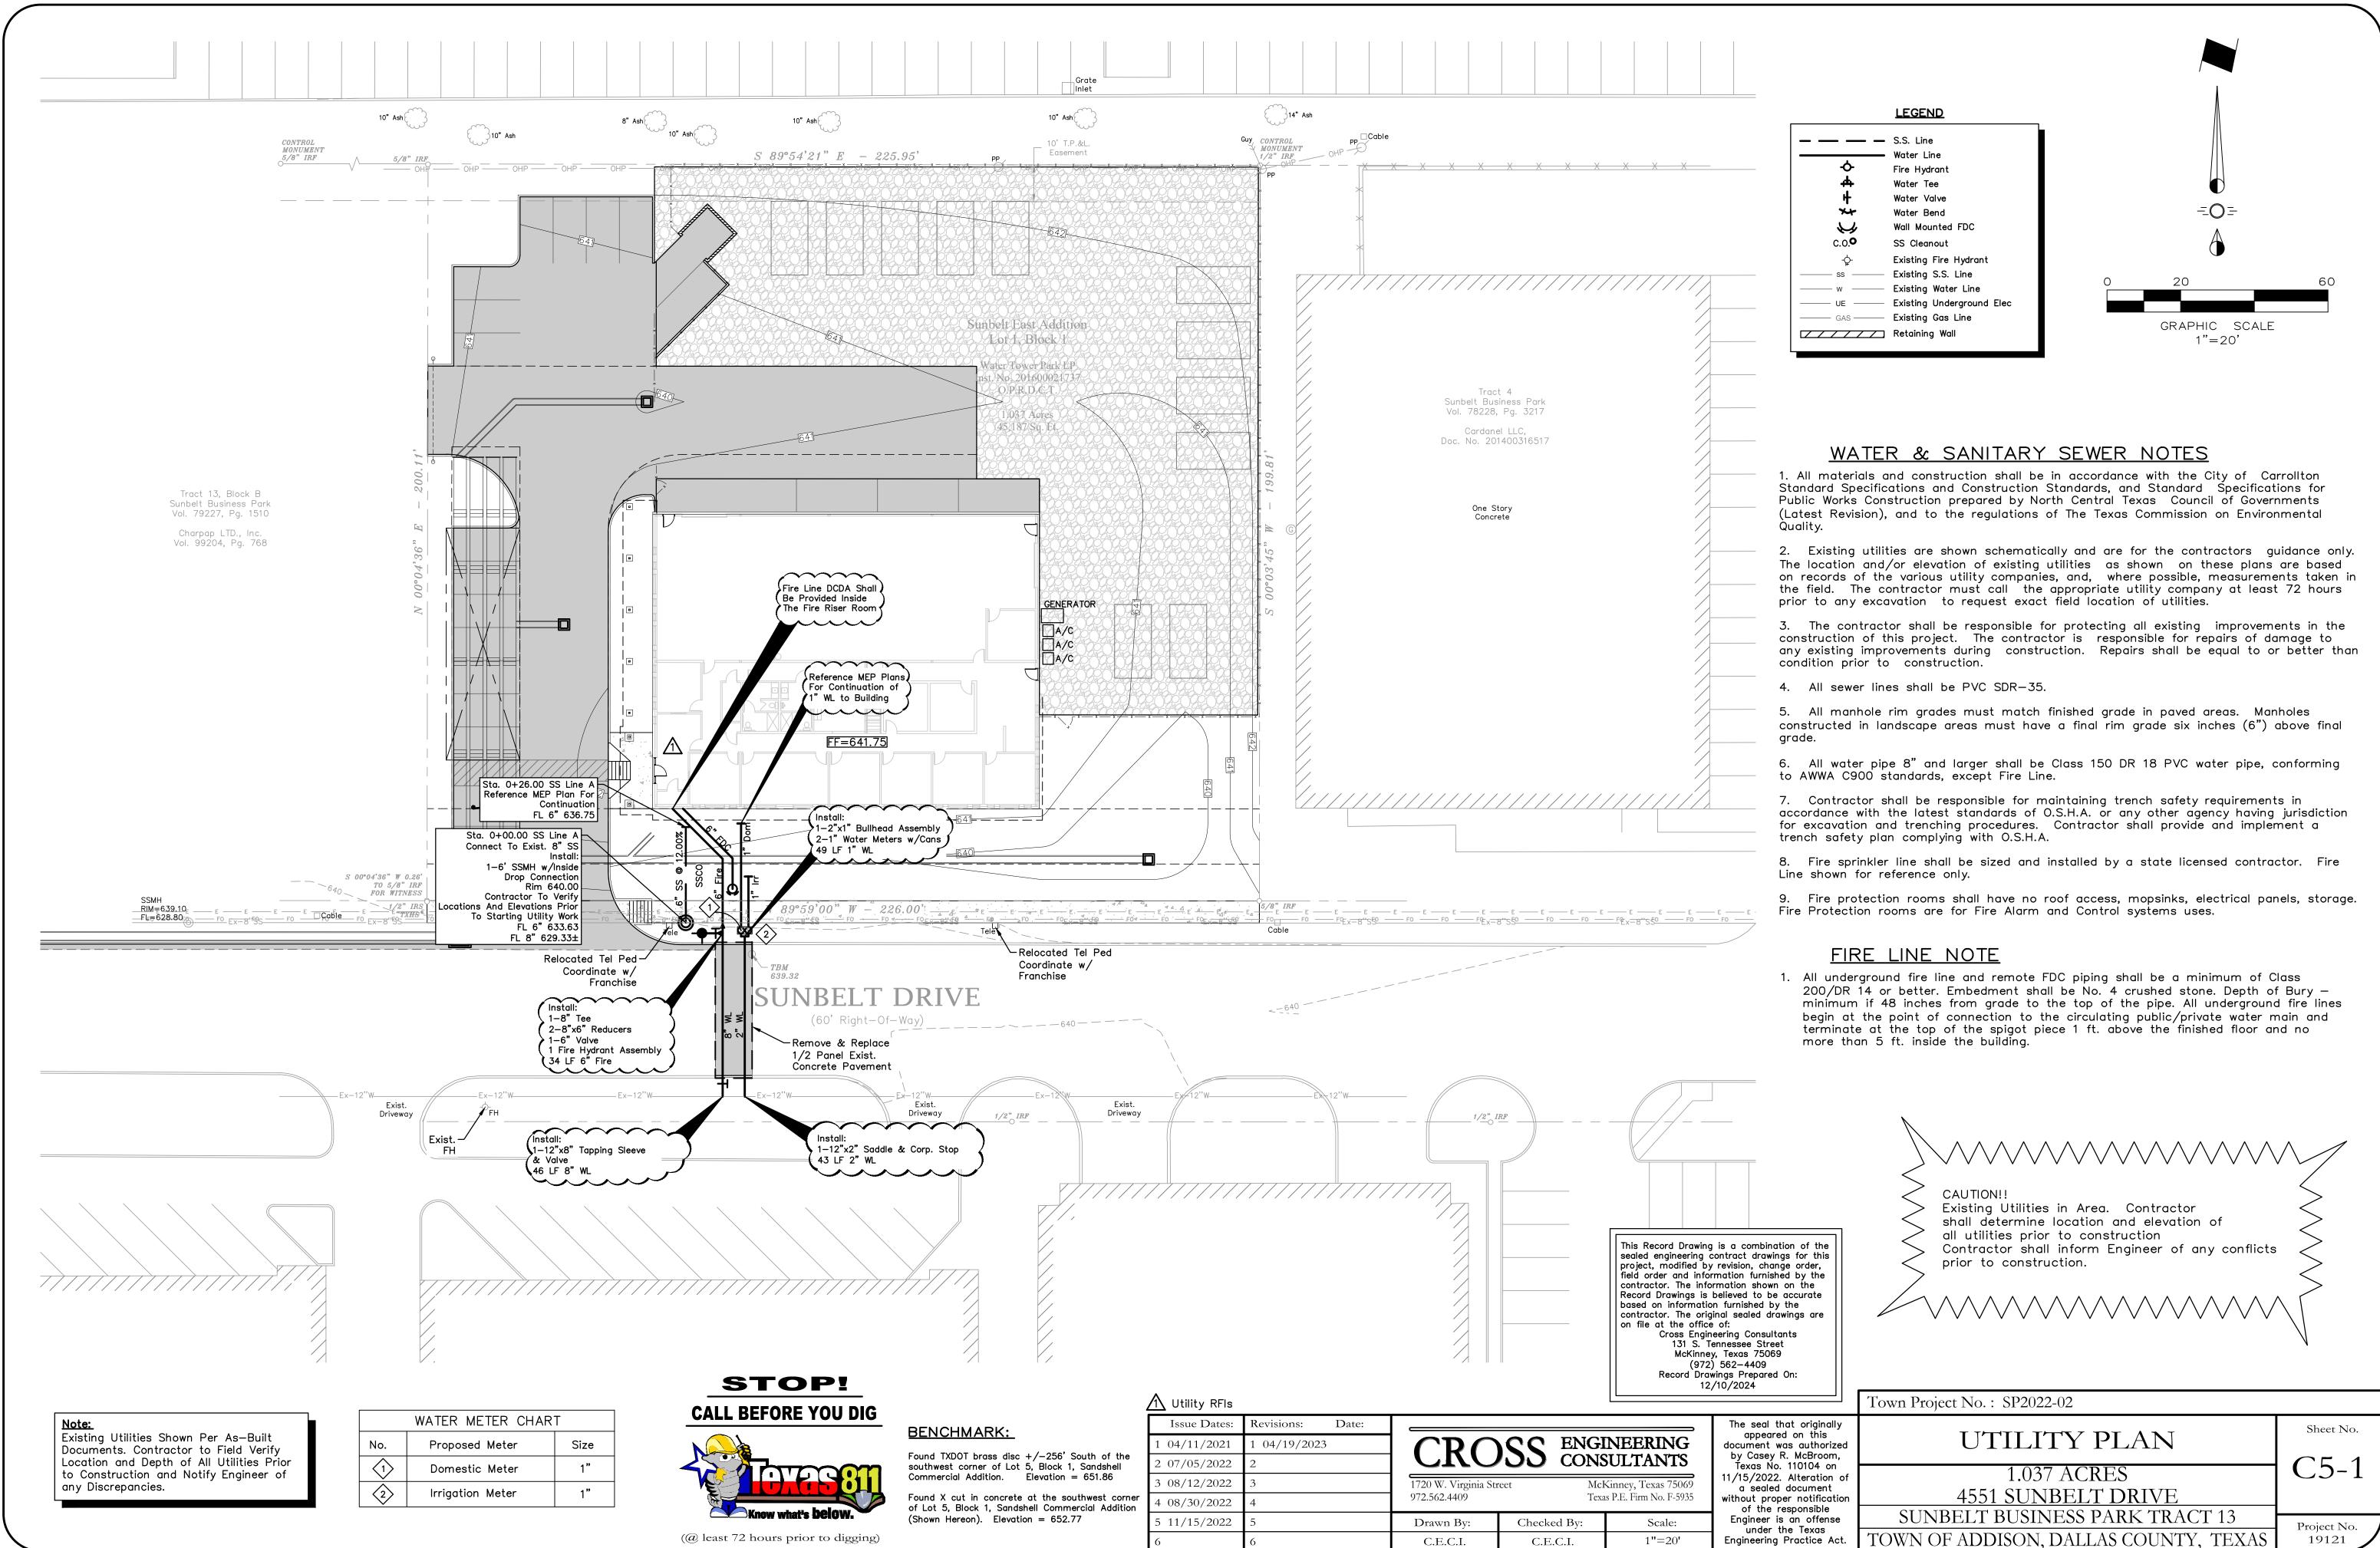

4551 SUNBELT DRIVE

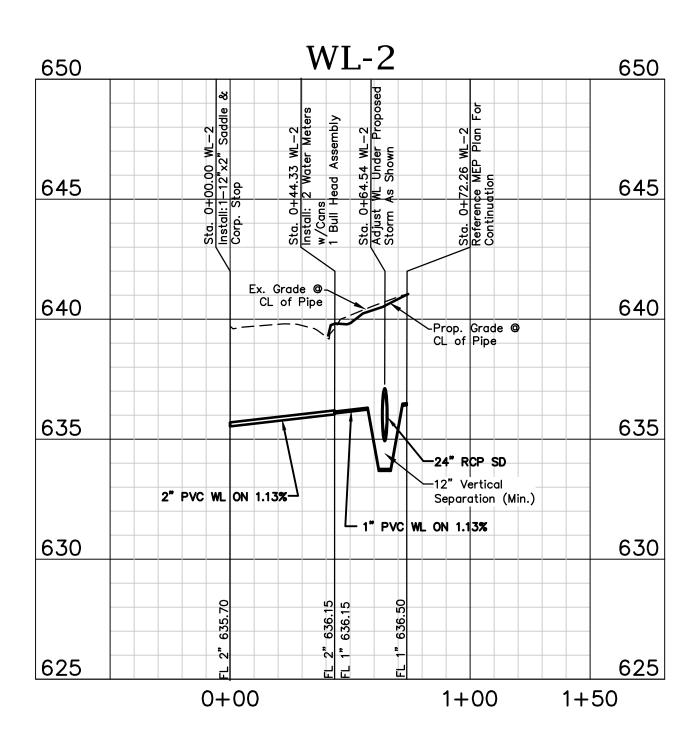

1 Utility RFIs

This Record Drawing is a combination of the sealed engineering contract drawings for this project, modified by revision, change order, field order and information furnished by the contractor. The information shown on the Record Drawings is believed to be accurate based on information furnished by the contractor. The original sealed drawings are on file at the office of:

Cross Engineering Consultants

131 S. Tennessee Street

McKinney, Texas 75069

(972) 562—4409

Record Drawings Prepared On:

12/10/2024

V:1"=4' H:1"=40'

STOP! **CALL BEFORE YOU DIG** 



(@ least 72 hours prior to digging)

**BENCHMARK:** 

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(Shown Hereon). Elevation = 652.77

Issue Dates:	Revisions: Date:						
1 04/11/2021	1 04/19/2023			NEERING			
2 07/05/2022	2		CONS	SULTANTS			
3 08/12/2022	3	1720 W. Virginia Str		McKinney, Texas 75069			
4 08/30/2022	4	972.562.4409	Texa	Texas P.E. Firm No. F-5935			
5 11/15/2022	5	Drawn By:	Checked By:	Scale:			

C.E.C.I.

C.E.C.I.

 $\Lambda$ 

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Engineering Practice Act.

Town Project No.: SP2022-02

WATER PROFILES 1.037 ACRES 4551 SUNBELT DRIVE

C5-2


19121

SUNBELT BUSINESS PARK TRACT 13 TOWN OF ADDISON, DALLAS COUNTY, TEXAS


Note:

Existing Utilities Shown Per As—Built
Documents. Contractor to Field Verify
Location and Depth of All Utilities Prior
to Construction and Notify Engineer of
any Discrepancies.

Sheet No. Project No.

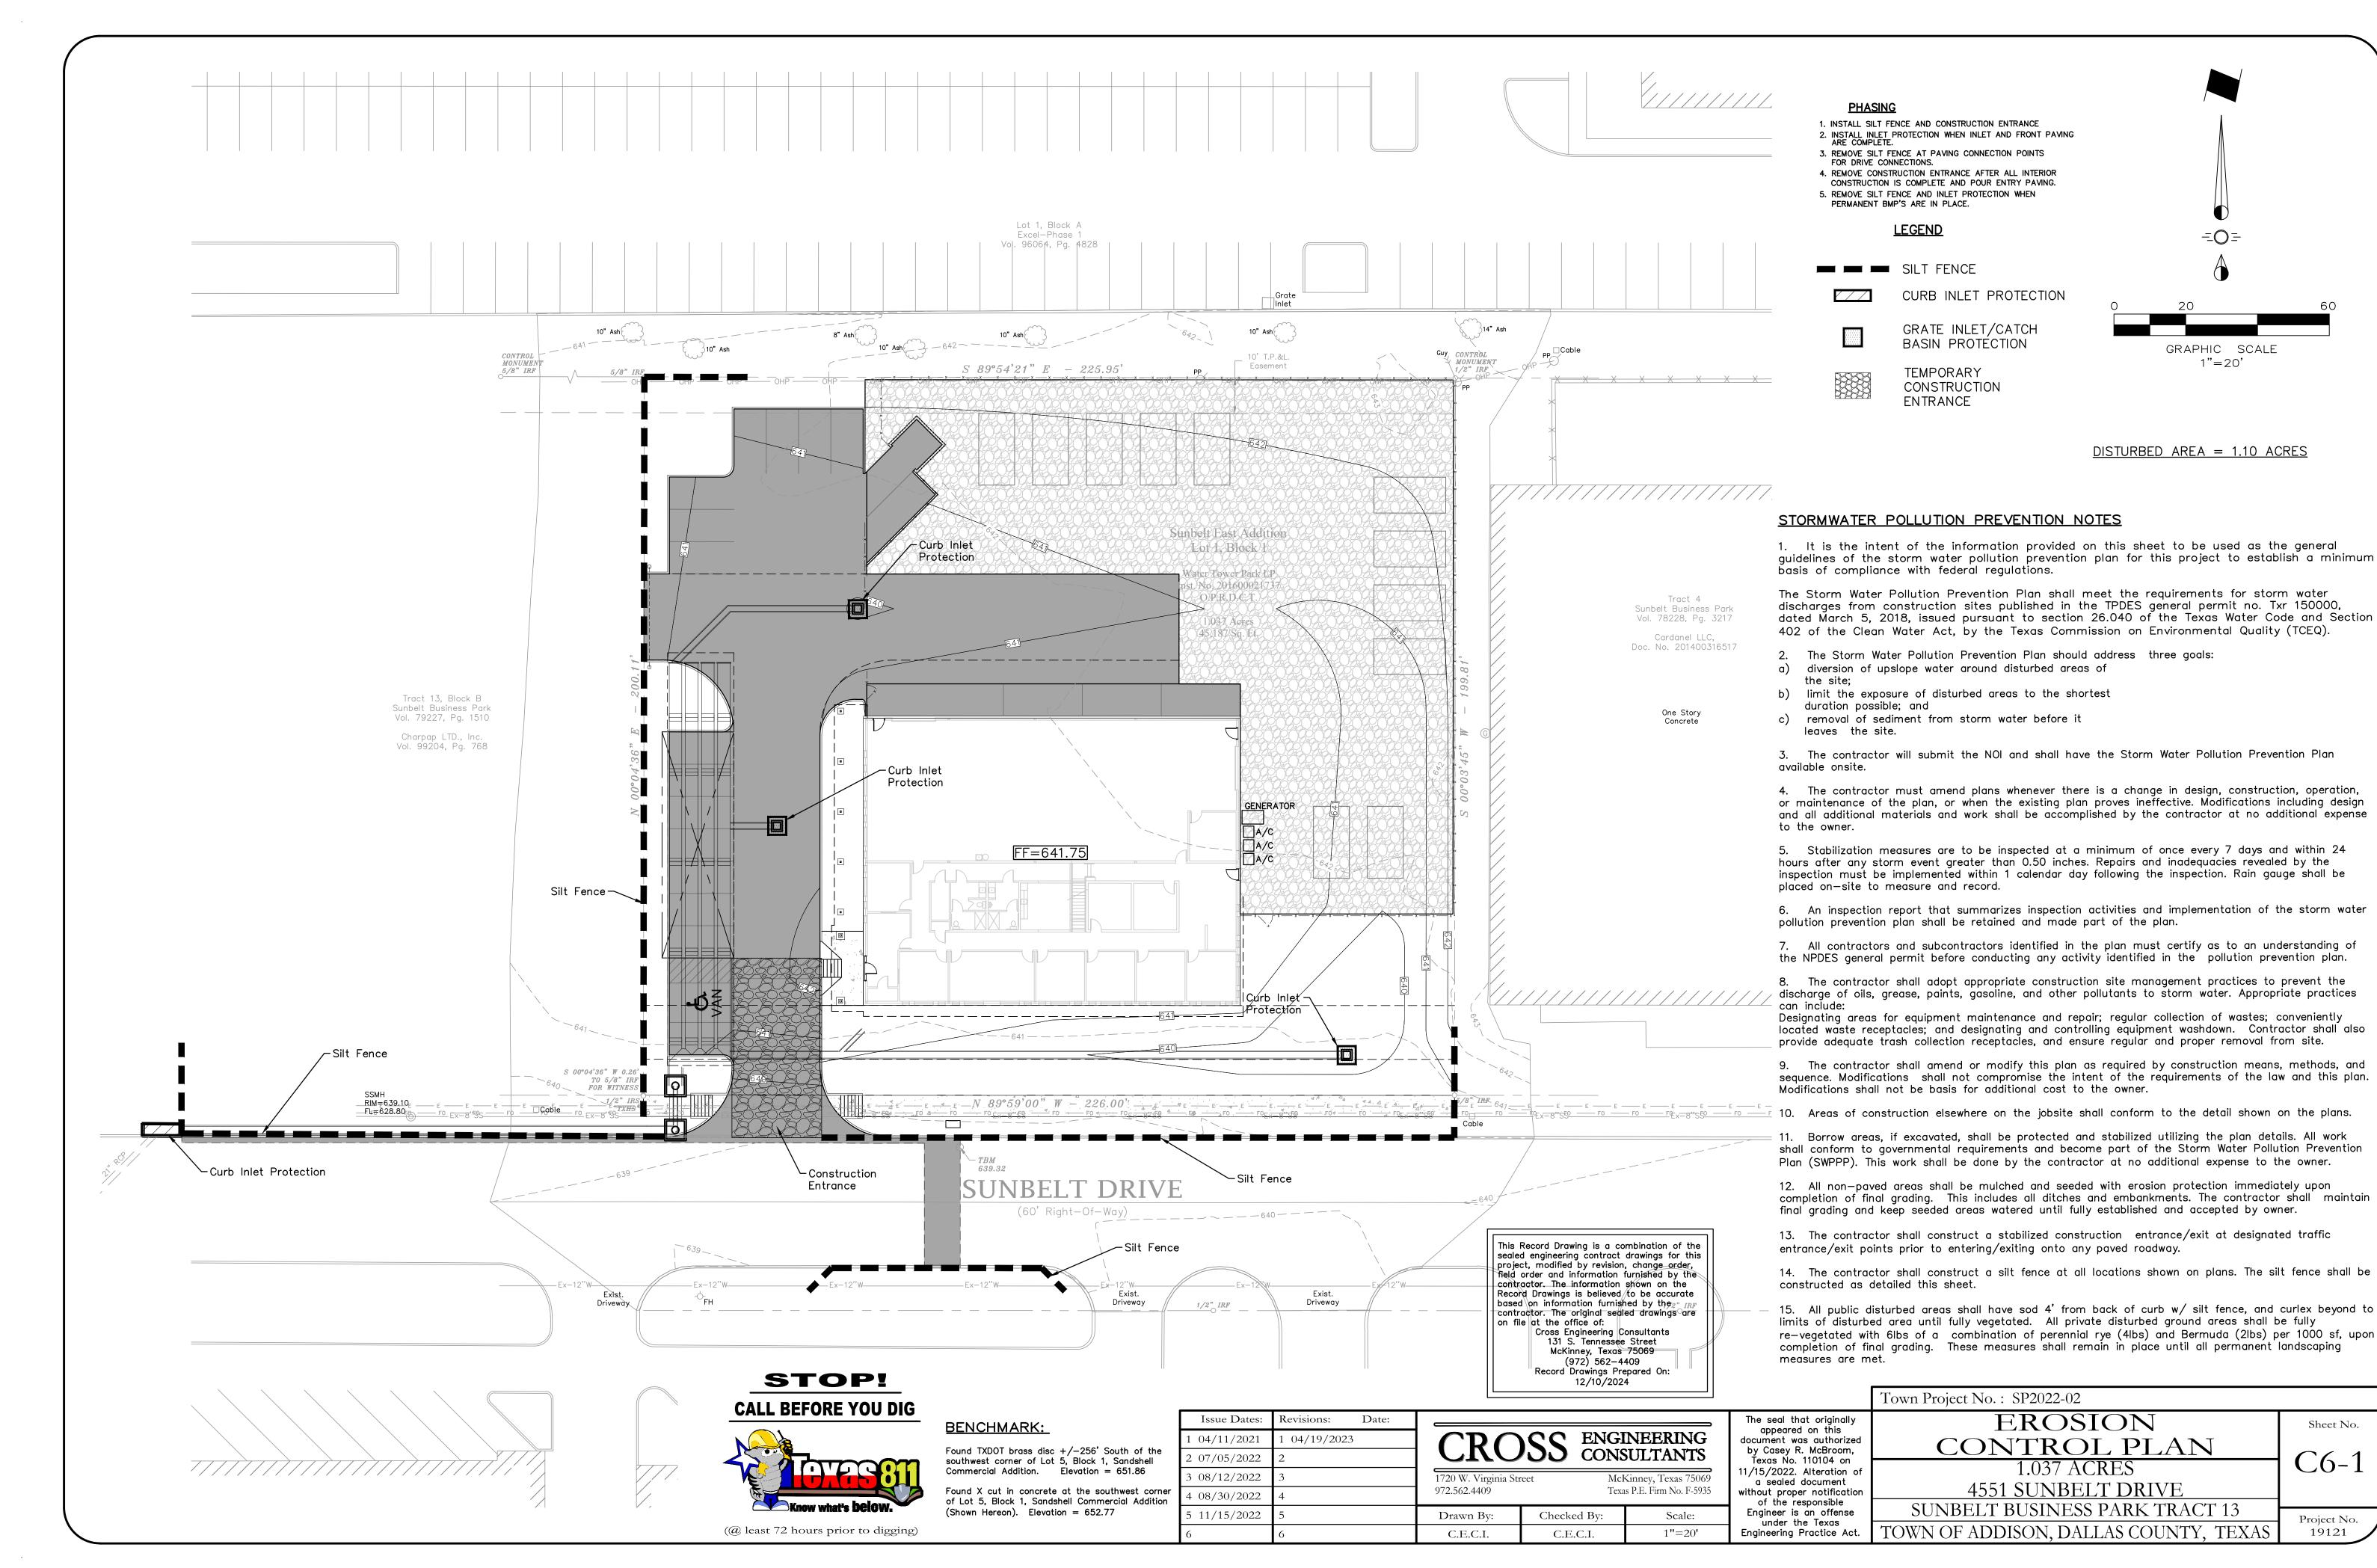

4551 SUNBELT DRIVE

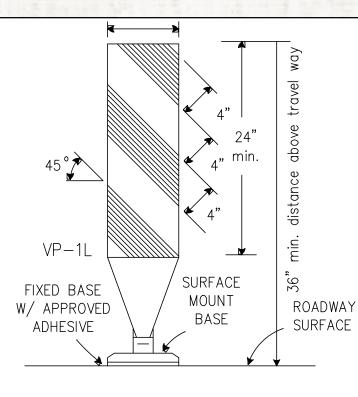

			um Desi Length			ested Maximum ing of Device	Minimum Sign Spacing
Posted Speed <del>X</del>	Formula	10′ □ffset	11′ □ffset	12′ Offset	□n a Taper	□n a Tangent	X Distance
30	٠, ٥	150′	165′	180′	30′	60′ -75′	120′
35	$\Gamma = \frac{80}{MZ_{s}}$	205′	225′	245′	35 35	70′ –90′	160′
40		265′	295′	320′	40′	80′ –100′	240′
45		450′	495′	540′	45′	90' -110'	320′
50		500′	550′	600′	50′	100′ -125′	400′
55	L=WS	550′	605′	660′	55 5	110' -140'	500′
60	L-W3	600′	660′	720′	60′	120′ –150′	<b>*</b> 600′
65		650′	715′	780′	65´	130′ –165′	<b>*</b> 700′

#### ★ Conventional Roads Only

\*\* Taper lengths have been rounded off. L=Length of Taper (FT.) W=Width of Offset (FT.) S=Posted Speed (MPH)

| 700′ | 770′ | 840′ | 70′ | 140′ −175′ || **※** 800′

		TYPICAL USAGE:		
	SHORT	SHORT TERM	INTERMEDIATE	LONG TE
MOBILE	DURATION	STATIONARY	TERM STATIONARY	NDITATS
	1	/		

## CHANNELIZING DEVICES

#### VERTICAL PANELS

CW20-1D

48" X 48"

(FLAGS-SEE NOTE 1)

Vertical Panels are normally used as channelizing devices to indicate tangent or nearly tangent roadway alignment where good target value of a device is needed in daytime as well as nighttime. In addition, vertical panels should be used at the edge of shoulder drop—offs and other areas such as lane transitions where positive daytime and nighttime delineation may be required. Vertical panels should be mounted back to back if used at the edge of cuts adjacent to two-way two lane roadways. Stripes are to be reflective orange and reflective white and should always slope downward toward the traveled way. Vertical Panels used on expressways, freeways, and other high speed roadways shall have a minimum of 2 square feet of retroreflective area facing traffic.

Self—righting supports are available with portable base. See Compliant Products List.

### **GENERAL NOTES:**

1. Unless otherwise stated in the plans, flags attached to the signs are REQUIRED.

2. All traffic control devices illustrated are REQUIRED, except those denoted with the triangle symbol may be omitted when stated elsewhere in the plans.

3. ROAD WORK AHEAD sign may be repeated if the visibility of zone is less than 1500'.

4. If pavement markings are not removed and traffic is directed over a double yellow centerline, the maximum spacing of channelizing devices in a tangent section should be no greater than 10 feet.

5. Town Inspectors Shall Field Approve Barricades Prior To Work Commencing.

# Existing Utilities in Area. Contractor to determine location and elevation of all utilities prior to construction. Contractor to inform Engineer of any conflicts prior to construction.

ROAD

CLOSED

R11-2

Type III Barricade

CW20-5L

48" X 48"

STOP!

(@ least 72 hours prior to digging)

PARKING

# 100

G20-2a

48" X 24"

Issue Dates: Revisions:

**PARKING** 

This Traffic Control Plan is for Reference Only. Contractor shall adhere to all MUTCD, TxDot, and Town Traffic Control Standards. Contractor is solely responsible for Traffic Control Installation and Implementation.

## TRAFFIC CONTROL NOTES:

Middle School: High School:

1. When the normal function of the roadway is suspended through closure of any portion of the right-of-way, temporary construction work zone traffic control devices shall be installed to effectively guide the motoring public through the area. Consideration for road user safety, worker safety, and the efficiency of road user flow is an integral element of every traffic control zone. All traffic control devices shall be in accordance with the latest T.M.U.T.C.D. and N.C.H.R.P. 350. Devices must contain either Type III Hi-Intensity sheeting or Type IV reboundable Hi-Intensity sheeting.

2. Any traffic control plans not included in the engineering plan set must be submitted for review a minimum of seven (7) working days prior to the anticipated lane closure. Construction activity shall not begin until the traffic control plan is approved by the Town of Addison. Traffic control plans may be required on other roadways as determined by the Traffic Engineer or the designee. All traffic control plans must be prepared by an individual that is certified in their preparation. Any deviation from an approved traffic control plan must be reviewed by the Traffic Engineer or their designated representative.

3. The contractor shall be responsible for maintaining all traffic control devices on an around—the—clock basis, whether or not work is active. Any deficiencies shall be corrected by the contractor immediately, regardless of time of day.

4. Lane closures will not be permitted on arterial roadways before 9:00 am or after 4:00 pm. Violations will result in suspension of all work at the job site for a minimum of 48 hours. The traffic engineer reserves the right to deny a closure for a special

7: 55am-9: am, 3: 30pm-4: 40pm 6: 45am-7: 45am, 2: 15pm-3: 15pm

5. Lane closures will not be permitted on streets adjacent to private and/or public schools during the following hours: 7:15am-8:15am, 2:45pm-3:45pm Elementary:

6. All temporary traffic control devices shall be removed as soon as practical when they are no longer needed. When work is suspended for short periods of time at the end of the workday, temporary traffic control devices that are no longer appropriate shall be removed or covered. The first violation of this provision will result in a verbal warning to the construction foreman. Subsequent violations will result in suspension of all work at the job site for a minimum of 48 hours.

7. Existing permanent signs removed by the contractor for construction purposes other than stop, yield and street name signs shall be returned to the Town of Addison. All stop, yield and street name signs removed shall be temporarily erected in the appropriate locations (no less than 7 feet vertical from grade) until permanent signing can be installed. Any temporary stop of yield sign locations to be left in place overnight will require prior approval from the Town Engineer.

This Record Drawing is a combination of the sealed engineering contract drawings for this project, modified by revision, change order, field order and information furnished by the

contractor. The information shown on the Record Drawings is believed to be accurate based on information furnished by the

contractor. The original sealed drawings are

Cross Engineering Consultants 131 S. Tennessee Street

McKinney, Texas 75069

(972) 562-4409

Record Drawings Prepared On: 12/10/2024

on file at the office of:

8. Any permanent sign or existing pavement markings that conflict with the approved traffic control plan shall be covered, obliterated or removed as directed by the Town

9. Access must be maintained to all drives and side streets or as indicated in the traffic control plan.

CW20-1D 48" X 48" (FLAGS-SEE NOTE 1)

> Type III Barricade

● ● ● Channelizing Devices Sign Post

Work Area

All signage shall conform to the Manual on Uniform Traffic Control Devices, latest edition.

All signs placed in parkways and medians shall be coordinated with existing signs to not obstruct the view of either one.

Contractor to place signs in parkway and medians as to not obstruct sight visibility at driveway and street intersections

Road to be closed less than 1 week for construction. Contractor shall coordinate with town waste services, town emergency services with minimum 48 Hours notification prior

# Town Project No.: SP2022-02

TRAFFIC

1.037 ACRES

4551 SUNBELT DRIVE

CONTROL PLAN

Project No. 19121

Sheet No.

#### **CALL BEFORE YOU DIG BENCHMARK:**

Found TXDOT brass disc +/-256' South of the southwest corner of Lot 5, Block 1, Sandshell

Commercial Addition. Elevation = 651.86 Found X cut in concrete at the southwest corner of Lot 5, Block 1, Sandshell Commercial Addition (Shown Hereon). Elevation = 652.77

07/05/2022 8 08/12/2022 08/30/2022 5 11/15/2022

CROSS ENGINEERING CONSULTANTS 04/11/2021 04/19/2023

Date:

1720 W. Virginia Street McKinney, Texas 75069 Texas P.E. Firm No. F-5935 972.562.4409 Drawn By: Checked By:

C.E.C.I.

Scale: 1"=40' C.E.C.I.

11/15/2022. Alteration of a sealed document without proper notification of the responsible Engineer is an offense under the Texas

The seal that originally

appeared on this

by Casey R. McBroom,


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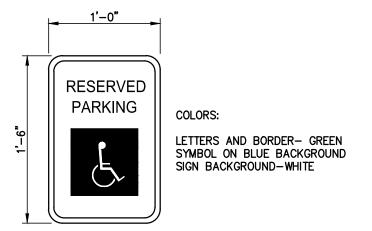
Texas No. 110104 on

3: 30pm-4: 40pm

Engineering Practice Act.

SUNBELT BUSINESS PARK TRACT 13 TOWN OF ADDISON, DALLAS COUNTY, TEXAS



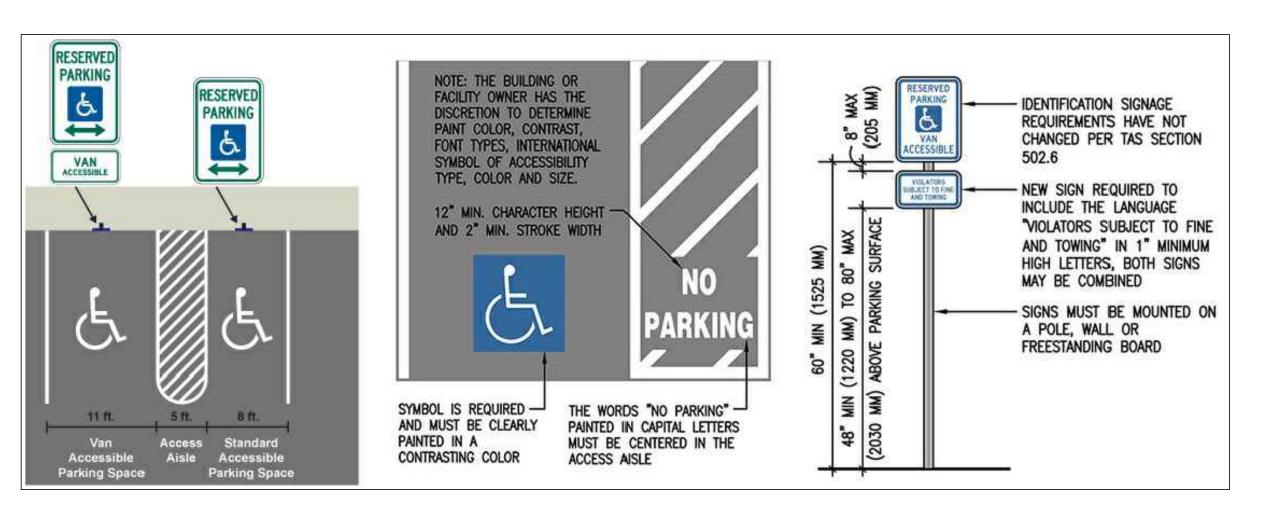

# RESERVED PARKING LETTERS AND BORDER- GREEN SYMBOL ON BLUE BACKGROUND SIGN BACKGROUND-WHITE VAN-ACCESSIBLE


- 1. SPACING BETWEEN LETTERS, COLORS, AND PROCESSES SHALL CONFORM STANDARD HIGHWAY AND SIGN DESIGN FOR TEXAS.
- 2. INSTALL 2' BACK OF CURB OR WHEEL STOPS, UNLESS OTHERWISE INDICATED.
- 3. VAN-ACCESSIBLE SIGNAGE ON VAN SPACES ONLY.

#### TYPICAL SIGNAGE DETAIL <u>TYPE</u> N.T.S.

#### NOTES:

- 1. SPACING BETWEEN LETTERS, COLORS, AND PROCESSES SHALL CONFORM STANDARD HIGHWAY AND SIGN DESIGN FOR TEXAS.
- 2. INSTALL 2' BACK OF CURB OR WHEEL STOPS, UNLESS OTHERWISE INDICATED.
- 3. VAN-ACCESSIBLE SIGNAGE ON VAN SPACES ONLY.

# TYPICAL SIGNAGE DETAIL TYPE II

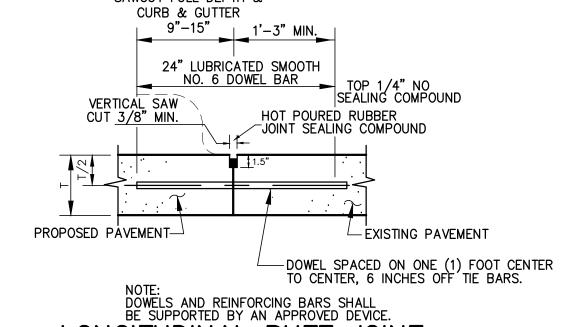



SAWCUT FULL DEPTH &

LONGITUDINAL BUTT JOINT


- 1. NO. 5 SMOOTH DOWEL BAR MAY BE USED IN 5 INCH AND 6 INCH PAVEMENT THICKNESS.
- 2. LONGITUDINAL BUTT CONSTRUCTION MAY BE UTILIZED IN PLACE OF LONGITUDINAL HINGED (KEYWAY) JOINT AT CONTRACTORS OPTION.
   3. DOWEL BARS SHALL BE DRILLED INTO PAVEMENT HORIZONTALLY
- BY USE OF A MECHANICAL RIG.

  4. DRILLED BY HAND IS NOT ACCEPTABLE, PUSHING DOWEL BARS INTO GREEN CONCRETE NOT ACCEPTABLE.

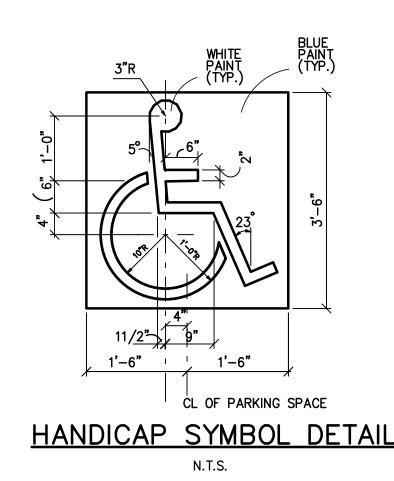

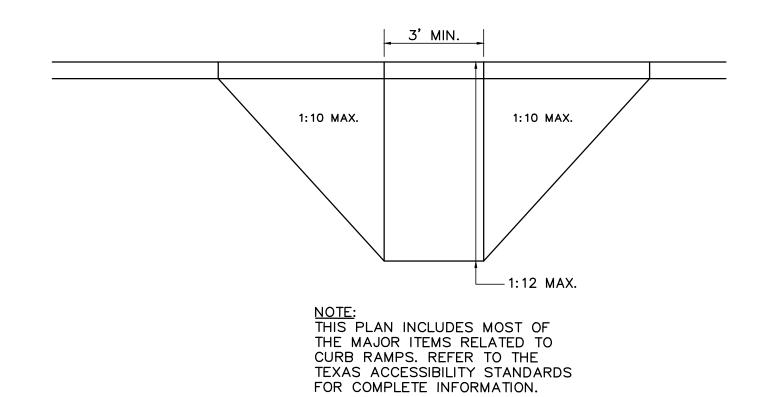




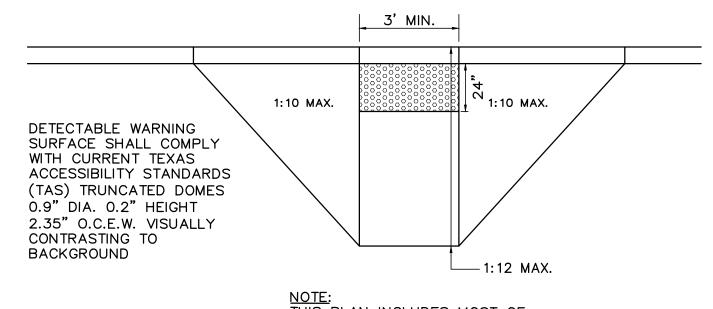


NOTE: THIS PLAN INCLUDES MOST OF THE MAJOR ITEMS RELATED TO CURB RAMPS. REFER TO THE TEXAS ACCESSIBILITY STANDARDS FOR COMPLETE INFORMATION.

HANDICAP RAMP DETAIL (R.O.W. USE ONLY)

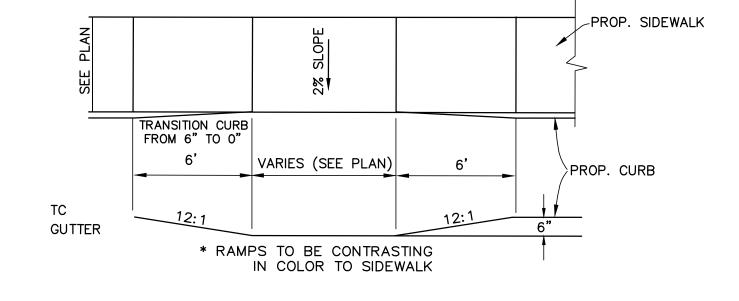


HANDICAP RAMP DETAIL (PRIVATE USE ONLY)

# DOWELS AND REINFORCING BARS SHALL BE SUPPORTED BY AN APPROVED DEVICE.

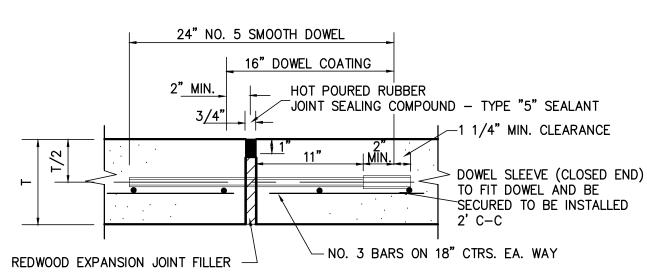




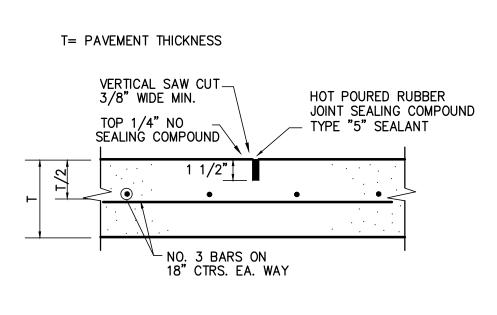


SAWED DUMMY (CONTROL) JOINT

MAXIMUM SPACING IS 15' CTRS. (TYP.)

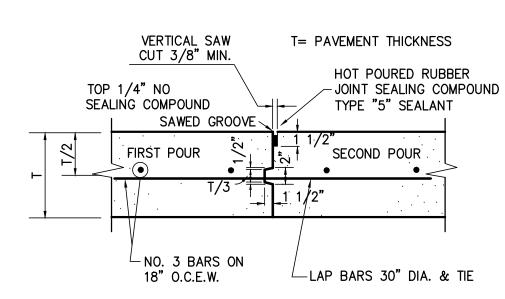


**CONSTRUCTION JOINT** 

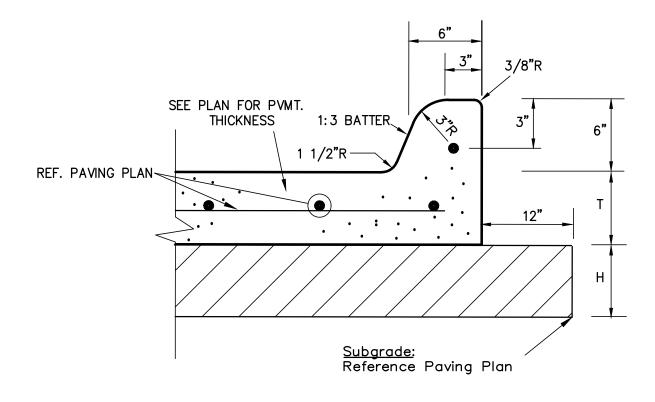

PAVEMENT SECTION WITH CURB

Scale:

N.T.S.

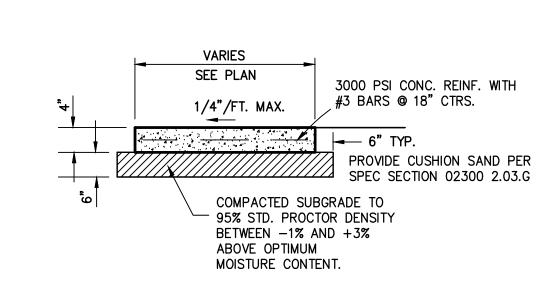

SIDEWALK DETAIL N.T.S.

# **BENCHMARK:**

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04/11/2021	1 04/19/2023	
07/05/2022	2	
08/12/2022	3	1720 W. V
08/30/2022	4	972.562.4
11/15/2022	5	Drawn

<b>CROSS</b>	ENGINEERING CONSULTANTS
1720 W. Virginia Street 972.562.4409	McKinney, Texas 75069 Texas P.E. Firm No. F-5935

Checked By:

C.E.C.I.

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TOWN OF ADDISON, DALLAS COUNTY, TEXAS **Engineering Practice Act.** 


## Town Project No.: SP2022-02 CONSTRUCTION **DETAILS** 1.037 ACRES 4551 SUNBELT DRIVE SUNBELT BUSINESS PARK TRACT 13


Sheet No.


C8-1


Project No.


19121

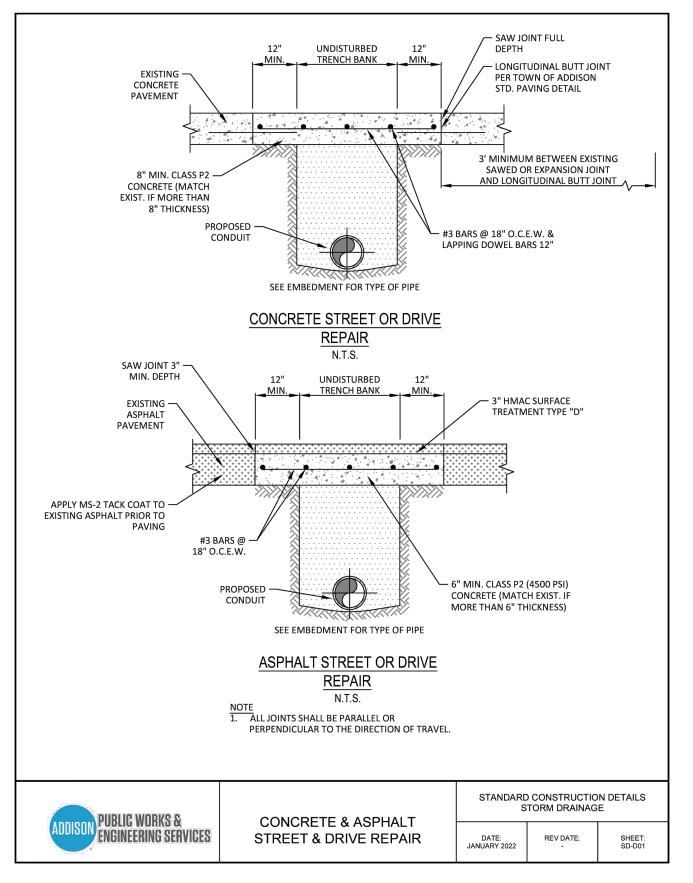


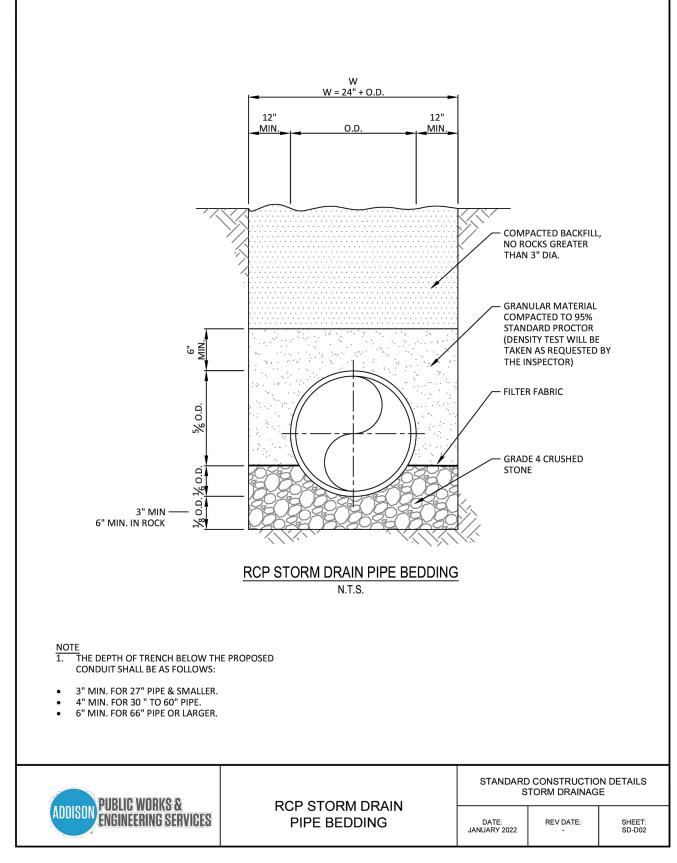


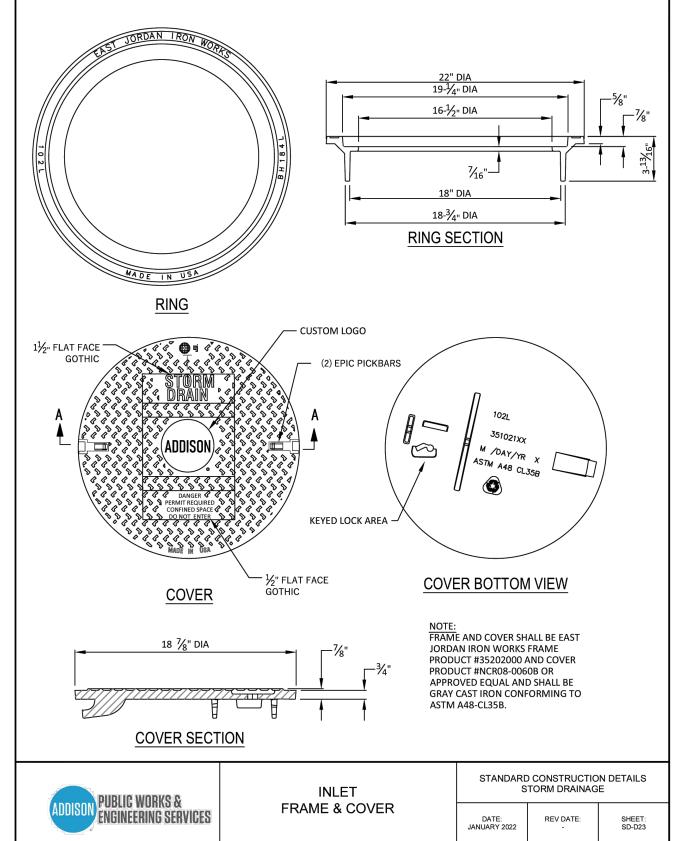


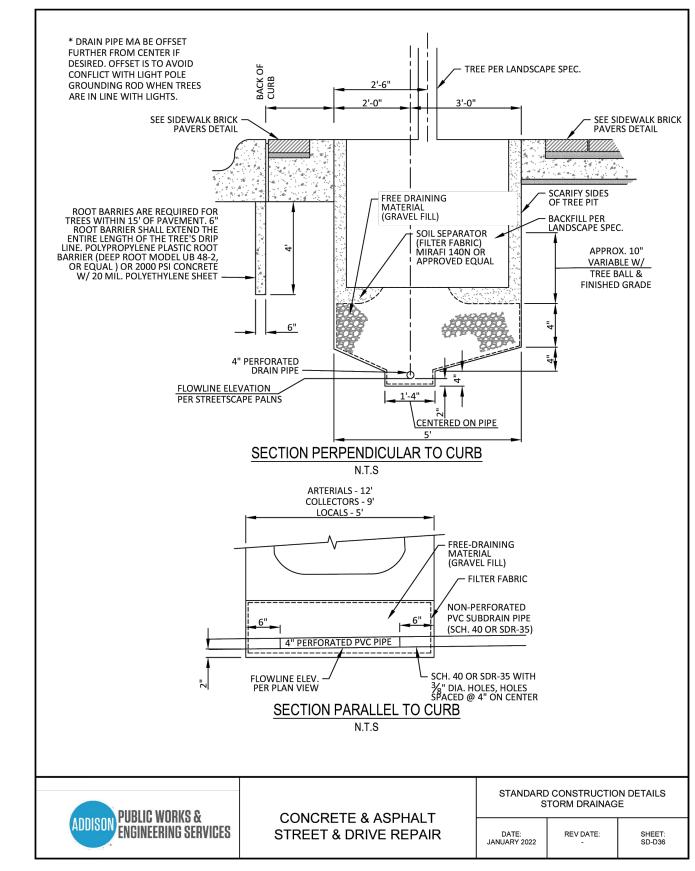

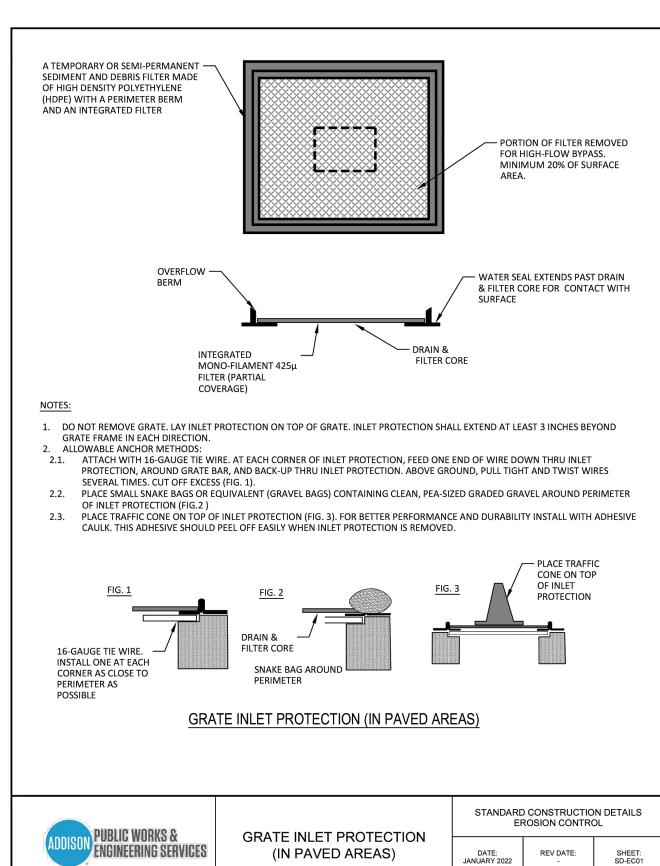

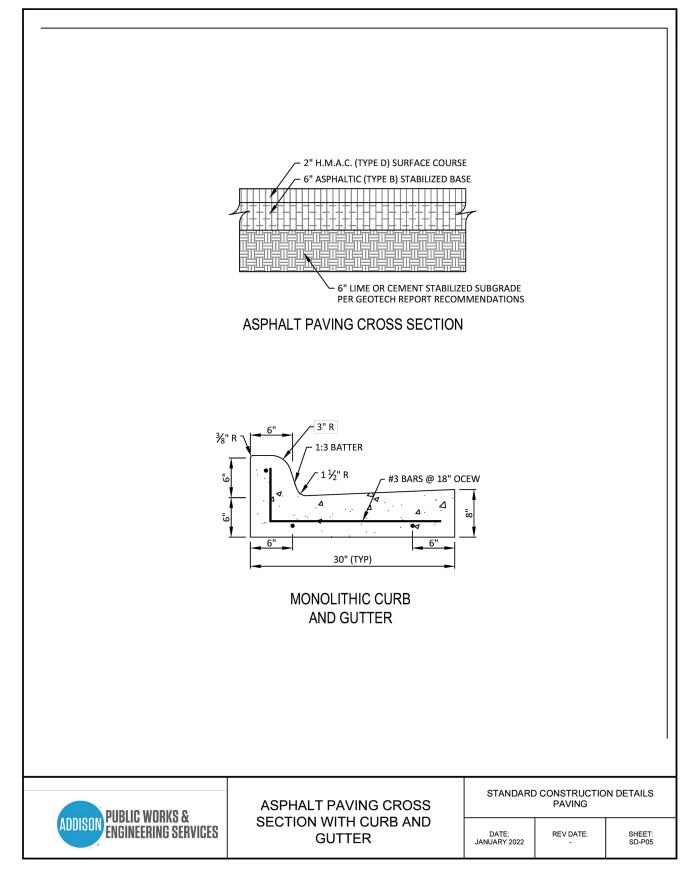

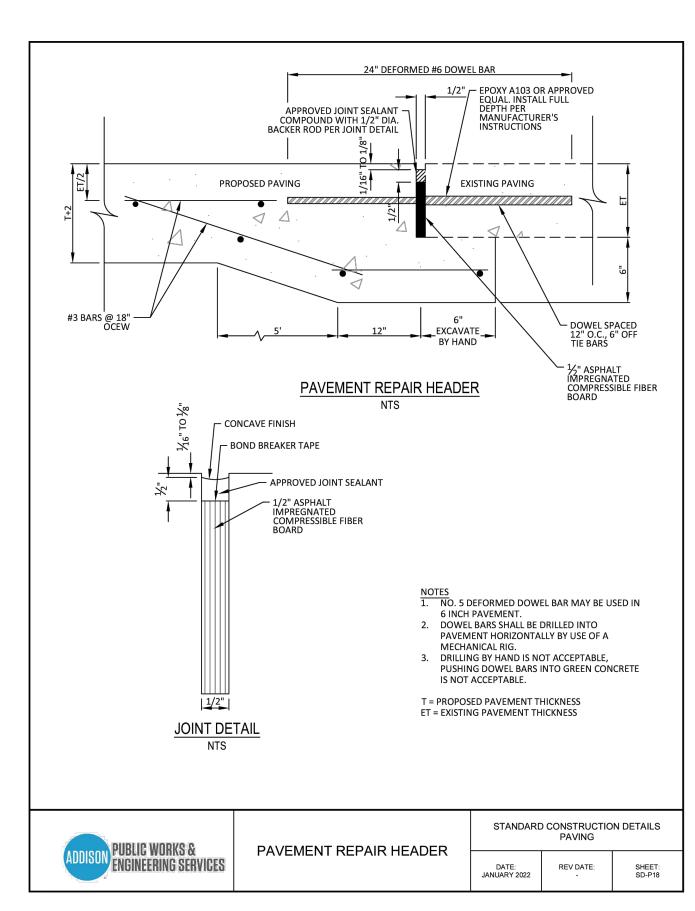

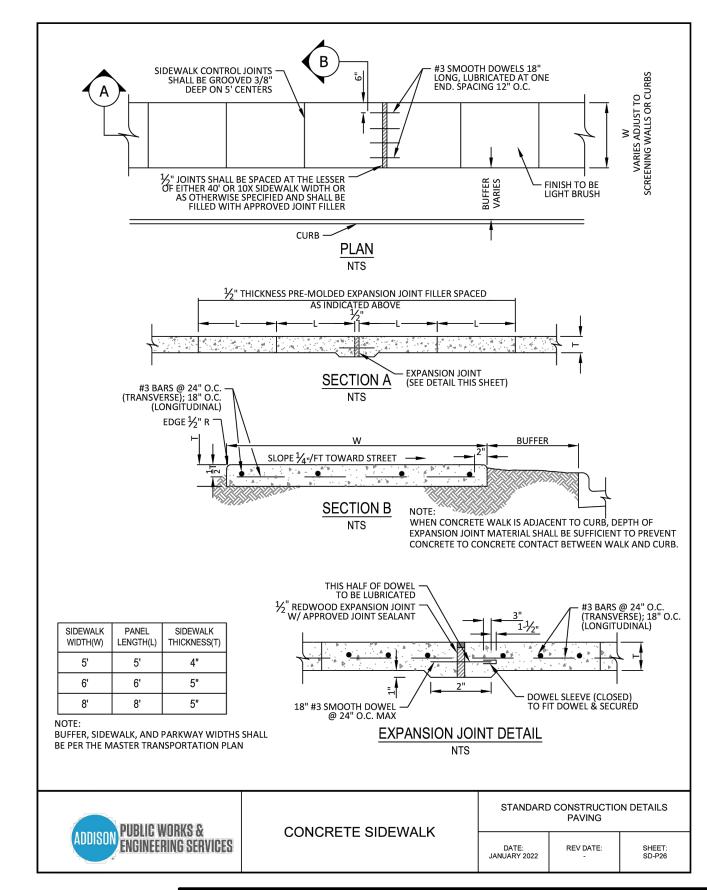

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4 08/30/2022	4	972.562.4409	Texa		
5 11/15/2022	5	Drawn By:	Checked By:	Scale:	

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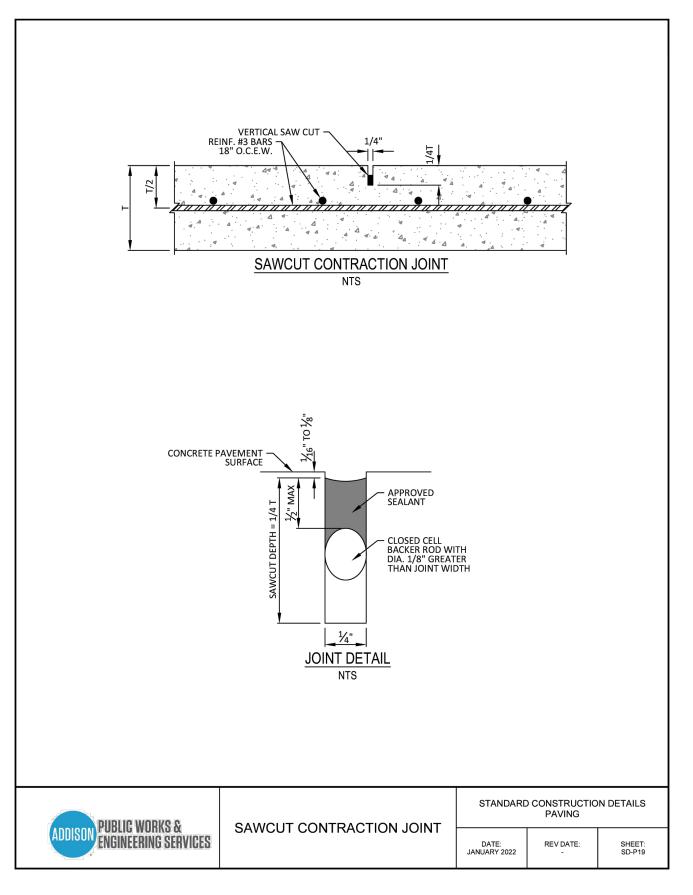
under the Texas TOWN OF ADDISON, DALLAS COUNTY, TEXAS Engineering Practice Act.


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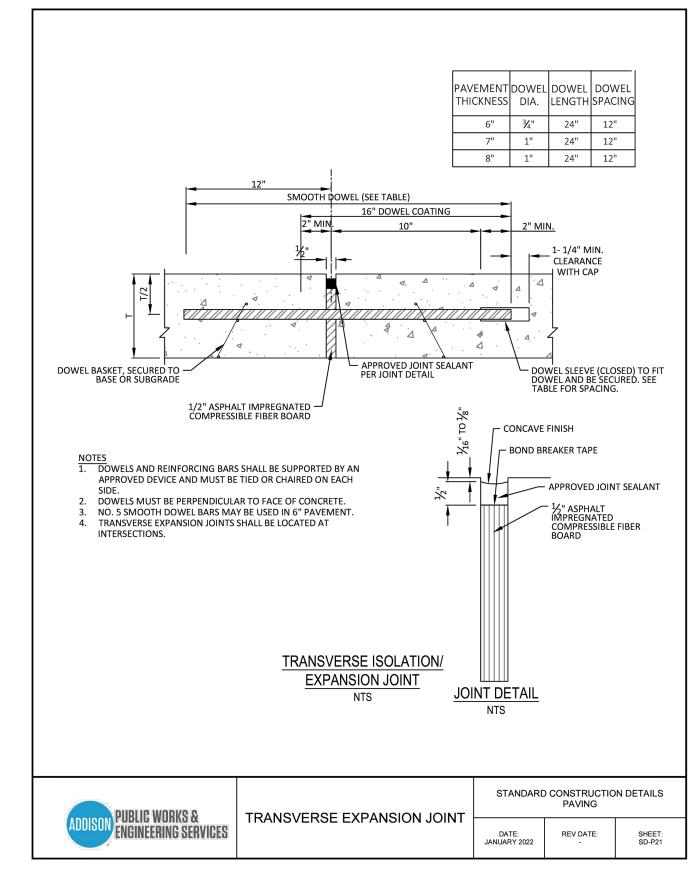
SUNBELT BUSINESS PARK TRACT 13


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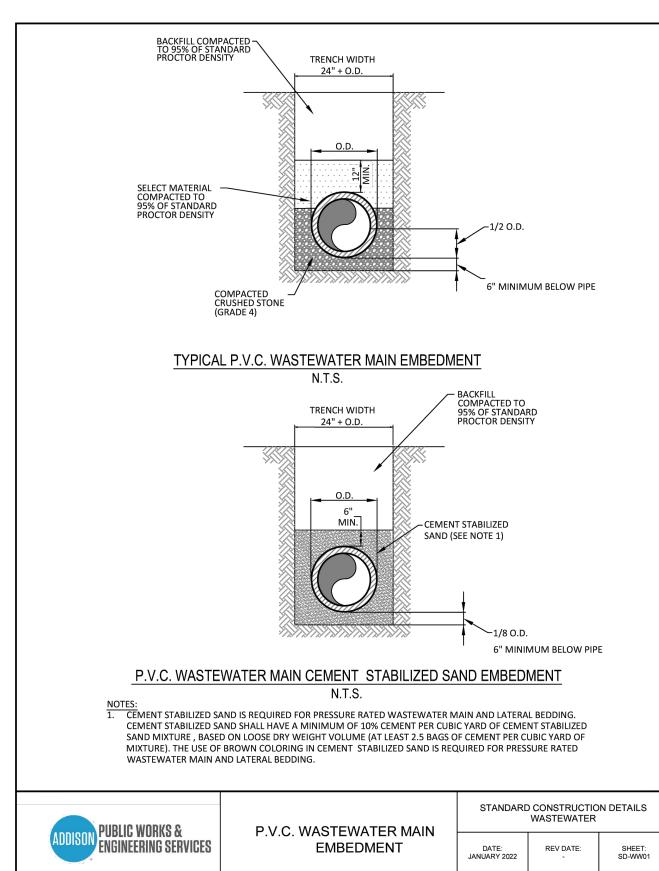
Project No. 19121










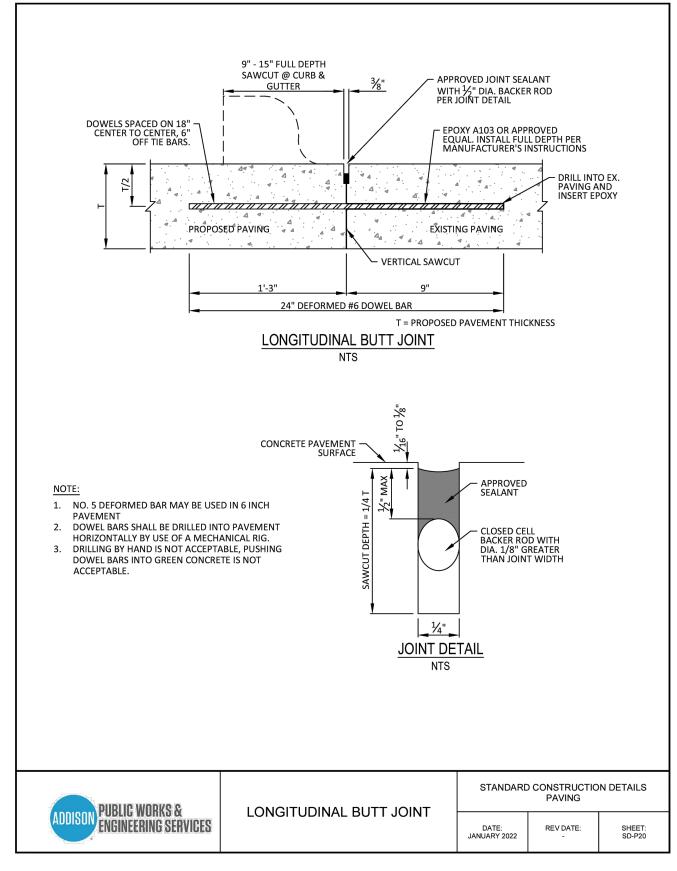

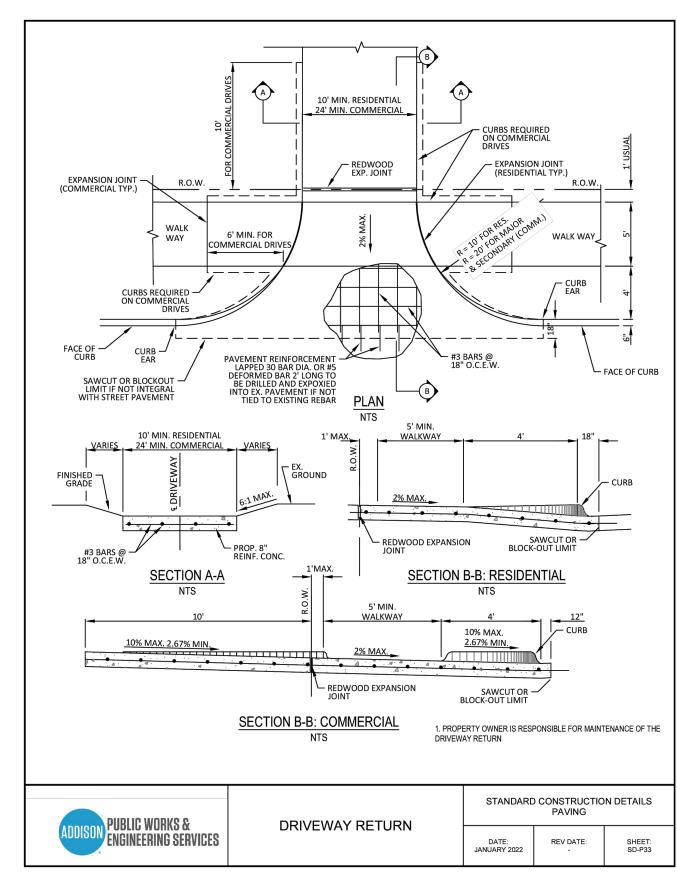

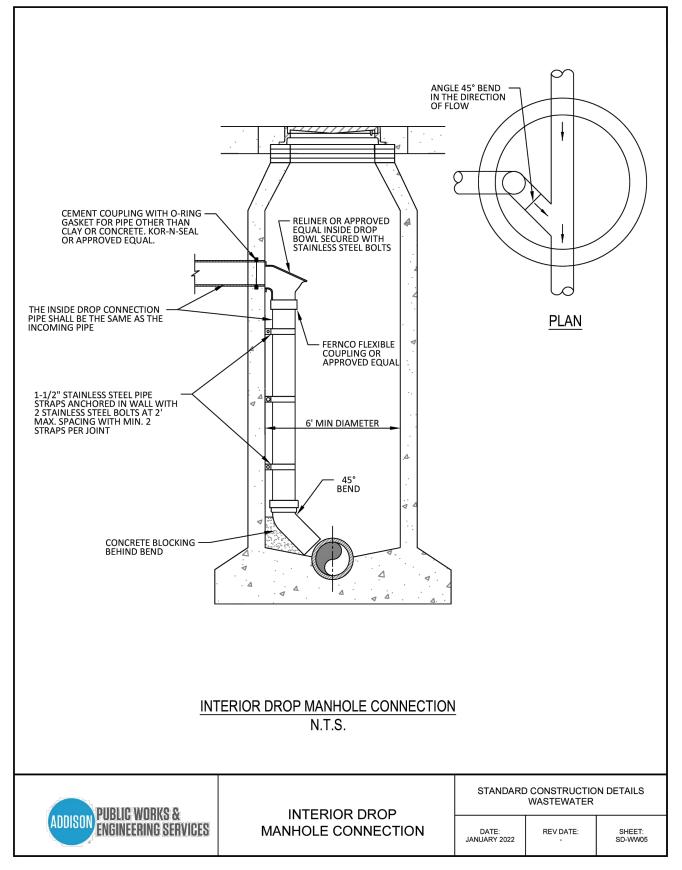

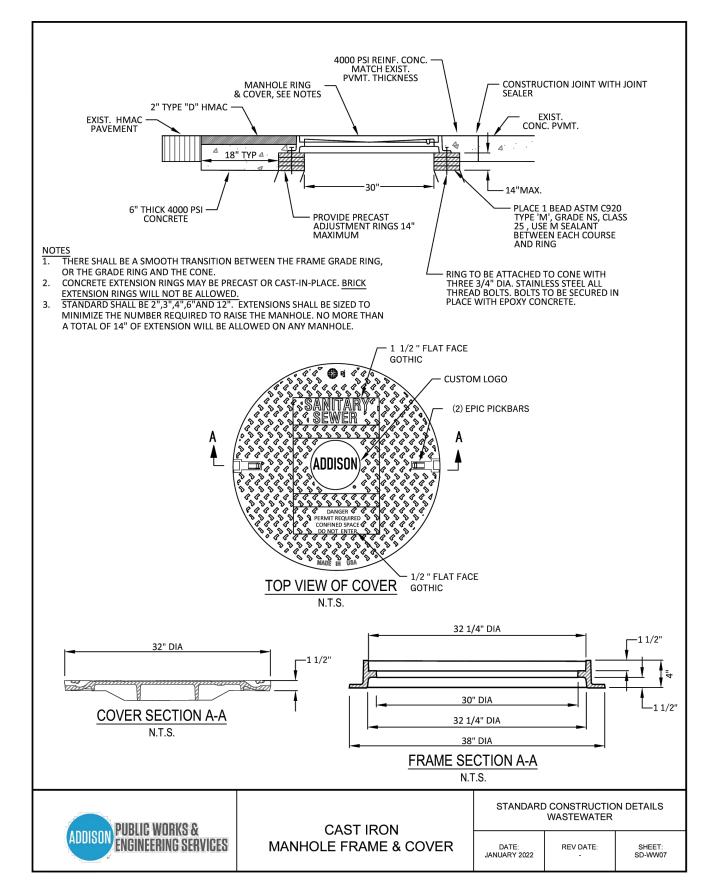

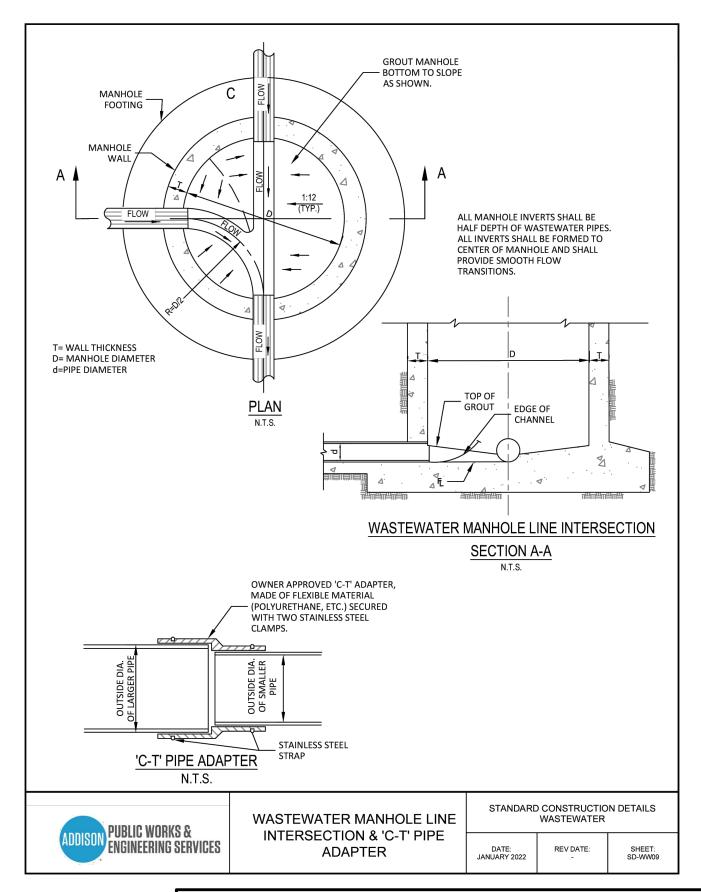

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5 11/15/2022	5	Drawn By:	Checked By:	Scale:

C.E.C.I.

C.E.C.I.

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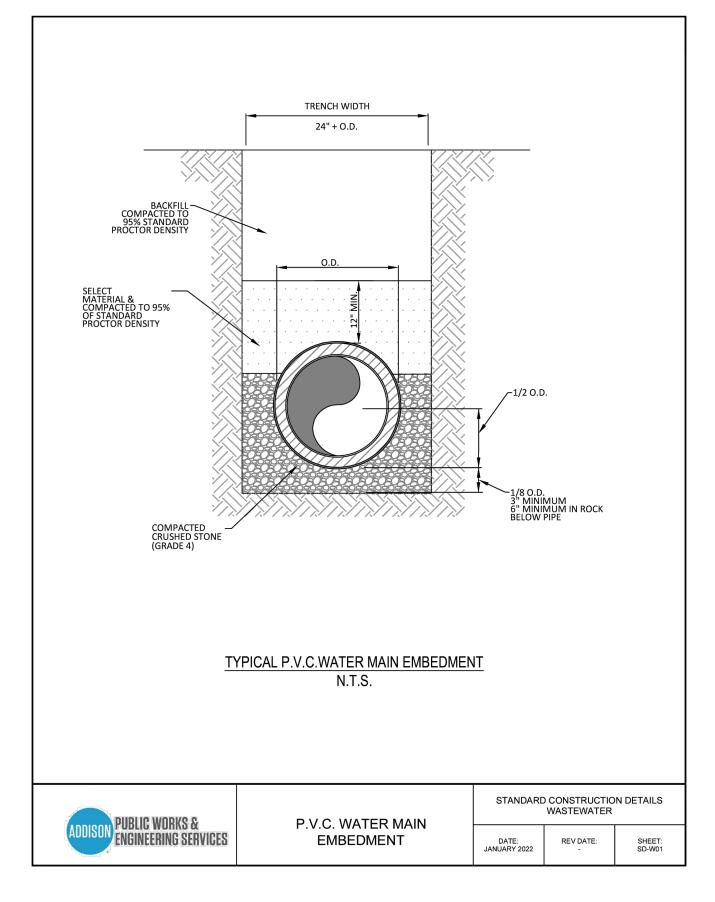
Town Project No.: SP2022-02 TOA - STANDARD CONST. DETAILS 1.037 ACRES 4551 SUNBELT DRIVE


SUNBELT BUSINESS PARK TRACT 13


Sheet No. C8-3


Project No.


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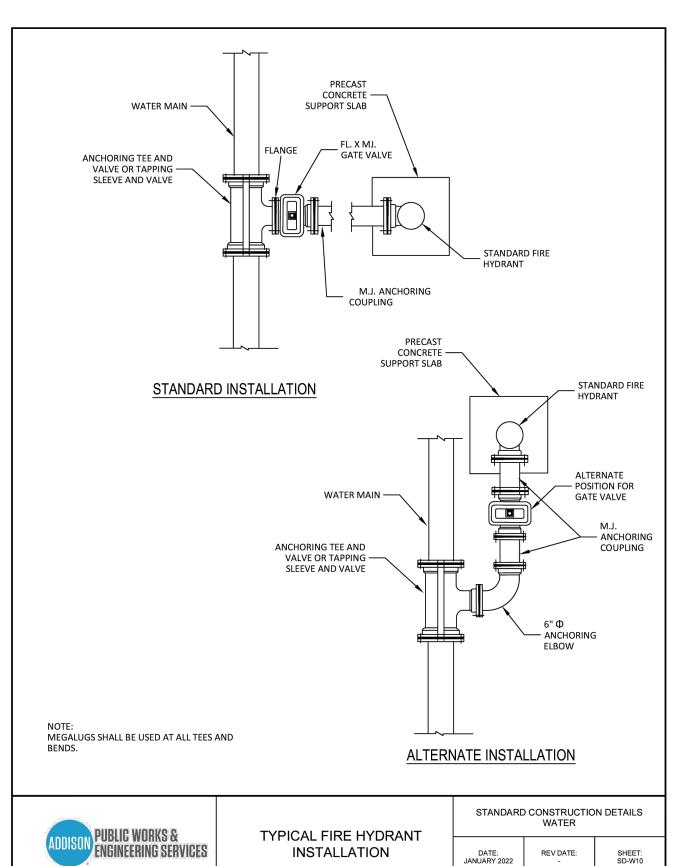





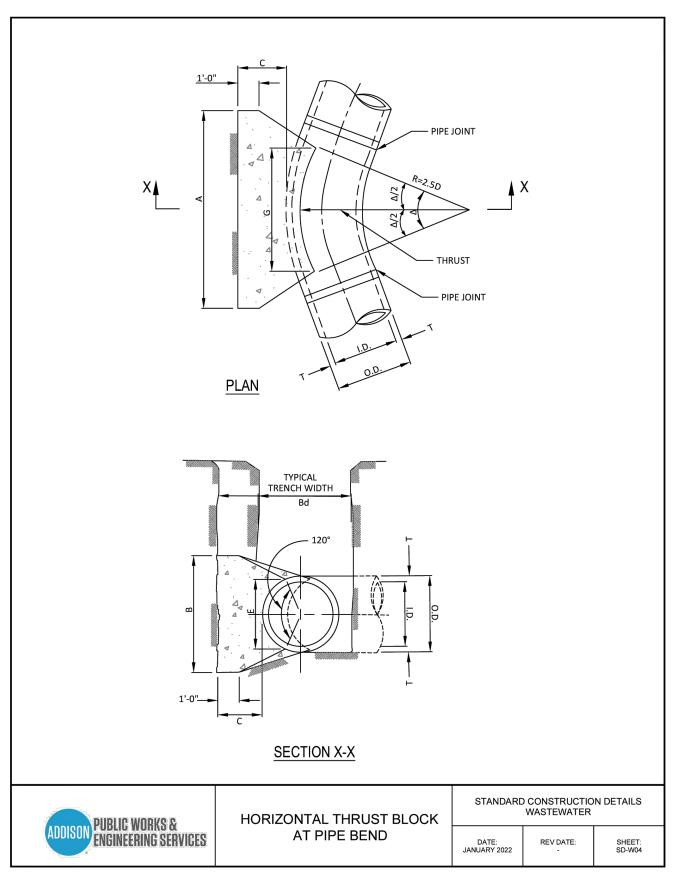

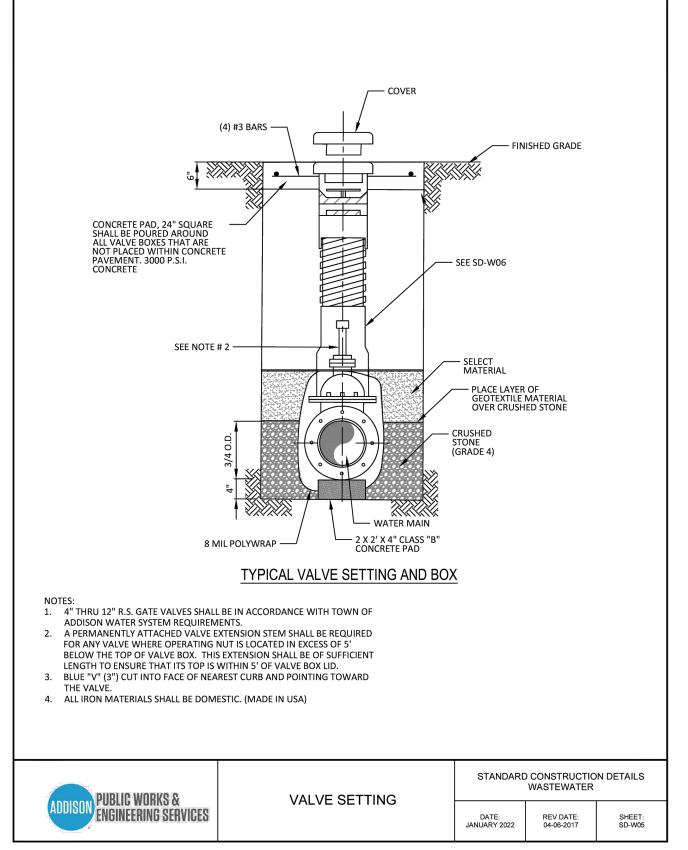

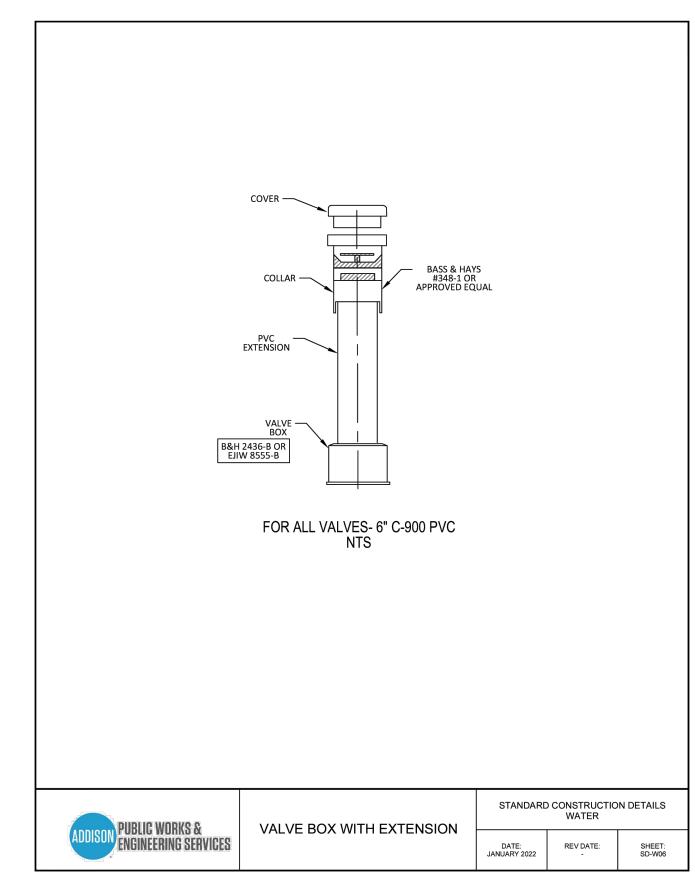

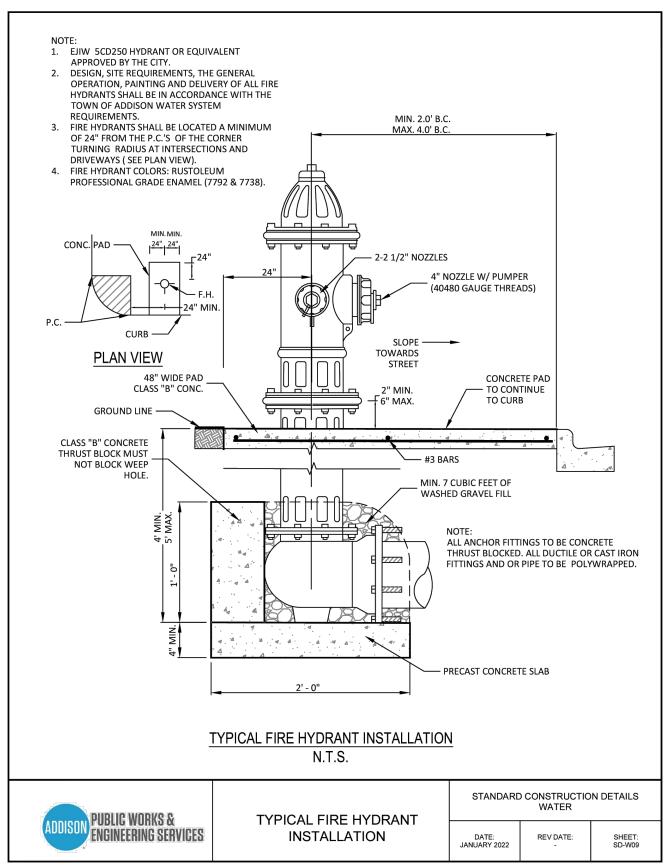

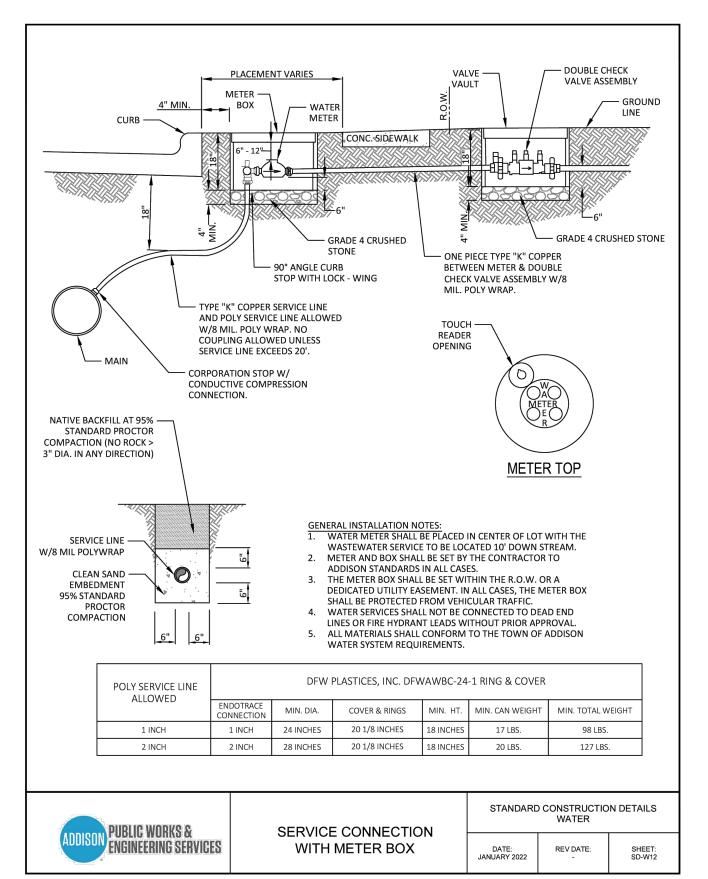

Found TXDOT brass disc +/-256' South of the southwest corner of Lot 5, Block 1, Sandshell Commercial Addition. Elevation = 651.86

Found X cut in concrete at the southwest corner of Lot 5, Block 1, Sandshell Commercial Addition (Shown Hereon). Elevation = 652.77


	Issue Dates:	Revisions: Date:				The seal that originally appeared on this
	1 04/11/2021	1 04/19/2023			NEERING	document was authorized
	2 07/05/2022	2		CONS	SULTANTS	by Casey R. McBroom, Texas No. 110104 on
	3 08/12/2022	3	1720 W. Virginia Str	reet McKinney, Texas 75069 Texas P.E. Firm No. F-5935		11/15/2022. Alteration of a sealed document without proper notification of the responsible
er 1	4 08/30/2022	4	972.562.4409			
	5 11/15/2022	5	Drawn By:	Checked By:	Scale:	Engineer is an offense under the Texas
	6	6	C.E.C.I.	C.E.C.I.	N.T.S.	Engineering Practice Act.


e seal that originally appeared on this ment was authorized Casey R. McBroom, xas No. 110104 on 5/2022. Alteration of sealed document ut proper notification of the responsible gineer is an offense under the Texas


Town Project No.: SP2022-02 TOA - STANDARD CONST. DETAILS 1.037 ACRES


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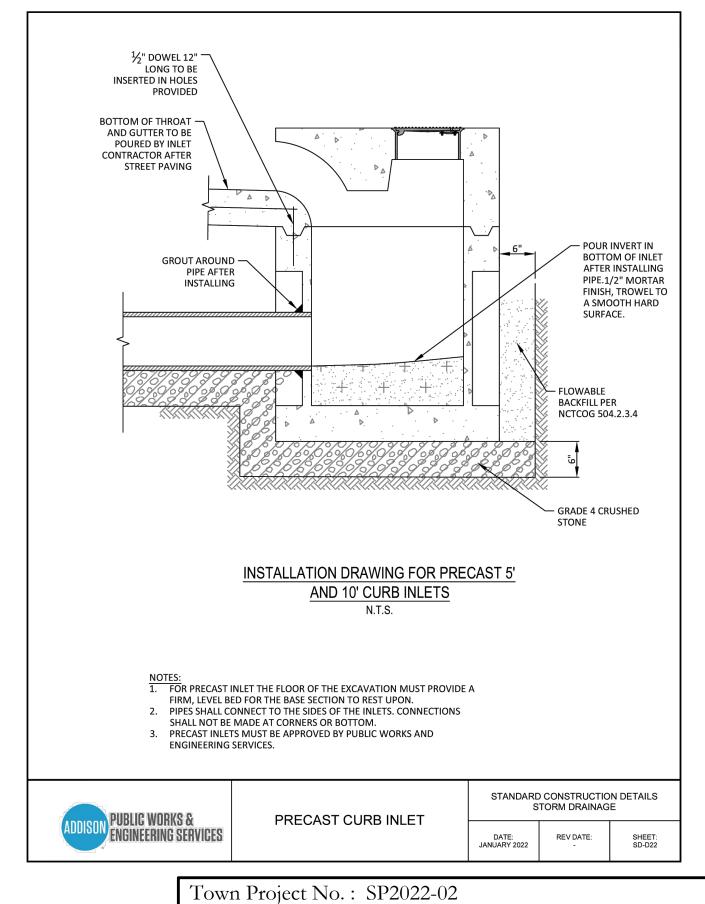
4551 SUNBELT DRIVE SUNBELT BUSINESS PARK TRACT 13 Project No. TOWN OF ADDISON, DALLAS COUNTY, TEXAS 19121



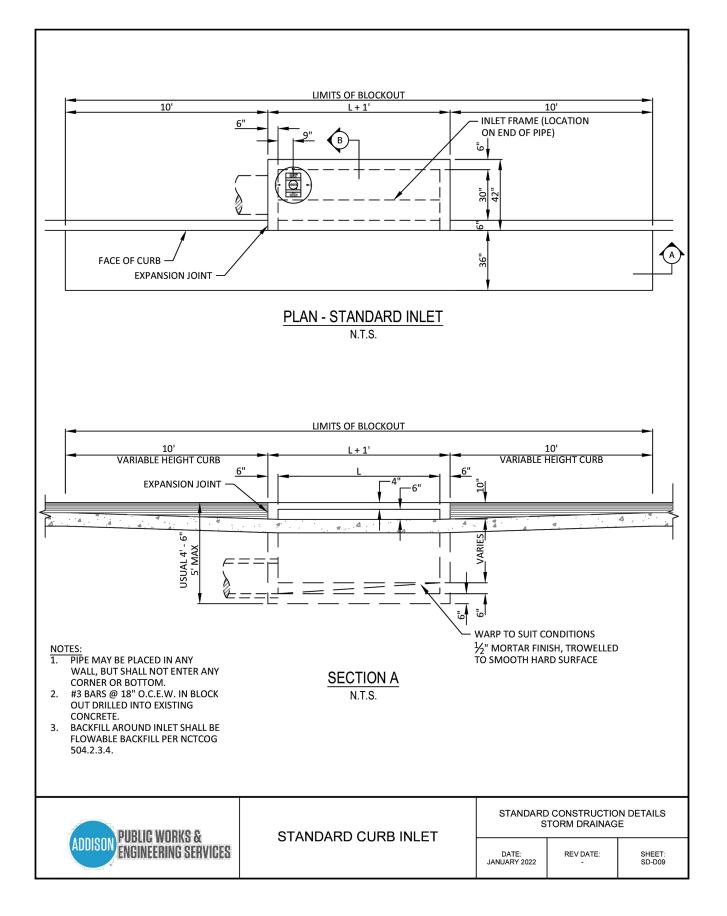

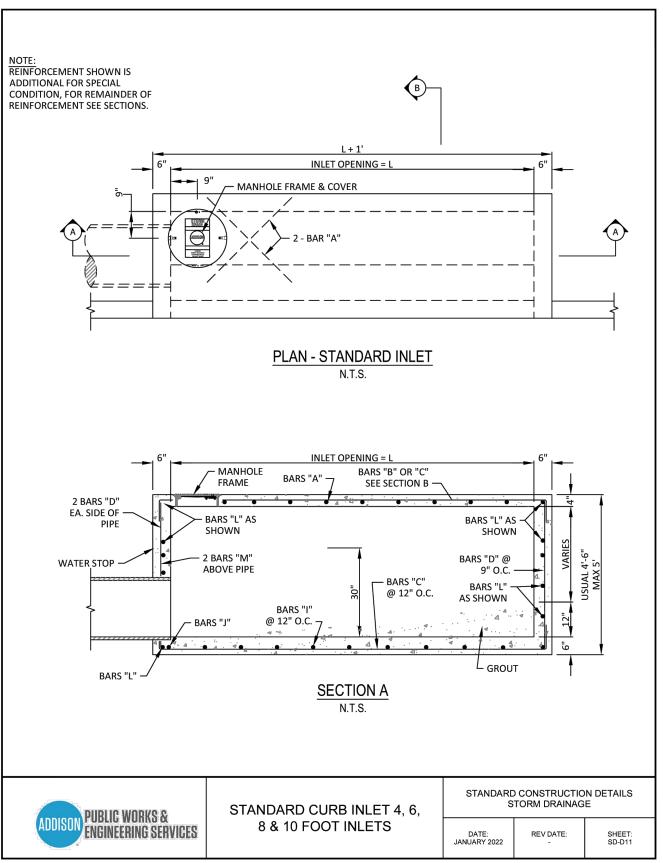

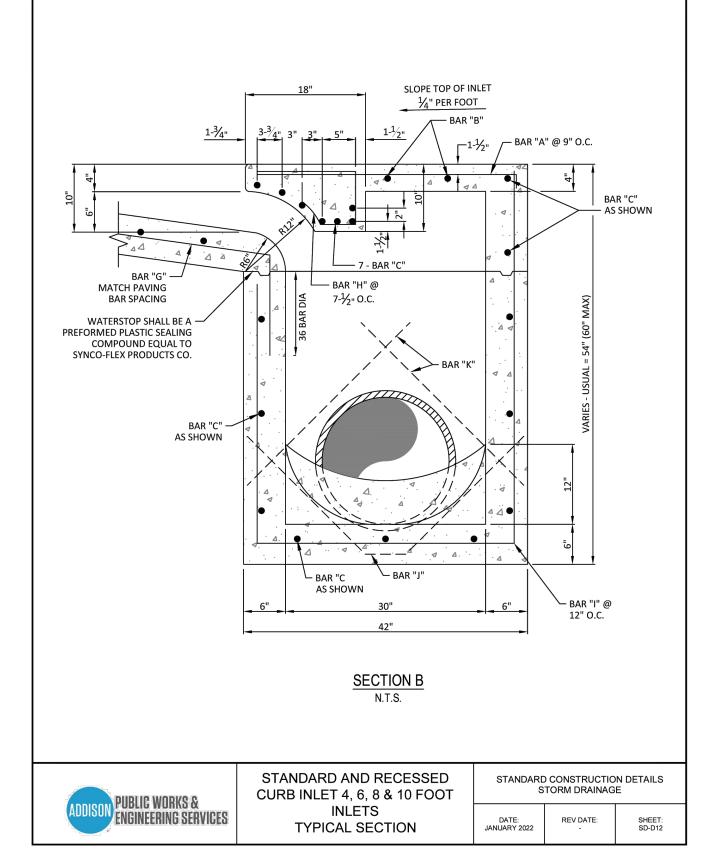

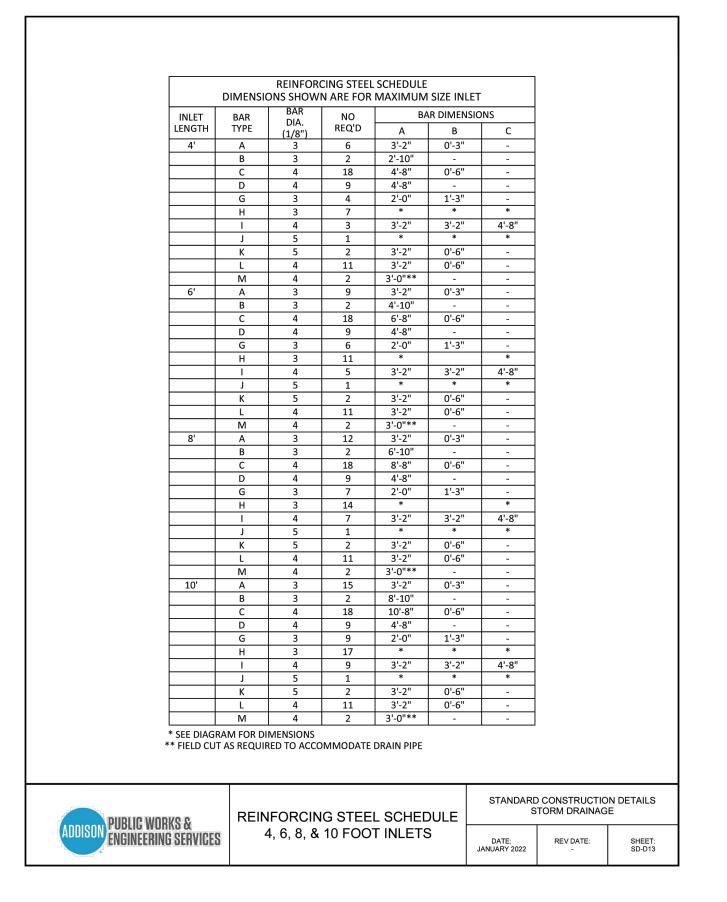

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4 08/30/2022	4	972.562.4409	Texa	s P.E. Firm No. F-5935	without proper notification of the responsible
5 11/15/2022	5	Drawn By:	Checked By:	Scale:	Engineer is an offense under the Texas
6	6	C.E.C.I.	C.E.C.I.	N.T.S.	Engineering Practice Act.

The seal that originally appeared on this ocument was authorized by Casey R. McBroom, Texas No. 110104 on /15/2022. Alteration of a sealed document thout proper notification of the responsible

TOA - STANDARD CONST. DETAILS 1.037 ACRES 4551 SUNBELT DRIVE

SUNBELT BUSINESS PARK TRACT 13

TOWN OF ADDISON, DALLAS COUNTY, TEXAS

Sheet No. C8-5

Project No. 19121