
# HANGAR ADDITION PLANS FOR:

# EHOAA - EXECUTIVE HANGAR OWNERS ASSOCIATION OF ADDISON

ADDISON AIRPORT ADDISON, TEXAS

AUGUST 2008

PW# 2008-07

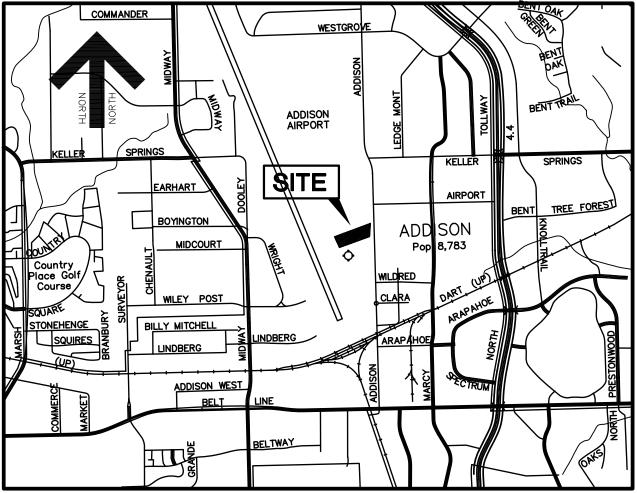

LOCATION MAP

SCALE: 1"=2000'

"AS-BUILT"

THIS AS-BUILT DRAWING IS BASED ON INFORMATION OBTAINED FROM BUILDING CONTRACTORS DURING CONSTRUCTION AS PROVIDED TO JDJR ENGINEERS & CONSULTANTS, INC..

JDJR ENGINEERS & CONSULTANTS, INC. DOES NOT GUARANTEE THE ACCURACY OR COMPLETENESS OF

# SHEET INDEX

COVERSHEET

PLAT

C1 SITE DIMENSIONAL CONTROL PLAN

C2 DEMOLITION PLAN

C3 GRADING AND DRAINAGE PLAN

C4 OFF-SITE DRAINAGE AREA MAP

C5 STORM DRAIN PLAN

C6 STORM DRAIN PROFILES

C7 STORM DRAIN PROFILES


C8 STORM DRAIN DETAILS

C8A STORM DRAIN DETAILS

C9 EROSION CONTROL PLAN


C9A EROSION CONTROL DETAILS


C10 UTILITY SERVICES PLAN

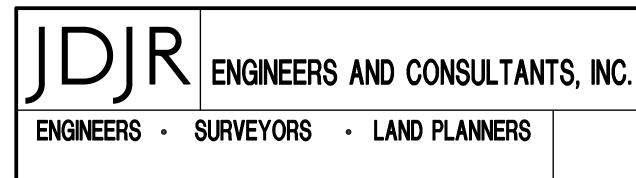


2500 Texas Drive Suite 100 Irving, Texas 75062 Tel 972-252-5357 (JDJR) Fax 972-252-8958


PREPARED FOR:
MSF PROPERTIES
TWO LEGACY TOWN CENTER
6900 N. DALLAS PARKWAY, SUITE 730
PLANO, TEXAS 75024
PHONE: (972) 403-0909
CONTACT: RICHARD FRENCH

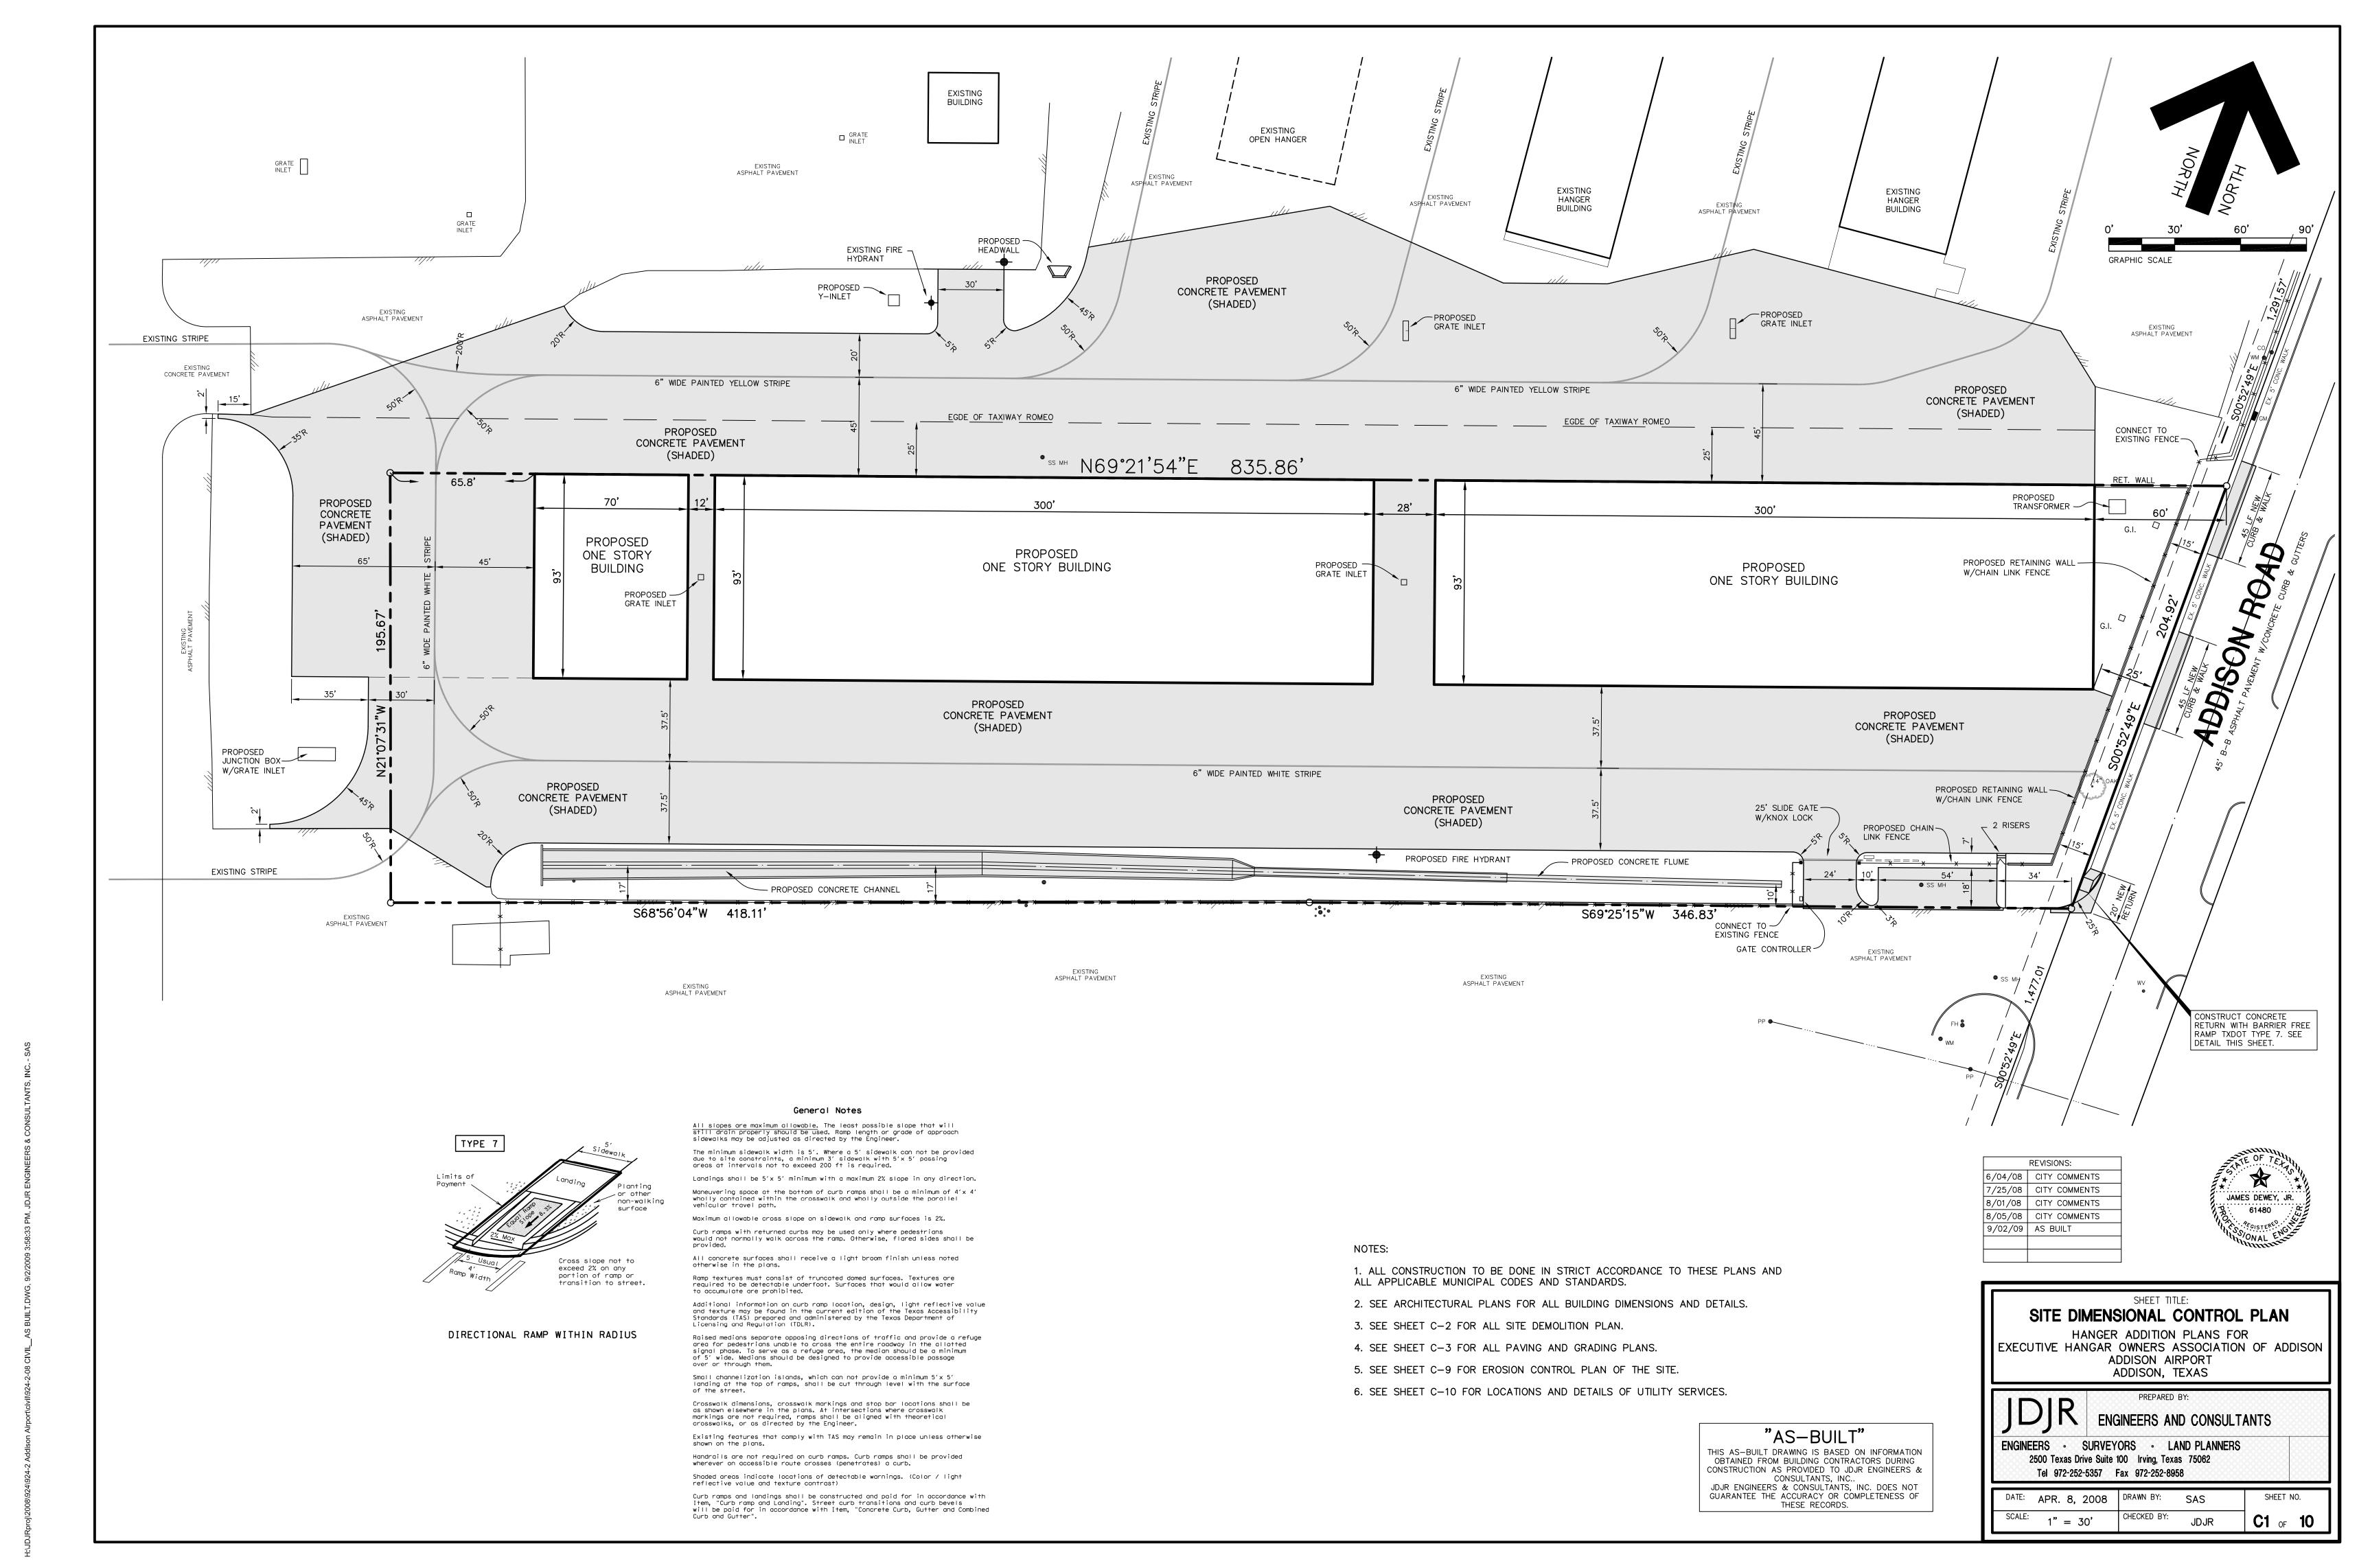


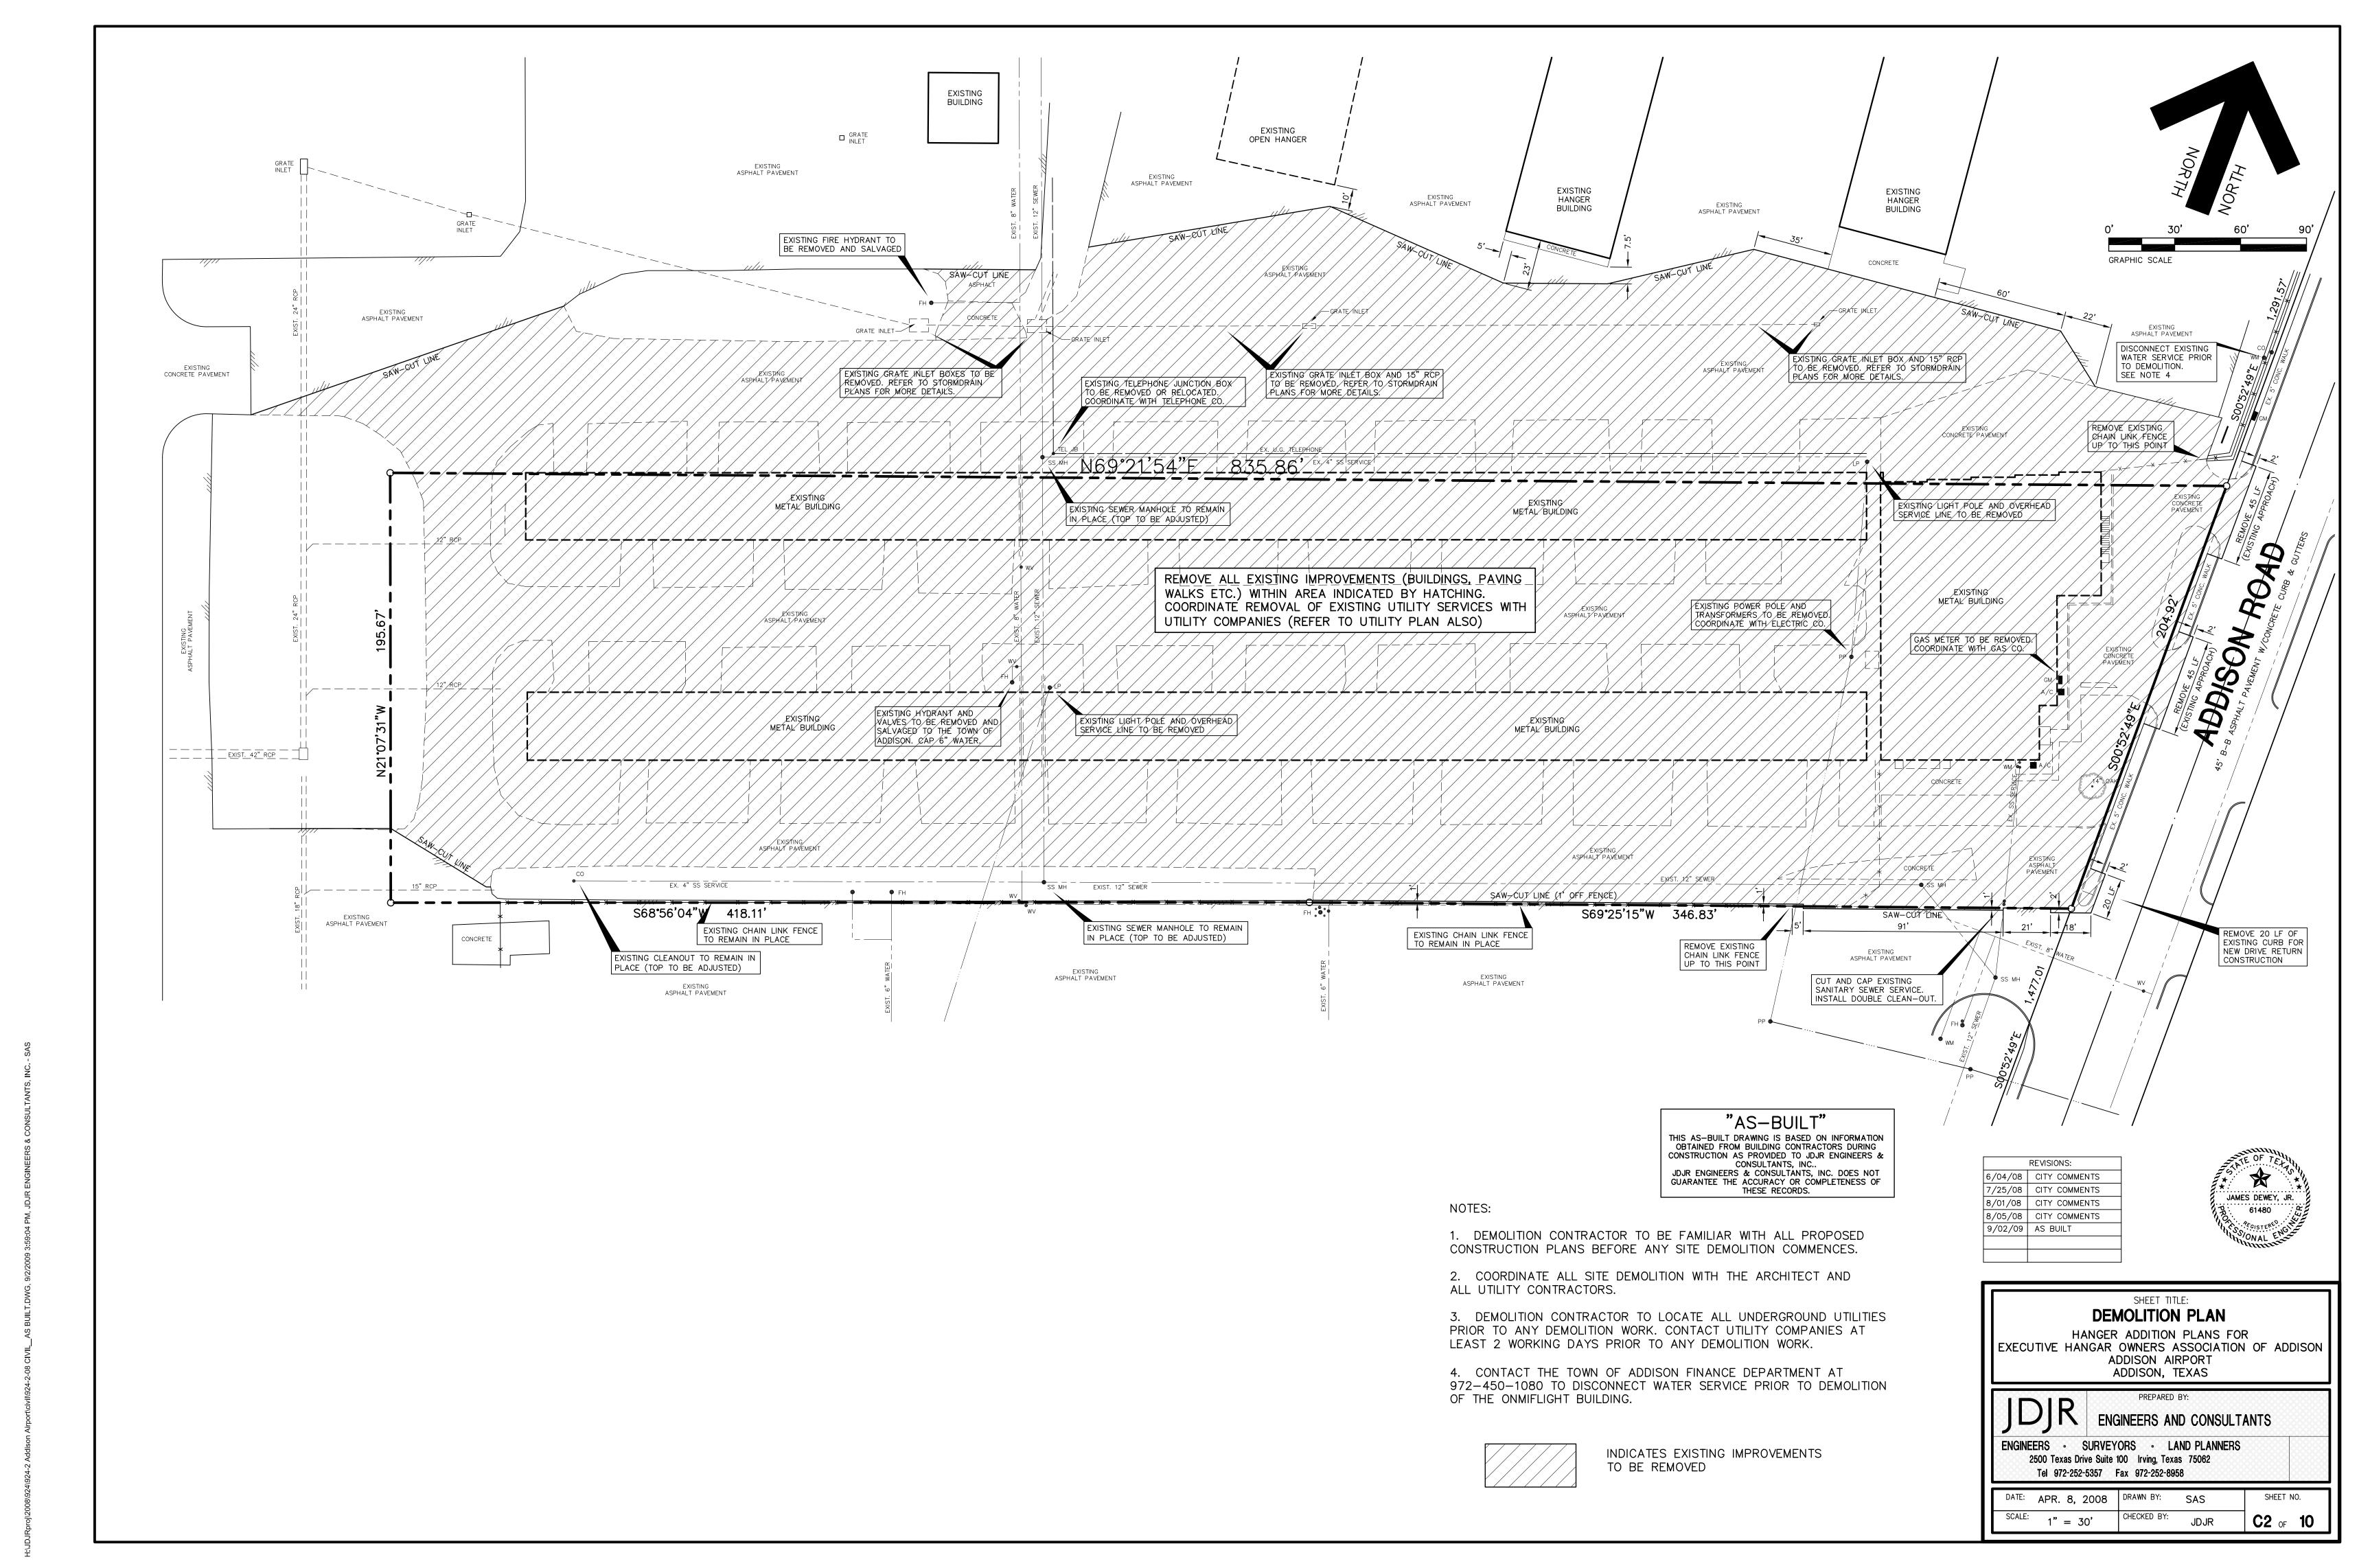

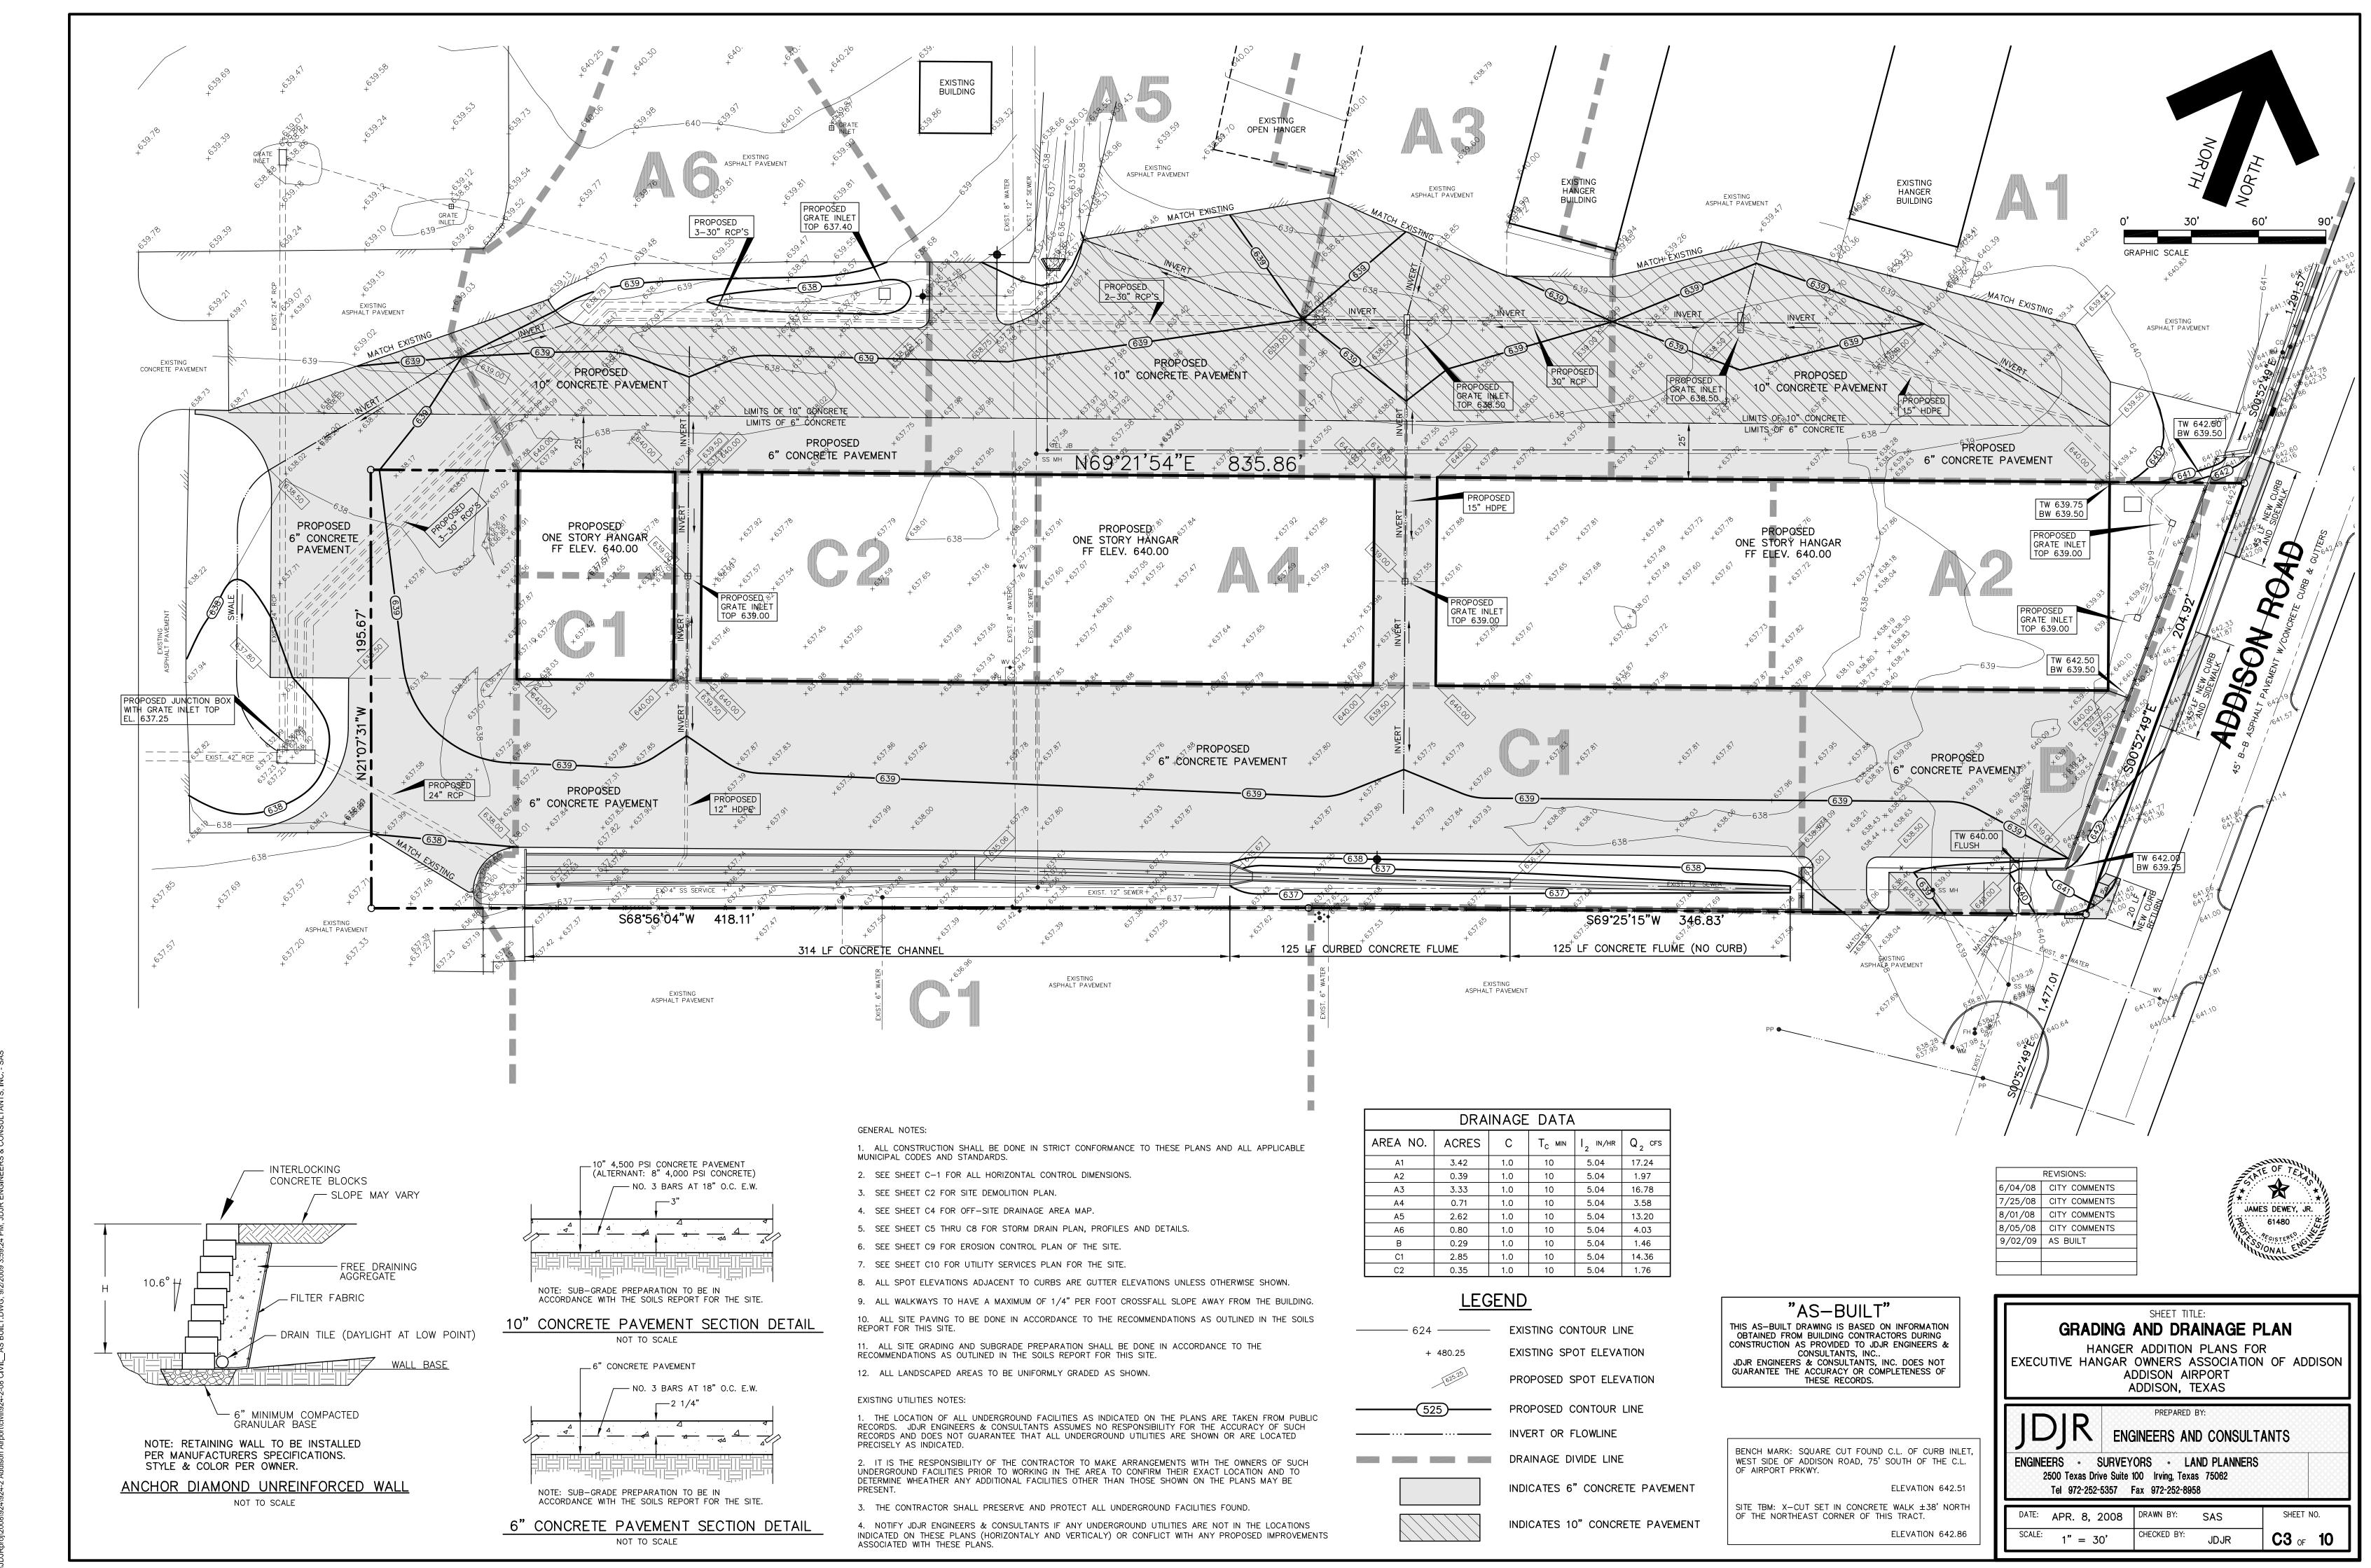


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DRAINAGE DATA							
AREA NO.	ACRES	С	T <sub>C</sub> MIN	I IN/HR	Q <sub>2</sub> cfs		
A1	3.42	1.0	10	5.04	17.24		
A2	0.39	1.0	10	5.04	1.97		
A3	3.33	1.0	10	5.04	16.78		
A4	0.71	1.0	10	5.04	3.58		
A5	2.62	1.0	10	5.04	13.20		
A6	0.80	1.0	10	5.04	4.03		
В	0.29	1.0	10	5.04	1.46		
C1	2.85	1.0	10	5.04	14.36		
C2	0.35	1.0	10	5.04	1.76		

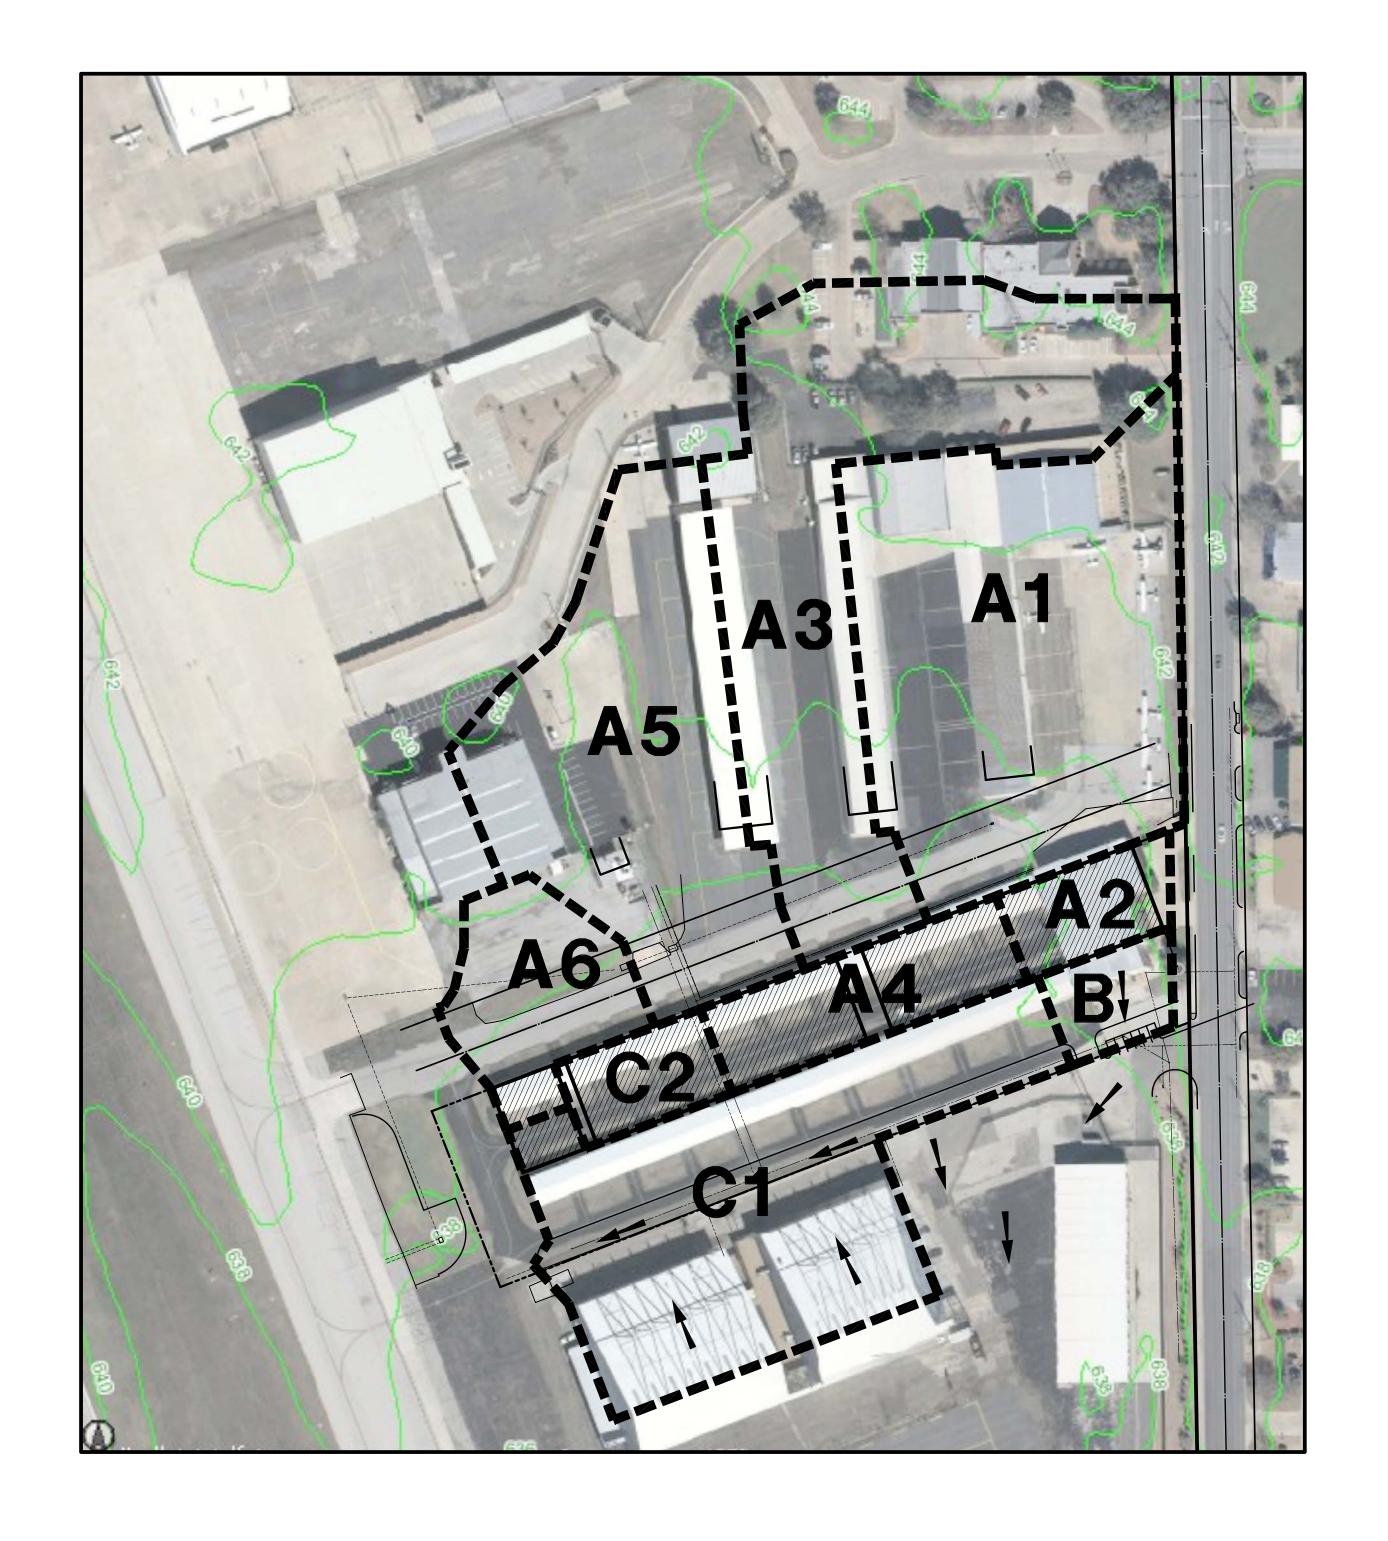	REVISIONS:	
9/02/09	AS BUILT	

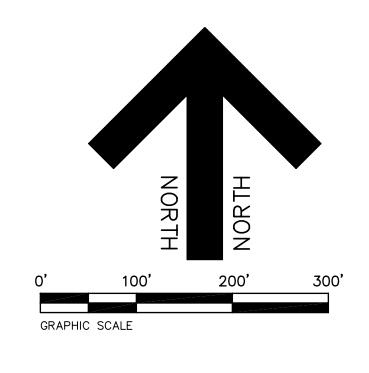

OFF-SITE DRAINAGE AREA MAP

HANGER ADDITION PLANS FOR EXECUTIVE HANGAR OWNERS ASSOCIATION OF ADDISON ADDISON AIRPORT ADDISON, TEXAS

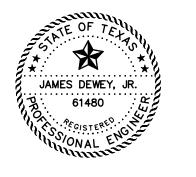PREPARED BY:

STATEMENT OF THE PREPARED BY:

ENGINEERS AND CONSULTANTS

ENGINEERS - SURVEYORS - LAND PLANNERS 2500 Texas Drive Suite 100 Irving, Texas 75062 Tel 972-252-5357 Fax 972-252-8958

DATE: APR. 8, 2008 DRAWN BY: SAS SCALE: 1" = 100'

"AS—BUILT"

THIS AS—BUILT DRAWING IS BASED ON INFORMATION OBTAINED FROM BUILDING CONTRACTORS DURING CONSTRUCTION AS PROVIDED TO JDJR ENGINEERS & CONSULTANTS, INC..


JDJR ENGINEERS & CONSULTANTS, INC. DOES NOT GUARANTEE THE ACCURACY OR COMPLETENESS OF THESE RECORDS.

2. IT IS THE RESPONSIBILITY OF THE CONTRACTOR TO MAKE ARRANGEMENTS WITH THE OWNERS OF SUCH UNDERGROUND FACILITIES PRIOR TO WORKING IN THE AREA TO CONFIRM THEIR EXACT LOCATION AND TO DETERMINE WHEATHER ANY ADDITIONAL FACILITIES OTHER THAN THOSE SHOWN ON THE PLANS MAY BE PRESENT.

3. THE CONTRACTOR SHALL PRESERVE AND PROTECT ALL UNDERGROUND FACILITIES FOUND.

4. NOTIFY JDJR ENGINEERS & CONSULTANTS IF ANY UNDERGROUND UTILITIES ARE NOT IN THE LOCATIONS INDICATED ON THESE PLANS (HORIZONTALY AND VERTICALY) OR CONFLICT WITH ANY PROPOSED IMPROVEMENTS ASSOCIATED WITH THESE PLÁNS.

- 3. SEE SHEET C3 AND C4 FOR GRADING PLAN AND DRAINAGE AREA MAP.
- 4. SEE SHEET C6 AND C7 FOR STORM DRAIN PROFILES.
- 5. SEE SHEET C8 FOR STORM DRAIN DETAILS.
- 6. SEE SHEET C9 FOR EROSION CONTROL PLAN OF THE SITE.
- 7. SEE SHEET C10 FOR UTILITY SERVICES PLAN FOR THE SITE.

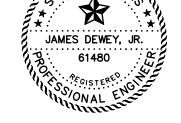

# STORM DRAIN PLAN

HANGER ADDITION PLANS FOR EXECUTIVE HANGAR OWNERS ASSOCIATION OF ADDISON ADDISON AIRPORT ADDISON, TEXAS

CONSTRUCTION AS PROVIDED TO JDJR ENGINEERS &

CONSULTANTS, INC..

JDJR ENGINEERS & CONSULTANTS, INC. DOES NOT GUARANTEE THE ACCURACY OR COMPLETENESS OF

THESE RECORDS.

BENCH MARK: SQUARE CUT FOUND C.L. OF CURB INLET

ELEVATION 642.51

ELEVATION 642.86

WEST SIDE OF ADDISON ROAD, 75' SOUTH OF THE C.L.

SITE TBM: X-CUT SET IN CONCRETE WALK  $\pm 38^{\circ}$  NORTH OF THE NORTHEAST CORNER OF THIS TRACT.

OF AIRPORT PRKWY.

**ENGINEERS AND CONSULTANTS** 

ENGINEERS • SURVEYORS • LAND PLANNERS 2500 Texas Drive Suite 100 Irving, Texas 75062

Tel 972-252-5357 Fax 972-252-8958


DATE: APR. 8, 2008 | DRAWN BY: SAS CHECKED BY: SCALE: 1" = 30'

SHEET NO.

CHECKED BY:


C6 of 10

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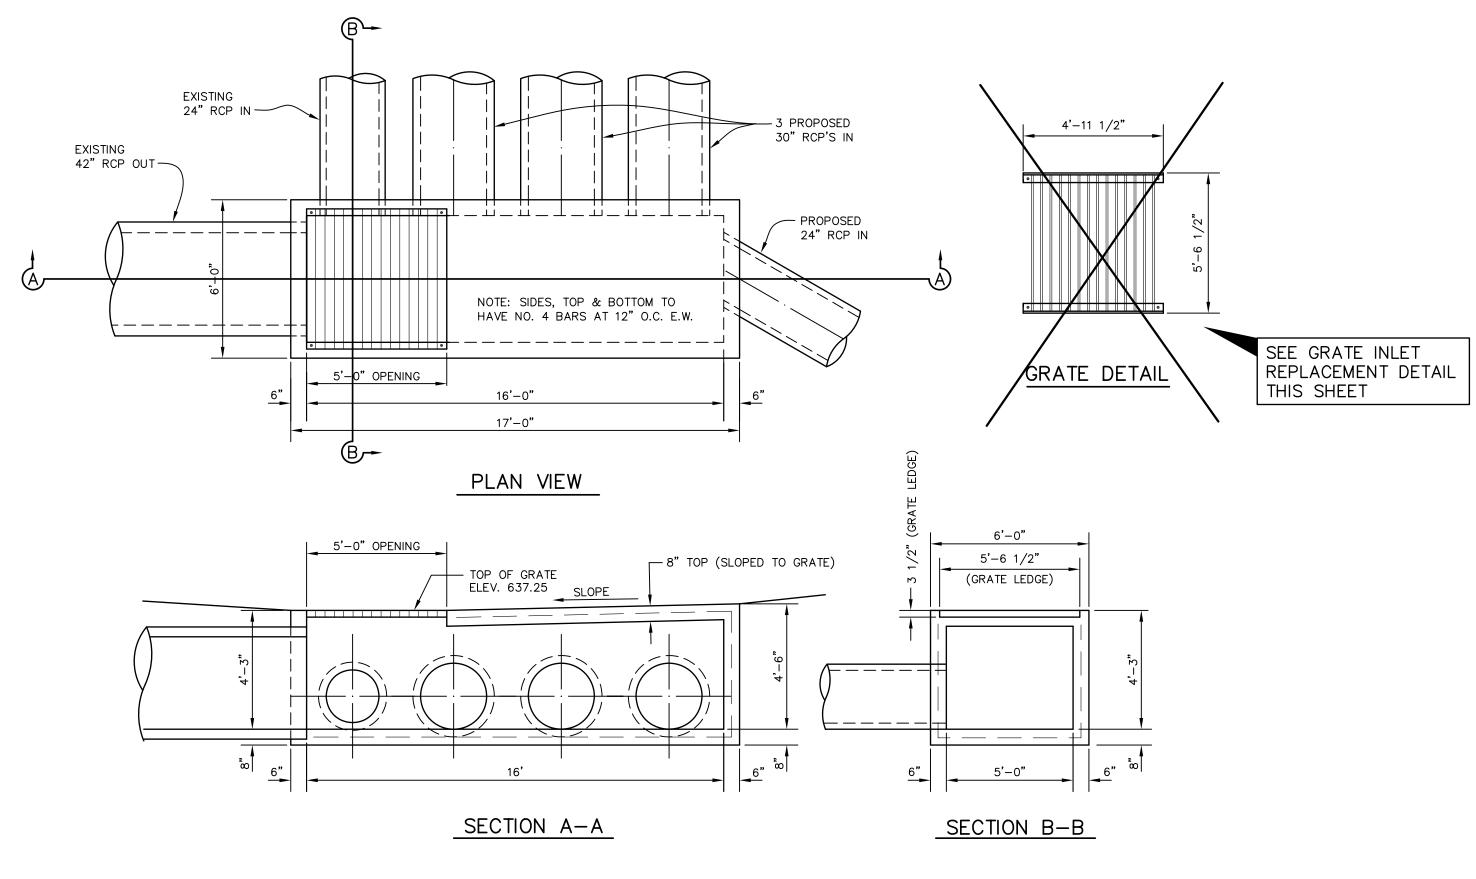
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GRATE INLET REPLACEMENT DETAILS

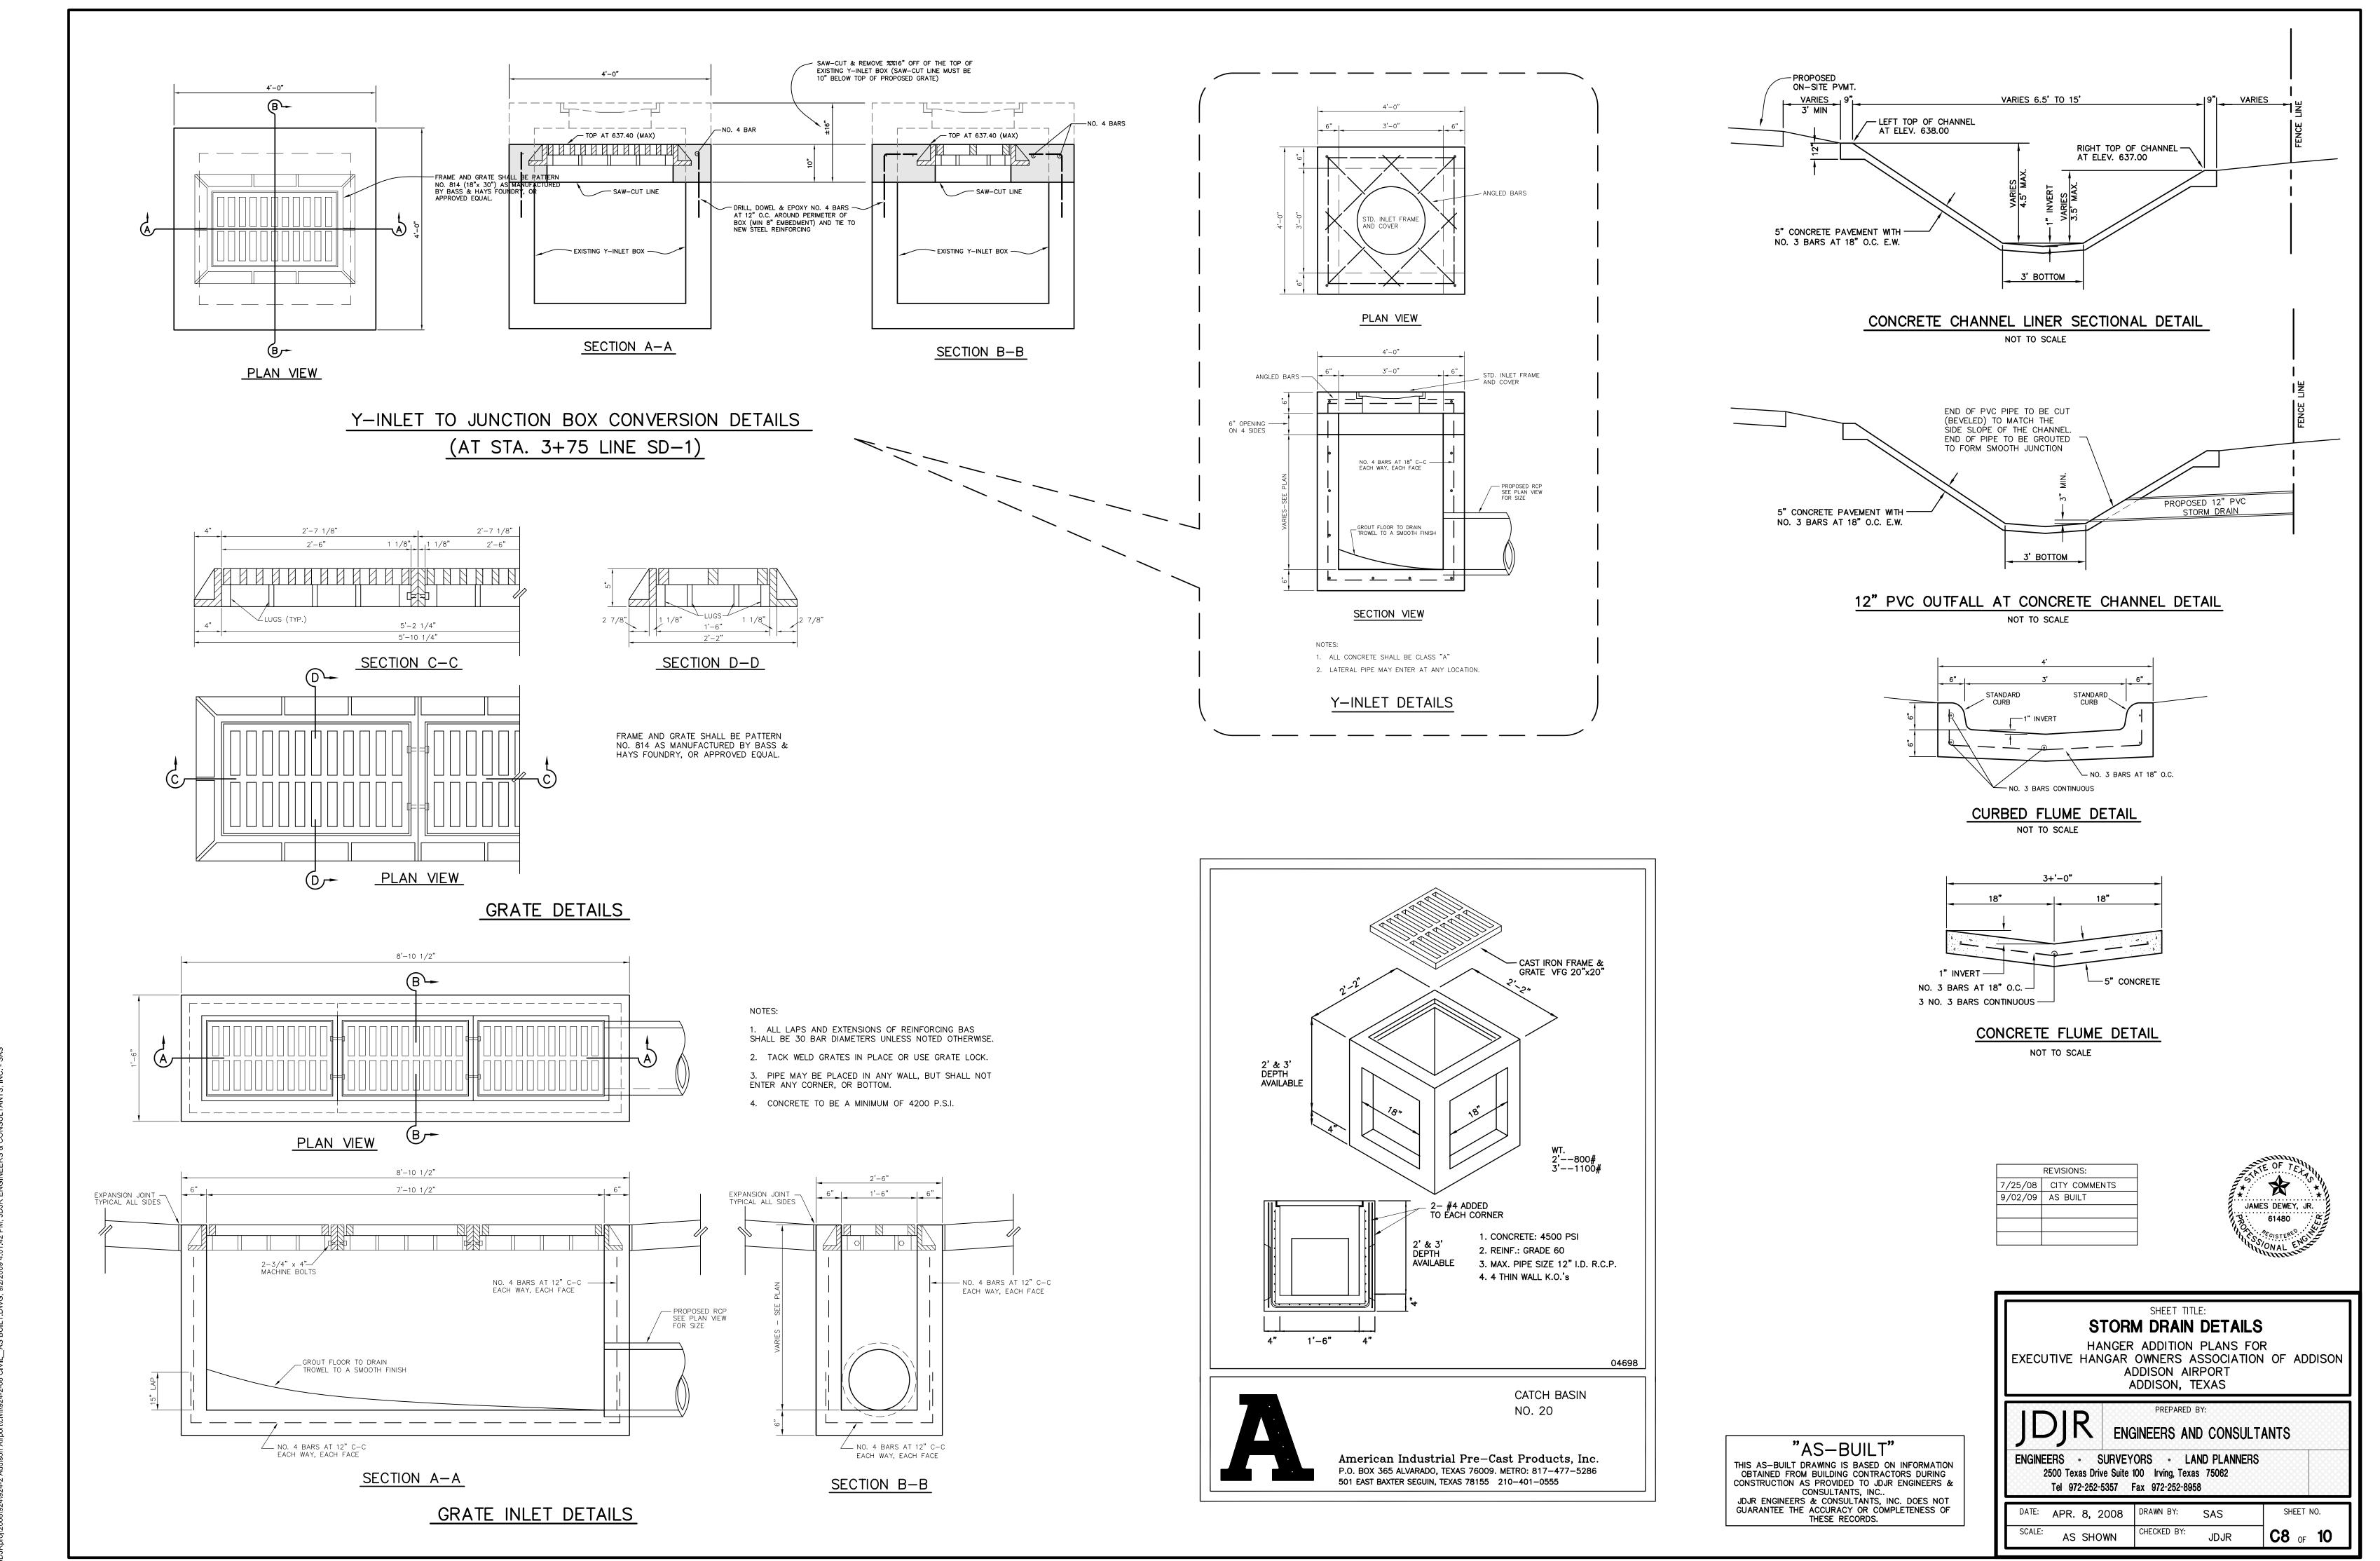
NOT TO SCALE




1. JUNCTION BOX TO BE CONSTRUCTED TO DIMENSIONS SHOWN HERE. REFER TO TXDOT DETAILS FOR GRATE AND ANCHOR DETAILS.

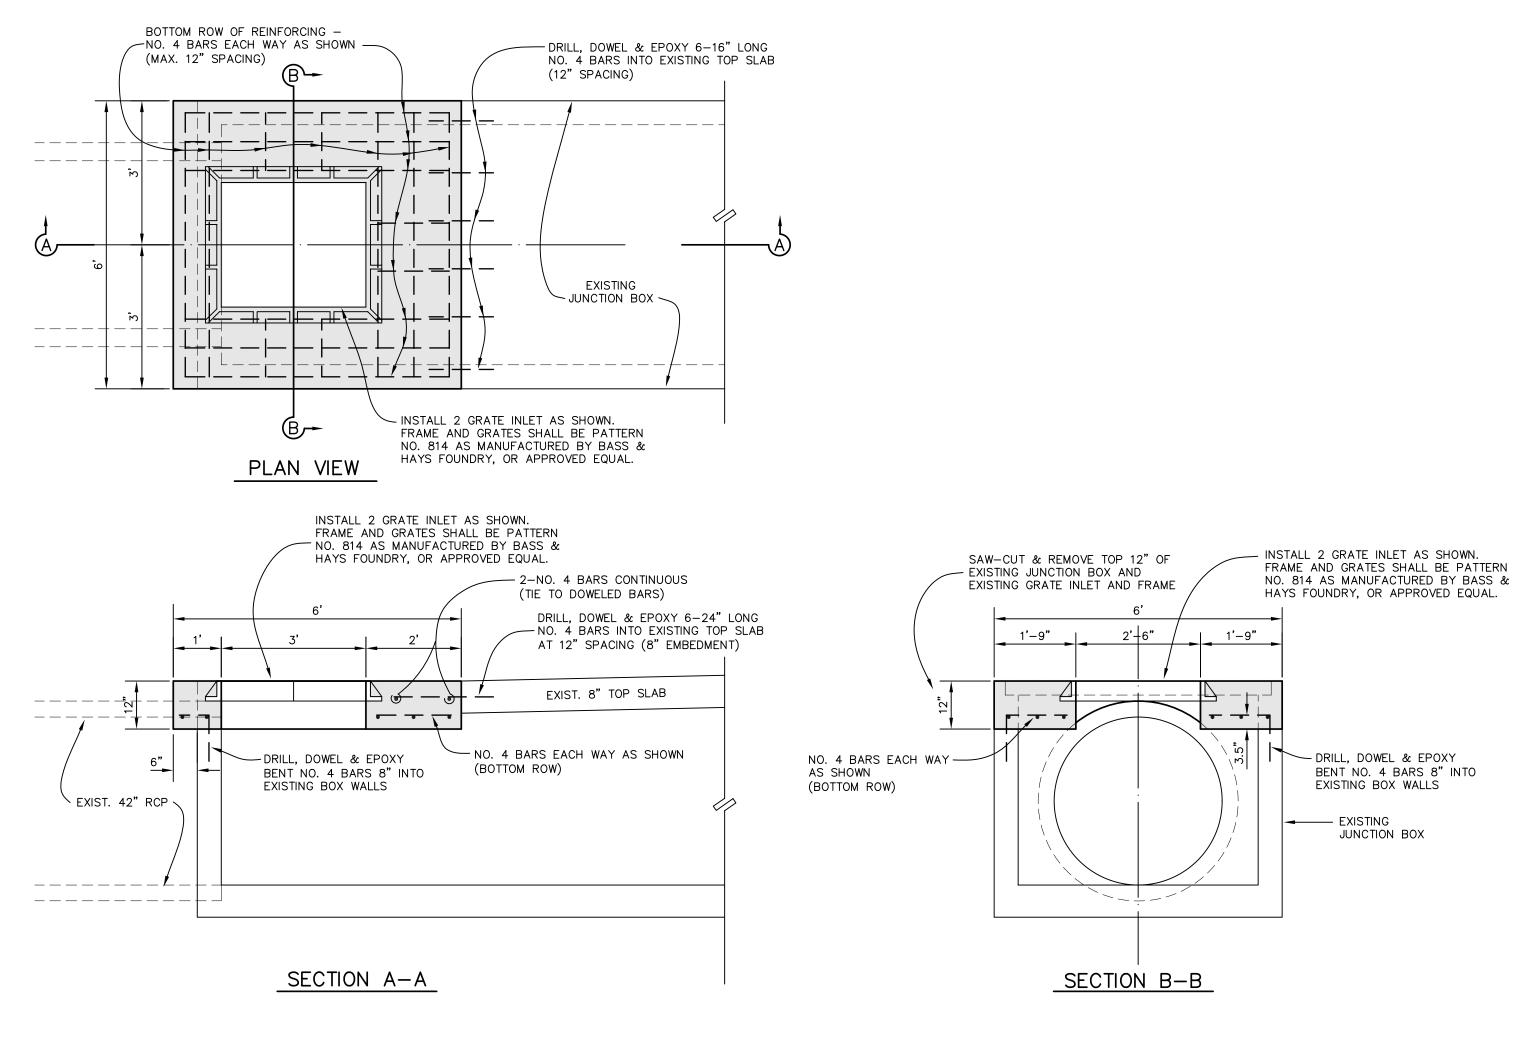2. REINFORCING STEEL IN SIDES, TOP & BOTTOM TO BE NO. 4 BARS AT 12" O.C. E.W.

# JUNCTION BOX DETAIL WITH TYPE H GRATE INLET NOT TO SCALE

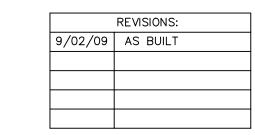

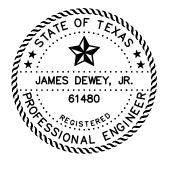

STORM DRAIN DETAILS

HANGER ADDITION PLANS FOR EXECUTIVE HANGAR OWNERS ASSOCIATION OF ADDISON ADDISON AIRPORT ADDISON, TEXAS

**ENGINEERS AND CONSULTANTS** 

ENGINEERS • SURVEYORS • LAND PLANNERS 2500 Texas Drive Suite 100 Irving, Texas 75062 Tel 972-252-5357 Fax 972-252-8958


DATE: APR. 8, 2008 DRAWN BY: SCALE: CHECKED BY:

SHEET NO. C8A of 10 AS SHOWN JDJR

"AS-BUILT" THIS AS-BUILT DRAWING IS BASED ON INFORMATION OBTAINED FROM BUILDING CONTRACTORS DURING CONSTRUCTION AS PROVIDED TO JDJR ENGINEERS & CONSULTANTS, INC..

JDJR ENGINEERS & CONSULTANTS, INC. DOES NOT GUARANTEE THE ACCURACY OR COMPLETENESS OF THESE RECORDS.

INLET IS ESTABLISHED WITH VEGETATION (LAWN).

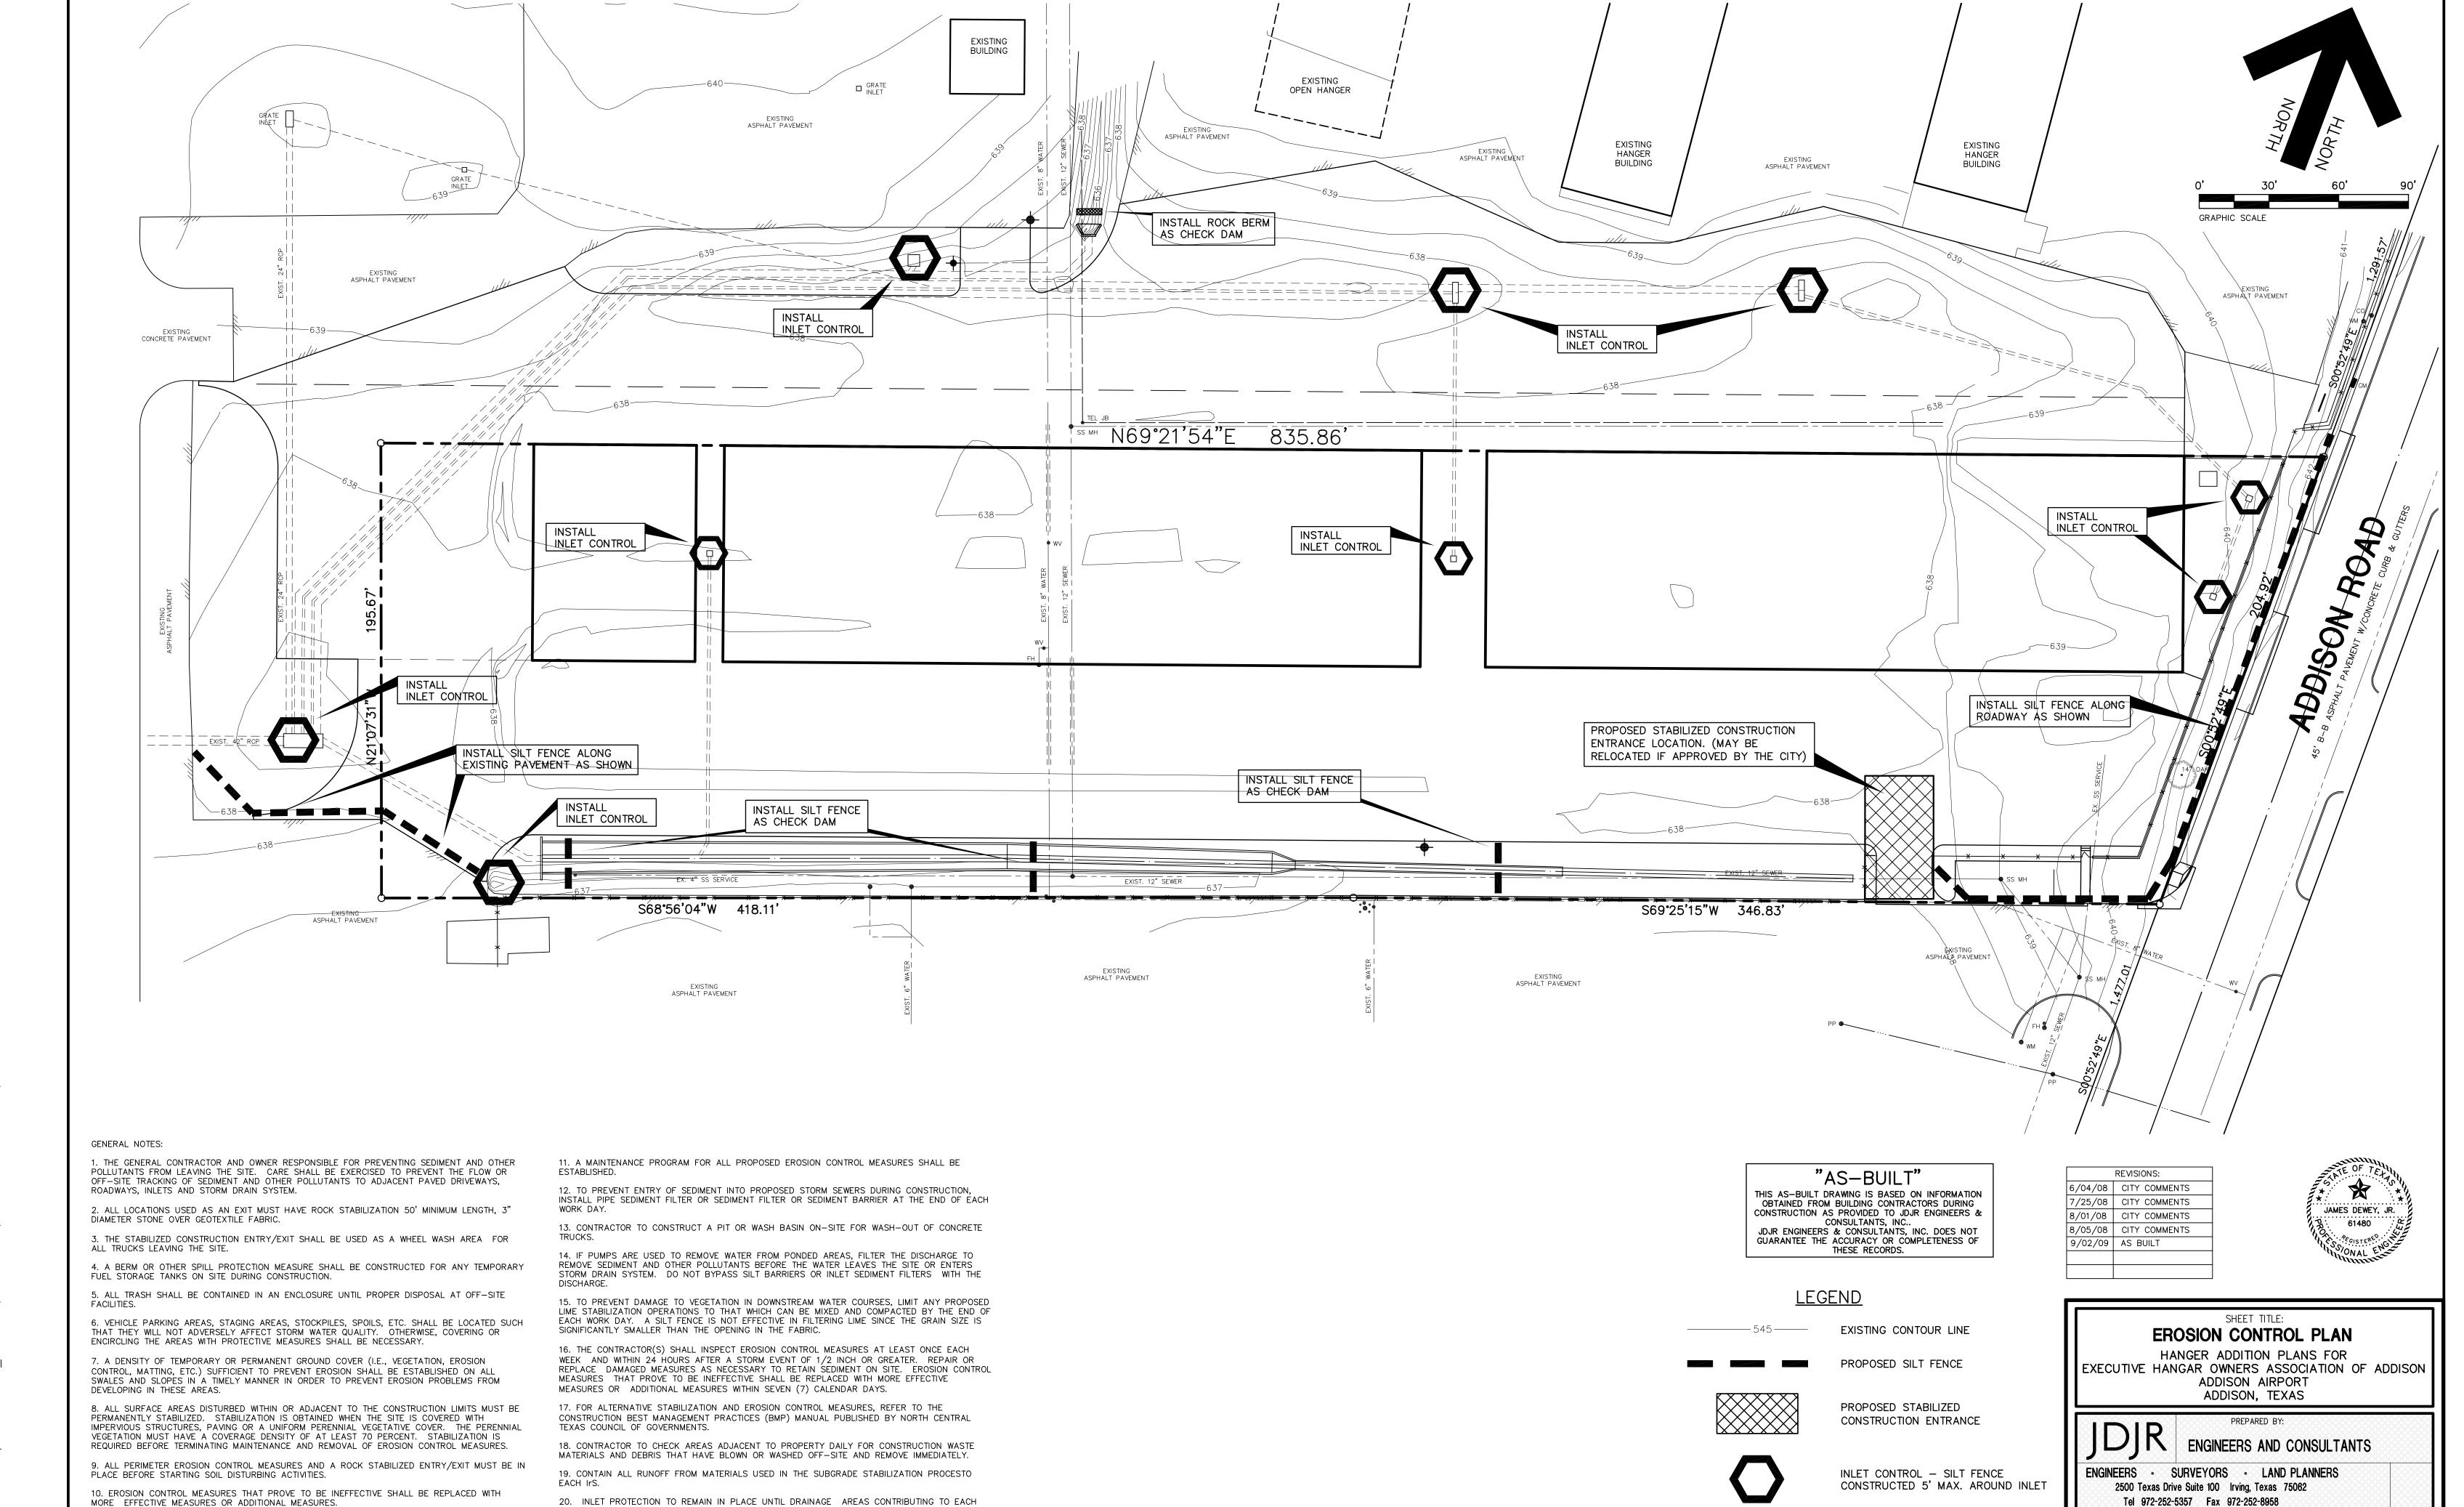

DATE: APR. 8, 2008

1" = 30'

DRAWN BY: SAS

CHECKED BY:

SHEET NO.

C9 of 10

SILT FENCE NOTES:

1. STEEL POSTS WHICH SUPPORT THE SILT FENCE SHALL BE INSTALLED ON A SLIGHT ANGLE TOWARD THE ANTICIPATED RUNOFF SOURCE. POST MUST BE EMBEDDED A MINIMUM OF ONE FOOT.

2. THE TOE OF THE SILT FENCE SHALL BE TRENCHED IN WITH A SPADE OR MECHANICAL TRENCHER, SO THAT THE DOWNSLOPE FACE OF THE TRENCH IS FLAT AND PERPENDICULAR TO THE LINE OF FLOW. WHERE FENCE CANNOT BE TRENCHED IN (e.g. PAVEMENT), WEIGHT FABRIC FLAP WITH WASHED GRAVEL ON UPHILL SIDE TO PREVENT FLOW LINDER FENCE. SIDE TO PREVENT FLOW UNDER FENCE. 3. THE TRENCH MUST BE A MIN. OF 6" DEEP AND 6" WIDE TO ALLOW FOR THE SILT FENCE FABRIC TO BE LAID IN THE GROUND AND BACKFILLED WITH COMPACTED MATERIAL.

4. SILT FENCE SHOULD BE SECURELY FASTENED TO EACH STEEL SUPPORT POST OR WOVEN WIRE, WHICH IS IN TURN ATTACHED TO THE STEEL FENCE POST. THERE SHALL BE A 6" OVERLAP, SECURELY FASTENED WHERE ENDS OF FABRIC MEET.

5. INSPECTION SHALL BE MADE WEEKLY OR AFTER EACH RAINFALL, REPAIR OR REPLACEMENT SHALL BE MADE PROMPTLY AS NEEDED. 6. SILT FENCE SHALL BE REMOVED WHEN THE SITE IS COMPLETELY STABILIZED SO AS NOT TO BLOCK OR

7. ACCUMULATED SILT SHALL BE REMOVED WHEN IT REACHES A DEPTH OF 6". THE SILT SHALL BE DISPOSED OF IN AN APPROVED SITE AND IN SUCH A MANNER AS TO NOT CONTRIBUTE TO ADDITIONAL SILTATION.

GRADE TO PREVENT RUNOFF **EXISTING** FROM LEAVING THE SITE PAVEMENT-FILTER FABRIC—

EXISTING GRADE —

OF INGRESS OR EGRESS.

NOTES:

1. STONE SHALL BE 3 TO 5 INCH DIAMETER CRUSHED ROCK OR ACCEPTABLE CRUSHED PORTLAND CEMENT CONCRETE.

2. LENGTH SHALL BE SHOWN ON PLANS, WITH A MINIMUM LENGTH OF 30 FEET FOR LOTS WHICH ARE LESS THAN 150 FEET FROM THE EDGE OF PAVEMENT. THE MINIMUM DEPTH IN ALL OTHER CASES SHALL BE 50 FEET.


3. THE THICKNESS SHALL NOT BE LESS THAN 6 INCHES. 4. THE WIDTH SHALL BE NO LESS THAN THE FULL WIDTH OF ALL POINTS

5. WHEN NECESSARY, VEHICLES SHALL BE CLEANED TO REMOVE SEDIMENT PRIOR TO ENTRANCE ONTO A PUBLIC ROADWAY. WHEN WASHING IS REQUIRED, IT SHALL BE DONE ON AN AREA STABILIZED WITH CRUSHED STONE WITH DRAINAGE FLOWING AWAY FROM BOTH THE STREET AND THE STABILIZED ENTRANCE. ALL SEDIMENT SHALL BE PREVENTED FROM ENTERING ANY STORM DRAIN, OR WATERCOURSE USING APPROVED METHODS.

6. THE ENTRANCE SHALL BE MAINTAINED IN A CONDITION WHICH WILL PREVENT TRACKING OR FLOWING OF SEDIMENT ONTO PAVED SURFACES. THIS MAY REQUIRE PERIODIC TOP DRESSING WITH ADDITIONAL STONE AS CONDITIONS DEMAND. ALL SEDIMENT SPILLED, DROPPED, WASHED OR TRACKED ONTO PAVED SURFACES, MUST BE REMOVED IMMEDIATELY.

7. THE ENTRANCE MUST BE PROPERLY GRADED OR INCORPORATE A DRAINAGE TO PREVENT RUNOFF FROM LEAVING THE CONSTRUCTION SITE.

STABILIZED CONSTRUCTION ENTRANCE NOT TO SCALE

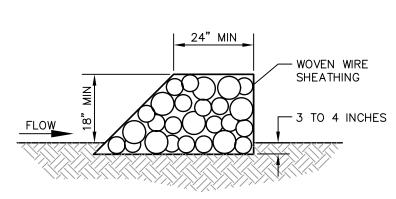

ROCK BERM DETAIL


ROCK BERM NOTES:

1. USE ONLY OPEN GRADED 4-8 INCHES IN DIAMETER FOR STREAM FLOW CONDITIONS. USE OPEN GRADED ROCK 3-5 INCHES IN DIAMETER FOR OTHER CONDITIONS. 2. THE ROCK BERM SHALL BE SECURED WITH A WOVEN WIRE SHEATHING HAVING A MAXIMUM OPENING OF 1 INCH AND A MINIMUM WIRE SIZE OF 20 GUAGE AND SHALL BE BURIED IN A TRENCH APPROXIMATELY 3 TO 4 INCHES DEEP. 3. THE ROCK BERM SHALL BE INSPECTED EVERY TWO WEEKS OR AFTER EACH 1/2" RAIN EVENT AND SHALL BE REPLACED WHEN THE STRUCTURE CEASES TO FUNCTION AS INTENDED DUE TO SILT ACCUMULATION AMONG THE ROCKS, WASHOUT, CONSTRUCTION TRAFFIC DAMAGE, ETC. 4. WHEN SILT REACHES A DEPTH EQUAL TO ONE—THIRD OF THE HEIGHT OF THE BERM OR ONE FOOT, WHICHEVER IS LESS, THE SILT SHALL BE REMOVED AND DISPOSED OF

5. WHEN THE SITE IS COMPLETELY STABILIZED, THE BERM AND ACCUMULATED SILT SHALL BE REMOVED AND DISPOSED OF IN AN APPROVED MANNER.

6. ROCK BERM SHOULD BE USED AS CHECK DAMS FOR CONCENTRATED FLOW AND ARE NOT INTENDED FOR USE IN PERIMETER PROTECTION.

**REVISIONS:** 6/04/08 CITY COMMENTS 9/02/09 AS BUILT

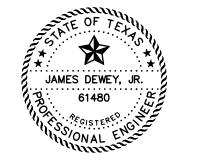

SHEET TITLE:

**EROSION CONTROL DETAILS** 

HANGER ADDITION PLANS FOR EXECUTIVE HANGAR OWNERS ASSOCIATION OF ADDISON ADDISON AIRPORT ADDISON, TEXAS

SCALE:

ENGINEERS AND CONSULTANTS


ENGINEERS • SURVEYORS • LAND PLANNERS 2500 Texas Drive Suite 100 Irving, Texas 75062

Tel 972-252-5357 Fax 972-252-8958 DATE: APR. 8, 2008 DRAWN BY: SAS

CHECKED BY: AS SHOWN

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JDJR ENGINEERS & CONSULTANTS, INC. DOES NOT GUARANTEE THE ACCURACY OR COMPLETENESS OF THESE RECORDS.

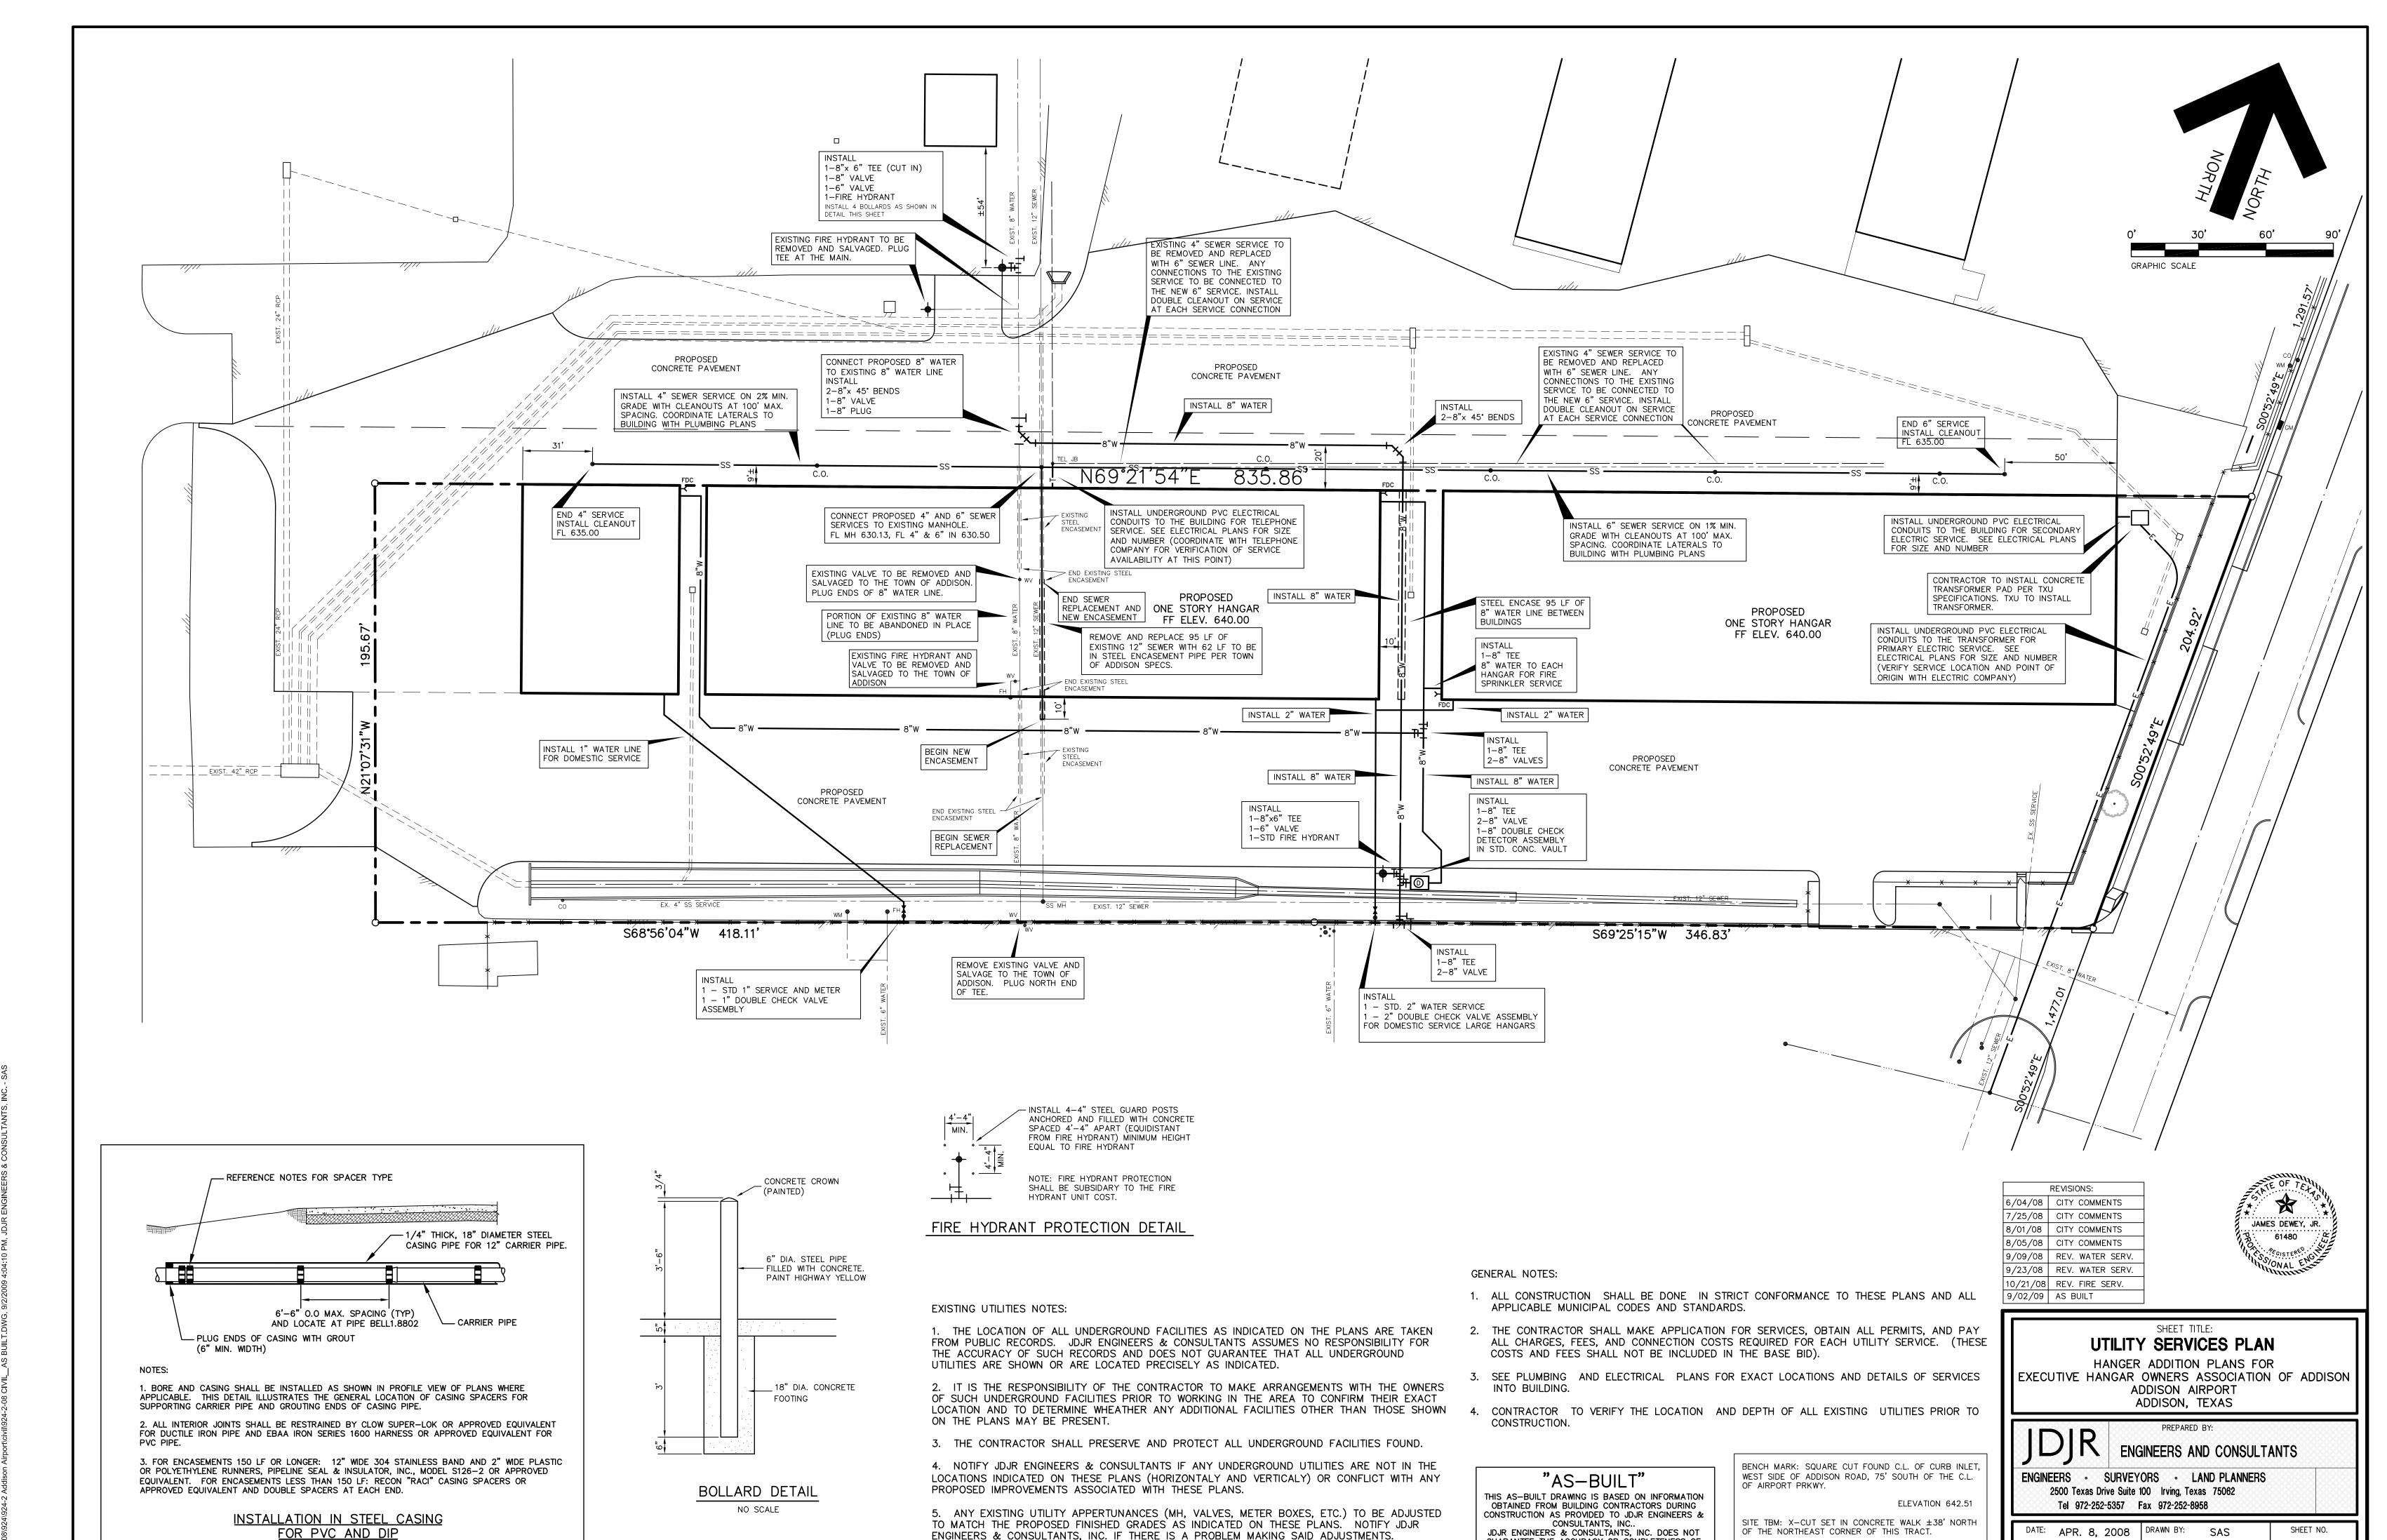

ENGINEERS & CONSULTANTS, INC. IF THERE IS A PROBLEM MAKING SAID ADJUSTMENTS.

GUARANTEE THE ACCURACY OR COMPLETENESS OF

THESE RECORDS.


ELEVATION 642.86

SCALE:

1" = 30'

CHECKED BY:

C10 of 10

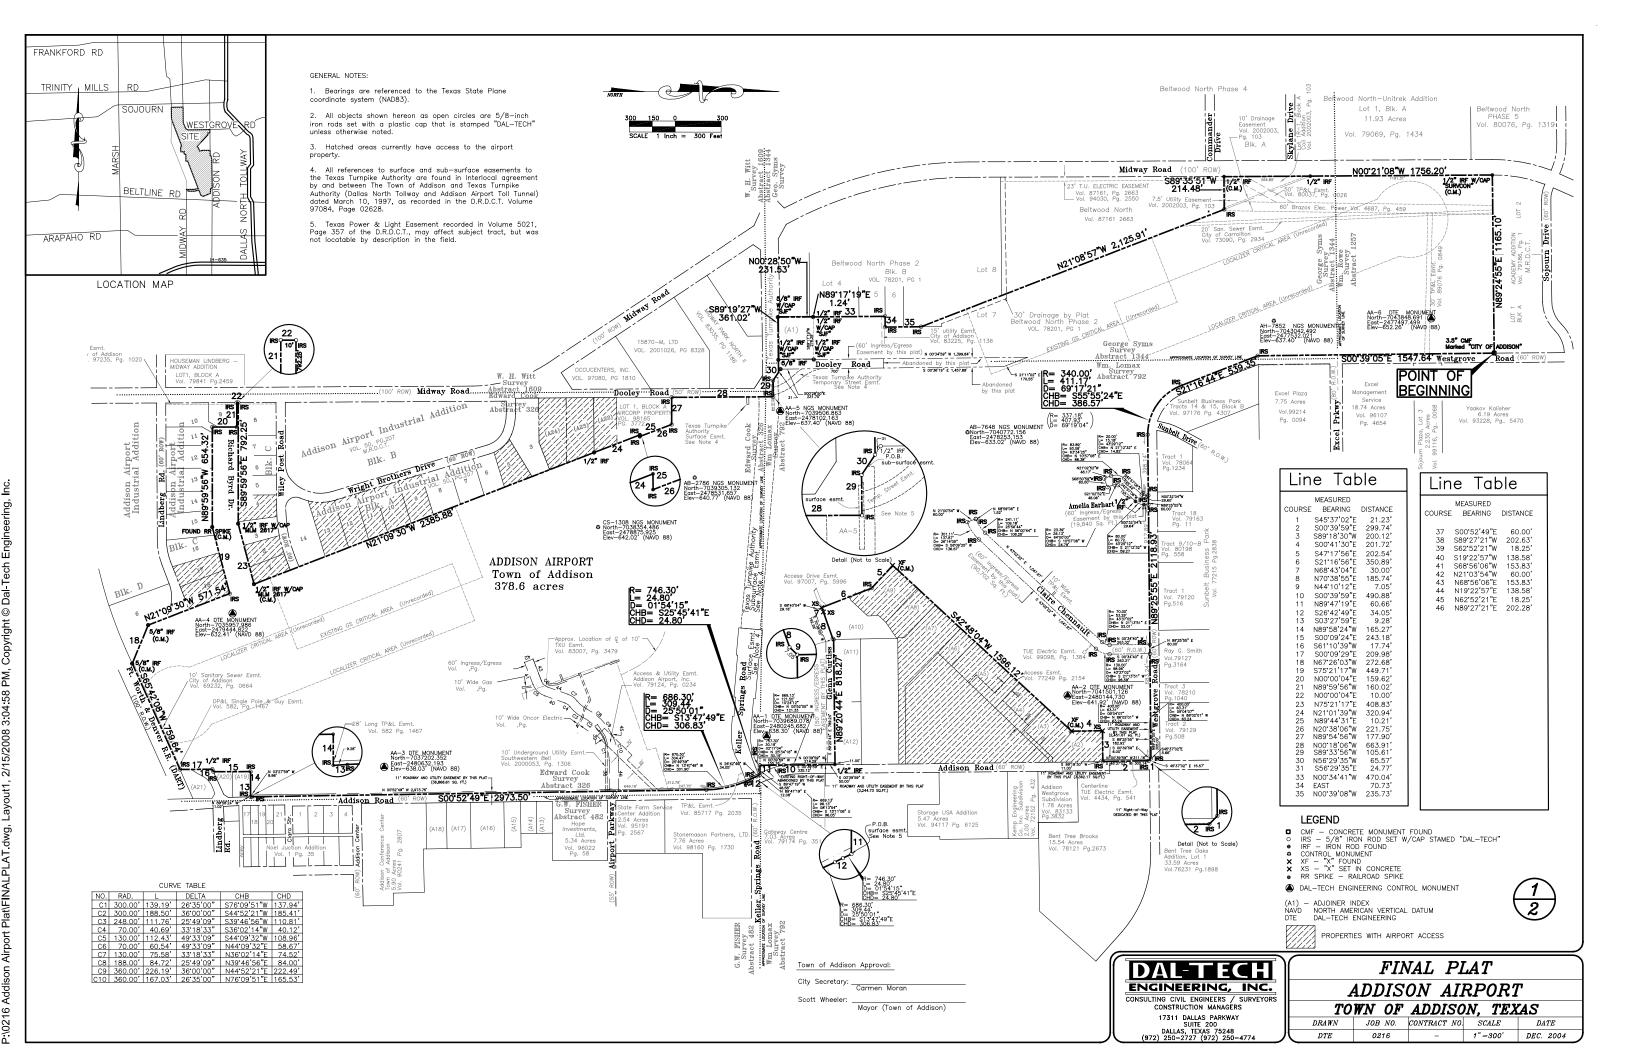

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A2	Texas Federal Subdivision, No.2	79039	133
A3	Blakely Airport Addition	84088	4359
A4	Van-Hoff Subdivision	79122	1831
A5	Aweco Subdivision	79136	2610
A6	Replat Aweco Subdivision	97093	2846
A7	Personal Way Aviation Addison	90241	2840
A8	Hangin' Out L.L.C	98245	3525
A9	Airport Land Development Subdivision	79078	1702
A10	1.950-acre Wolfe Subdivision	84108	3030
A11	Airport Plaza	85070	2982
A12	Addison Storage Addition	99018	78
A13	Eleanor W. Dedmon Marital Trust No. 1	98004	3173
A14	Tom J. Shepherd et ux Sandra D. Shepherd	92229	4451
A15	Crossroads Aviation Inc.	67044	213
A16	D.A. Cody	71165	2799
A17	Barco Mirror & Glass	79020	875
A18	General Public	83083	1059
A19	Town of Addison	97247	4072
A20	White Rock Masonic Lodge #234	3981	416
A21	George P. Kondos and Čarol C. Kondos	91084	2102
A22	15800 Dooley Road Ltd.	2000039	4255
A23	John-Mac Joint Venture	82001	4089
A24	Midway Road Condo's.	81115	0016

# Control Monument

(NAD 83, TEX	AS NORTH CENT	RAL - 4202	2)
North	East	Elevation	Desc.
7039689.078	2480245.682	638.30	AA-1
7041501.126	2480144.730	641.92	AA-2
7037202.352	2480632.193	638.03	AA-3
7035957.986	2479444.822	632.41	AA-4
7039506.863	2478102.163	637.40	AA-5
7043849.691	2477497.499	652.26	AA-6
7039305.132	2478531.657	640.77	AB2786
7040772.156	2478253.153	633.02	AB7648
7043042.492	2477532.021	637.40	AH7852
7038354.486	2478875.925	642.02	CS1308

## Parent Iracts

Conner: City of Addison
Address: 15333 Addison Road City of Addison, Texas
Legal Description: Being all the certain tract of land 373.332 acres, more or
less, out of the Edward Cook Survey Abstract 326, the William Lomar Survey
Abstract 792, the George Syms Survey Abstract 1344, the William Rowe Survey
Abstract 1257, Lot 1R-1, Block A of Coil Addition, Vol. 2002003, Pg. 130,
Dallas County, Texas, and part of Lot 1 and Lot 2 of Block "A" of The Carroll
Estates Addition, Volume 10 Page 473, Dallas County, Texas

Grantor: Ray V. Ki Grantor: Ray V. Kincaid, Jr. Grantee: Town of Addison

Grantee: City of Addison WD Vol.77010 Pg. 1391

Grantor: W. H. Laffity Grantee: City of Addison Judgment Cause# 80-1894-D Vol.91079 Pg.2687

Grantor: Beltwood North Joint Venture, et al

Grantor: Bob Chester and William F. Chester

Grantee: City of Addison Vol.98015 Pg.2143 Re: Chester Addition Vol.84216 Pg.3066

Grantor: Protecta—Cab, Inc. Grantee: Town of Addison Vol.97217 Pg.1350

Grantor : Charles Cayce, Independent Executor of the Estate of William L. Gray and Independent Executor of the Estate of Kathy L. Gray Crontee: Town of Addison, Texas Vol. 2003105, Pg. 11725

Re: Lot 1R-1, Block A, Coil Addition, Vol. 2002003, Pg. 103

Vol. 2003105 Pg. 1991

Re: 1/4th Interest

Vol. 2003105, Pg. 11725

Grantor: Annie Ruth Harg Crontee: City of Addison Vol. 2002003, Pg. 103

Vol. 2003105 Pg. 1991

Re: 1/4th Interest

Vol. 2003105 Pg. 1993

Vol. 2003105 Pg. 1991

Grantor: North Texas Tollway Authority Grantee: Town of Addison Vol. 2002150, Pg. 10404

That the TOWN OF ADDISON ("Owner") does hereby adopt this plat designating the hereinabove property as ADDISON AIRPORT ADDITION, on addition to the Town of Addison, Texas, and, subject to the conditions, restrictions and reserval stated hereinafter, owner dedicates to the public use forever the streets and alleys shown thereon.

Vol.99155 Pg.2291 Re: Kincaid Addition Vol.84087 Pg.0048

Grantor: George Marko, Trustee, et al

Grantor: Bobbie L. Odom, et al Grantee: City of Addison Vol.81150 Pg.1985 Re: 1/4th Interest

Grantor: Donnell Jones, et al Grantee: City of Addison Vol.81150 Pg.1993

Re: 1/4th Interest

Re: 1/4th Interest

Grantor: Annie Ruth Harge, et al

Grantor: Oswald Coleman, et al

Grantee: City of Addison Vol.81150 Pg.1989

Grantee: Town of Addison Vol.99249 Pg.5436 Re; Mullins Addition Vol.85157 Pg.4674 and Barnett Addition Vol.85160 Pg.1680

Grantee: Town of Addison Vol.99078 Pg.1254 Re: a portion of Aircorp Property Addition Vol.98165 Pg.3772

Grantor: Billy Joe Mullins, Jr.

The easements shown on this plat are hereby reserved for the purposes as indicated, including, but not limited to, the installation and maintenance of work, sanitary sever, storm sever, droinage, electric, telephone, gos and cable television. Owner shall have the right to use these easements, provided however, that it does not unreasonably interfere or impede with the provision of the services to others. Said utility easements are hereby being reserved by mutual use and accommodation of all public utilities using or desiring to use the same. An express easement of ingress and egress is hereby expressly granted on, over and across all such easements for the benefit of the provider of services for which easements are granted.

easements are 'granted.

Any drainage and floodway easement shown hereon is hereby dedicated to the public's use forever, but including the following covenants with regards to maintenance responsibilities. The existing channels or creeks traversing the drainage and floodway easement will remain as an open channel, unless required to be enclosed by ordinance, at all times and shall be maintained by the individual owners of the lot or lots that are traversed by or adjacent to the drainage and floodway easement. The City will not be responsible for the maintenance and operation of said creek or creeks or for any damage or injury of private property or person that results from the flow of water along said creek, or for any damage or injury of private property or person that results from the flow of water along said creek, or for any damage or injury of private property or person that results from the flow of water along said creek, or for the control of erosion. No obstruction to the natural flow of water run—off shall be permitted by construction of any type building, fence or any other structure within the drainage and floodway easement. Provided, however, it is understood that in the event it becomes necessary for the City to channelize or consider erecting any type of drainage structure in order to improve the storm drainage, then in such event, the City shall have the right, but not the obligation, to net upon the drainage and floodway easement at any point, or points, with all rights of ingress and egress to investigate, survey, erect, construct or maintain any drainage channels and creeks traversing the drainage and floodway easement adjacent to his property clean and free of debris, silt, growth, vegetation, weaks, rubbish, refuse matter and any substance which would result in unsanitary conditions or obstruct the flow of water, and the City shall have the right of ingress and egress for the purpose of inspection and supervision and maintenance work by the property owner to alleviate any undesirable conditi of each lot shall be shown on the plat

The maintenance or paying of the utility and fire lane easements is the responsibility of the property owner. All public The maintenance or paving of the utility and fire lane easements is the responsibility of the property owner. All public utilities shall at all times have the full right of ingress and egress to and from and upon the said utility easements for the purpose of constructing, reconstructing, inspecting, patrolling, maintaining and adding to or removing all or parts of its respective system without the necessity at any time of procuring the permission of anyone. Any public utility shall have the right of ingress and egress to private property for the purpose of reading meters and any maintenance and service required or ordinarily performed by that utility. Buildings, fences, trees, shrubs or other improvements or growth may be constructed, reconstructed or placed upon, over or across the utility easements as shown; provided, however, that owner shall at its sole cost and expense be responsible under any and all circumstances for the maintenance and repair of such improvements or growth, any public utility shall have the right to remove and keep removed all or parts of any buildings, fences, trees, shrubs or other improvements or growth which in any way endanger or interfere with the construction, maintenance or efficiency of its respective system or service.

Water main and sanitary sewer easements shall also include additional area of working space for construction and maintenance of the systems. Additional easement area is also conveyed for installation and maintenance of manholes, cleanouts, fire hydrants, water service and sewer services from the main to curb or pavement line, and the descriptions of such additional easements herein granted shall be determined by their locations as installed.

This plat is approved subject to all platting ordinances, rules, regulations and resolutions of the Town of Addison. Texa

PROPERTY DESCRIPTION

Being a tract of land out of the E. Cook Survey, Abstract No. 326, the William Lomax Survey, Abstract No. 792, the George Syms Survey, Abstract 1344, and the William Rowe Survey, Abstract 1257, and being all of a tract of land described in deed to the City of Addison recorded in Volume 77010, Page 1391 of the Deed Records of Dalias County, Texas (D.R.D.C.T.), all of a tract of land described in Judgment to the City of Addison recorded in Volume 91079, Page 2687, D.R.D.C.T., LOT, Block B of Beltwood North Addition, Phase II, an Addition to the City of Dalias, Texas, according to the map thereof recorded in Volume 8201, Page 0001, D.R.D.C.T., as drescribed in deed to the City of Addison recorded in Volume 98015, Page 2143, D.R.D.C.T., a tract of land described in deed to the Town of Addison recorded in Volume 98015, Page 2143, D.R.D.C.T., a tract of land described in Volume 97217, Page 1350, D.R.D.C.T., Lot T., Block 1, of Kincaid Addition, an Addition to the City of Addison, Dalias County, Texas, according to the Plat thereof recorded in Volume 84087, Page 48, D.R.D.C.T., a tract of land described in deed to the Town of Addison recorded in Volume 99249, Page 5436, D.R.D.C.T., a tract of land described in deed to Volume 99078, Page 1254, D.R.D.C.T., a tract of land described in Deed to the City of Addison recorded in Volume 99249, Page 15450, D.R.D.C.T., a tract of land described in Deed to the City of Addison recorded in Volume 98015, D.R.D.C.T., and a tract of land described in Deed to the City of Addison recorded in Volume 98015, D.R.D.C.T., and a tract of land described in Deed to the City of Addison recorded in Volume 98015, D.R.D.C.T., and a tract of land described in Deed to the City of Addison recorded in Volume 98015, D.R.D.C.T., and a tract of land described in Deed to the City of Addison recorded in Volume 98016, D.R.D.C.T., and a tract of land described in Deed to the City of Addison recorded in Volume 98016, D.R.D.C.T., and a tract of land described in Deed to the City of Addiso

Beginning at a concrete monument found with a 3 1/2 inch disk stamped "City of Addison" lying in the west right-of-way line of Westgrove Road (a 60 foo wide right-of-way) said point being the most northerly northeast corner of said Addison Airport tract and the southeast corner of Lot 1, Block A, Academy Addition, an addition to the City of Carrollton, Dallas County, Texas according to the Plat thereof recorded in Volume 79186, Page 1, D.R.D.C.T.;

THENCE South 00 degrees 39 minutes 05 seconds East, along the west right-of-way line of said Westgrove Road, a distance of 1547.64 feet to a 5/8 inch iron rod set with cap stamped "DAL-TECH";

THENCE South 21 degrees 16 minutes 44 seconds East, continuing along said west right-of-way line of Westgrove Road, a distance of 539.35 feet to a 5/8 inch iron rod set with cap stamped "DAL-TECH";

THENCE along a curve to the left of said Westgrove Road having a radius of 340,00 feet, a central angle of 69 degrees 17 minutes 21 seconds and an arc length of 411.17 feet, being subtended by a chord of South 55 degrees 55 minutes 24 seconds East for a distance of 386.57 feet to a 5/8 inch iron rod set with cap stamped "DAL-TECH"

THENCE North 89 degrees 25 minutes 55 seconds East, along the southerly right-of-way line of Westgrove Road for a distance of 2.118.93 feet to a 5/8 inch iron rod set with cap stamped "DAL-TECH" at the corner clip of said southerly right-of-way line of Westgrove Road and the west right-of-way line of Addison Road (a 60 foot wide right-of-way) line of Addison Road (a 60 foot wide right-of-way).

THENCE South 45 degrees 37 minutes 02 seconds East, along said corner clip, a distance of 21.23 feet to a 5/8 inch iron rod set with cap stamped "DAL—TECH".

THENCE South 00 degrees 39 minutes 59 seconds East, along said west right—of—way line of Addison Road, a distance of 299.74 feet to a 5/8 inch iron rod set with cap stamped "DAL—TECH";

THENCE South 89 degrees 18 minutes 30 seconds West, departing said west right-of-way line of Addison Road, a distance of 200.12 feet set in concrete;

THENCE South 00 degrees 41 minutes 30 seconds East, a distance of 201.72 feet to a found "X";

THENCE South 42 degrees 48 minutes 04 seconds West, a distance of 1,596.12

THENCE South 47 degrees 17 minutes 56 seconds East, a distance of 202.54 feet to a 5/8 inch iron rod set with cap stamped "DAL—TECH";

THENCE South 21 degrees 16 minutes 56 seconds East, a distance of 350.89 feet to a chiseled "X" set in concrete:

THENCE North 68 degrees 43 minutes 04 seconds East, a distance of 30.00

THENCE North 70 degrees 38 minutes 55 seconds East, a distance of 185.74 feet to a 5/8 inch iron rod set with cap stamped "DAL-TECH":

THENCE North 44 degrees 10 minutes 12 seconds East, a distance of 7.05 feet Inclined North 44 degrees to minutes 12 seconds cases, a disance of 7.05 ret to a 5/8 inch iron rod set with cap stamped "DAL-TECH", said point is the common corner between the aforesaid Addison Airport tract and the southwest corner of a tract of land described in deed to 0.J. Broughton and E.E. Ericson recorded in Volume 4350, Page 491 of D.R.D.C.T.;

THENCE North 89 degrees 20 minutes 44 seconds East, along the common line of said Addison Airport tract and the south line of said 0.J. Broughton tract for a distance of 818.27 feet to a 5/8 inch iron rod set with cap stamped "DAL—TECH" in the west right-of-way line of aforesaid Addison Road;

THENCE South 00 degrees 39 minutes 59 seconds East, a distance of 490.88 feet to a 5/8 inch iron rod set with cap stamped "DAL-TECH" in the apparent common survey line between the aforesaid William Lomax Survey, Abstract No. 792 and the aforesaid E. Cook Survey, Abstract No. 326;

THENCE North 89 degrees 47 minutes 19 seconds East, a distance of 60.66 feet to a 1/2 inch iron rod set with cap stamped "DAL—TECH" in the aforesaid west right-of-way line of Addison Road;

THENCE along a curve to the left in the said west right-of-way line of Addison Road, having a radius of 746.30 feet, a central angle of 01 degree 54 minutes 15 seconds and an arc length of 24.80 feet, being subtended by a chord of South 25 degrees 45 minutes 41 seconds East for a distance of 24.80 feet to a 5/8 inch iron rod set with cap stamped "DAL-TECH";

THENCE South 26 degrees 42 minutes 49 seconds East, along said west right-of-way line of Addison Road, a distance of 34.05 feet to a 5/8 inch iron rod set with cap stamped "DAL-TECH";

THENCE along a curve to the right in the said west right-of-way line of Addison Road having a radius of 686.30 feet, a central angle of 25 degrees 50 minutes 01 second and an arc length of 309.44 feet, being subtended by a chord of South 13 degrees 47 minutes 49 seconds East for a distance of 306.83 feet to a 5/8 inch iron rod set with cap stamped "DAL-TECH";

THENCE South 00 degrees 52 minutes 49 seconds East, along said west right—of—way line of Addison Road, a distance of 2,973.50 feet to a 5/8 inch iron rod set with cap stamped "DAL—TECH";

THENCE South 03 degrees 27 minutes 59 seconds East, along said west right-of-way line of Addison Road, a distance of 9.28 feet to a 5/8 inch iron rod set with cap stamped "DAL-TECH";

THENCE North 89 degrees 58 minutes 24 seconds West departing said west right-of-way line of Addison Road, a distance of 165.27 feet to a 5/8 inch iron rod set with cap stamped "DAL-TECH";

THENCE South 00 degrees 09 minutes 24 seconds East, a distance of 243.18 feet to a 5/8 inch iron rod set with cap stamped "DAL-TECH"

THENCE South 61 degrees 10 minutes 39 seconds West, a distance of 17.74 feet to a 1/2 inch iron rod found:

THENCE South 00 degrees 09 minutes 29 seconds East, a distance of 209.98 feet to a 5/8 inch iron rod set with cap stamped "DAL—TECH" in the north right—of—way line of the Fort Worth and Denver Railroad spur;

THENCE South 65 degrees 42 minutes 08 seconds West, glong said north ight-of-way line of said Forth Worth and Denver Railroad sour, a distance of right—oft—way line of Sala Fofth worth and between namious span, a discounce of 59.6 inch iron rod found at the most easterly corner of the Addison Airport Industrial District, an Addition to the City of Addison according the plat thereof recorded in Volume 50, Page 207, D.R.D.C.T.;

THENCE North 67 degrees 26 minutes 03 seconds West, along the said easterly line of Addison Airport Industrial District addition, a distance of 272.68 feet to a

THENCE North 21 degrees 09 minutes 30 seconds West, along the said easterly line of Addison Airport Industrial District addition, a distance of 571.54 feet to a 5/8 inch iron rod set with cap stamped "DAL—TECH";

THENCE South 75 degrees 21 minutes 17 seconds West, a distance of 449.71 feet to a found railroad spike:

THENCE North 89 degrees 59 minutes 56 seconds West, a distance of 654.32 feet to a 5/8 inch iron rod set with cap stamped "DAL-TECH";

THENCE North 00 degrees 00 minutes 04 seconds East, a distance of 159.62 feet to a 5/8 inch iron rod set with cap stamped "DAL—TECH";

feet to a 5/8 inch iron rod set with cap stamped "DAL—TECH" in the east right—of—way line of Midway Road (a 100 foot wide right—of—way);

THENCE North 00 degrees 00 minutes 04 seconds East, along said east ight-of-way line of Midway Road, a distance of 10.00 feet to a 5/8 inch iron od set with cap stamped "DAL-TECH";

THENCE South 89 degrees 59 minutes 56 seconds East, a distance of 792.25 feet to a 1/2 inch iron rod found with cap stamped "MLM #2617;

THENCE North 75 degrees 21 minutes 17 seconds East, a distance of 408.83 feet to a 1/2 inch iron rod found with cap stamped "MLM #2617;

THENCE North 21 degrees 09 minutes 30 seconds West, along the aforesaid 2.385.88 feet record to a 1/2 inch iron rod found;

THENCE North 21 degrees 01 minute 39 seconds West, a distance of 320.94 feet to a 5/8 inch iron rod set with cap stamped "DAL-TECH"

THENCE North 89 degrees 44 minutes 31 seconds East, a distance of 10.21 feet to a 5/8 inch iron rod set with cap stamped "DAL-TECH"

THENCE North 20 degrees 38 minutes 06 seconds West, a distance of 221.75 feet to a 5/8 inch iron rod set with cap stamped "DAL-TECH";

THENCE North 89 degrees 54 minutes 56 seconds West, a distance of 177.90 feet to a 5/8 inch iron rod set with cap stamped "DAL—TECH" in the east right—of—way line of Dooley Road (a 50 foot wide right—of—way)

THENCE North 00 degrees 18 minutes 06 seconds West, along the said east right—of—way line of Dooley Road, a distance of 663.91 feet to a 5/8 inch iron rod set with cap stamped "DAL—TECH" for the apparent intersection of said east right—of-way line of Dooley Road and the north right—of-way line of the old Keller Springs Road (a 50 foot wide right—of-way);

THENCE South 89 degrees 33 minutes 56 seconds West, with the said north line of Keller Springs Road, a distance of 105.61 feet to a 5/8 inch iron rod se with cap stamped "DAL-TECH";

THENCE North 56 degrees 29 minutes 35 seconds West, a distance of 65.57 feet to a 5/8 inch iron rod set with cap stamped "DAL—TECH" in the aforesaid east right—of—way line of Dooley Road (a 60 foot wide right—of—way);

THENCE South 89 degrees 19 minutes 27 seconds West, a distance of 361.02

THENCE North 00 degrees 28 minutes 50 seconds West, a distance of 231.53 feet to a 1/2 inch iron rod found;

THENCE North 89 degrees 17 minutes 19 seconds East, a distance of 1.24 feet to a 1/2 inch iron rod found with cap stamped SJ&F

THENCE North 00 degrees 34 minutes 41 seconds West, a distance of 470.04 feet to a 5/8 inch iron rod set with cap stamped "DAL—TECH" in the east line of Beltwood North Phase 2, an addition to the City of Dallas, Texas, according to the Plat thereof recorded in Volume 78201, Page 1, D.R.D.C.T.;

THENCE East, a distance of 70.73 feet along said Beltwood North Phase 2addition to a 5/8 inch iron rod set with cap stamped "DAL-TECH"

THENCE North 00 degrees 39 minutes 08 seconds West, along said Beltwood North Phase 2 addition, a distance of 235.73 feet to a 5/8 inch iron rod set with ap stamped "DAL-TECH" for the most southerly corner of Lot 7 of said Beltwood North Phase 2 addition;

THENCE North 21 degrees 08 minutes 57 seconds West, passing the north line of said Beltwood North Phase 2 addition at a called distance of 576.04 feet of said Beltwood North Phase 2 addition at a called distance of 5.76.04 feet and continuing on for a total distance of 2,125.91 feet to a 5/8 inch iron rod set with cap stamped "DAL—TECH" for the northeast corner of Beltwood North Addition, according to the plat thereof recorded in Volume 78201, Page 1, D.R.D.C.T., same being the southeast corner of Lot 1R-1, Block A, Coil Addition, according to the plat thereof recorded in Volume 2002003, Page 103, D.R.D.C.T.;

THENCE South 89 degrees 35 minutes 51 seconds West, along the common line between the north line of said Beltwood Addition and the south line of said Coil Addition, a distance of 214.48 feet to a 1/2 inch iron rod found in the east right-of-way line of Midway Road (a 100 foot wide right-of-way);

THENCE North 00 degrees 21 minutes 08 seconds West, along said east right-of-way line of Midway Road, passing a 1/2 inch iron rod found for the North corner of said Lot 1R-1, Block A, at a distance of 564.89 feet and continuing for a total distance of 1.756.20 feet to a 1/2 inch iron rod found with cap stamped "SURVCON":

THENCE North 89 degrees 24 minutes 55 seconds East, a distance of 1,165.10 feet to the POINT OF BEGINNING and CONTAINING 16,492,399 square foot or; 378.6 acres of land, more or less.

l, Alan Moore, a Registered Professional Land Surveyor in the State of Texas, do herby certify that I prepared this Plat from an actual survey of the land under my supervision in accordance with the "Minimum Standards of Practice" approved by the Texas Board of Professional Land Surveyors.

Alan Moore, RPLS No. 5537



Town of Addison Approval:

City Secretary: \_\_\_\_\_\_Carmen Moran

DAL-TECH ENGINEERING, INC. CONSULTING CIVIL ENGINEERS / SURVEYORS CONSTRUCTION MANAGERS

17311 DALLAS PARKWAY SUITE 200 DALLAS, TEXAS 75248 (972) 250-2727 (972) 250-4774

ADDISON AIRPORT TOWN OF ADDISON, TEXAS DRAWN JOB NO. CONTRACT NO. SCALE DATE DTE 0216 - 1"=300' DEC. 2004

FINAL PLAT