
# CONSTRUCTION PLANS

# WESTFIELD COURT

# TOWN OF ADDISON, TEXAS

### GENERAL NOTES

- A. Prior to final acceptance by the Town of Addison.
  - 1) A Texas Registered Professional engineer shall certify that the project was constructed in accordance with the plans and specifications approved by the Town of Addison.
  - The owner shall provide 1 reproducible set of as-builts (sealed and certified by a Texas Registered Engineer) and 2 blue line sets.
  - 2) A five foot sidewalk shall be installed along Proton Drive and Les Lecs Avenue: See attached detail.
  - 4) A one year maintenance bond is required for the internal subdivision
  - 5) Contractor shall demonstrate that the water and sanitary sewer systems meet the proper pressure, bacteria, and mandrel tests. In addition, the owner shall provide a VHS format video tape of the sanitary sewer.
- Prior to starting construction, the contractor shall contract the utility companies to locate existing facilities. These include but may not be limited to the following:
  - 1) Town of Addison
  - 2) Lone Star Gas
  - 4) Southwestern Bell 5) Storer Cable
  - 6) Planned Cable Systems
  - 7) TU Electric
- Prior to beginning construction, the owner or his authorized representative shall convene a Pre-Construction Conference between the Town of Addison, Consulting Engineer, Contractor(s), utility companies and any other affected parties. Notify Bruce Ellis 450-2847 at least 48-hours prior to the time of the conference and 48-hours prior to beginning of construction.
- D. Any existing pavement, curbs, and/or sidewalks damaged or removed will be repaired by the contractor at their expense.
- Lot pins shall be in place during construction and prior to final acceptance. Concrete monuments shall be placed as shown on the final plat and iron pins shall be placed at block corners, curve points and angle points in public right-of-way. Concrete monuments shall be six (6) inches in diameter and twenty-four (24) inches long. An iron rod one-half inch in diameter embedded at least three (3) inches in the monument at the exact intersection point of the monument. The monuments shall be set at such an elevation that after construction, the top of the monument will be not less than twelve (12) inches below the ground surface.
- F. The contractor shall stamp a 2-inch "S" in the curb at the location of the sewer service line.
- G. At intersections that have valley drainage, the crown of the intersecting streets will culminate in a distance of 40 feet from the intersecting curb line unless otherwise noted.
- H. Temporary of permanent street barricades shall remain at all points of ingress and egress to prevent public use until such street received final
- Contractor shall obtain a right-of-way permit by the Town of Addison for working within the public right-of-way.
- During construction, the owner shall provide a qualified geotechnical lab to perform materials testing during the construction, at the request of the Town of Addison.
- K. The contractor shall submit material sheets to the Town of Addison for approval prior to incorporating materials into the job.
- The utility contractor shall submit to the Town of Addison for approval a trench safety plan sealed by a registered professional engineer for the installation of utilities greater than five (5) feet in depth.

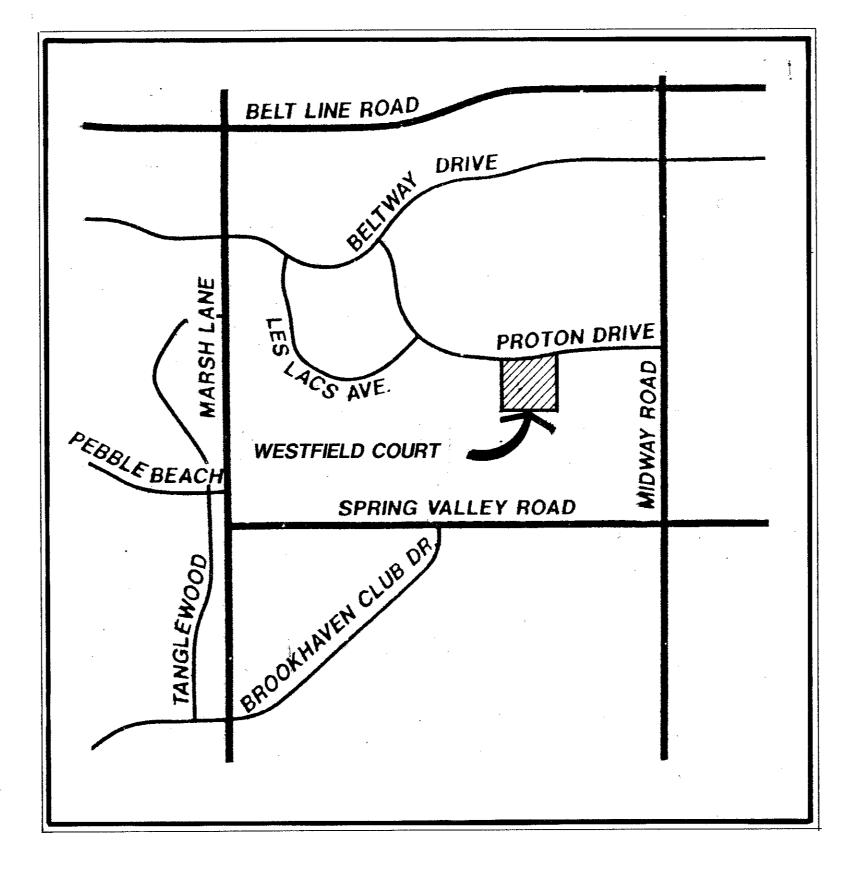

**LOCATION MAP** NOT TO SCALE

SHEET NO.	DESCRIPTION		
FP-1	FINAL PLAT		
	PAVING PLAN AND PROFILE		
P-1	PAVING PLAN AND PROFILE		
P-2	PAVING PLAN AND PROFILE		
	WATER & SANITARY SEWER		
WS-1	WATER & SANITARY SEWER PLAN		
WS-2	SANITARY SEWER PROFILES		
	DRAINAGE PLAN AND PROFILES		
DA-1	DRAINAGE AREA MAP		
DR-1	DRAINAGE PLAN & PROFILE		
GR-1	GRADING PLAN		
	CONSTRUCTION PLANS		
<b>D</b> -1	CONSTRUCTION DETAILS		
THRU			
D-10			

### **AS BUILT**



## **ENGINEER**

### THE NELSON CORPORATION

5999 SUMMERSIDE DR., SUITE 202

DALLAS, TEXAS 75252

(214) 380-2605

### **APPLICANT**

### ARCADIA REALTY CORP.

415 W. WALL, SUITE 2018 MIDLAND, TEXAS 79702


(915) 683-3386

### **OWNER**

WARWICK INVESTMENTS, INC. 2777 STEMMONS FREEWAY

DALLAS, TEXAS 75207

(214) 689-2206

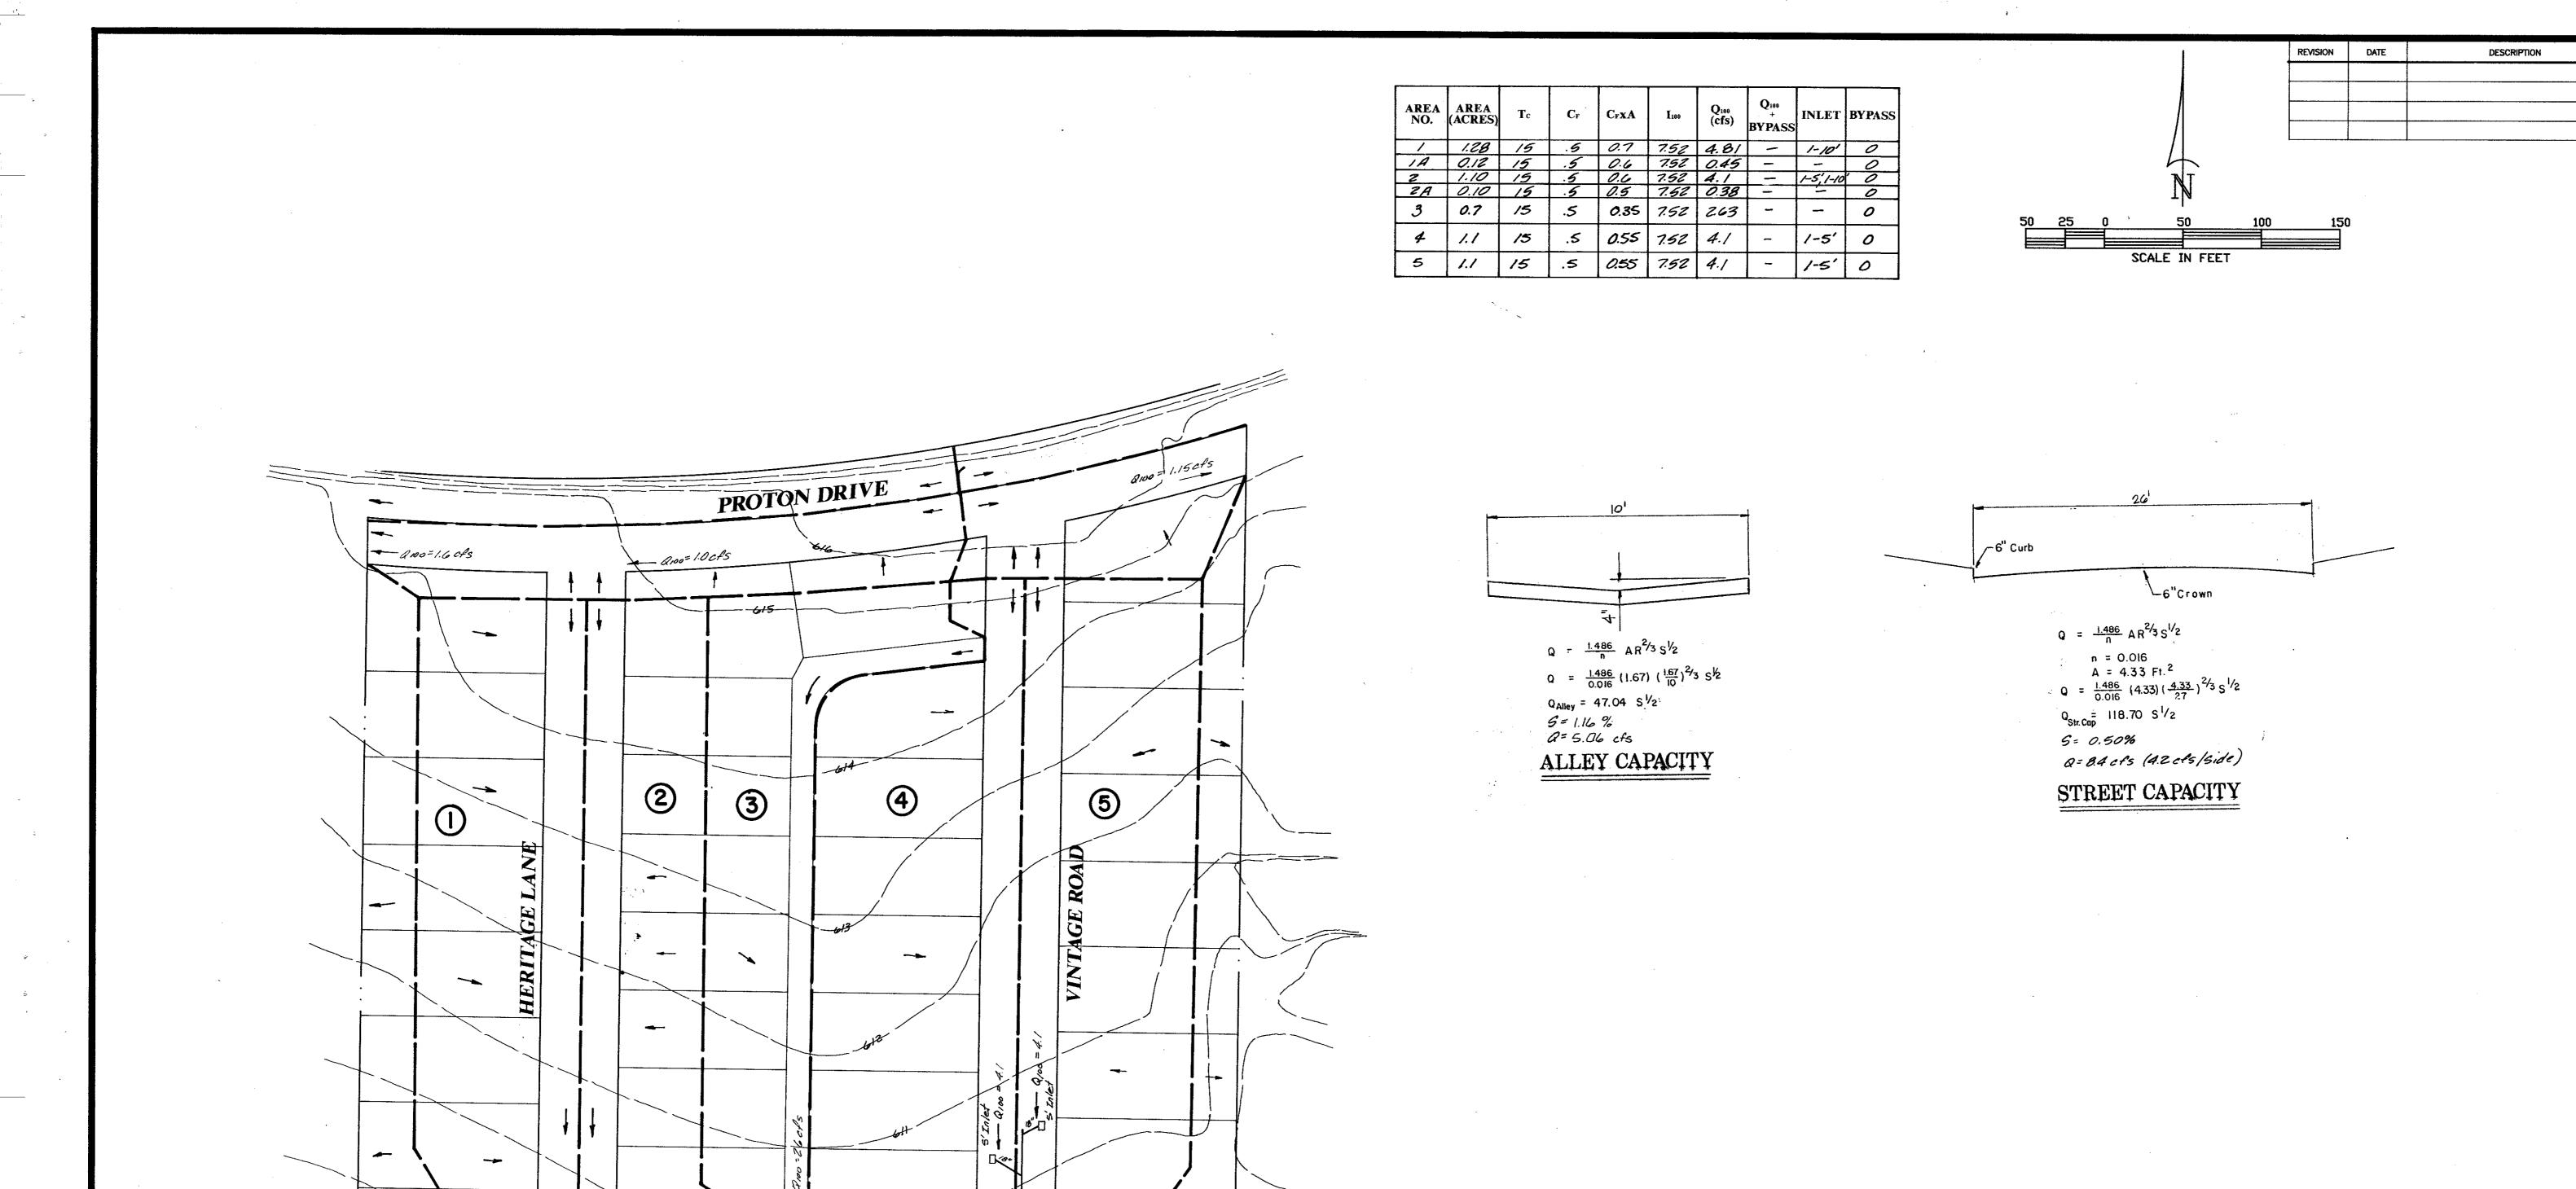

**LEGEND** 

DRAINAGE AREA LINE

DRAINAGE AREA

===== EXIST. STORM SEWER LINE


**EXIST. CONTOUR LINE** 


\_ PROP. STORM SEWER LINE

Gutter Cap = 4.96 10' Inlet

OLD TOWN ROAD

**AS BUILT** 

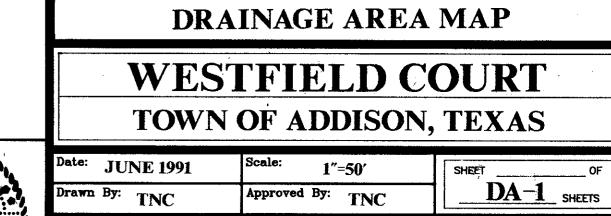

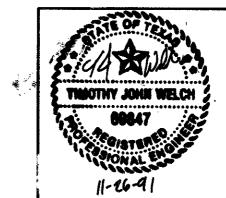


	<u> </u>	
514	Date:	JĮ
روم	Drawn	By:
ELCH		N
F		

THE NELSON CORPORATION

LAND PLANNING - ENGINEERING - SURVEYING

DRAWN BY CHECKED B

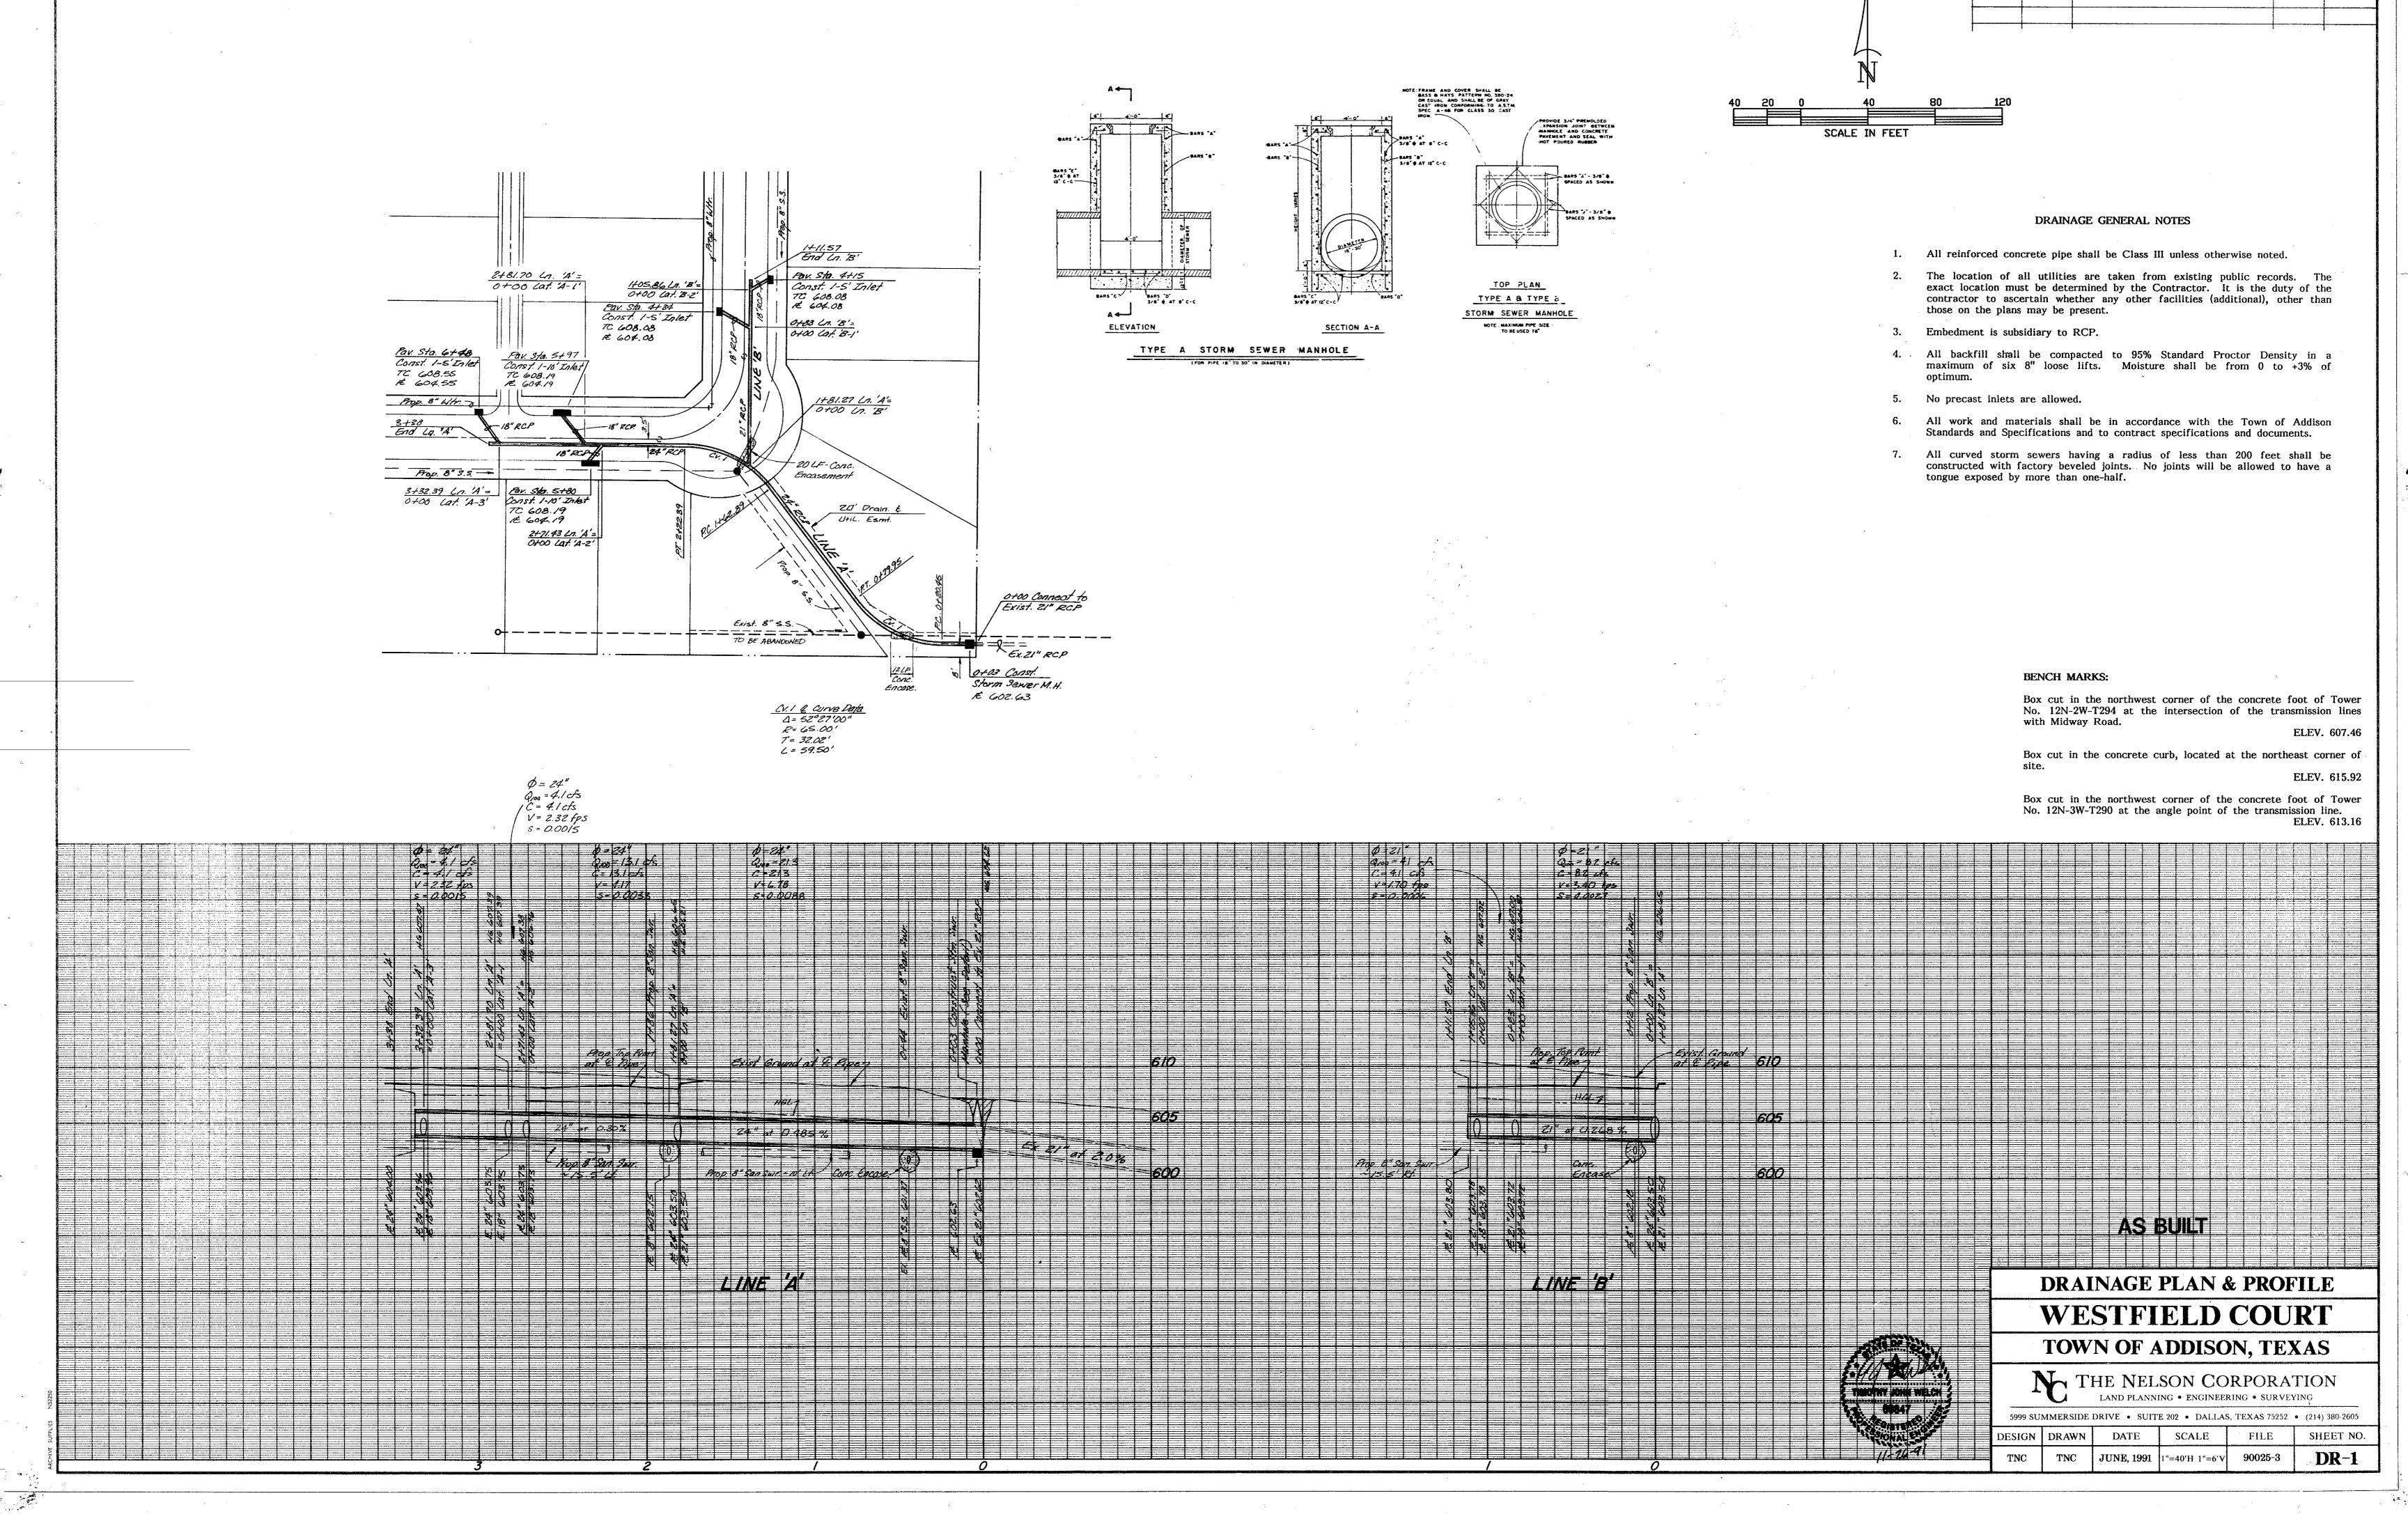

Revisions

Description

Drawn By Checked By

BLOCK B

S 89'21'22"E

N 89'21'22"W

i lo' ELEC\_ESM'T.

S 89°21'22"E

107.00 5'ELEC.

OLD TOWN ROAD

S 89°21'22"E 179.08

N 89°21'22" W 558.08

5' ELEC. ESM'T.

12

S 89'21'22"E

N 89'21'22"W

S 89'21'22"E

N 89°21'22"W 96.47

GREENHILL SCHOOL ADDITION

VOL. 87200, PG. 1886

N 89'21'22"W

BLOCK A

S 89'21'22"E

N 89°21'22"W

S 89'21'22"E

CURVE DELTA RADIUS ARC CHORD TANGENT CHORD BRG

1 04°17'27" 1530.00 114.58 114.56 57.32 S 87°33'05"

2 03°54'43" 1530.00 104./6 104.44 52.25 N 86°28'27"

5 18°16'00" 50.00 15.94 15.87

6 48°27'49" 50.00 42.29 41.04

7 50°50'21" 50.00 44.37 42.92

8 46°10'13" 50.00 40.29 39.21

11 43°29'51" 50.00 37.96 37.05

13 82\*39'39" 40.00 57.71 52.83

3 04°43'52" 1530.00 126.33 126.30 63.20 N 82°09'09" 4 04°26'24" 1530.00 118.56 118.53 59.31 N 75°39'15"

9 54°10'06" 50.00 47.27 45.53 25.57 S 10°25'47" W

10 44°25'40" 50.00 38.77 37.81 20.42 S 38°52'06"

12 21°38'47" 50.00 18.89 18.78 9.56 N 64°35'50"

14 82°39'39" 32.50 42.93 46.89 28.58 S 41°58'27" W

15 90°00'00" 50.00 78.54 70.71 50.00 S 45°38'38" W 16 90°00'00" 50.00 78.54 70.71 50.00 S 44°21'22" E

8.04 S 61°37'10"

23.76 N 35°21'50"

35.18 S 41°58'27" W

38,

8.4844 LTWAY LES L. 90077,

BEL Vol

LINE BEARING DISTANCE
1 N 38'55'08"E 16.1

6 S 89'21'22"E 15.00 7 S 89'21'22"E 15.00 8 S 44'09'12"E 14.19

S 89'21'22"E

3 N 86°46'11"E

S 49'22'14"E

5 N 44 10 18 E

### SURVEYOR CERTIFICATION

STATE OF TEXAS \* COUNTY OF DALLAS \*

THAT I, Brian Marcus, do hereby certify that I have prepared this plat from an actual survey of the land and that the corner monuments shown thereon actually exist, and their location, size and material described are correctly shown.

BRIAN MARCUS, Registered Professional Land Surveyor #4695 THE NELSON CORPORATION 5999 Summerside Drive, Dallas, Texas 75252, (214) 380-2605

STATE OF TEXAS \* COUNTY OF DALLAS \*

BEFORE ME, the undersigned, a Notary Public in and for the State of Texas, on this day personally appeared Brian Marcus, known to me to be the person whose name is subscribed to the foregoing instrument and acknowledged to me that he executed the same for the purposes and consideration therein expressed.

GIVEN UNDER MY HAND AND SEAL OF OFFICE this


Notary Public, State of Texas

APPROVED this the Town of Addison, Texas. 1991, by the Planning and Zoning Commission of

City Secretary Town of Addison, Texas

Town of Addison, Texas

10' TYPICAL SIDEWALK & UTILITY EASEMENT DETAIL

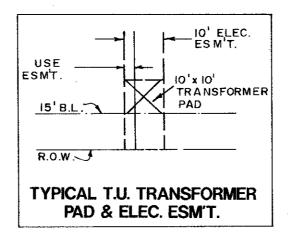

A G

LA 83

LES

S 89'21'22"E

3.5' USE ESMT.

(TYP.) N 89°21'22"W

S 89'21'22"E

18

N 89'21'22"W

\_5'ELEC. ESM'T.

EX. 8' S.S. ESMT.

VOL. 82060, PG. 1621


EX. 15' T.P.& L. ESMT VOL. 82056, PG. 1209

- Driveway Access/Curb Cuts to Proton Drive are prohibited.
- No masonry fences or columns are permitted within the 20 foot utility/drainage easement between lots 15 and 16, Block A.
- Property owners shall provide access to the utility/drainage easements as may be necessary for inspection and maintenance of facilities by the Town of Addison Public Utility Companies.

### NOTE:

ALL IRON RODS SET ARE 5/8" IRON ROD EXCEPT PC, PT, PI & BLOCK CORNERS ARE I" IRON ROD SET, UNLESS NOTED.

O CONCRETE MONUMENT SET.

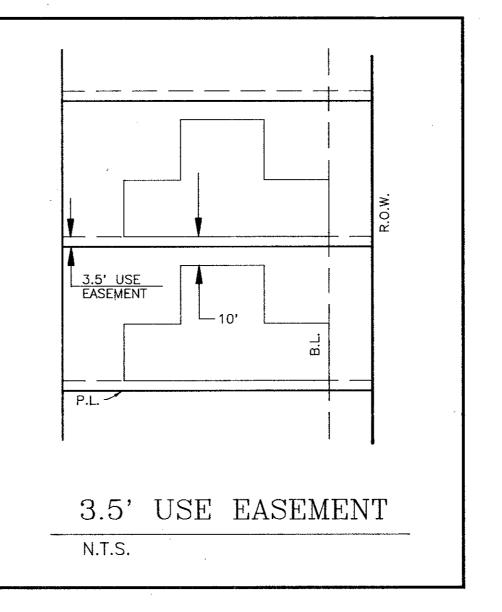

### STATE OF TEXAS COUNTY OF DALLAS

WHEREAS, ARCADIA LAND PARTNERS 3, acting by and through the undersigned, its duly authorized officer, is the owner of that 8.0001 acre tract land out of the THOMAS L. CHENOWITH SURVEY, Abstract No. 273 in the Town of Addison, Dallas County, Texas conveyed by deed recorded in Volume 88006, Page 5295, Deed Records of Dallas County, Texas and being more particularly described as follows:

OWNER CERTIFICATION

BEGINNING at a cross cut found in the concrete street and in the south line of Les Lacs Garden Homes, an addition to the Town of Addison, Texas according to the plat thereof recorded in Volume 82049, Page 1860, Deed Records of Dallas County, Texas and for the northwest corner of Les Lacs Village, Phase I, an addition to the Town of Addison, Texas according to the plat thereof recorded in Volume 83183, Page 4319, Deed Records of Dallas County, Texas and the northeast corner of the beforementioned 8.0001 acre tract:

THENCE with the west line of the said addition, South 00° 38' 38" West, a distance of 675.41 feet to a ½" iron rod found, replaced with a concrete monument set in the north line of Greenhill School Addition, an addition to the Town of Addison, Texas according to the plat thereof recorded in Volume 87200, Page 1886, Deed Records of Dallas County, Texas for the southwest corner of Les Lacs Village, Phase I:

THENCE with the north line of said addition, North 89° 21' 22" West, a distance of 558.08 feet to a ½" iron rod found, replaced with a concrete monument set for the southeast corner of the 8.4844 acre tract conveyed to Beltway Les Lacs Ltd. by deed recorded in Volume 90077, Page 2272, Deed Records of Dallas County, Texas;

THENCE with the west line of the said tract, North 00° 38' 38" East, a distance of 609.17 feet to a cross cut found in the concrete street and in the south line of Les Lacs Garden Homes and for the northeast corner of the 8.4844 acre tract and the beginning of a non-tangency curve to the left, having a central angle of 21° 35' 39", a radius of 1500.00 feet and a chord bearing and distance of North 83° 52' 34" East, 562.00 feet:

THENCE with the said south line and the said curve, an arc distance of 565.34 feet to the POINT OF BEGINNING and containing 8.0001 acres of land.

### NOW, THEREFORE, KNOW ALL MEN BY THESE PRESENTS:

THAT ARCADIA LAND PARTNERS 3, does hereby adopt this plat designating the hereinabove property as WESTFIELD COURT, an addition to the Town of Addison, Texas, and, subject to the conditions, restrictions and reservations stated hereinafter, owner dedicates to the public use forever the streets and alleys shown

The easements shown on this plat are hereby reserved for the purposes as indicated, but not limited to, the installation and maintenance of water, sanitary sewer, storm sewer, drainage, electric, telephone, gas and cable television. Owner shall have the right to use these easements, provided however, that it does not unreasonably interfere or impede with the provision of the services to others, Said utility easements are hereby being reserved by mutual use and accommodation of all public utilities using or desiring to use the same. An express easement of ingress and egress is hereby expressly granted on, over and across all such easements for the benefit of the provider of services for which easements are granted.

Water main and sanitary sewer easements shall also include additional area of working space for construction and maintenance of the systems. Additional easement area is also conveyed for installation and maintenance of manholes, cleanouts, fire hydrants, water service and sewer services from the main to curb or pavement line, and the descriptions of such additional easements herein granted shall be determined by their locations as installed.

This plat is approved subject to all platting ordinances, rules, regulations and resolutions of the Town of Addison, Texas.

WITNESS MY HAND at Plano, Texas, this \_\_\_\_\_ day of \_\_\_\_\_1991.

ARCADIA LAND PARTNERS 3

William Gietema, Jr., In His Capacity
As CEO For ARCADIA REALTY CORP., In Its Capacity As General Partner For ARCADIA LAND PARTNERS 3

STATE OF TEXAS \* COUNTY OF COLLIN \*

BEFORE ME, the undersigned, a Notary Public in and for The State of Texas, on this day personally appeared William Gietema, Jr., General Partner, of ARCADIA LAND PARTNERS 3, known to me to be the person and officer whose name is subscribed to the foregoing instrument, and acknowledged to me that the same was the act of the said ARCADIA LAND PARTNERS 3 and that he executed the same as the act of such partnership for the purposes and consideration therein expressed, and in the capacity therein stated.

GIVEN UNDER MY SEAL OF OFFICE this \_\_\_\_\_ day of \_\_\_\_\_\_, 1991.

Notary Public, State of Texas

## FINAL PLAT

# WESTFIELD COURT

AN ADDITION TO THE TOWN OF ADDISON

8.0001 ACRE TRACT OUT OF THE

THOMAS L. CHENOWITH SURVEY, ABSTRACT NO. 273 TOWN OF ADDISON, DALLAS COUNTY, TEXAS

### OWNER-APPLICANT

PLANNER-ENGINEER-SURVEYOR

THE NELSON CORPORATION

5999 SUMMERSIDE DRIVE, SUITE 202

ARCADIA LAND PARTNERS 3 415 W. WALL, SUITE 2018 MIDLAND, TEXAS 79702


(915) 683-3386

DALLAS, TEXAS 75252

(214) 380-2605

SCALE 1"=50'

JUNE 1991

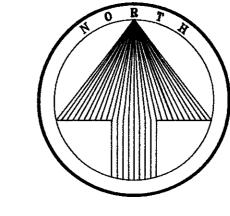


# REVISION DRAWN BY CHECKED I

### STABILIZED CONSTRUCTION ACCESS


A STABILIZED CONSTRUCTION ENTRANCE APPLIES TO POINTS OF CONSTRUCTION INGRESS AND EGRESS WHERE SEDIMENT MAY BE TRACKED OR FLOW OFF THE CONSTRUCTION SITE.

THE ENTRANCE SHALL BE MAINTAINED IN A CONDITION WHICH WILL PREVENT TRACKING OR


FLOWING OF SEDIMENT ONTO PUBLIC RIGHTS-OF-WAY. THIS MAY REQUIRE PERIODIC TOP DRESSING WITH ADDITIONAL STONE OR ADDITIONAL LENGTH AS CONDITIONS DEMAND AND REPAIR AND/OR CLEANOUT OF ANY MEASURES USED TO TRAP SEDIMENT. ALL SEDIMENT SPILLED, DROPPED, WASHED OR TRACKED ONTO PUBLIC RIGHTS-OF-WAY MUST BE REMOVED IMMEDIATELY.

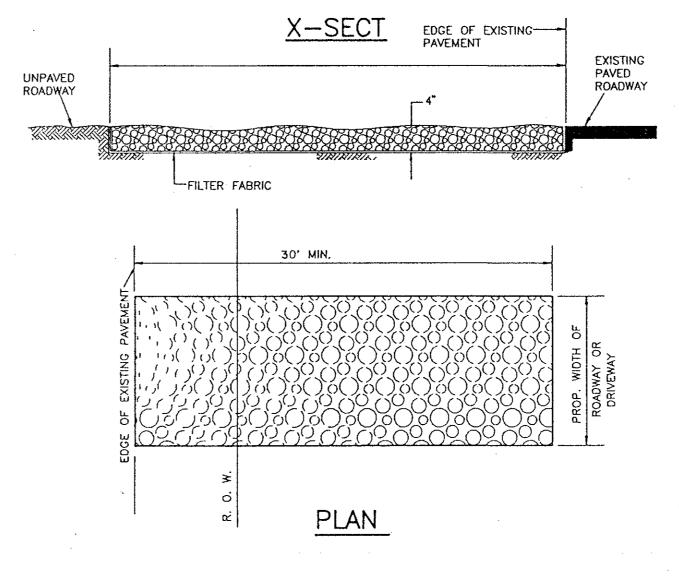

MAINTENANCE THE ENTRANCE SHALL BE MAINTAINED IN A CONDITION WHICH WILL PREVENT TRACKING OR FLOWING OF SEDIMENT ONTO PUBLIC RIGHTS-OF-WAY. THIS MAY REQUIRE PERIODIC TOP DRESSING WITH ADDITIONAL STONE OR ADDITIONAL LENGTH AS CONDITIONS DEMAND AND REPAIR AND/OR CLEANOUT OF ANY MEASURES USED TO TRAP SEDIMENT. ALL SEDIMENT SPILLED, DROPPED, WASHED, OR TRACKED ONTO PUBLIC RIGHTS-OF-WAY MUST BE

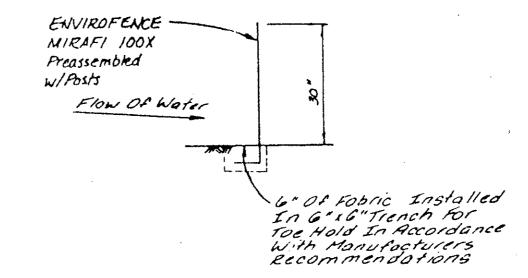

SILITATION FENCE EROSION CONTROL DEVICE

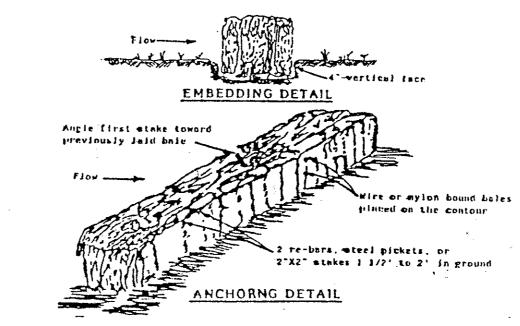

HAY BALE EROSION CONTROL DEVICE

#### **EROSION CONTROL SPECIFICATIONS**


- The grading contractor shall provide and maintain erosion control devices in the areas indicated on the grading plan or any other areas as directed by the Owner's representative or the Town of Addison.
- 2. The utility contractor shall provide and maintain an erosion control device around all openings into the storm sewer system to project completion or as directed by Owner's representative or the Town of Addison.
- 3. The paving contractor shall, upon completion of fine grading provide and maintain erosion control devices in the areas indicated on the grading plan or as directed by the Owner's representative or the Town of
- Upon completion of fine grading, all street parkways shall be seeded, fertilized and maintained by the paving contractor.
- Erosion control devices may be added or reduced in the field as directed by the Town of Addison's inspector or Owner's representative.

#### GRADING SPECIFICATIONS

- All Grading shall conform to the following sections of the North Central Texas C.O.G. Standard Specifications for Public Works construction, latest edition, as applicable:
  - Item 3.2 Clearing and Grubbing
    - Unclassified Street Excavation 3.3
    - 3.4 Parkways
    - 3.5 Unclassified Channel Excavation 3.6 Borrow
    - 3.7 Embankment
- Lot Grading shall be completed to provide sufficient dirt on each pad to achieve the critical pad grades and spot grades on each lot. After achieving critical pad grades indicated on this plan, the contractor is to uniformly fill all pads until the preferred pad grade is met, or, fill pad grades in priority locations as indicated by the engineer.
- Compaction performed in pad areas, streets and alleys shall be a minimum of 95% density at a moisture content of 1 to 3% wet of optimum.
- 4. Remove topsoil in street/alley right-of-ways and pad areas to a depth of 4". Place topsoil in front and backyard areas at the direction of the Owner's representative.
- Finished Floor elevations are assumed to be 9" above Finished Pad
- The Grading contractor is to provide pad compaction testing for each 8" lift at the rate of one random test at the direction of the engineer for
- All lots are to be left in a smooth, bladed condition, without any severe change in slope or low spots. Minimum grade across any lot is to be 1%. Maximum slope is to be 3:1, unless otherwise approved in the field.
- All excess material shall be distributed throughout the site.
- TOLERANCES FOR GRADING ARE:

ROUGH GRA	DING	FINAL GRADIN
Streets	± 0.1'	± 0.1'
Pads	± 0.5'	± 0.25'
Lot Corners	± 0.5"	± 0.25'

LEGEND EXISTING CONTOUR ---- EXISTING TOP OF CURB ELEVATION - CRITICAL FINISHED PAD ELEVATION PREFERRED FINISHED PAD ELEVATION CONTRACTOR MAINTAINED TO PROJECT COMPLETION EROSION CONTROL DEVICE BY PAVING CONTRACTOR PLACED UPON COMPLETION OF FINAL GRADING PROPOSED TOP OF CURB OR SPOT ELEVATION

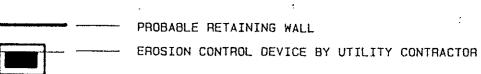


----- EXISTING ASPHALT PAVEMENT TO BE REMOVED. BLOCK NUMBER

**AS BUILT** 

# GRADING PLAN & EROSION PLAN

# WESTFIELD COURT



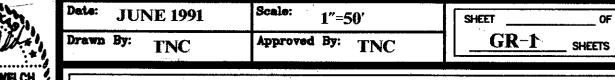








5999 SUMMERSIDE DRIVE SUITE 202 · DALLAS, TEXAS 75252 · (214) 380-2605



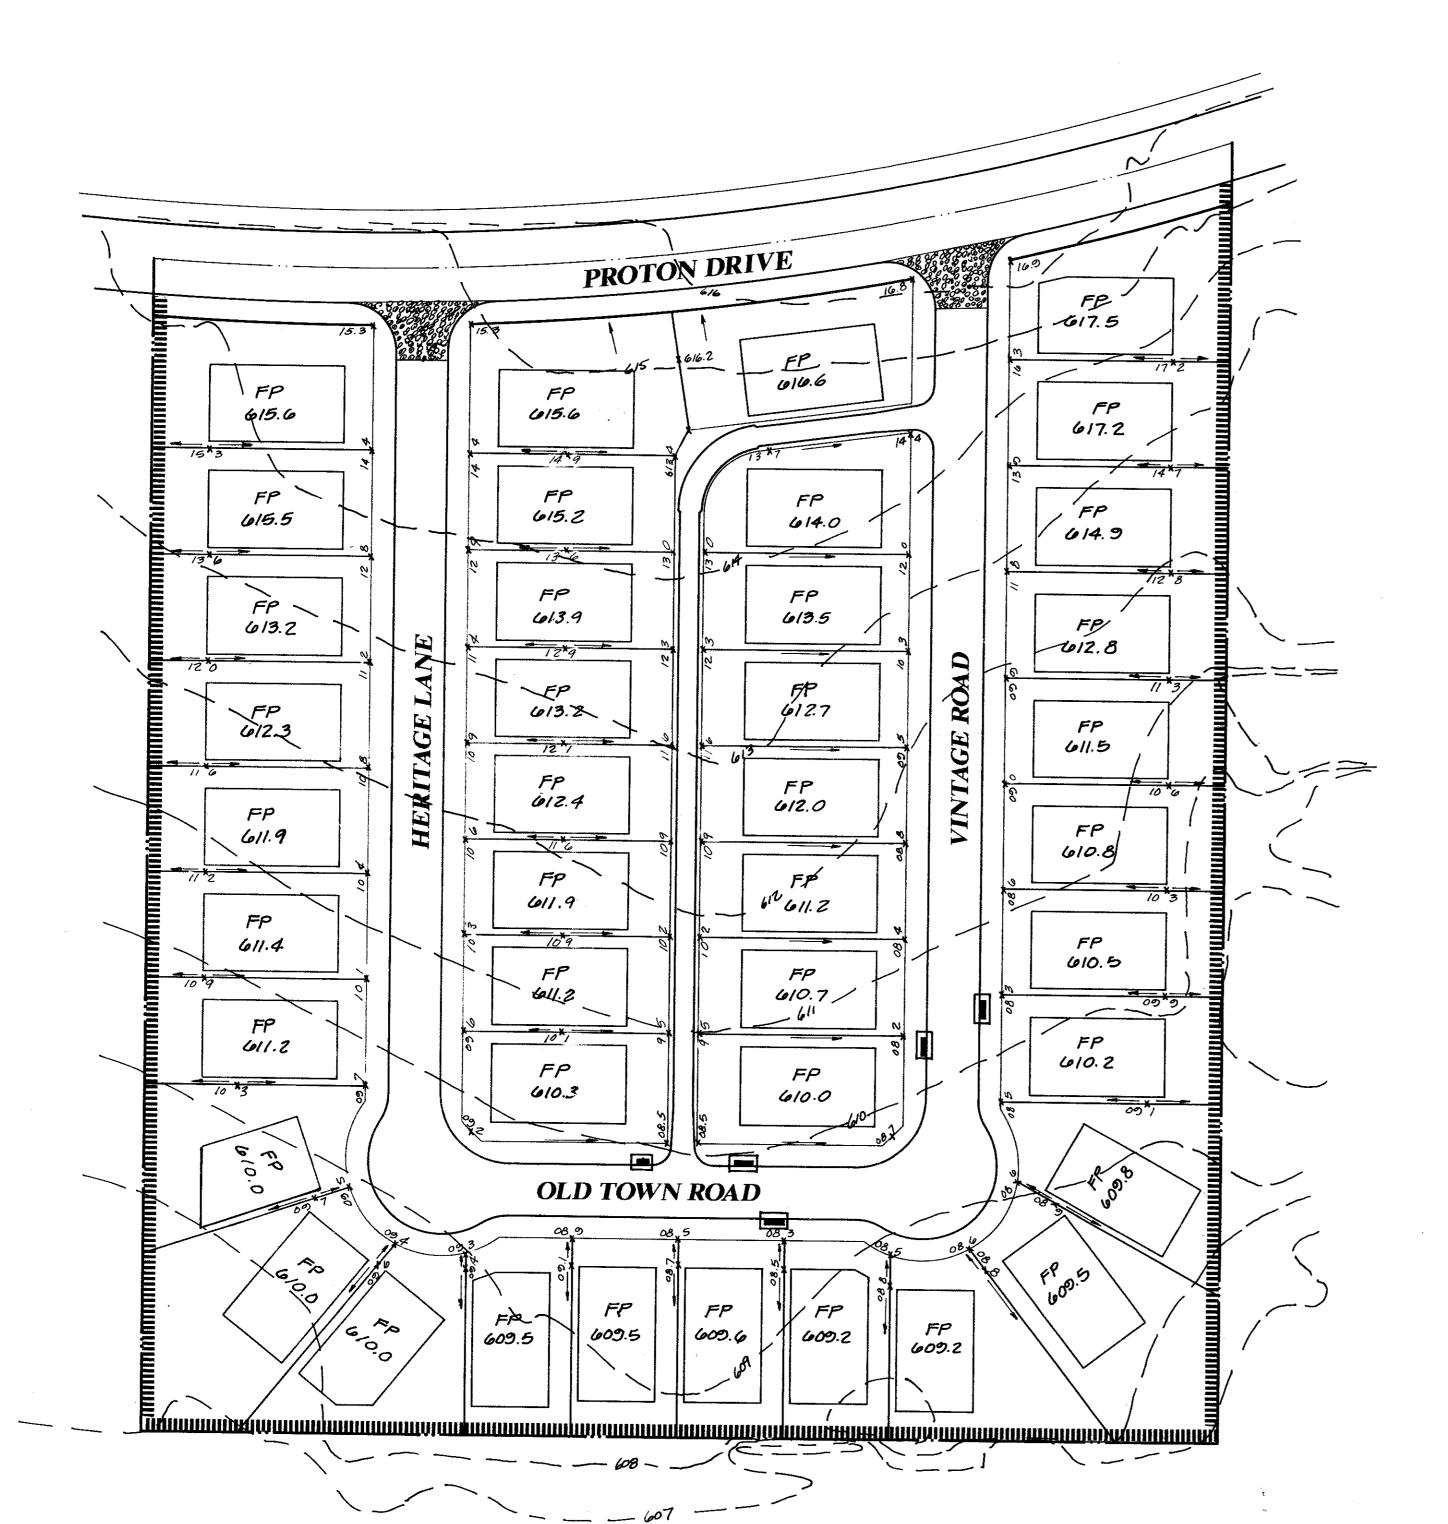

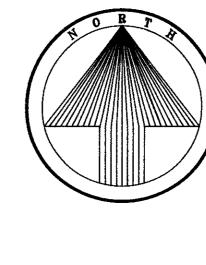

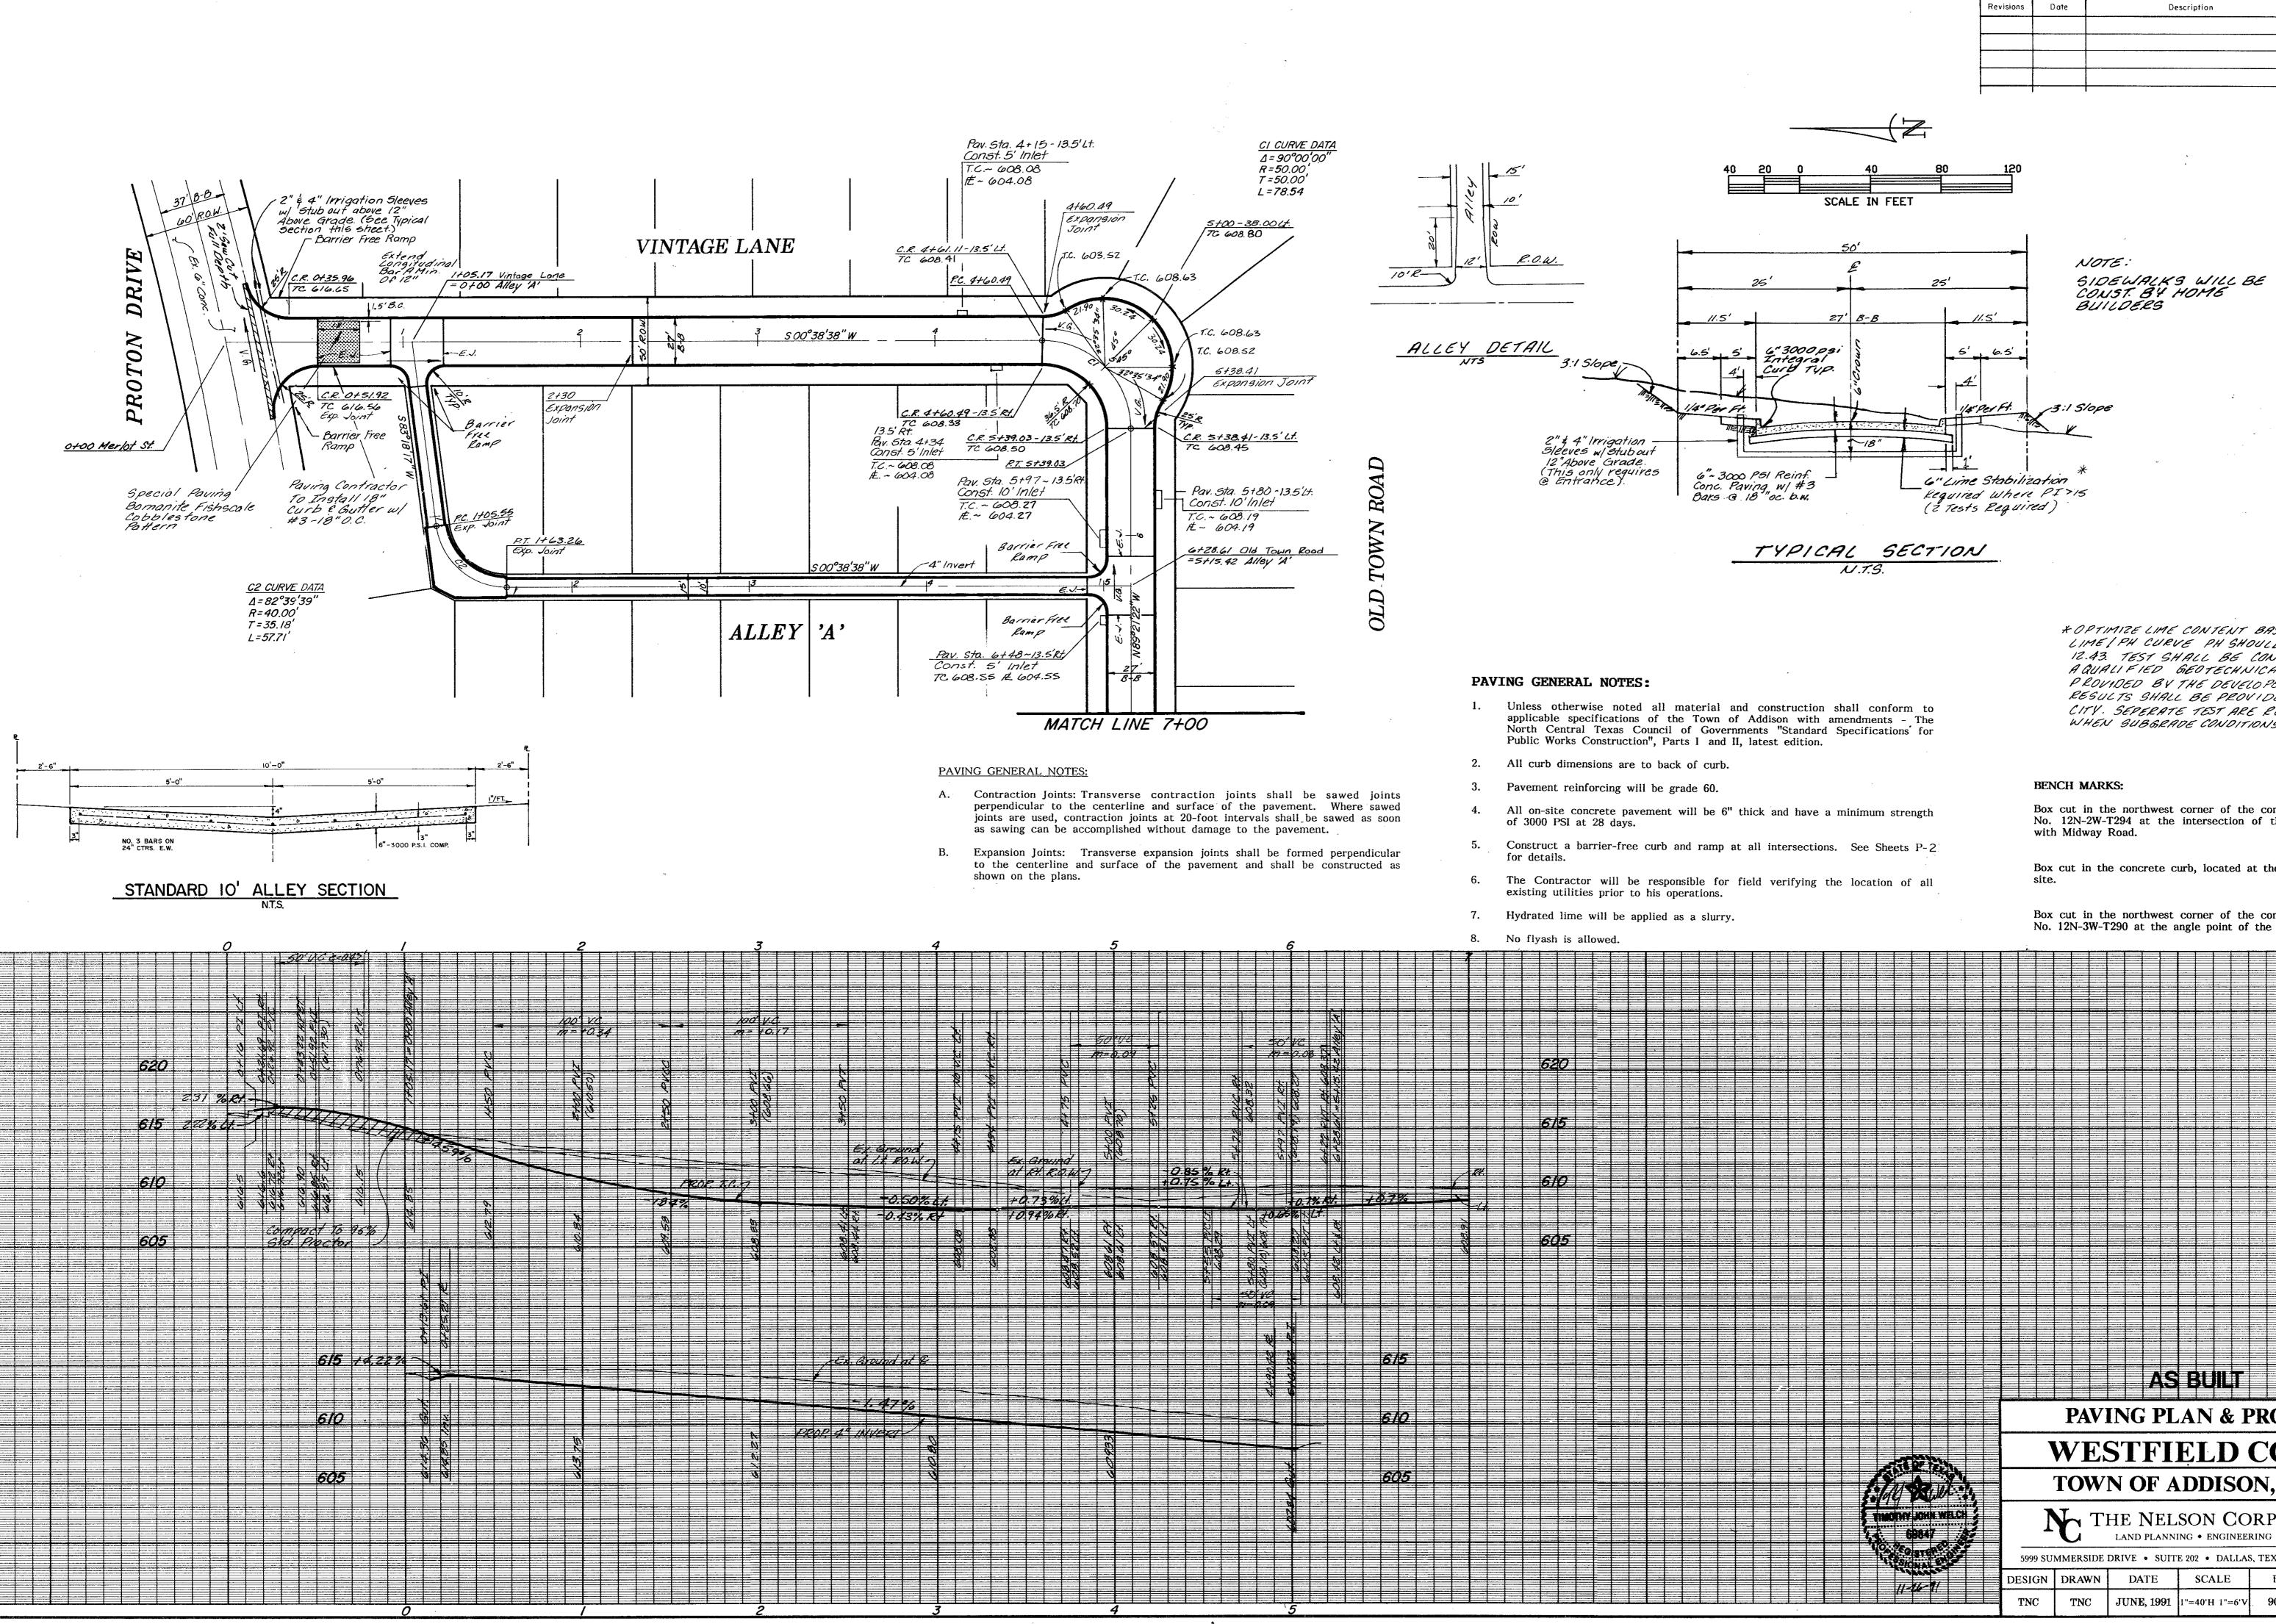

\* OPTIMIZE LIME CONTENT BASED ON A LIME PH CURVE PH SHOULD BE APPROX. 12.43. TEST SHALL BE CONDECTED BY A QUALIFIED GEOTECHNICAL FIRM PROVIDED BY THE DEVELOPER. TEST RESULTS SHALL BE PROVIDED TO THE CITY. SEPERATE TEST ARE REQUIRED WHEN GUBGRADE CONDITIONS CHANGE.

Description

Drawn By

Box cut in the northwest corner of the concrete foot of Tower No. 12N-2W-T294 at the intersection of the transmission lines with Midway Road.

Box cut in the concrete curb, located at the northeast corner of

ELEV. 615.92

Box cut in the northwest corner of the concrete foot of Tower No. 12N-3W-T290 at the angle point of the transmission line. ELEV. 613.16


AS BUILT


### PAVING PLAN & PROFILE

# WESTFIELD COURT TOWN OF ADDISON, TEXAS




5999 SUMMERSIDE DRIVE • SUITE 202 • DALLAS, TEXAS 75252 • (214) 380-2605 SHEET NO. DRAWN P-1 90025-3 JUNE, 1991 1"=40'H 1"=6'V

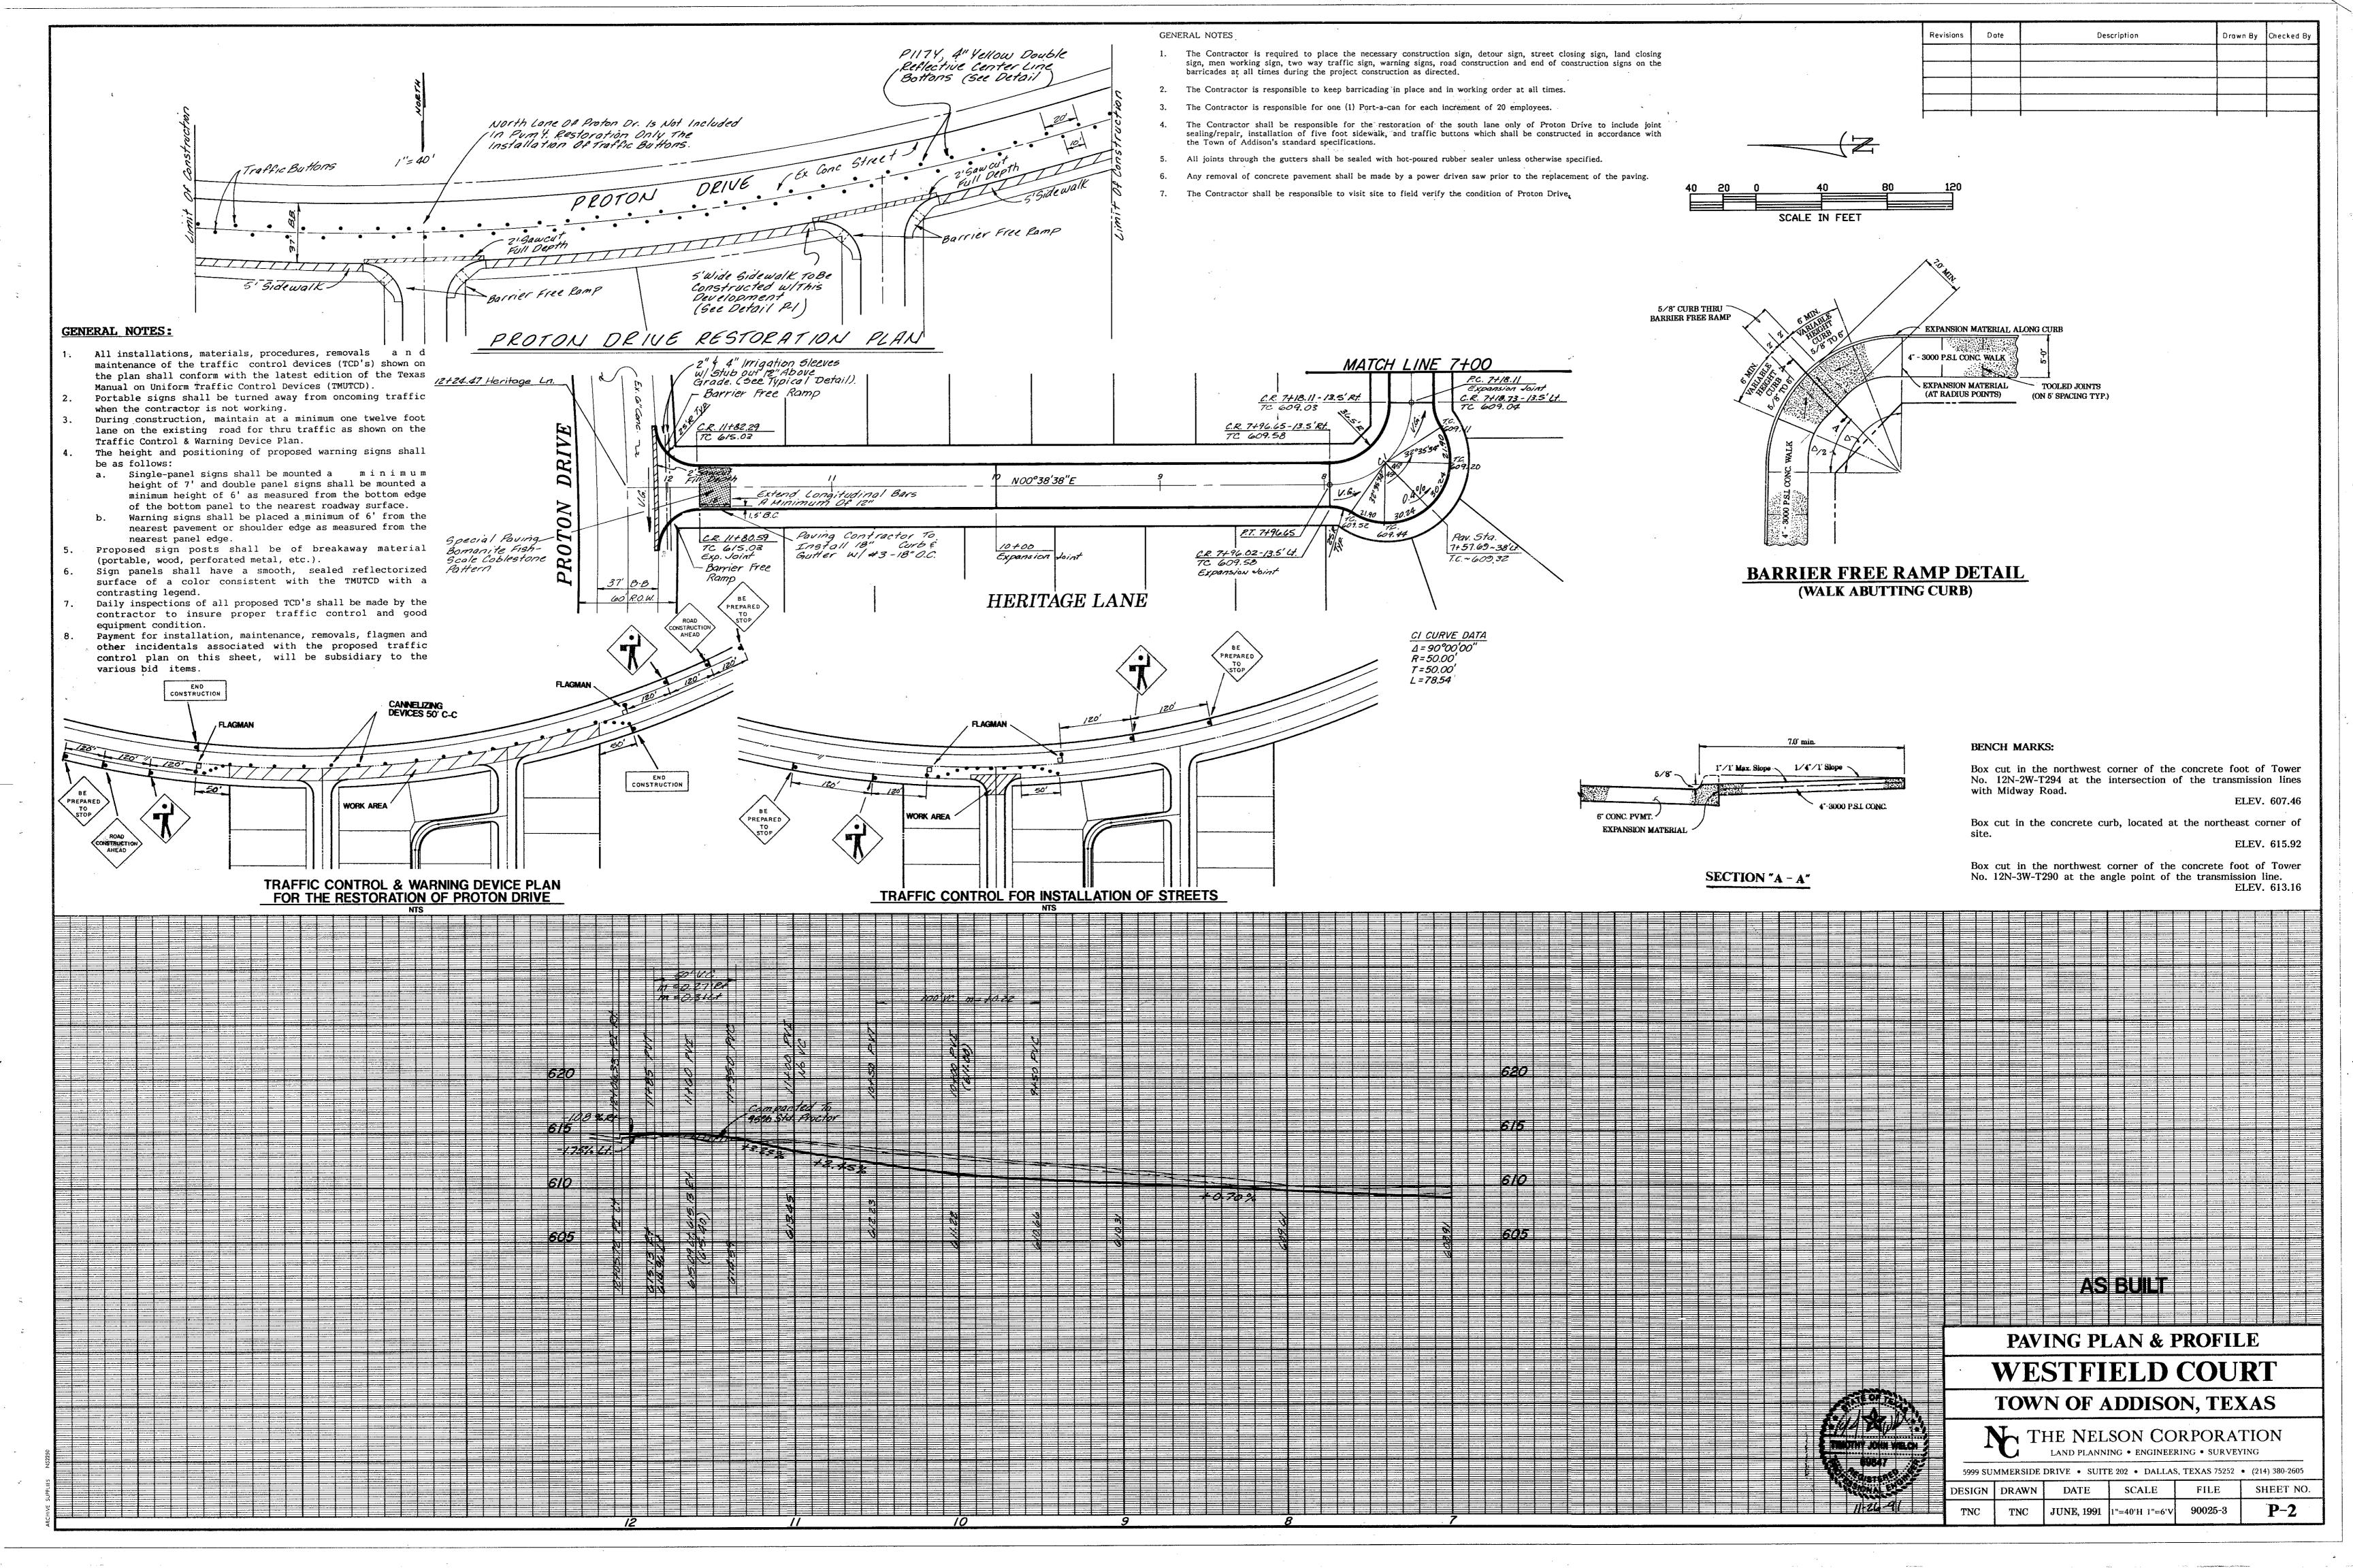

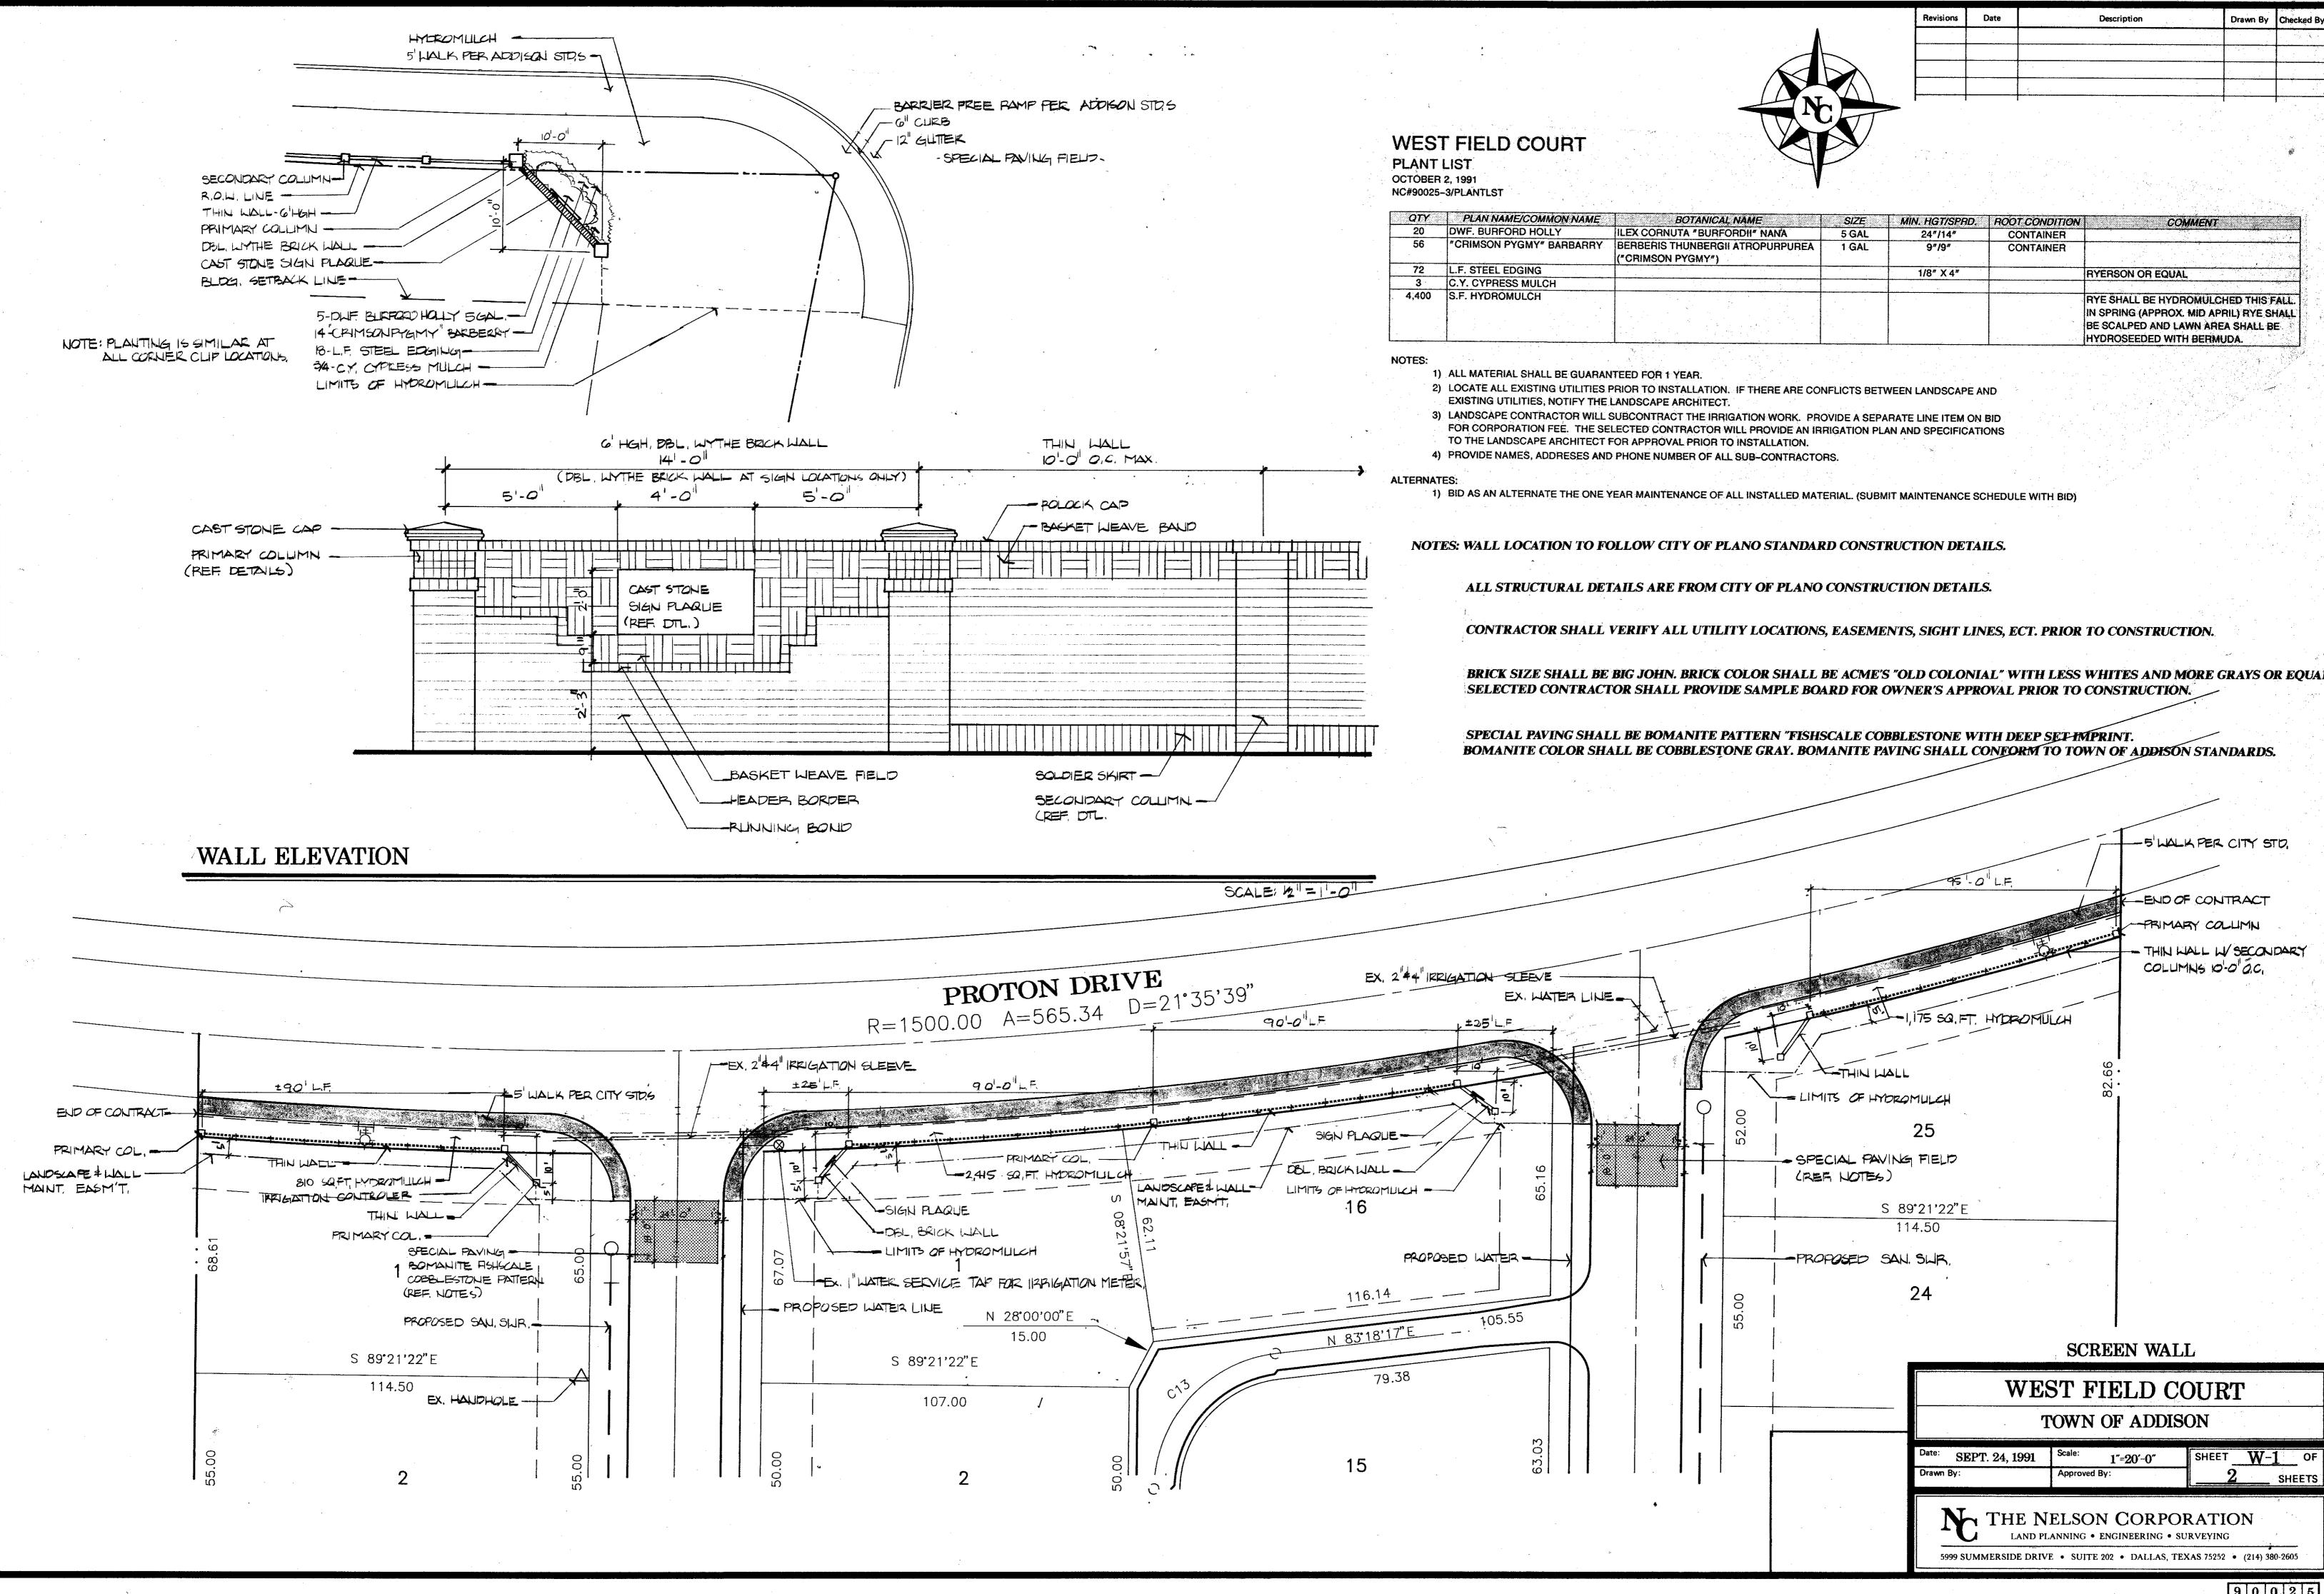


# A THIN WALL SECTION

SCALE: 3/4"=1'-0"

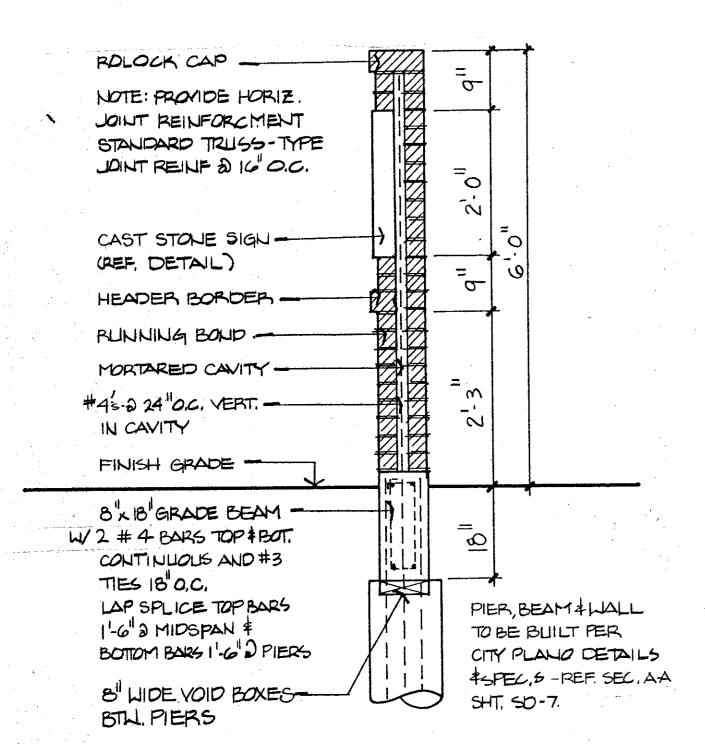

SECTION- DBL. BRICK WALL AT SIGN


5CALE: 34 = 1-0

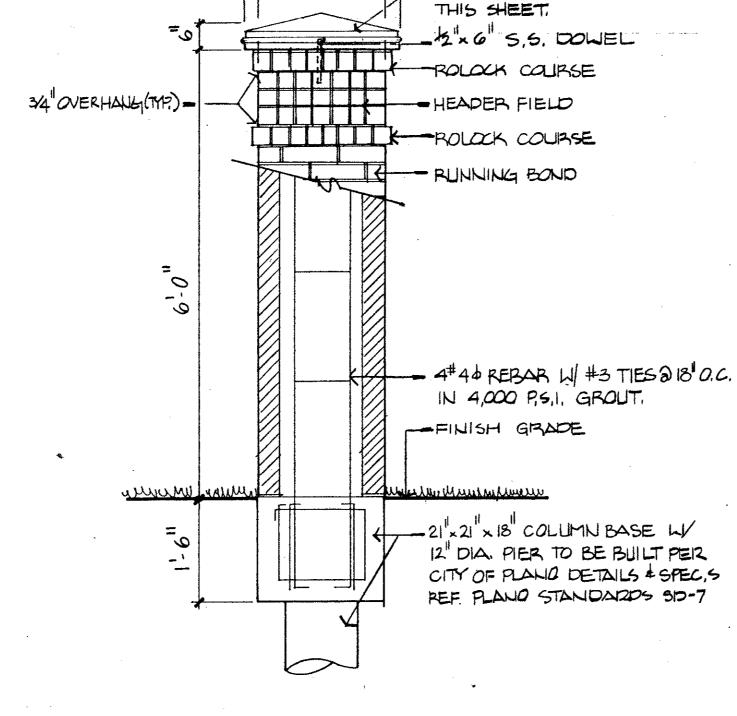

### C PRIMARY COLUMN


SCALE: 3/4" = 1-0"


- CAST STONE CAP-REF. DETAIL

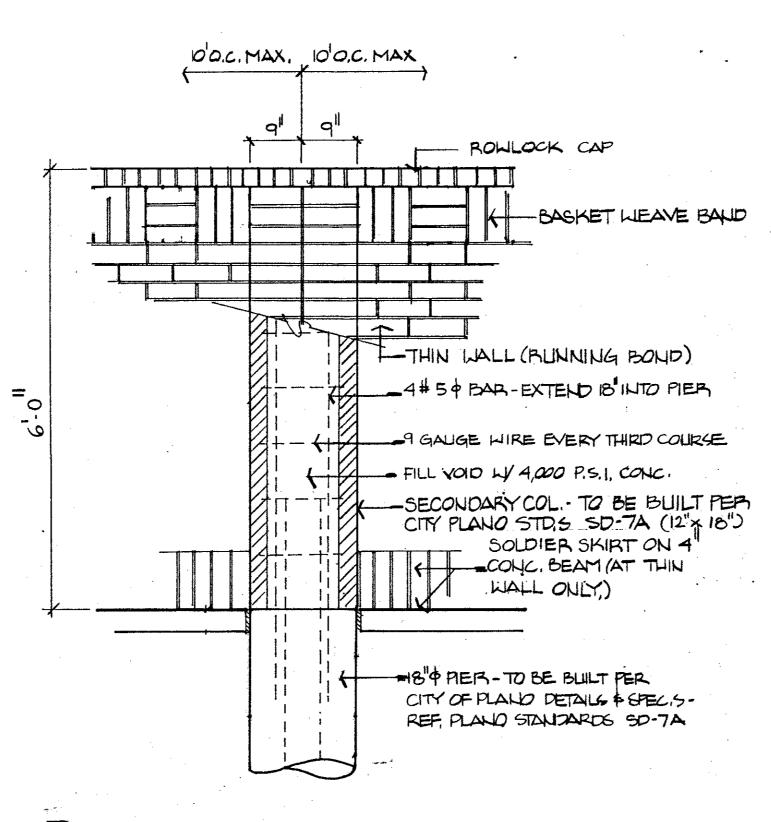

### D SECONDARY COLUMN


SCALE: 3/4"=1'-0"

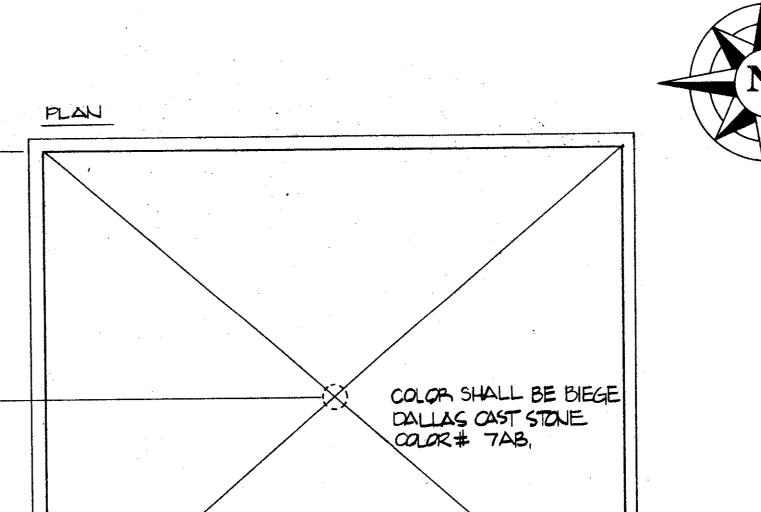

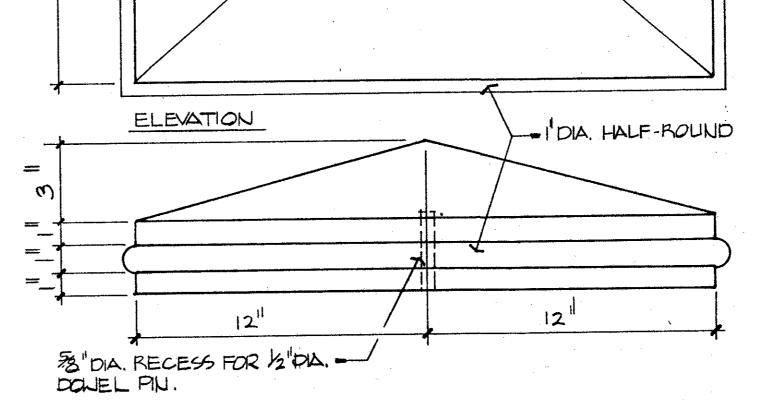


### E CAST STONE CAP

-81

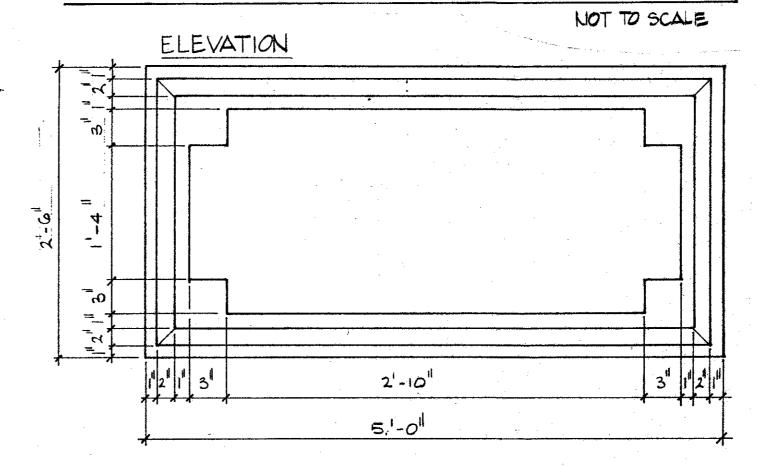


1) CAST STONE COLOR! BIEGE - DALLAS CAST STONE # 7AB,
2) LETTERING STYLE/GRAPHICS TO BE DETERMINED.
3) SIGN SHALL CONTAIN SUBDIVISION NAME ONLY,
4) LETTERING SHALL BE SANDBLASTED I DEEP & STAINED FOR CONTRAST,
5) SELECTED CONTRACTOR SHALL PROVIDE SHOP DOVE &

5) SELECTED CONTRACTOR SHALL PROVIDE SHOP DRV4, S
FOR APPROVAL PRIOR TO SIGN MANUFACTURE

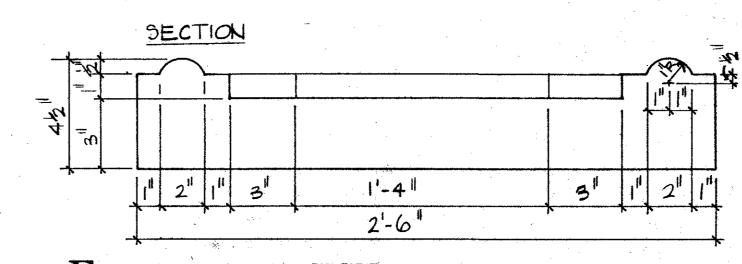

F CAST STONE SIGN

NOT TO SCALE

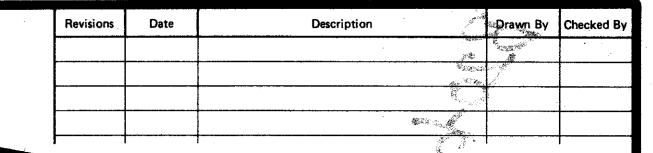

SCREEN WALL

# WEST FIELD COURT


TOWN OF ADDISON


Date: SEPT. 24, 1991 Scale: 1"=20'-0" SHEET W-0F
Drawn By: Approved By: ETS

THE NELSON CORPORATION
LAND PLANNING • ENGINEERING • SURVEYING

5999 SUMMERSIDE DRIVE • SUITE 202 • DALLAS, TEXAS 5252 • (214):

9 0 0 2 5

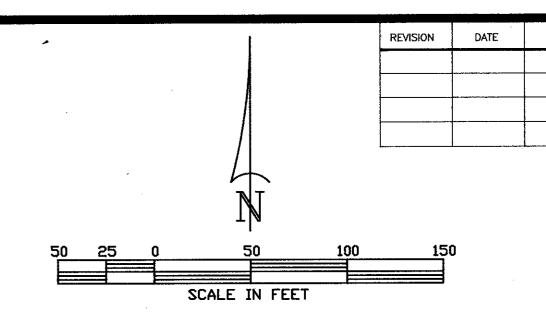

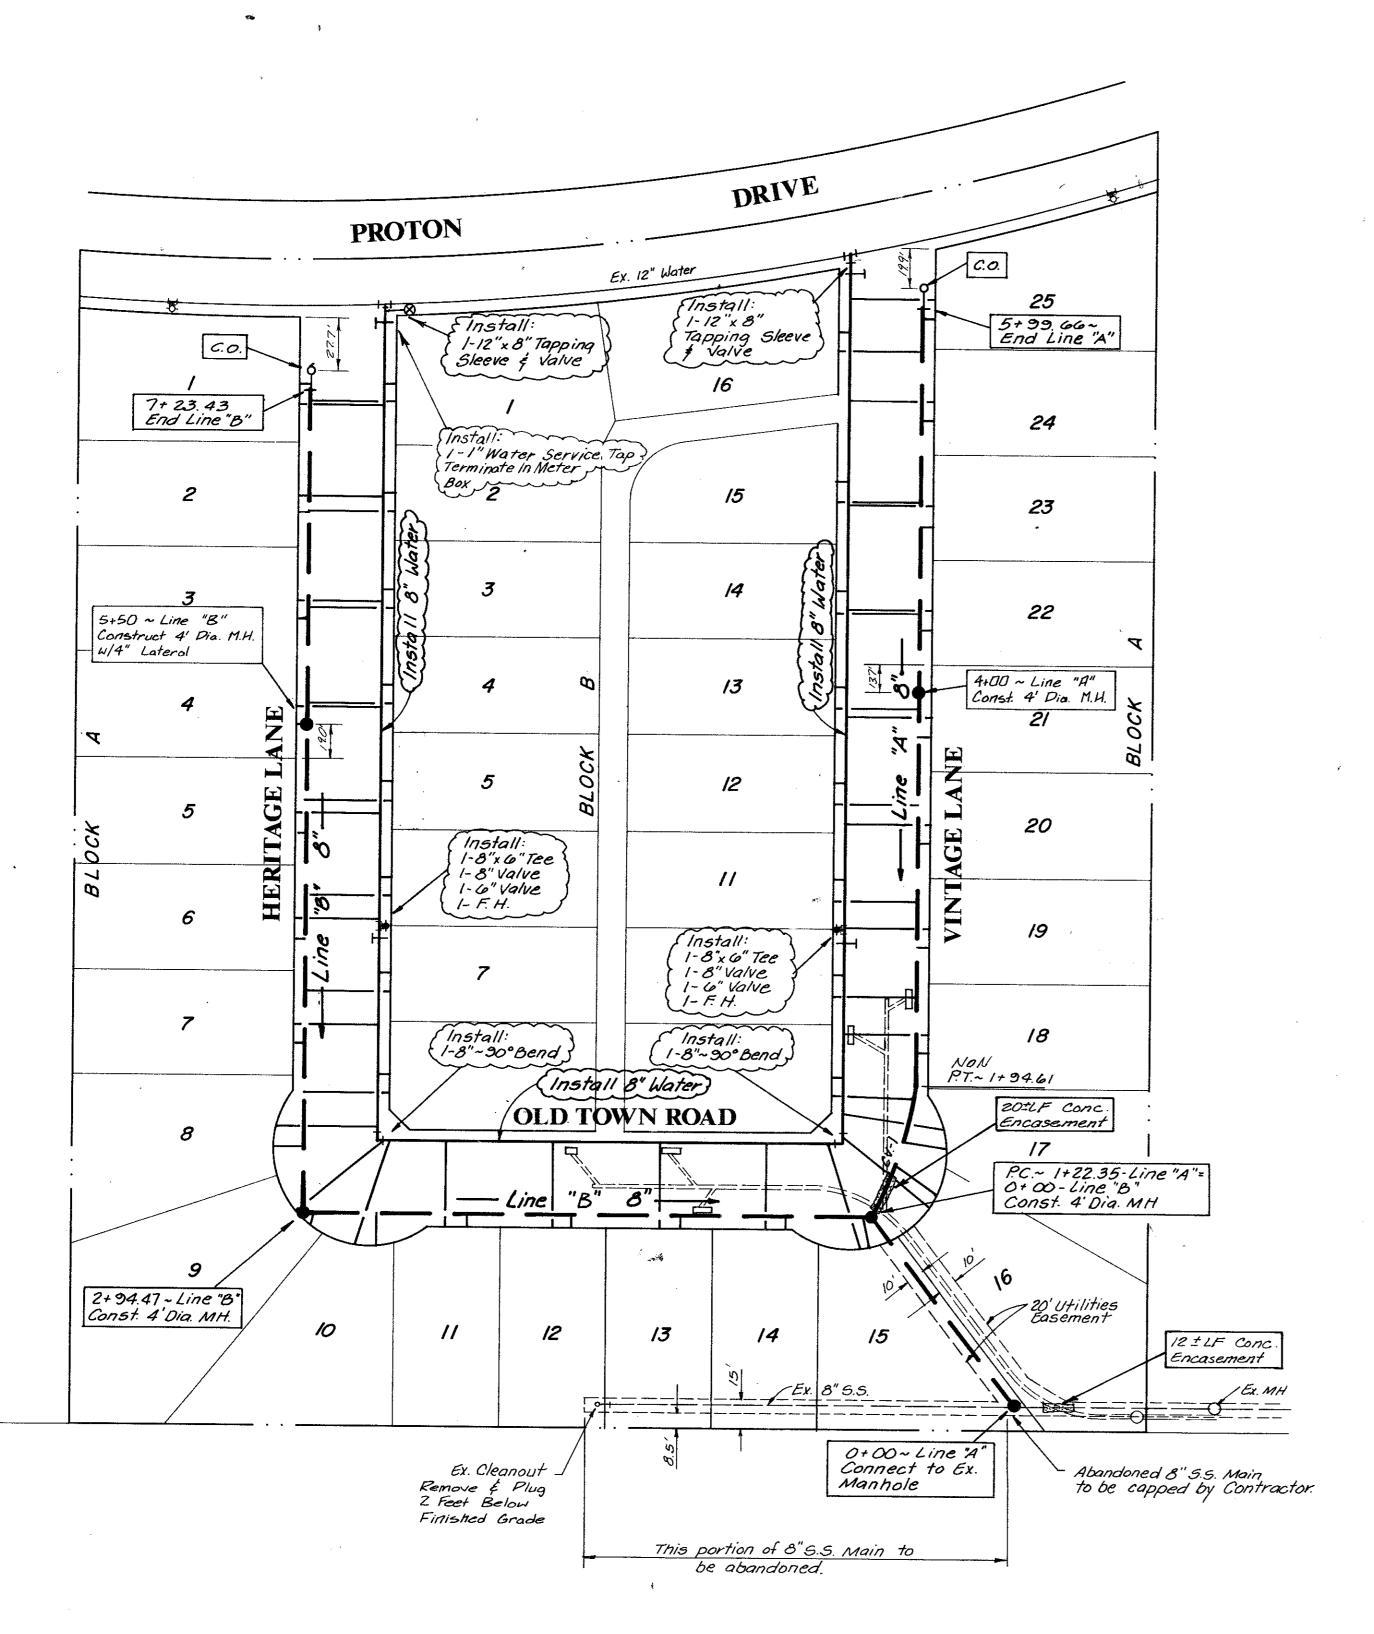


#### WATER & SANITARY GENERAL NOTES

- 1. All water mains shall be PVC SDR-18 water pipe.
- 2. All sanitary sewer mains shall be PVC SDR-35 and shall have integral wall bell and spigot joints.
- 3. All water mains shall have a minimum cover below finished grades as follows: 6" & 8" 48", 12" 60", or as required to clear other utilities.
- 4. The location of all utilities are taken from existing public records. The exact location must be determined by the Contractor. It is the duty of the contractor to ascertain whether any other facilities (additional), other than those on the plans may be present.
- 5. All utility and service laterals trenches shall be backfilled and compacted to 95% Standard Proctor Density.
- All manholes, cleanouts, valve boxes, fire hydrants, etc., must be adjusted to proper line and grade by the Contractor after placing of permanent paving.
- 7. All work and materials shall be in accordance with the Town of Addison Standard Specifications.
- 8. Contractor shall be responsible for providing "as-built" plans to the Engineer showing the location of sewer service by distance to the lot lines.
- All fire hydrants shall be Mueller Centurion model.
- 10. The No. 12 plastic coated wire shall be placed in the trench over all water lines. The wire will be tied to all valves and fire hydrants and attached directly to the top of pipe and extend to six (6") inches above finished grade along the outside of all valve stacks and fire hydrants.
- 11. All dimensions shown are to centerline of pipe and the R.O.W., unless otherwise noted.
- 12. Contractor shall be responsible for trench safety and details as required.

 SANITARY SEWER CURVE DATA

 LOCATION
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 R
 T
 L

 VINTAGE ROAD & OLD TOWN ROAD
 20°42'03" 200.00' 36.53' 72.26'

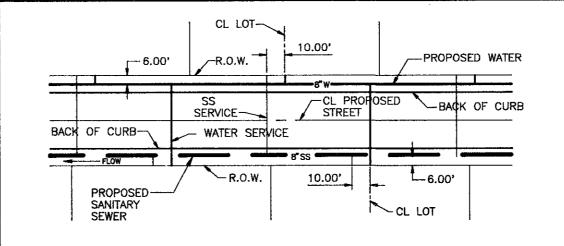


TYPICAL INSTALLATION DETAIL FOR WATER & SANITARY SEWER SERVICES

**AS BUILT** 

WATER & SANITARY SEWER PLAN

WESTFIELD COURT TOWN OF ADDISON, TEXAS

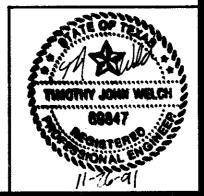

te: JUNE 19	991 Scale:	1"=50'	SHEET
awn By: TNC	Approved	By: TNC	WS-1 SHE

THE NELSON CORPORATION

LAND PLANNING - ENGINEERING - SURVEYING

5999 SUMMERSIDE DRIVE SUITE 202 · DALLAS, TEXAS 75252 · (214) 380-2605

DRAWN BY CHECKED

DESCRIPTION

