


DASEKE RESIDENCE

5656 CELESTIAL ROAD
TOWN OF ADDISON, TEXAS

FOR
DROESE RANEY ARCHITECTURE
3906 Lemmon Avenue, Suite 101
Dallas Texas 75219

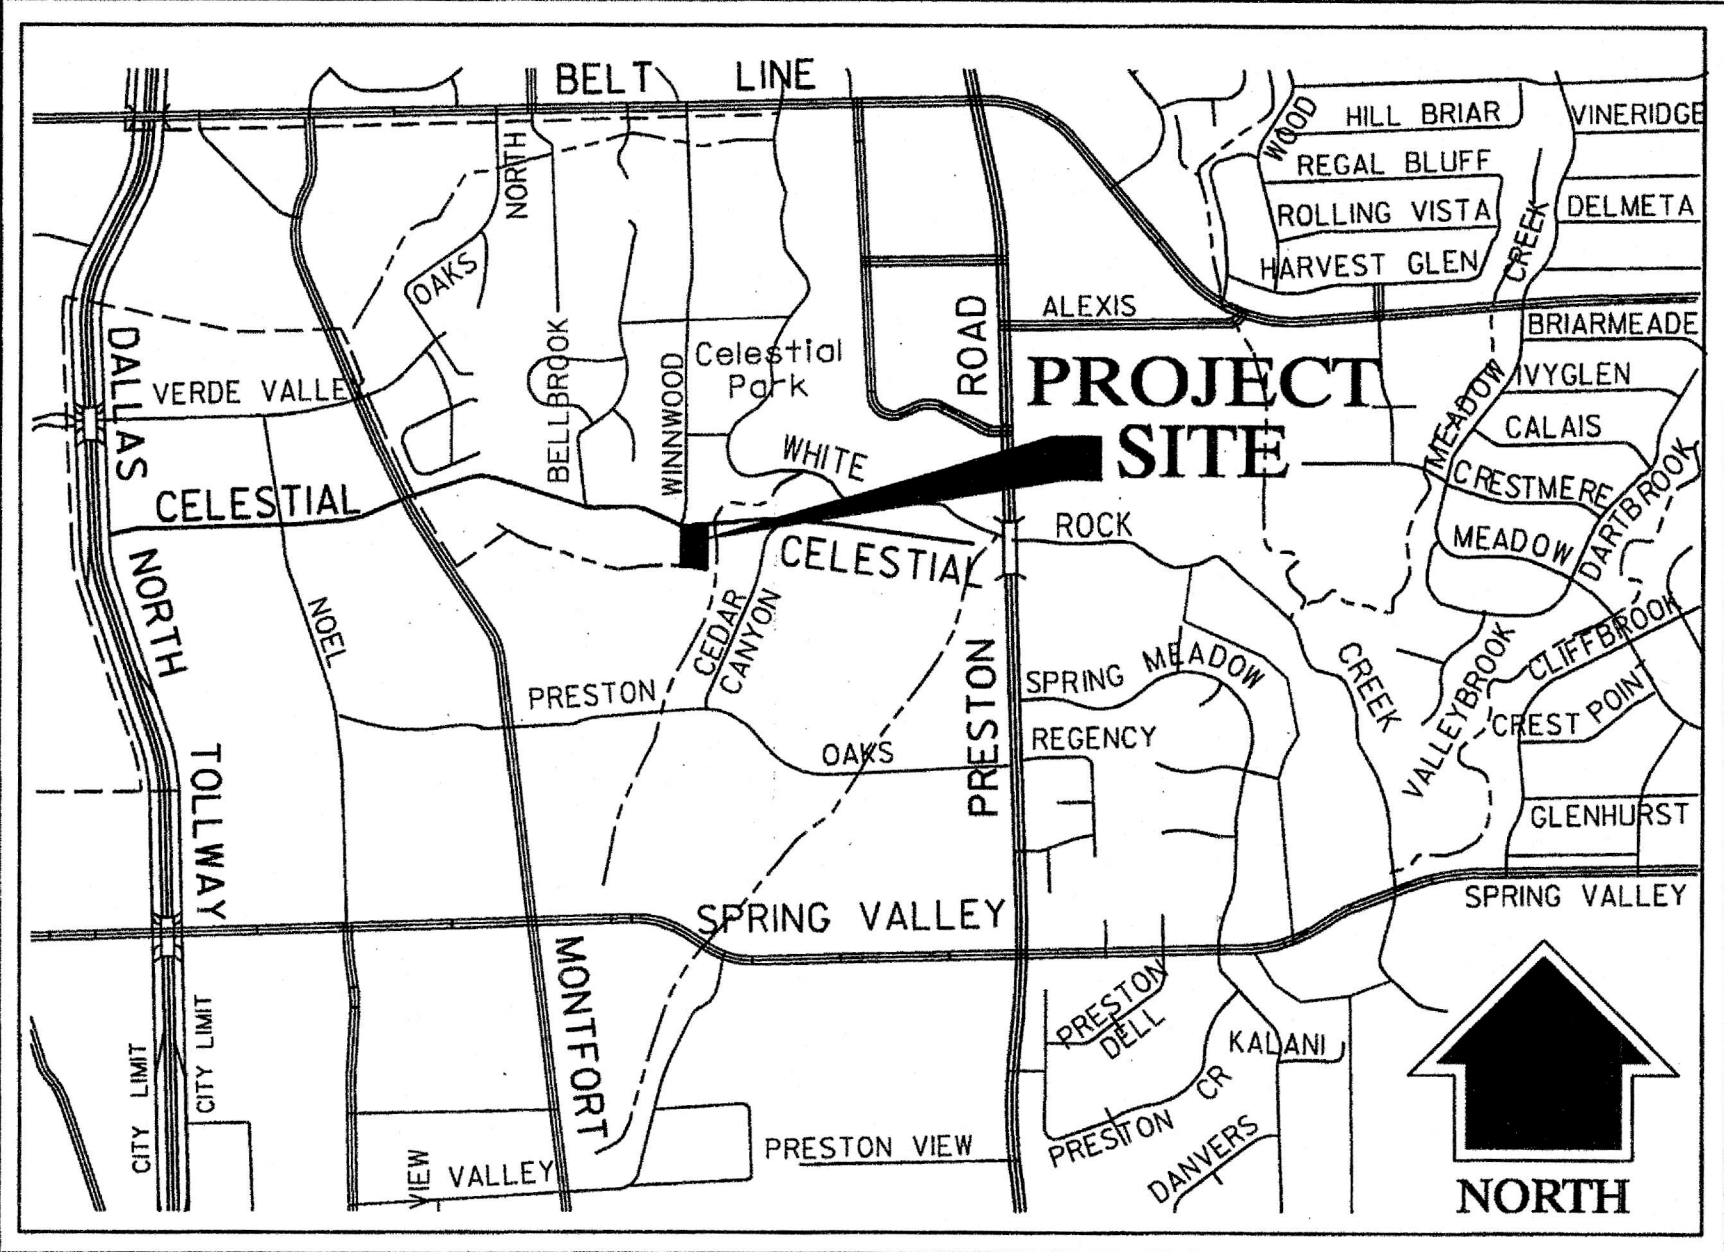

LOCATION MAP - N.T.S.

SHEET INDEX

C0.01	TOPOGRAPHIC SURVEY	
C1.01	PAVING AND DIMENSION CONTROL PLAN	⚠
C2.01	GRADING PLAN	
C2.02	DRAINAGE AREA MAP	⚠
C3.01	UTILITY PLAN	
C4.01	EROSION CONTROL PLAN	
C4.02	EROSION CONTROL NOTES & DETAILS	



09-27-2010
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APPROVED FOR CONSTRUCTION
 Town of Addison
 Public Works Department
 APPROVED BY: *Curt Brown*
 DATE: 10-6-2010

All responsibility for the adequacy of these plans remains with the Engineer who prepared them. In approving these plans, the Town of Addison makes no representation of adequacy of the work of the Design Engineer.

HALFF
 1201 NORTH BOWSER ROAD
 RICHARDSON, TEXAS 75081-2275
 TEL (214) 346-6200
 FAX (214) 739-0095

AVO 27431 SEPTEMBER 27, 2010



1 REV. FOR PERMIT AND CONSTRUCTION

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DASEKE 5656 Celestial p.p.

WINWOOD ROAD

FARRIN ASSOJAD
BARBARA ASSOJAD
VOL 92052 PG 7503

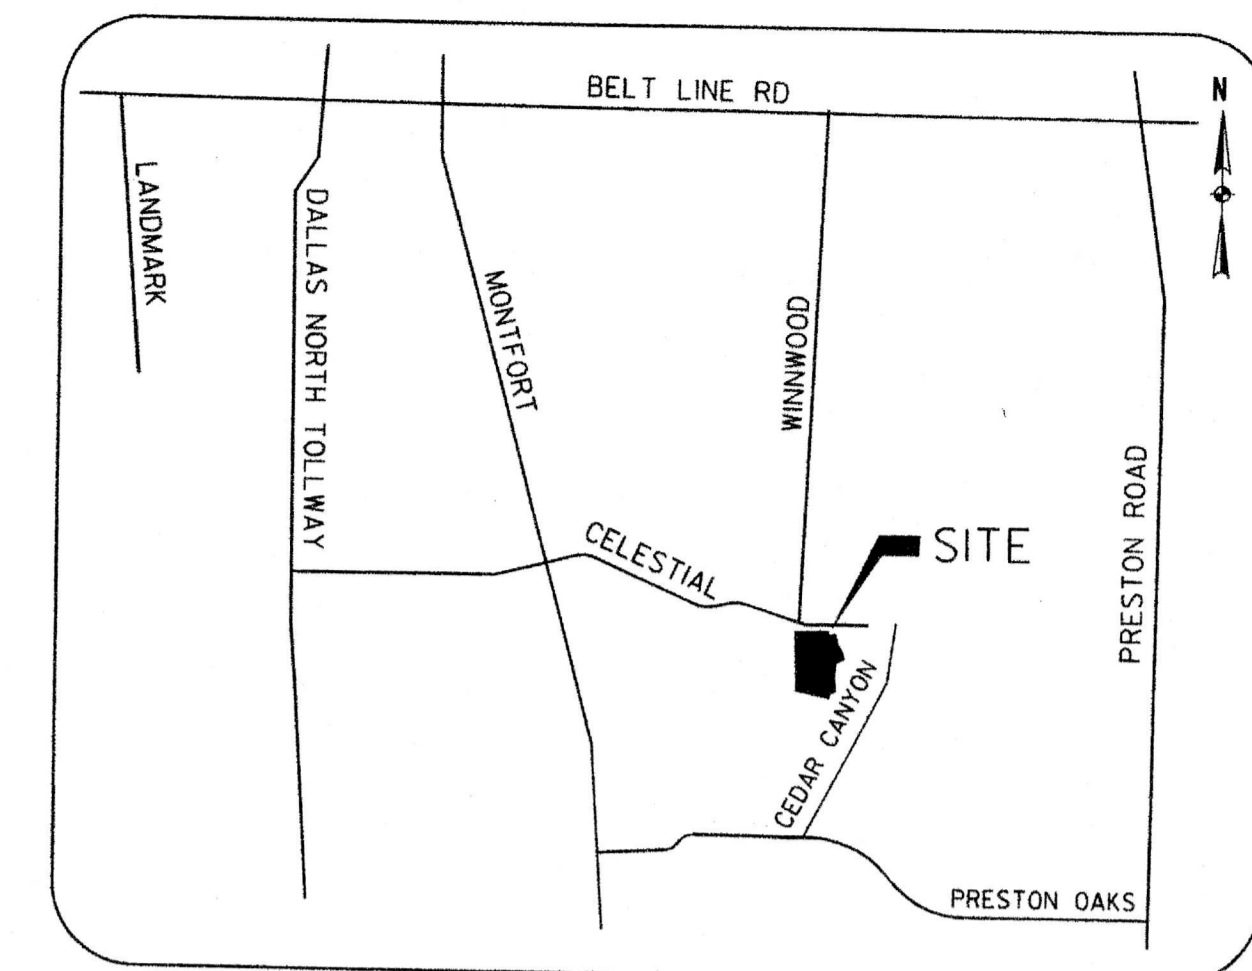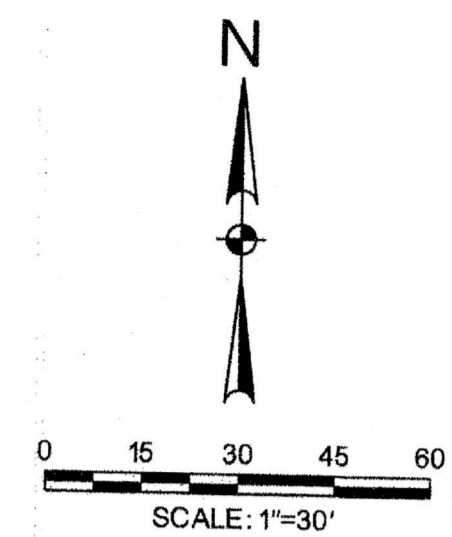

LOCATION MAP
N.T.S.

CITY OF DALLAS
BLOCK 8166

ARMSTRONG ADDITION
VOL 79050 PG 1857

CELESTIAL ROAD

BM#1

FND 'X'

1/2" F.I.R.

3/8" F.I.R.

GARAGE

5656 CELESTIAL ROAD
FF-5562.32

LOT 1, BLOCK 1
DASEKE ADDITION
(VOL. 97041, PG. 2221)

100-YR FLOOD PLAIN
WS ELEV. = 656.55

15' SEWER ESMT.
(VOL. 70152, PG. 680)
ESMT. STRIP NO. 1

DRAINAGE EASEMENT
(VOL. 97041, PG. 2221)

15' SEWER ESMT. (VOL. 10152, PG. 680)
ESMT. STRIP NO. 2

15' SEWER ESMT.
(VOL. 91184, PG. 4870)

JEFFERSON OAKS ADDITION
PHASE TWO
VOL 94027 PG 6910

- NOTES:
1. PROPERTY LINES ARE SHOWN FOR REFERENCE ONLY AND ARE INTENDED TO SHOW THE APPROXIMATE LOCATION OF THE IMPROVEMENTS AND TOPOGRAPHY RELATIVE TO THE DEED LINE.
 2. DRIVEWAY, TREES AND OTHER SITE FEATURES NOT SHOWN.

LOT 1B BLOCK B/8166
JEFFERSON OAKS ADDITION
VOL 93185 PG 1518

BENCHMARKS:

1. (ON-SITE)
'X' CUT ON THE NORTH SIDE OF CELESTIAL ROAD AND EAST SIDE OF WINWOOD RD. ELEV. = 568.70
2. (OFF-SITE, CITY OF ADDISON)
SQUARE CUT ON INLET 400' +/- SOUTH OF BELT LINE ROAD, EAST SIDE OF LANDMARK BLVD. ELEV. = 638.13

LEGEND:

- 570 --- EXISTING CONTOUR
- 100-YR. WATER SURFACE ELEV.
- NG 559.11 + NATURAL GROUND ELEVATION
- WD 562.03 + WOODEN DECK ELEVATION

REVISED FOR PERMIT AND CONSTRUCTION
09-27-2010

TOPOGRAPHIC SURVEY
PART OF
LOT 1, BLOCK 1
DASEKE ADDITION

AN ADDITION TO THE
CITY OF ADDISON, TEXAS
THOMAS GARVIN SURVEY, ABSTRACT NO. 524
DALLAS COUNTY, TEXAS


FOR
DON R. DASEKE

5656 CELESTIAL ROAD, ADDISON, TEXAS 75248



BY
TBPE FIRM #F-312
1201 NORTH BOWSER ROAD
RICHARDSON, TEXAS 75081-2275
TEL (214) 346-8200
FAX (214) 739-0095

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CITY OF DALLAS
BLOCK 8166
ARMSTRONG ADDITION
VOL 79050 PG 1857

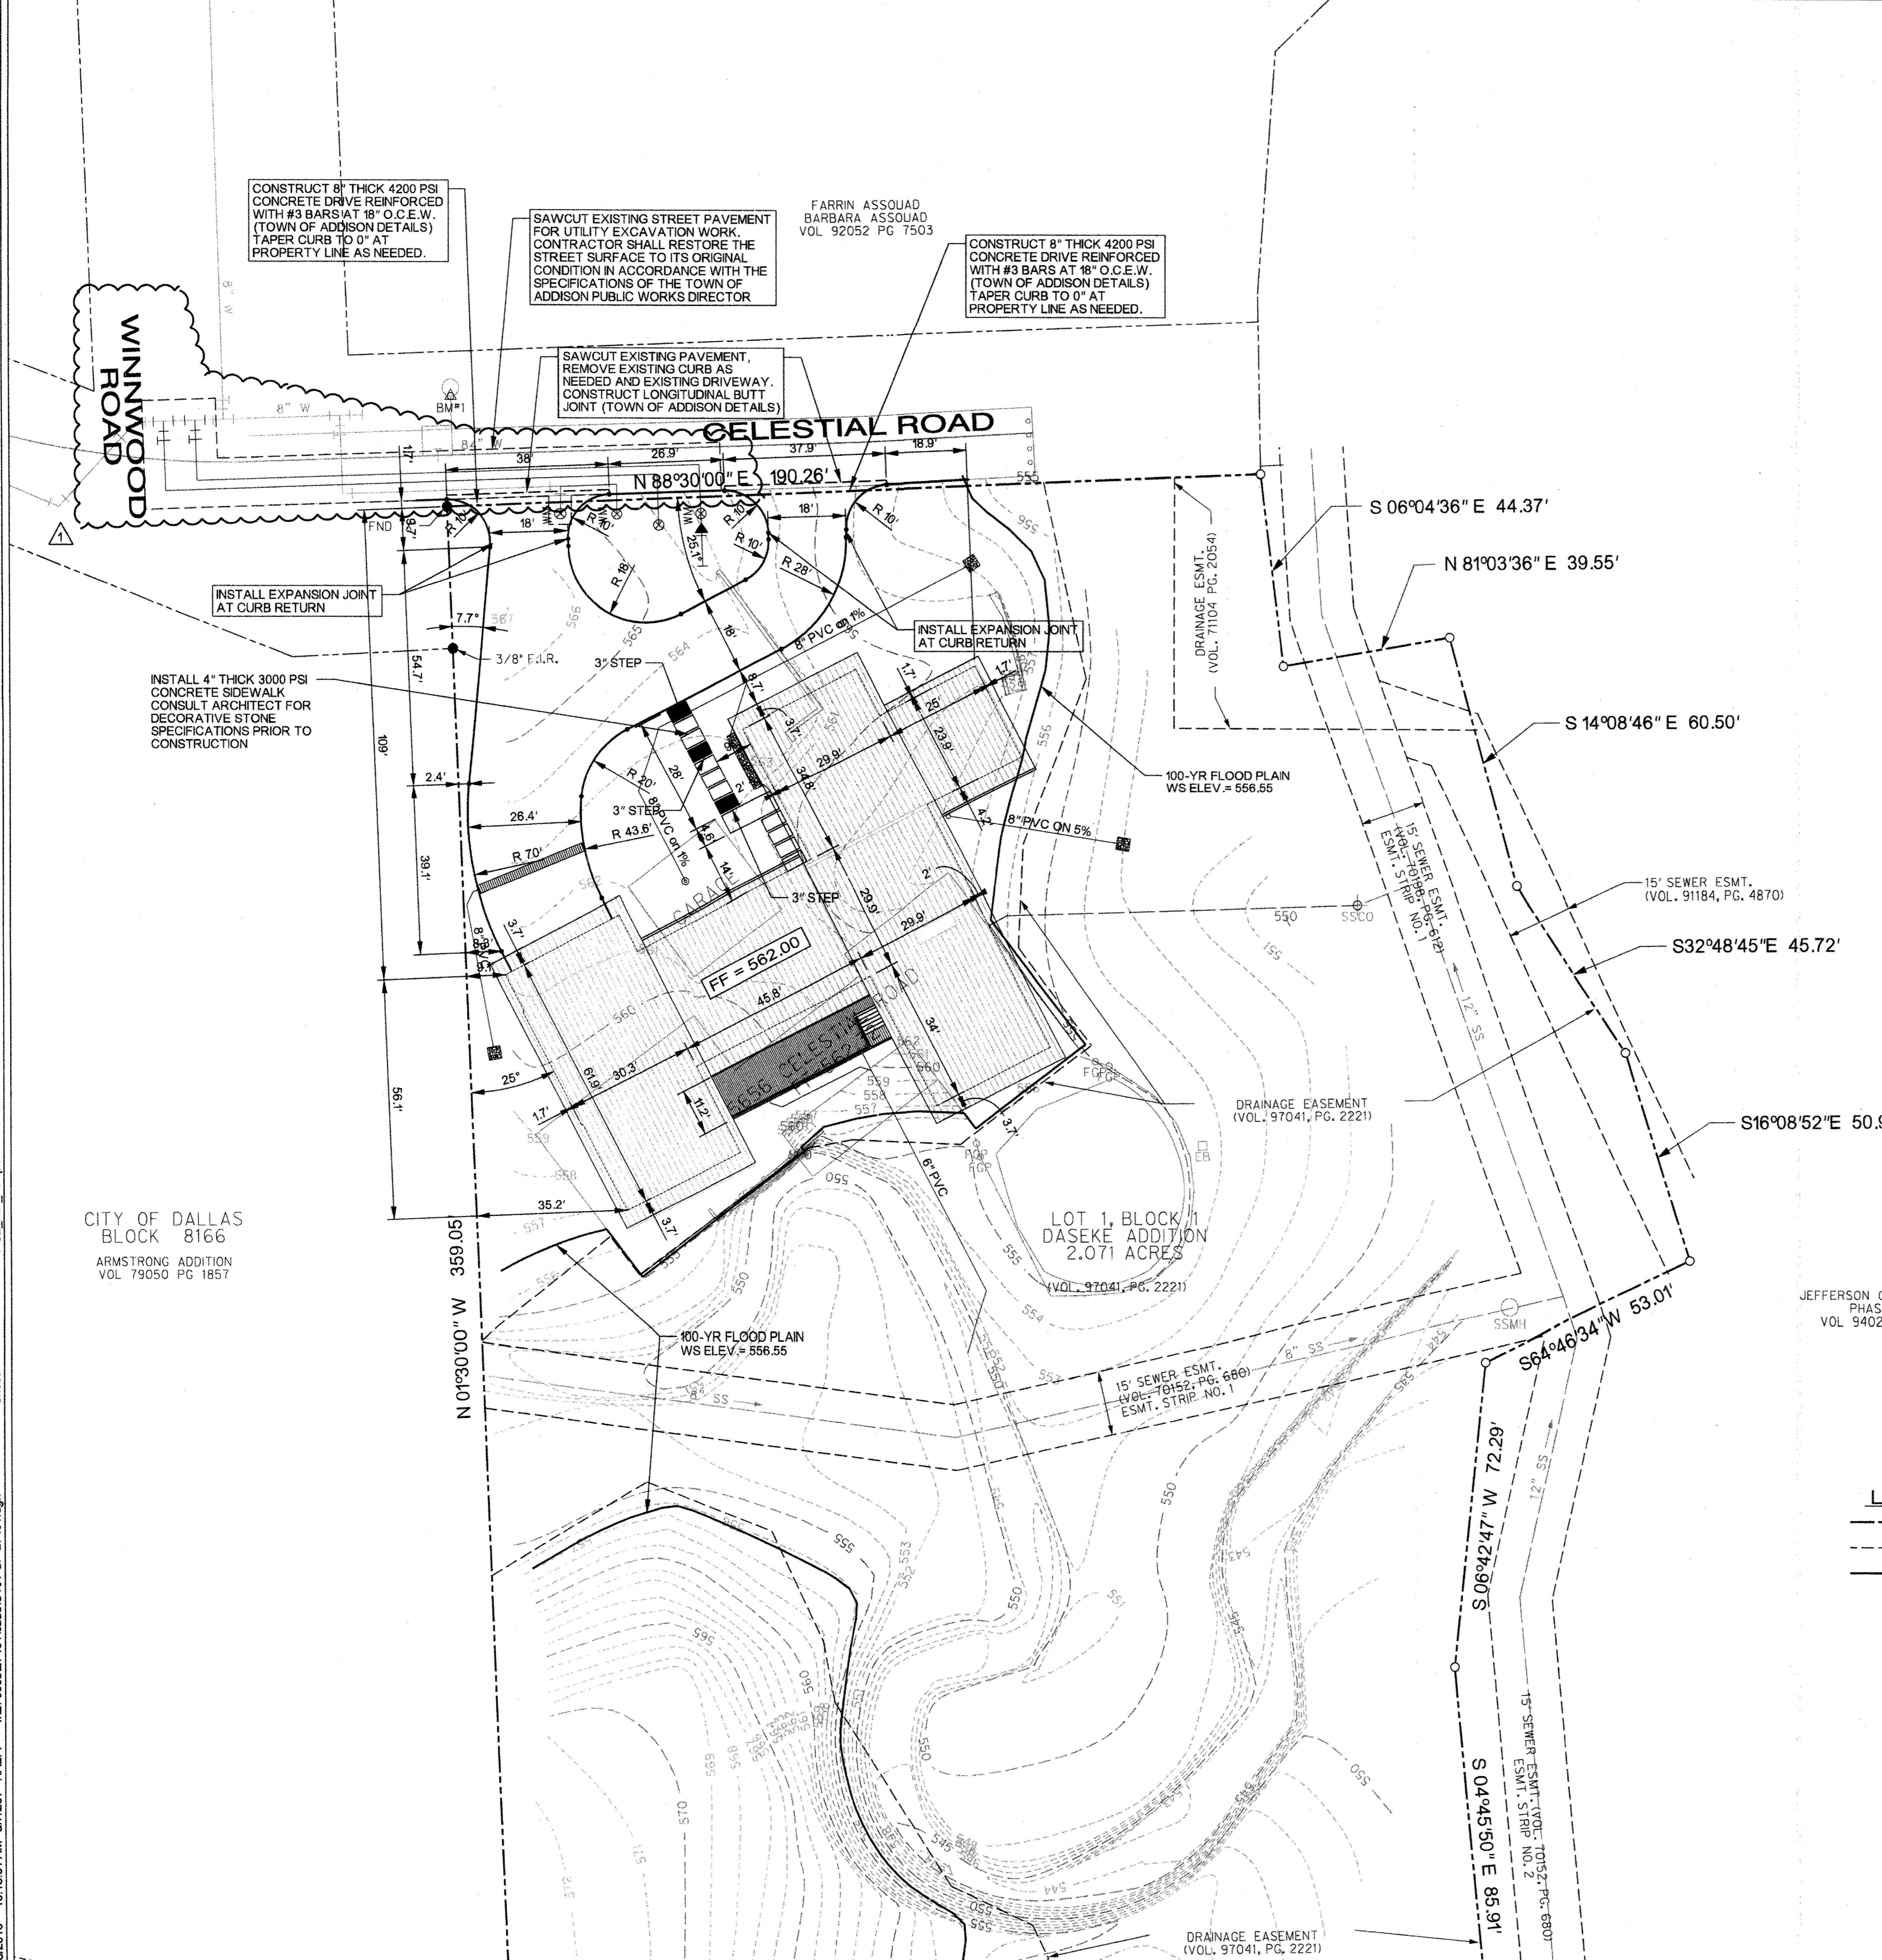FARRIN ASSOJAD
BARBARA ASSOJAD
VOL 92052 PG 7503

CONSTRUCT 8" THICK 4200 PSI
CONCRETE DRIVE REINFORCED
WITH #3 BARS AT 18" O.C.E.W.
(TOWN OF ADDISON DETAILS)
TAPER CURB TO 0" AT
PROPERTY LINE AS NEEDED.

SAWCUT EXISTING STREET PAVEMENT
FOR UTILITY EXCAVATION WORK.
CONTRACTOR SHALL RESTORE THE
STREET SURFACE TO ITS ORIGINAL
CONDITION IN ACCORDANCE WITH THE
SPECIFICATIONS OF THE TOWN OF
ADDISON PUBLIC WORKS DIRECTOR

CONSTRUCT 8" THICK 4200 PSI
CONCRETE DRIVE REINFORCED
WITH #3 BARS AT 18" O.C.E.W.
(TOWN OF ADDISON DETAILS)
TAPER CURB TO 0" AT
PROPERTY LINE AS NEEDED.

SAWCUT EXISTING PAVEMENT,
REMOVE EXISTING CURB AS
NEEDED AND EXISTING DRIVEWAY.
CONSTRUCT LONGITUDINAL BUTT
JOINT (TOWN OF ADDISON DETAILS)

INSTALL EXPANSION JOINT
AT CURB RETURN

INSTALL EXPANSION JOINT
AT CURB RETURN

INSTALL 4" THICK 3000 PSI
CONCRETE SIDEWALK
CONSULT ARCHITECT FOR
DECORATIVE STONE
SPECIFICATIONS PRIOR TO
CONSTRUCTION

100-YR FLOOD PLAIN
WS ELEV. = 566.55


100-YR FLOOD PLAIN
WS ELEV. = 566.55

LOT 1, BLOCK 1
DASEKE ADDITION
2.071 ACRES
(VOL. 97041, PG. 2221)

15" SEWER ESMT.
(VOL. 70152, PG. 666)
ESMT. STRIP NO. 1

15" SEWER ESMT.
(VOL. 70152, PG. 680)
ESMT. STRIP NO. 2

DRAINAGE EASEMENT
(VOL. 97041, PG. 2221)

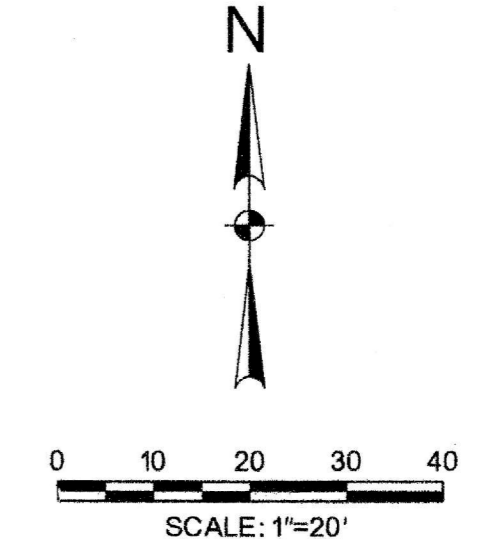

GENERAL NOTES:

- Contractor is responsible for, and must obtain prior to construction, all necessary construction permits required by the Town of Addison.
- The Contractor shall abide by all applicable federal, state, and local laws governing excavation. The Contractor shall provide detailed plans and specifications for trench safety systems that comply with applicable laws governing excavation. These plans shall be sealed by an Engineer experienced in the design of trench safety systems and licensed by the State of Texas. Submit plan to the Owner prior to commencing work. The Contractor shall be solely responsible for all aspects of work related to excavation.
- Existing utility locations shown are taken from available records provided by the utility Owner and field locations of surface appurtenances. Locations shown are generally schematic in nature and may not accurately reflect the size and location of each particular utility. Some utility lines may not be shown. Contractor shall assume responsibility for actual field location and protection of existing facilities whether shown or not. Contractor shall also assume responsibility for repairs to existing facilities, whether shown or not, damaged by contractor's activities. Differences in horizontal or vertical location of existing utilities shall not be a basis for additional expense.
- Contractor shall locate and adjust existing utility manhole lids, cleanouts, water valves and other surface appurtenances as required for new construction. Contractor shall coordinate utility adjustments with other disciplines and the appropriate utility agencies and provide for all fees for permits, connections, inspections, etc.
- The Contractor shall protect existing property monumentation and primary control. Any such points which the Contractor believes will be destroyed shall have offset points established by the Contractor prior to construction. Any monumentation destroyed by the Contractor shall be reestablished at his expense.
- Barricading and traffic control during construction shall be the responsibility of the Contractor and shall conform to the "Texas Manual on Uniform Traffic Control Devices", Part VI in particular. Traffic flow and access shall be maintained during all phases of the construction. The Contractor is responsible for providing traffic safety measures for work on project.
- Onsite planimetric and topographic mapping taken from data provided by Half Associates, dated October 2009. Boundary data taken from Survey by Half Associates, dated October 2009.
- Any damages that may occur to real property or existing improvements shall be restored by the Contractor to at least the same condition that the real property or existing improvements were in prior to the damages. This restoration shall be subject to the Owner's approval; moreover, this restoration shall not be a basis for additional compensation to the Contractor. Restoration shall include, but not be limited to, regrading, revegetation, replacing fences, replacing trees, etc.
- It shall be the responsibility of the Contractor to:
 - Prevent any damage to private property and property owner's poles, fences, shrubs, etc.
 - Provide access to all drives during construction.
 - Protect all underground utilities to remain in service.
 - Notify all utility companies and verify location of all utilities prior to start of construction.
- Contractor shall maintain positive drainage at all time during construction. Ponding of water in streets, drives, truck courts, trenches, etc. will not be allowed.
- Contractor shall maintain existing sanitary sewer and water service at all times during construction.
- Pavement removal and repair shall conform to the Town of Addison requirements in code of ordinances. All sawcuts shall be full depth cuts. Contractor shall make efforts to protect concrete and/or asphalt edges. Any large spalled or broken edges shall be removed by sawcutting pavement prior to replacement.
- Contractor's work shall include pavement removal and disposal required for new walk, drive, curb, gutter and other grading features. Contractor shall be responsible for all coordination, inspection and testing required by the Owner and/or the Town of Addison.
- All sidewalks shall maintain 2% cross slope maximum.
- See Architect Plan for additional building dimensions and details.


LEGEND

---	PROPERTY LINE
- - - -	EASEMENT LINE
---	100-YR FLOOD PLAIN LINE


- NOTES**
- SHOWN PARCEL ZONED FOR RESIDENTIAL.
 - NO REMOVAL OF SIGNIFICANT TREES WITHOUT PRIOR NOTIFICATION TO OWNER, ARCHITECT AND ENGINEER.
 - STORM DRAIN, SANITARY SEWER, AND FIRE LOOP SYSTEMS ARE PRIVATE. DOMESTIC WATER IS PRIVATE AFTER METER AND FIRE SUPPLY IS PRIVATE AFTER DOUBLE DETECTOR CHECK VALVE.

- BENCHMARKS**
- (ON-SITE)
"X" CUT ON THE NORTH SIDE OF CELESTIAL ROAD AND EAST SIDE OF WINWOOD RD. ELEV. = 568.70
 - (OFF-SITE, CITY OF ADDISON)
SQUARE CUT ON INLET 400' +/- SOUTH OF BELT LINE ROAD, EAST SIDE OF LANDMARK BLVD. ELEV. = 638.13

DASEKE RESIDENCE
5656 CELESTIAL ROAD
CITY OF ADDISON, TEXAS


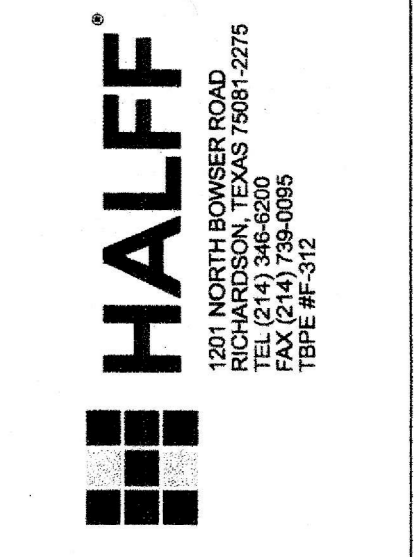


Revision	No.	Date	Description
	1	09-27-2010	Rev. for Permit and Construction

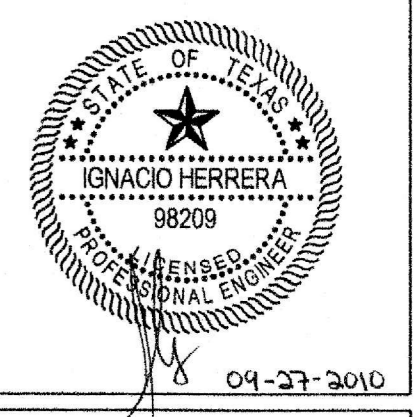


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Project No.:	27431
Issued:	MAY 2010
Drawn By:	CAD
Checked By:	IH
Scale:	AS NOTED
Sheet Title	PAVING & DIMENSION CONTROL PLAN
Sheet Number	C1.01

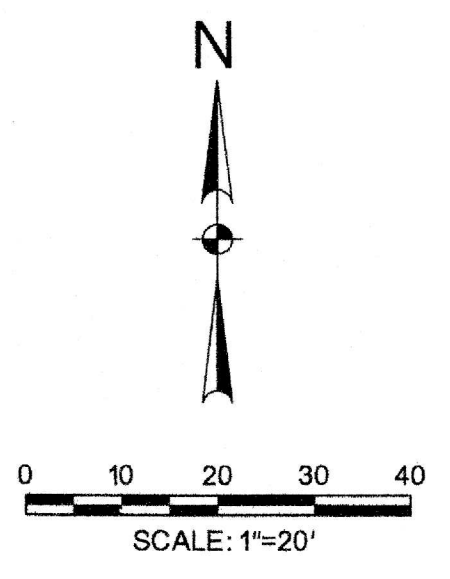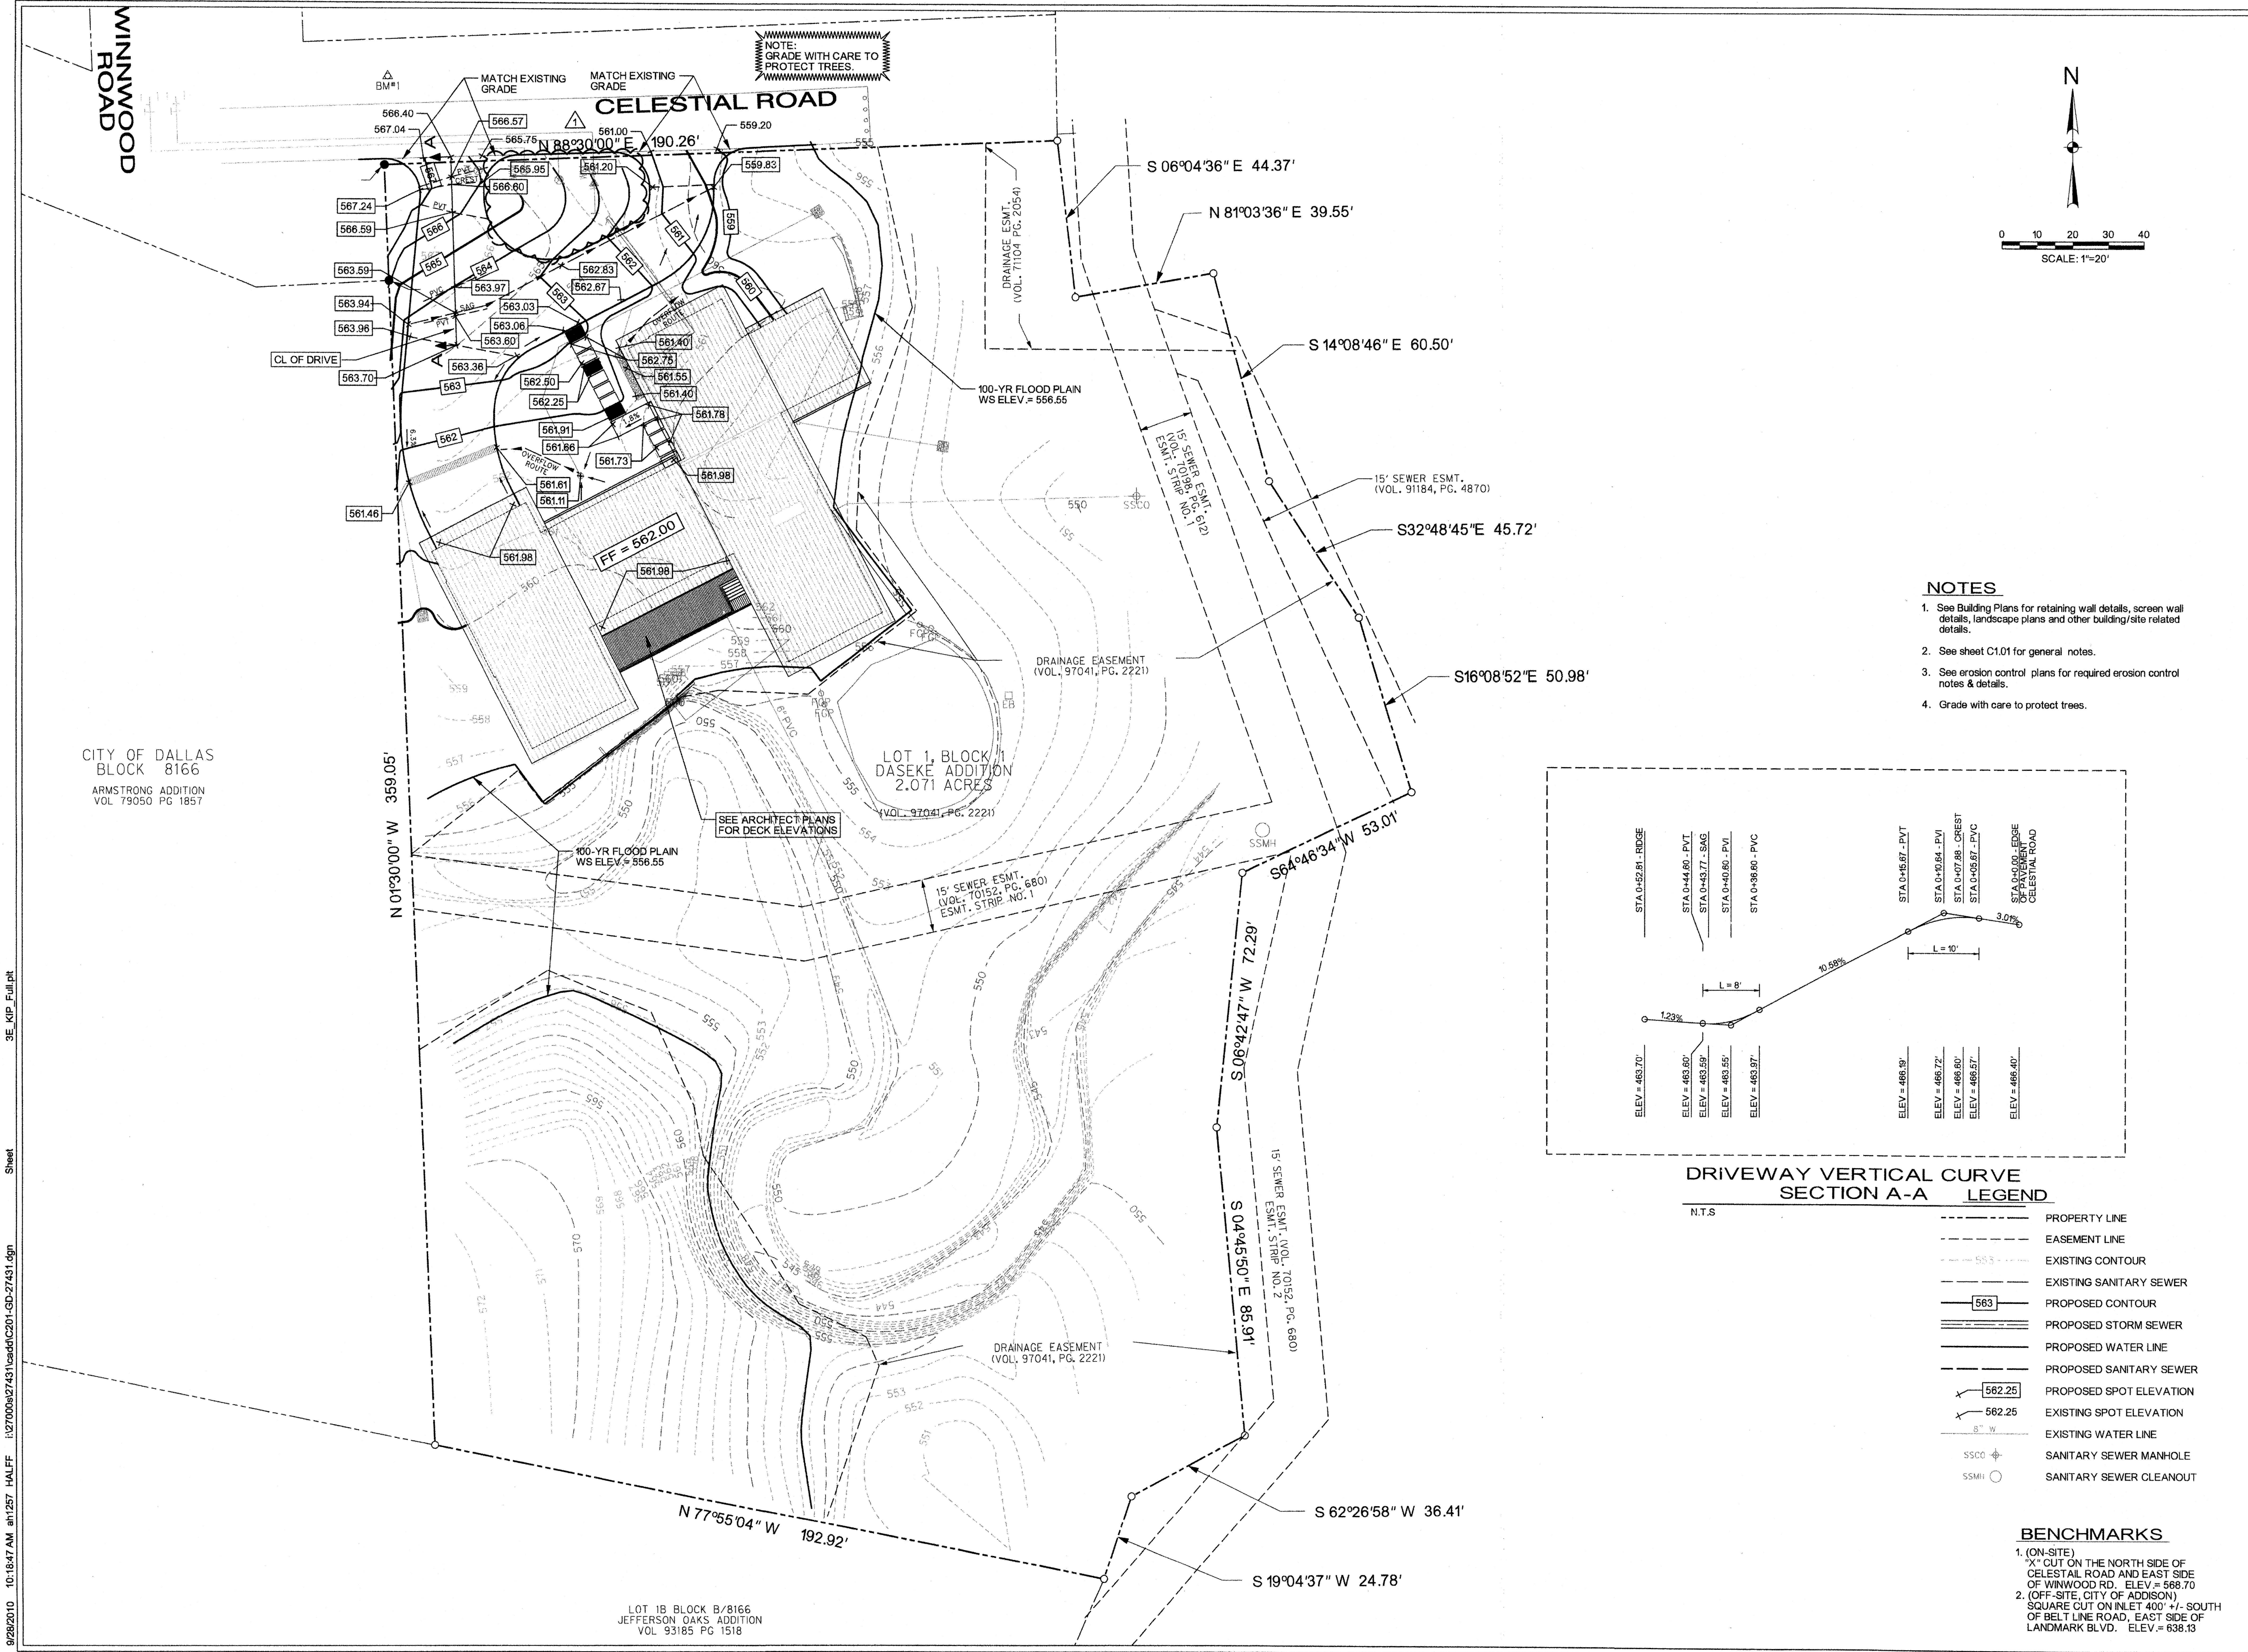

NOTES

1. See Building Plans for retaining wall details, screen wall details, landscape plans and other building/site related details.
2. See sheet C1.01 for general notes.
3. See erosion control plans for required erosion control notes & details.
4. Grade with care to protect trees.

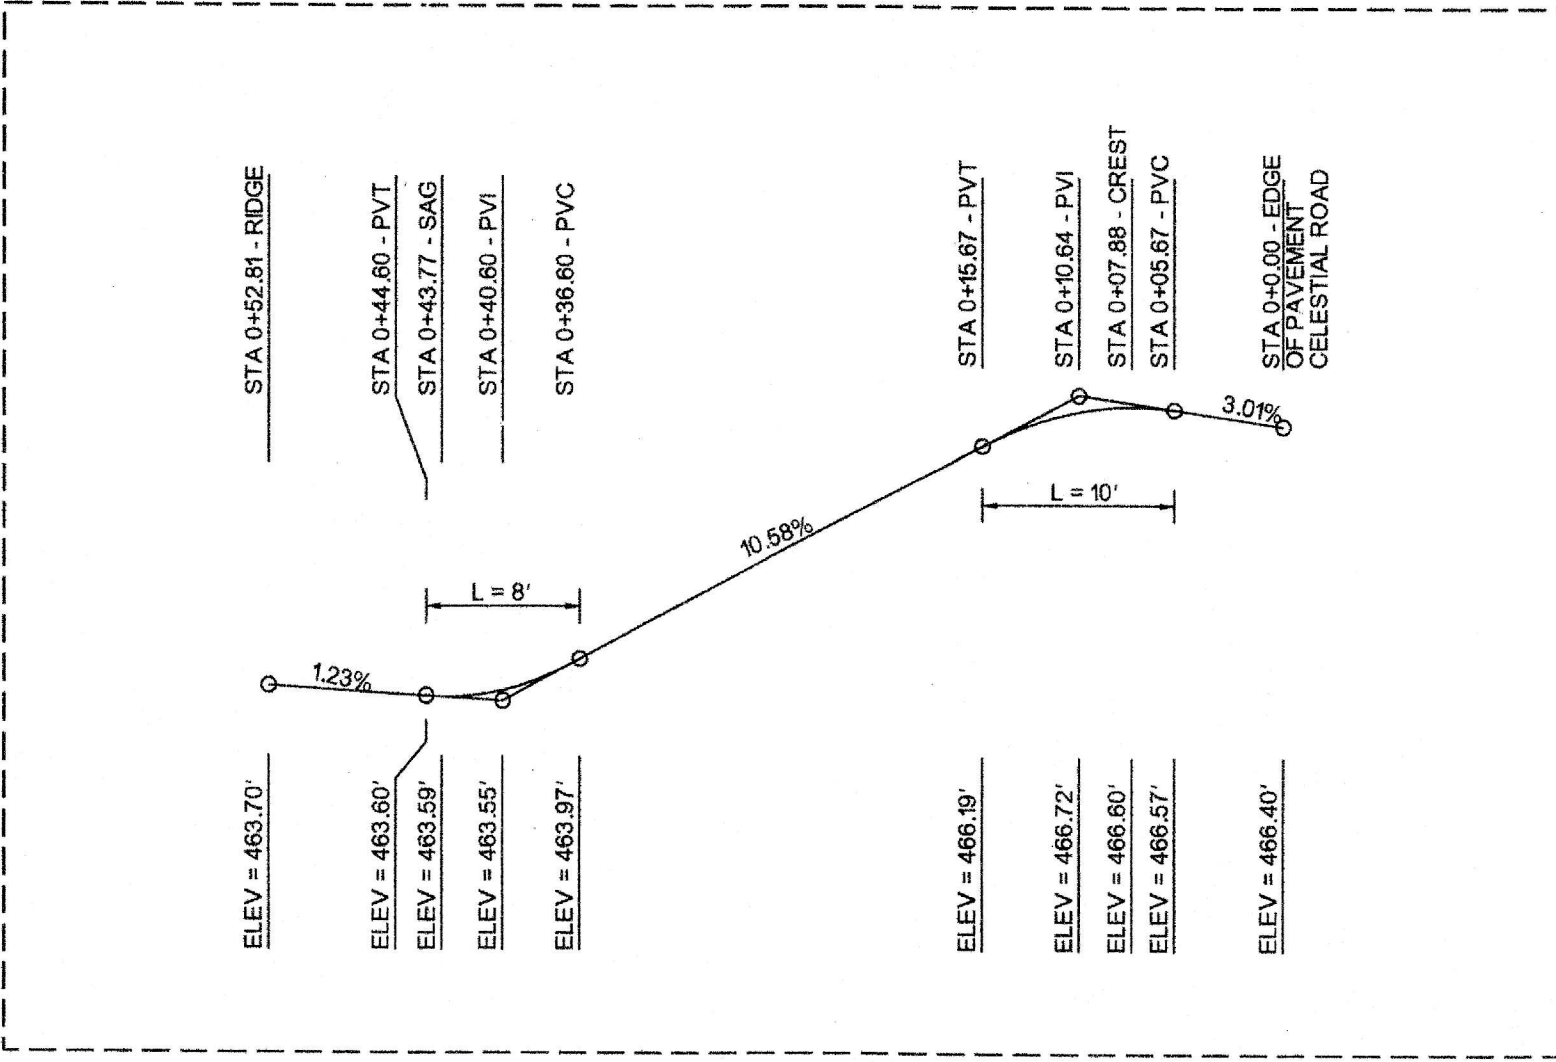


DRIVEWAY VERTICAL CURVE SECTION A-A LEGEND

- N.T.S.
- PROPERTY LINE
 - - - EASEMENT LINE
 - EXISTING CONTOUR
 - EXISTING SANITARY SEWER
 - PROPOSED CONTOUR
 - PROPOSED STORM SEWER
 - PROPOSED WATER LINE
 - PROPOSED SANITARY SEWER
 - 562.25 PROPOSED SPOT ELEVATION
 - 562.25 EXISTING SPOT ELEVATION
 - EXISTING WATER LINE
 - SSC SANITARY SEWER MANHOLE
 - SSC SANITARY SEWER CLEANOUT

BENCHMARKS

1. (ON-SITE) 'X' CUT ON THE NORTH SIDE OF CELESTIAL ROAD AND EAST SIDE OF WINWOOD RD. ELEV = 568.70
2. (OFF-SITE, CITY OF ADDISON) SQUARE CUT ON INLET 400' +/- SOUTH OF BELT LINE ROAD, EAST SIDE OF LANDMARK BLVD. ELEV = 638.13

DASEKE RESIDENCE
 5656 CELESTIAL ROAD
 CITY OF ADDISON, TEXAS

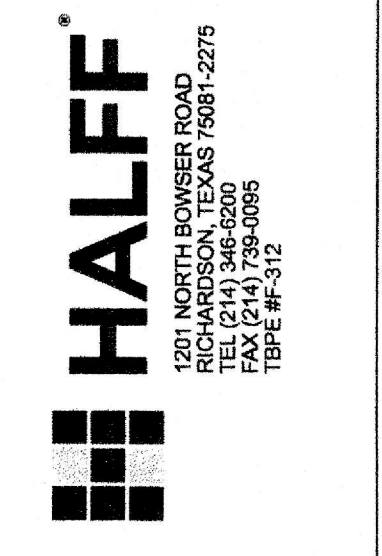

Revision No.	Date	Description
1	09-27-2010	Rev. for Permit and Construction



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Project No.:	27431
Issued:	MAY 2010
Drawn By:	CAD
Checked By:	IH
Scale:	AS NOTED

Sheet Title
GRADING PLAN



Sheet Number
C2.01

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WINWOOD ROAD

CELESTIAL ROAD

NOTE:
GRADE WITH CARE TO
PROTECT TREES.

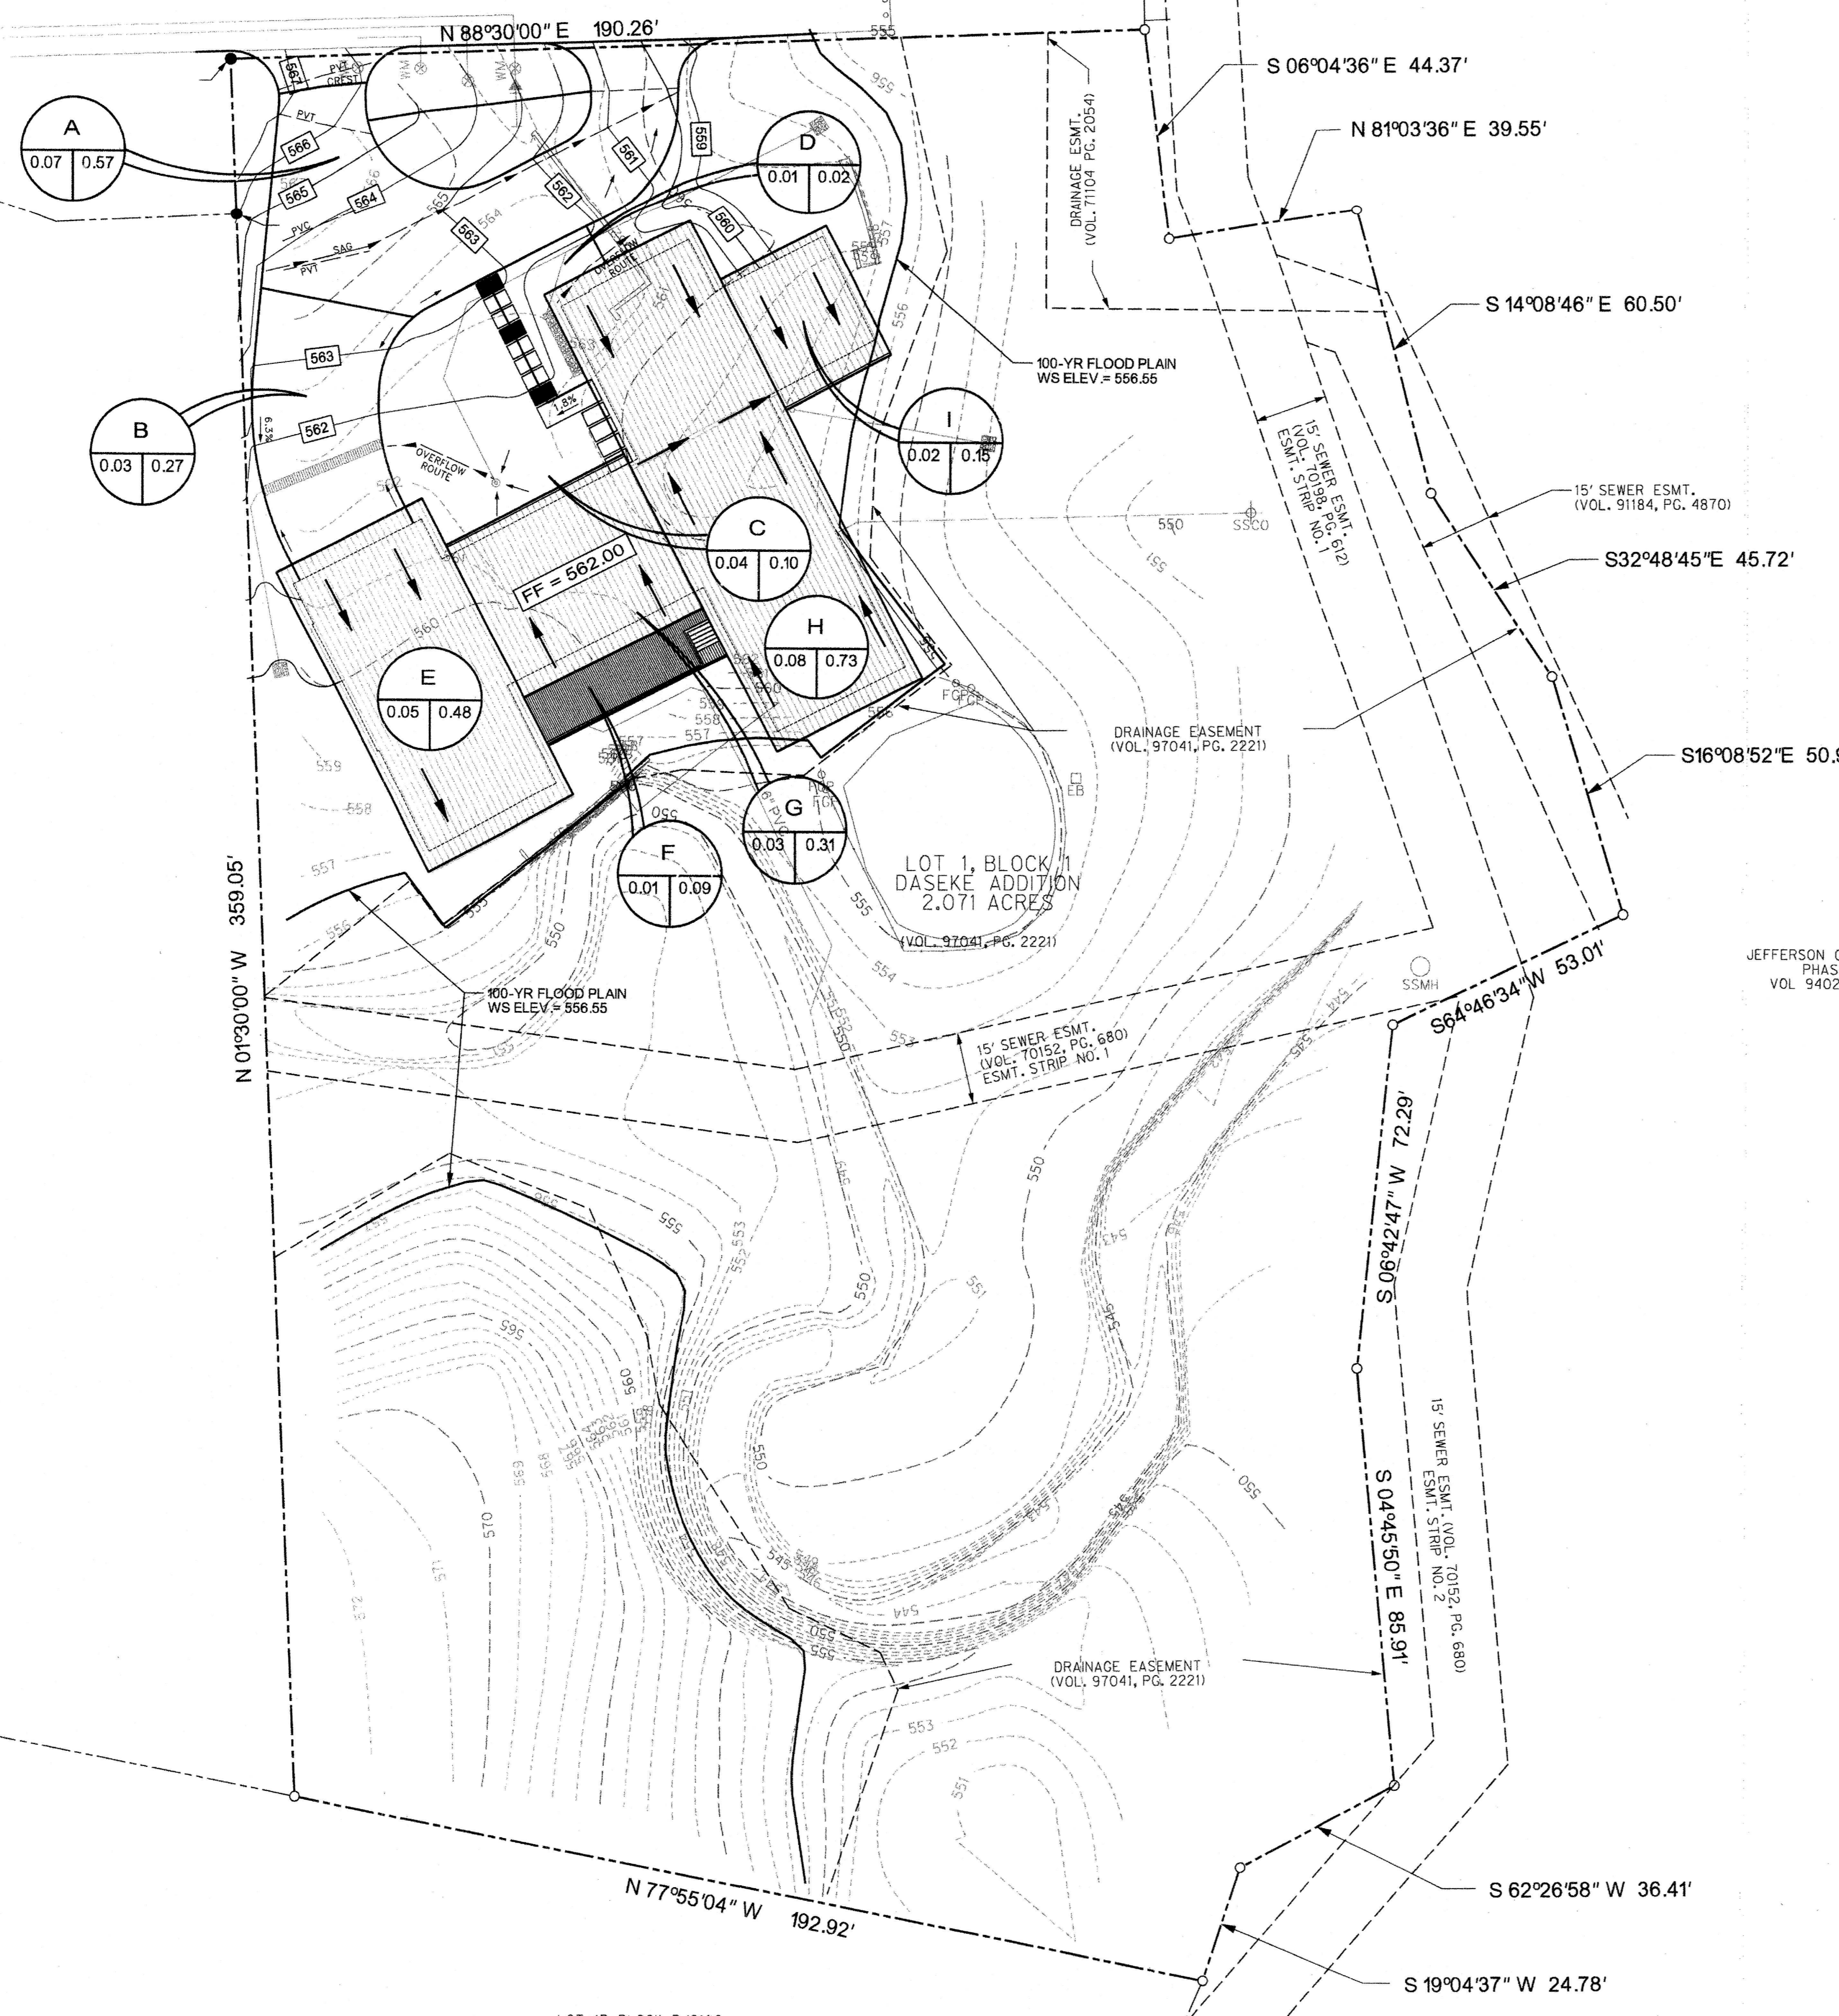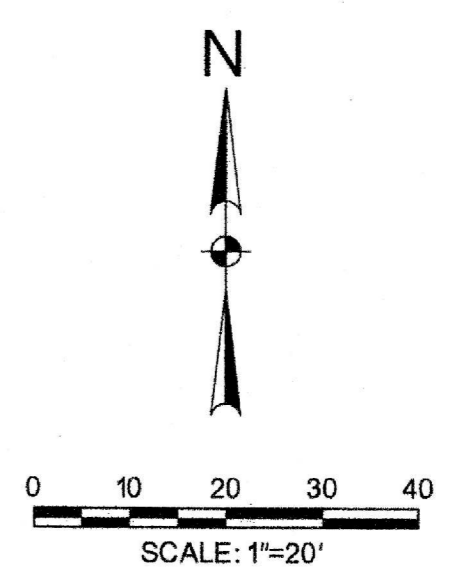


CITY OF DALLAS
BLOCK 8166
ARMSTRONG ADDITION
VOL. 79050 PG 1857

NOTES

1. See Building Plans for retaining wall details, screen wall details, landscape plans and other building/site related details.
2. See sheet C1.01 for general notes.
3. See erosion control plans for required erosion control notes & details.
4. Grade with care to protect trees.

DRAINAGE AREA DESIGN CRITERIA

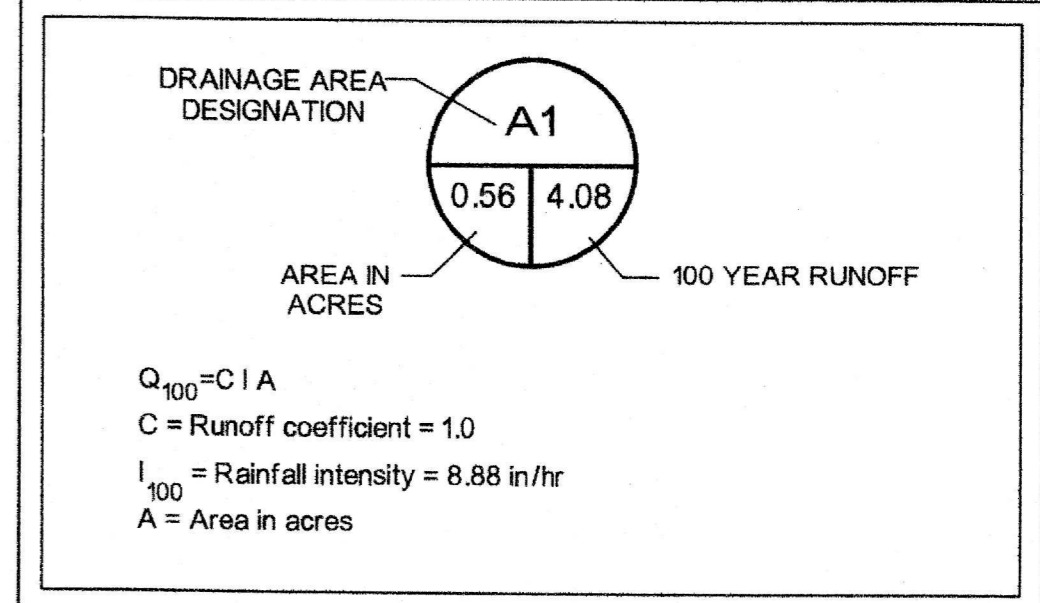


- PROPERTY LINE
- - - EASEMENT LINE
- - - EXISTING CONTOUR
- - - EXISTING SANITARY SEWER
- PROPOSED CONTOUR
- PROPOSED STORM SEWER
- PROPOSED WATER LINE
- PROPOSED SANITARY SEWER
- 582.25 PROPOSED SPOT ELEVATION
- 582.25 EXISTING SPOT ELEVATION
- R" W EXISTING WATER LINE
- SSCO SANITARY SEWER MANHOLE
- SSMH SANITARY SEWER CLEANOUT


BENCHMARKS

1. (ON-SITE)
"X" CUT ON THE NORTH SIDE OF CELESTIAL ROAD AND EAST SIDE OF WINWOOD RD. ELEV = 568.70
2. (OFF-SITE, CITY OF ADDISON)
SQUARE CUT ON INLET 400' +/- SOUTH OF BELT LINE ROAD, EAST SIDE OF LANDMARK BLVD. ELEV = 638.13

DASEKE RESIDENCE
5656 CELESTIAL ROAD
CITY OF ADDISON, TEXAS

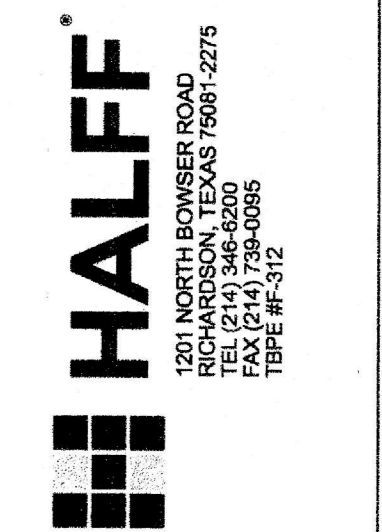

Revision No.	Date	Description	Rev. for Permit and Construction
1	09-27-2010		

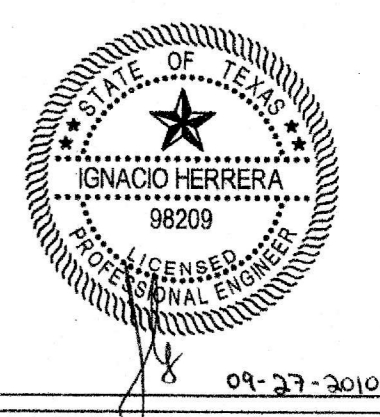

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Project No.: 27431
Issued: MAY 2010
Drawn By: CAD
Checked By: IH
Scale: AS NOTED


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DRAINAGE AREA MAP

C2.02
Sheet Number


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LOT 1B BLOCK B/8166
JEFFERSON OAKS ADDITION
VOL. 93185 PG 1518

DASEKE RESIDENCE
5656 CELESTIAL ROAD
 CITY OF ADDISON, TEXAS

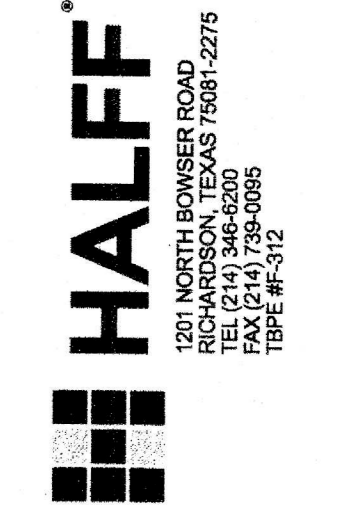


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Project No.:	27431
Issued:	MAY 2010
Drawn By:	CAD
Checked By:	IH
Scale:	AS NOTED
Sheet Title	UTILITY PLAN

C3.01
 Sheet Number

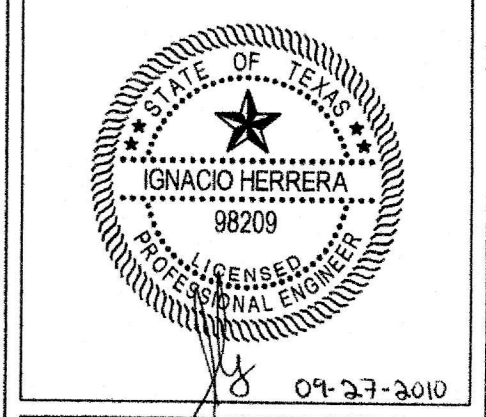


- NOTES**
- CONTRACTOR TO CONTACT TOWN OF ADDISON FINANCE DEPARTMENT AT 972-450-7082 TO DISCONNECT WATER SERVICE PRIOR TO DEMOLITION OF EXISTING STRUCTURE.
 - ALL WORK SHALL BE COMPLETED TO TOWN OF ADDISON REQUIREMENTS.
 - ADJUST UTILITY LOCATION TO MINIMIZE TREE IMPACTS. CONTACT ENGINEER AS NEEDED.
 - CONTRACTOR TO CONTACT DALLAS WATER UTILITIES TO MARK 84" WATER LINE.
 - ALL WATER MAIN MATERIALS SHALL BE IN ACCORDANCE WITH THE TOWN OF ADDISON WATER SYSTEM REQUIREMENTS.

LEGEND

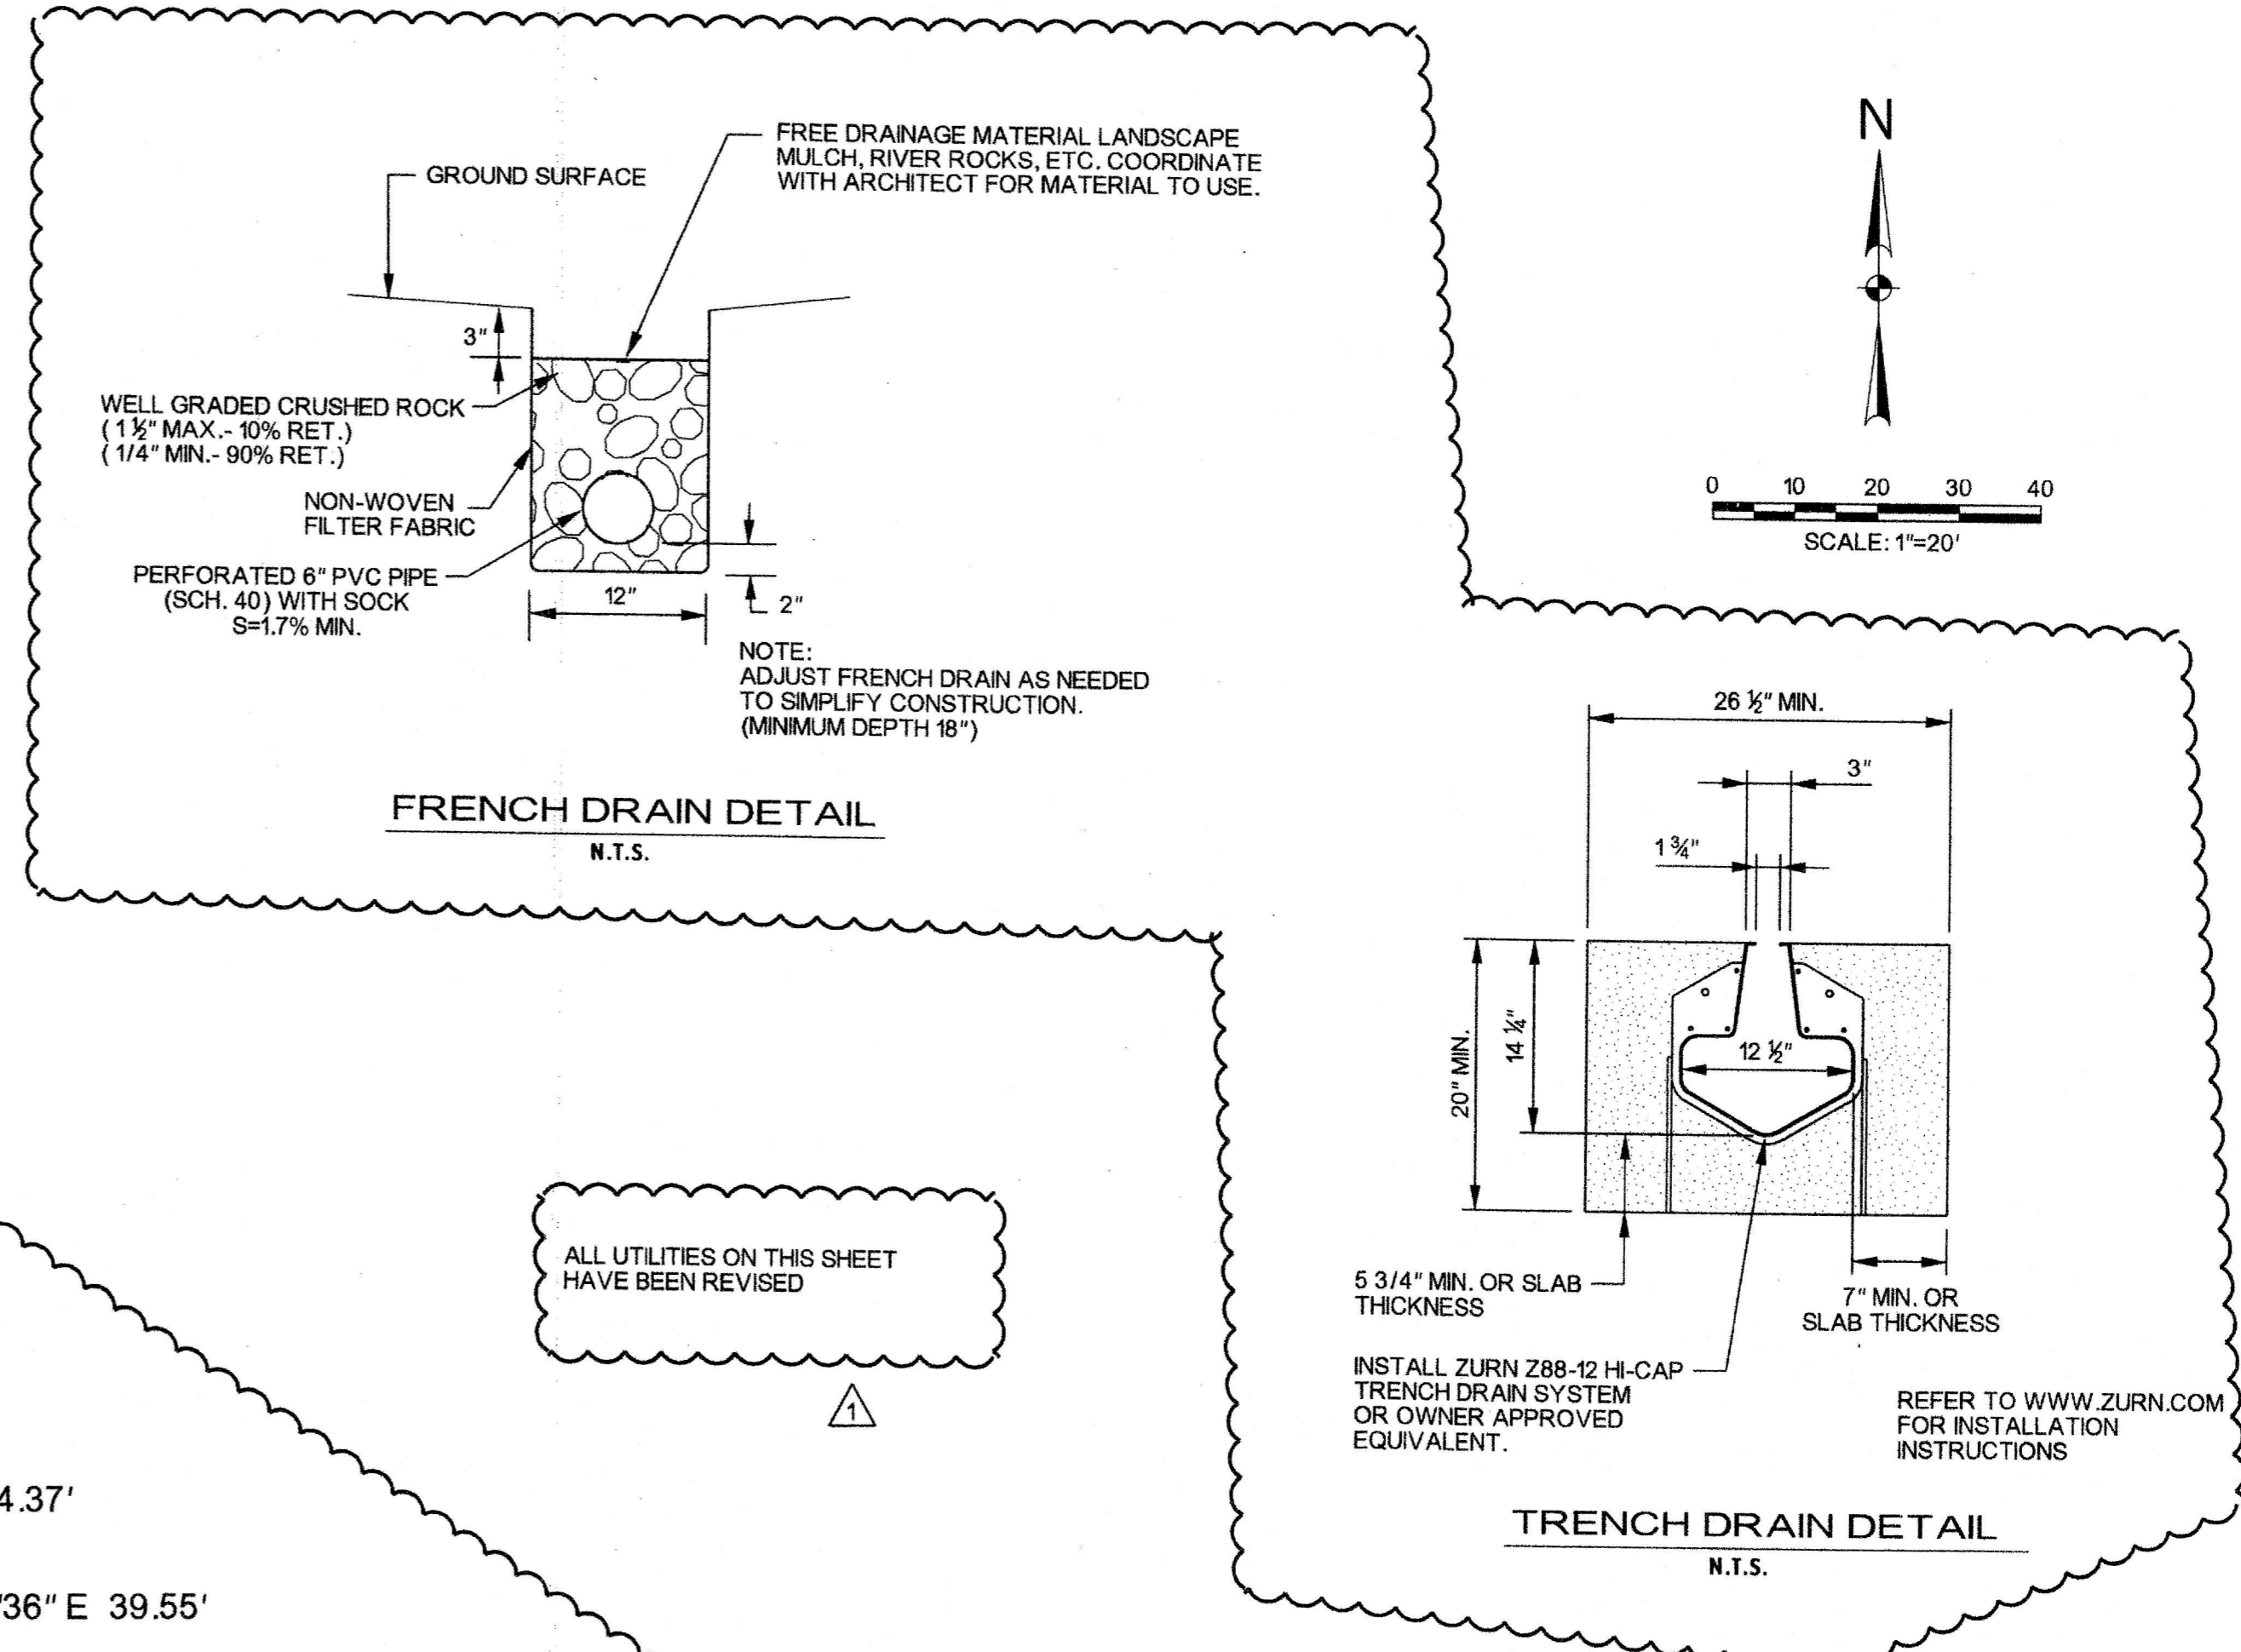---	PROPERTY LINE
- - - -	EASEMENT LINE
- - - -	EXISTING CONTOUR
- - - -	EXISTING SANITARY SEWER
---	PROPOSED CONTOUR
---	PROPOSED STORM SEWER
---	PROPOSED WATER LINE
---	PROPOSED SANITARY SEWER
562.25	PROPOSED SPOT ELEVATION
562.25	EXISTING SPOT ELEVATION
8" W	EXISTING WATER LINE
SSCO	SANITARY SEWER MANHOLE
SSMH	SANITARY SEWER CLEANOUT


- BENCHMARKS**
- (ON-SITE) "X" CUT ON THE NORTH SIDE OF CELESTIAL ROAD AND EAST SIDE OF WINWOOD RD. ELEV = 568.70
 - (OFF-SITE, CITY OF ADDISON) SQUARE CUT ON INLET 400' +/- SOUTH OF BELT LINE ROAD, EAST SIDE OF LANDMARK BLVD. ELEV = 638.13

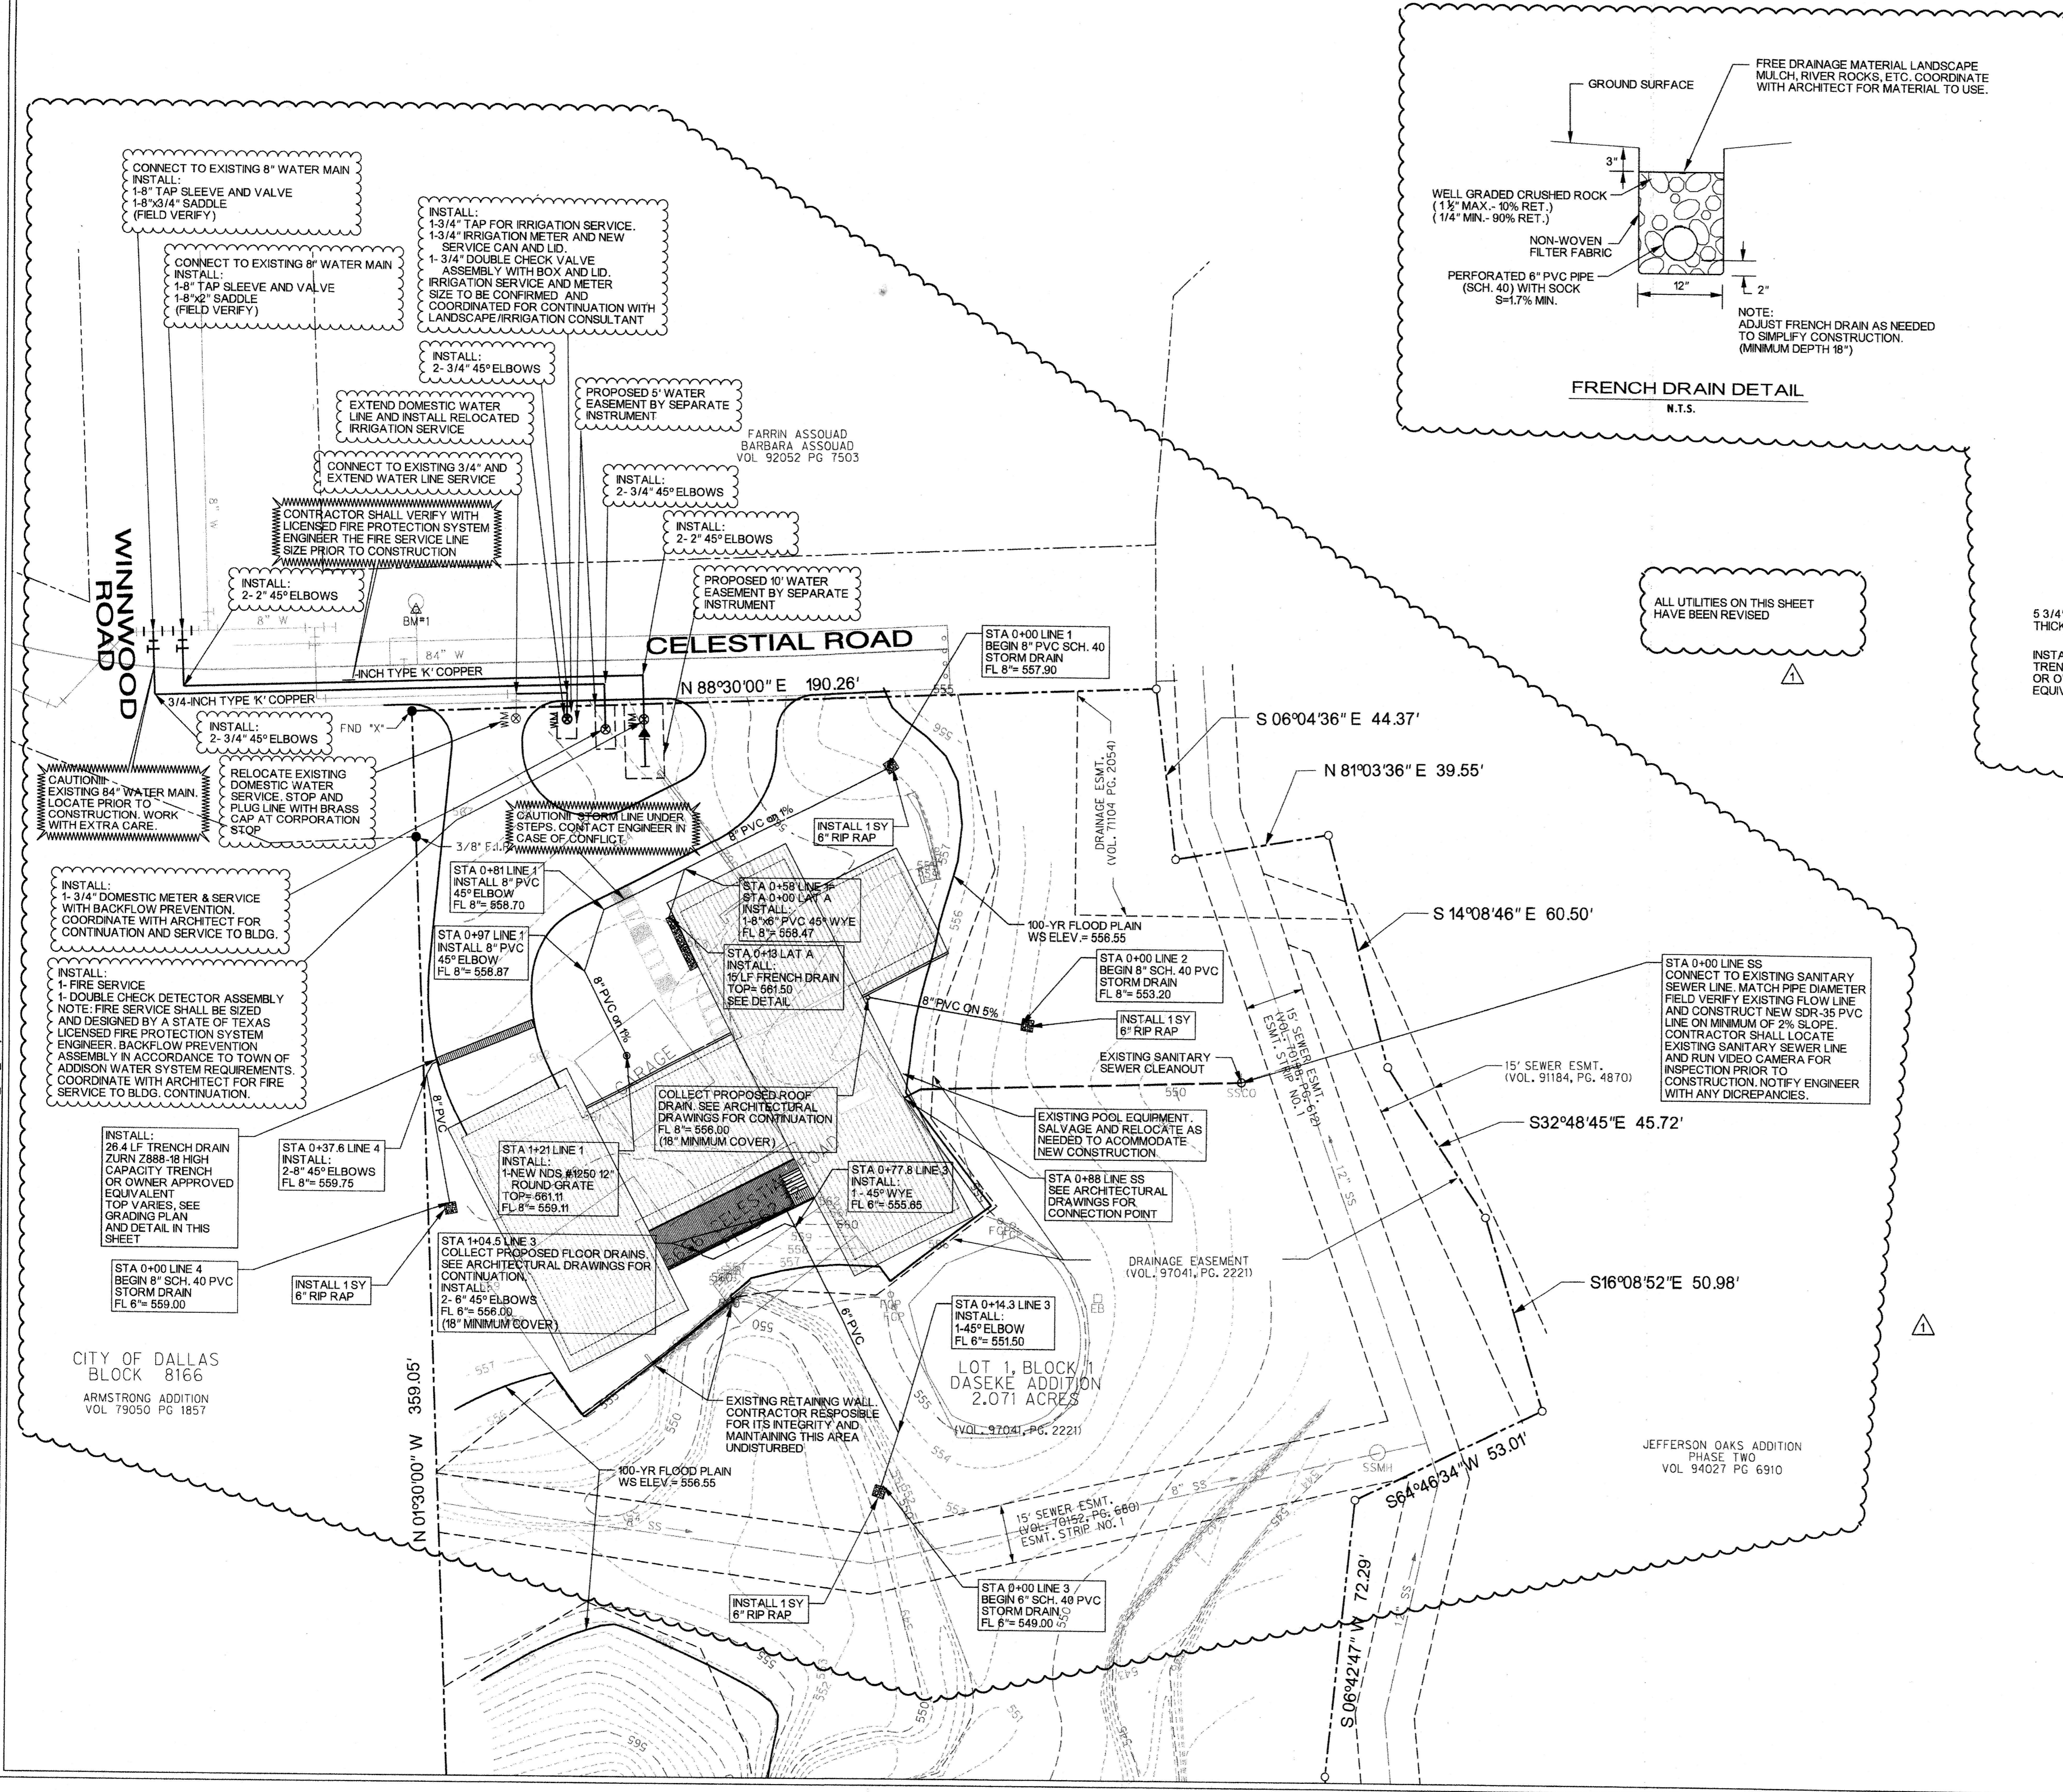

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WINNWOOD ROAD

CELESTIAL ROAD

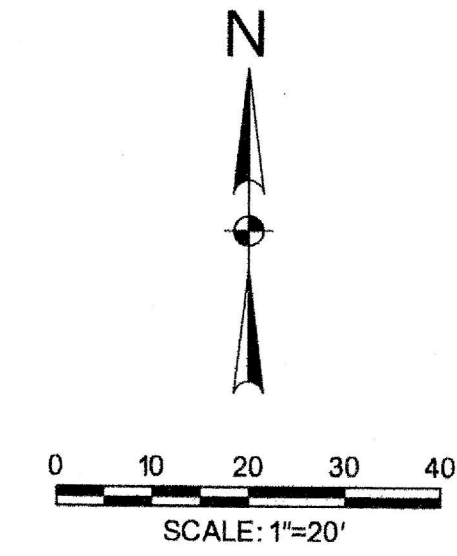

DASEKE RESIDENCE
5656 CELESTIAL ROAD
CITY OF ADDISON, TEXAS



1201 NORTH BOWSER ROAD
IRVING, TEXAS 75038-2275
TEL: (972) 258-0300
FAX: (214) 739-0055
TBB# 01512

CITY OF DALLAS
BLOCK 8166
ARMSTRONG ADDITION
VOL. 79050 PG. 1857

INSTALL POLYPROPYLENE MESH TUBE WATTLING DEVICE

INSTALL STABILIZED CONSTRUCTION ENTRANCE

INSTALL 630 LF OF SILT FENCE

INSTALL STONE OVERFLOW STRUCTURE

INSTALL STONE OVERFLOW STRUCTURE

INSTALL STONE OVERFLOW STRUCTURE

LOT 1B BLOCK B/8166
JEFFERSON OAKS ADDITION
VOL. 93185 PG. 1518

LOT 1, BLOCK DASEKE ADDITION
2.071 ACRES

JEFFERSON OAKS ADDITION
PHASE TWO
VOL. 94027 PG. 6910

LEGEND:

SILT FENCE ——— SF ———

STONE OVERFLOW STRUCTURE [Symbol]

Revision No.	Date	Description
1	09-27-2010	Rev. for Permit and Construction



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Project No.:	27431
Issued:	MAY 2010
Drawn By:	CAD
Checked By:	IH
Scale:	AS NOTED
Sheet Title	EROSION CONTROL PLAN
Sheet Number	C4.01

BENCHMARKS

1. (ON-SITE) 'X' CUT ON THE NORTH SIDE OF CELESTIAL ROAD AND EAST SIDE OF WINNWOOD RD. ELEV. = 568.70

2. (OFF-SITE, CITY OF ADDISON) SQUARE CUT ON INLET 400' +/- SOUTH OF BELT LINE ROAD, EAST SIDE OF LANDMARK BLVD. ELEV. = 638.13

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Erosion Control Notes

1. The Contractor is responsible for preparing and implementing a Storm Water Pollution Prevention Plan (SWP3) in accordance with TCEQ Texas Pollutant Discharge Elimination System (TPDES) Permit No. TXR150000 (PERMIT). The details shown on this sheet represent typical methods for controlling erosion during construction and are intended for the Contractor's guidance in preparing his Pollution Prevention Plan. The Contractor's plan shall comply with the PERMIT and Federal, State and local requirements. The Contractor's plan shall include, but not be limited to, preparation and submission of a Notice of Intent (NOI) to the TCEQ, if the project is 5 acres or larger and preparation of all plans and documentation as required by the PERMIT.

2. It is the intent of the information provided on these documents to be used as a general guideline for the Contractor. The SWP3 to be prepared by the Contractor shall meet the current requirements set forth in the TCEQ's TPDES general permit for storm water discharges from construction sites as well as any local requirements.

3. The Contractor shall be responsible for maintaining erosion control during construction and for obtaining any required construction related permits or making any construction related notifications. An inspection report that summarizes inspection activities and implementation of the SWP3 shall be performed as required by the PERMIT and retained by the Contractor and made a part of the construction documents. The Contractor shall provide copies of all SWP3 documents including, but not limited to, inspection records, original plans, and modified plans to the Owner at contract close-out. During construction the contractor shall provide copies of the inspection reports to the Owner on a monthly basis.

4. Temporary storm drainage and/or erosion control material shall be suitable for this application and shall be installed with the proper techniques by the Contractor as required by NCTCOG Standard Specifications for Public Works Construction. Temporary storm drainage and/or erosion control material shall be removed by the Contractor, in addition to any excavations backfilled by the Contractor, in accordance with NCTCOG Standard Specifications for Public Works Construction when temporary erosion control devices are no longer needed as specified in the PERMIT. Maintenance of the permanent erosion control measures at the site will be assumed by the Owner at contract close out and acceptance of the work.

5. The Contractor shall maintain his SWP3 in accordance with the TCEQ Permit and make his SWP3 available, upon request, to the TCEQ and/or Owner.

6. The Contractor must amend his SWP3 whenever there is a change in design, construction, operation, or maintenance of the SWP3, or when the existing SWP3 proves ineffective. Modifications shall not compromise the intent of the requirements of the PERMIT. Modifications including design and all additional materials and work shall be accomplished by the Contractor at no additional expense to the Owner.

7. The Contractor shall inspect his stabilization and erosion control measures at a minimum of once every 14 days, and within 24 hours after any storm event greater than 0.5 inches, or once every 7 days. The Contractor shall repair inadequacies revealed by the inspection before the next storm event and he shall modify his SWP3 within 7 days of the inspection.

8. The Contractor shall adopt and implement appropriate construction site management practices to prevent the discharge of oils, greases, paints, gasoline, and other pollutants to storm water. Appropriate practices shall include, but not be limited to: designating areas for equipment maintenance and repair; collecting wastes periodically; maintaining conveniently located waste receptacles; and designating and controlling equipment washdown.

9. Borrow areas, if excavated, shall be protected and stabilized by the Contractor in a manner acceptable to the Owner and in accordance with PERMIT requirements.



10. All non-paved areas shall be seeded and mulched with erosion protection grass by the Contractor immediately upon completion of final grading. This includes all ditches and embankments. The Contractor shall maintain final grading, and keep seeded areas watered until fully established and accepted by Owner.

11. The Contractor shall construct a silt fence at locations suggested on plans as appropriate or as modified in his SWP3 to fit site conditions at the time of placement, and all borrow and stock pile areas. The silt fence shall be constructed as detailed on this plan. The Contractor shall remove accumulated silt when it reaches a depth of 1/3 the height of the silt fence. The Contractor shall dispose of the removed silt in a location approved by the Owner and in such a manner as to not contribute to erosion and sedimentation. The Contractor shall remove the silt fence when the site is completely stabilized in accordance with the PERMIT.

12. The Contractor shall designate material and equipment storage areas mutually agreed to by the Owner. The storage areas shall be graded for positive drainage, and the surface stabilized with a minimum of 2 inches of compacted flex base on 6 inches of scarified and recompact subgrade by the Contractor. A silt fence shall be installed by the Contractor around the storage areas to prevent eroded material from leaving the site.


13. All inlets (onsite and offsite) receiving drainage water from disturbed areas shall be protected by the Contractor as per details shown or other Owner approved methods to prevent eroded material from being transported into inlets. The inlet protection shall be constructed as shown on these plans.

14. The notes and details contained herein do not relieve the Contractor and Owner of meeting and implementing the requirements of the PERMIT.

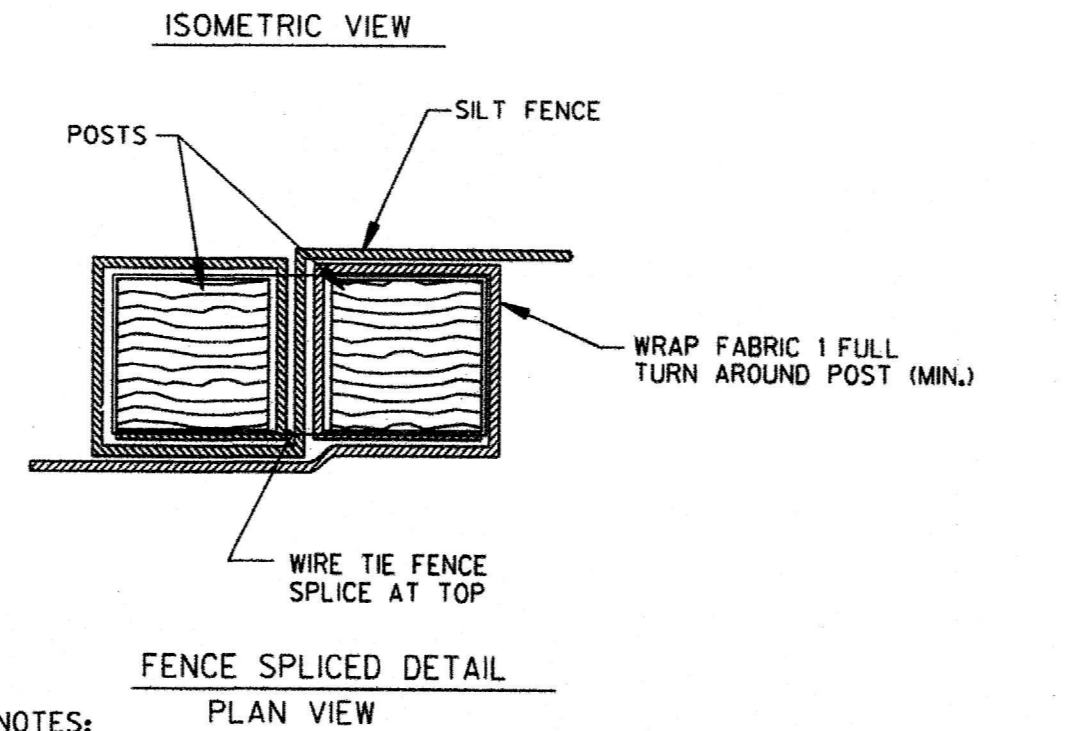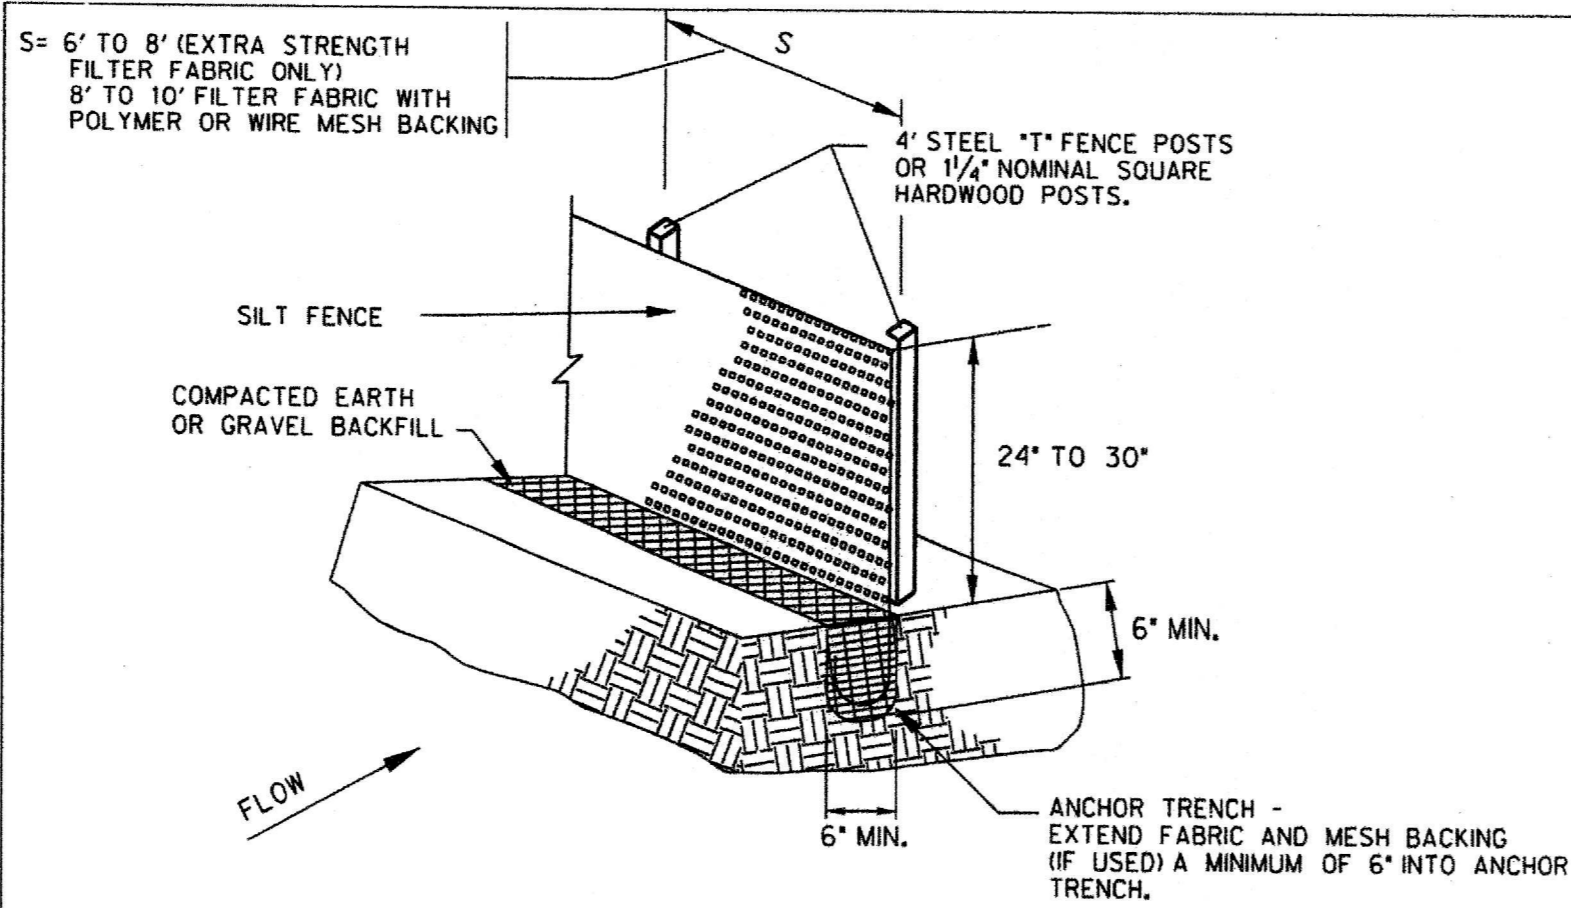


- SILT FENCE GENERAL NOTES:**
1. THE BOTTOM OF THE SILT FENCE SHALL BE SET IN ANCHOR TRENCH PER THE DETAIL. WHERE THE SILT FENCE CANNOT BE ANCHORED IN A TRENCH (E.G. PAVEMENT), SILT FENCE SHALL BE ANCHORED DOWN WITH WASHED GRAVEL.
 2. AT SPLICES IN THE SILT FENCE, THE SILT FENCE SHALL BE WRAPPED AROUND EACH END POST, ONE FULL TURN, POSTS DRIVEN ADJACENT TO EACH OTHER WITH THE TOPS OF THE POSTS SECURED TIGHTLY TOGETHER WITH WIRE TO PREVENT SEDIMENT FLOWING THROUGH THE SPLICED JOINT.
 3. SILT FENCE SHALL BE SECURELY FASTENED TO EACH SUPPORT POST.
 4. ACCUMULATED SILT SHALL BE REMOVED WHEN IT REACHES A DEPTH OF 1/3 THE HEIGHT OF THE SILT FENCE OR AS NECESSARY TO MAINTAIN THE SILT FENCE IN GOOD OPERATING ORDER. THE SILT SHALL BE DISPOSED OF ON AN APPROVED SITE AND IN SUCH A MANNER AS TO NOT CONTRIBUTE TO ADDITIONAL SILTATION.
 5. SILT FENCE AND OTHER SEDIMENT CONTROLS SHALL BE MAINTAINED PER THE REQUIREMENTS OF THE PERMIT AND IT SHALL BE REMOVED AS REQUIRED BY THE PERMIT AT COMPLETION.

SILT FENCE DETAIL
N.T.S.

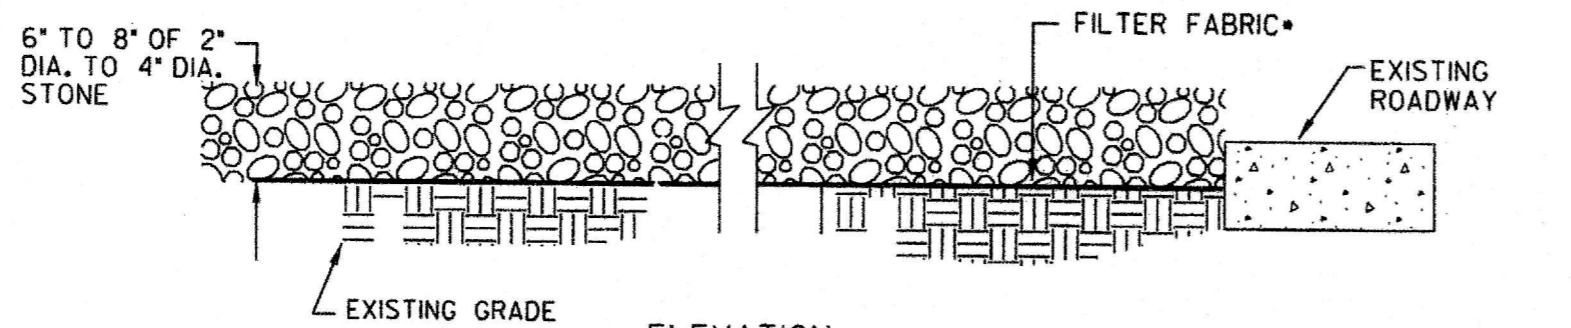


MINIMUM FILTER FABRIC SPECS.

GRAB TENSILE STRENGTH	205 LBS. (ASTM D1682)
ELONGATION FAILURE	60% (ASTM D1682)
MULLEN BURST STRENGTH	255 LBS. (ASTM D3768)
PUNCTURE STRENGTH	80 LBS. (ASTM D751) (MODIFIED)
EQUIVALENT OPENING SIZE (EOS)	SIZE 40-80, (US STD. SIEVE) (CW-02215)

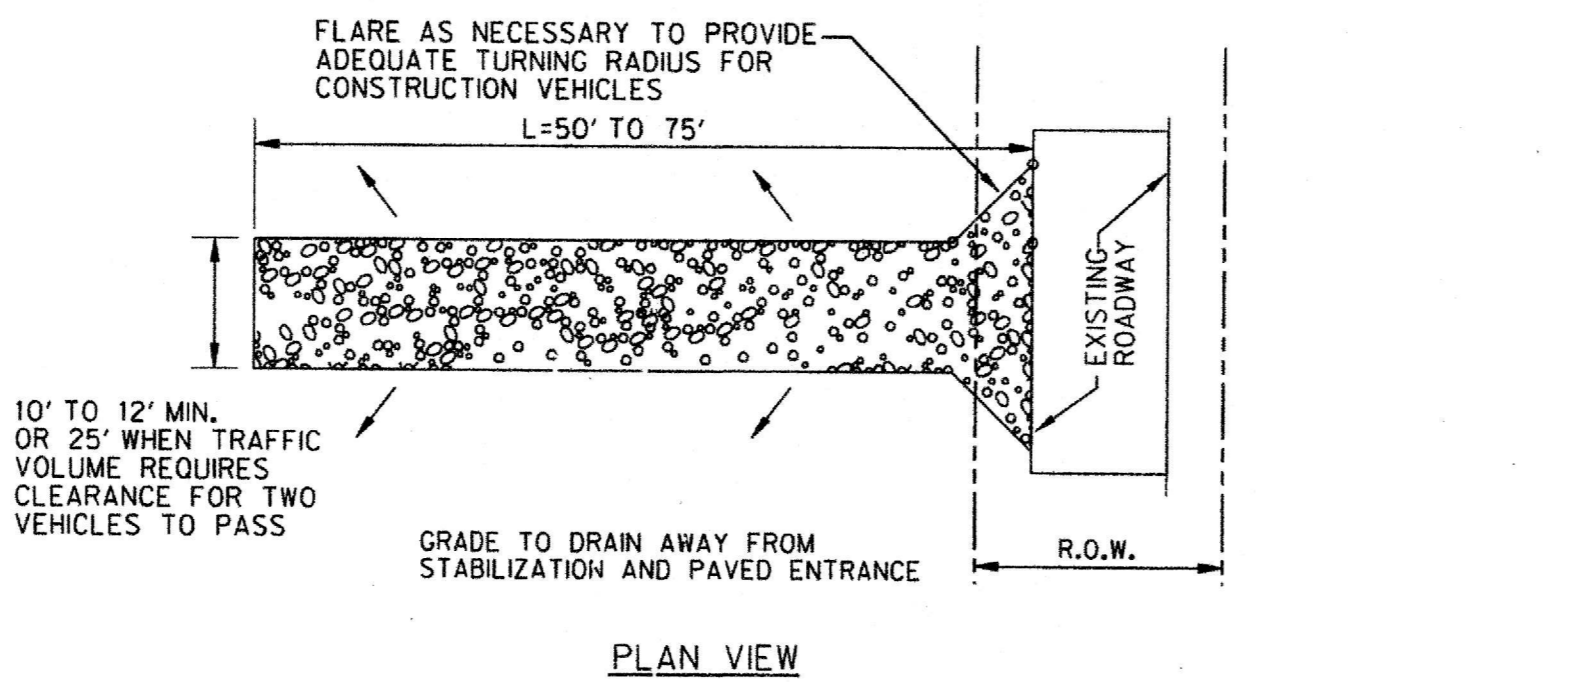


STABILIZED CONSTRUCTION ENTRANCE
N.T.S.

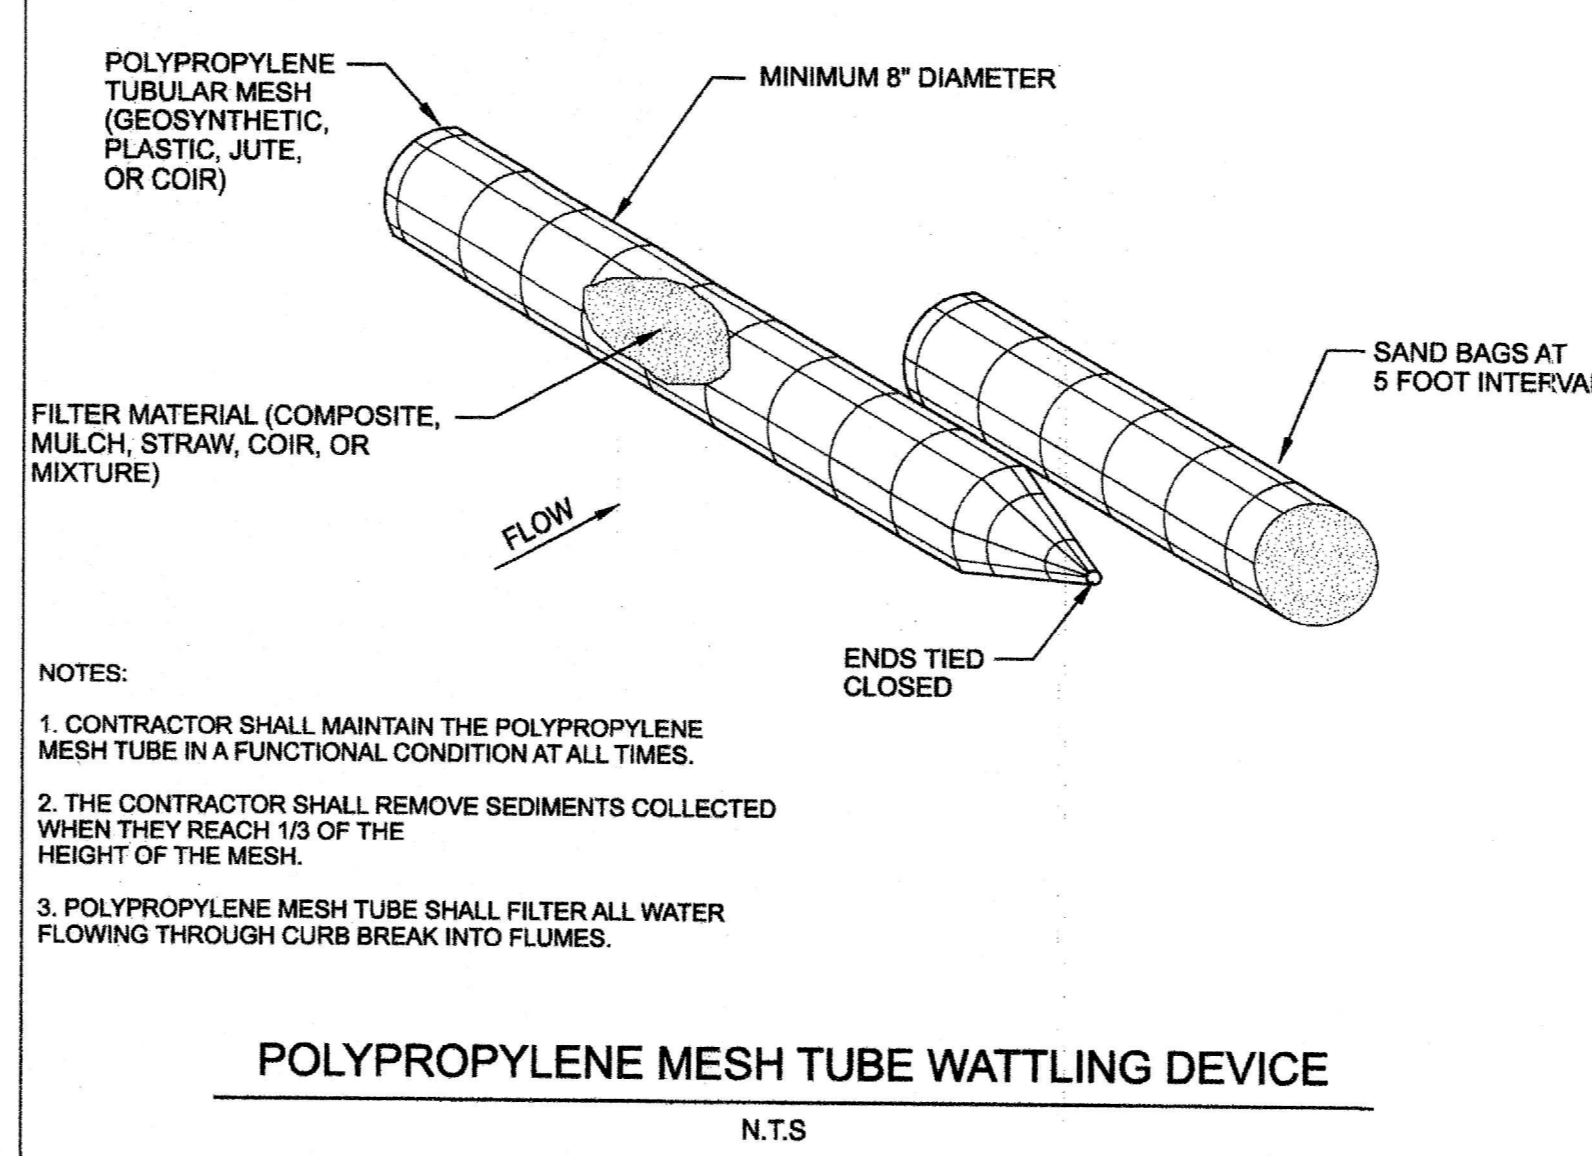



- NOTES:**
1. CONTRACTOR SHALL MAINTAIN THE POLYPROPYLENE MESH TUBE IN A FUNCTIONAL CONDITION AT ALL TIMES.
 2. THE CONTRACTOR SHALL REMOVE SEDIMENTS COLLECTED WHEN THEY REACH 1/3 OF THE HEIGHT OF THE MESH.
 3. POLYPROPYLENE MESH TUBE SHALL FILTER ALL WATER FLOWING THROUGH CURB BREAK INTO FLUMES.

POLYPROPYLENE MESH TUBE WATTLING DEVICE
N.T.S.

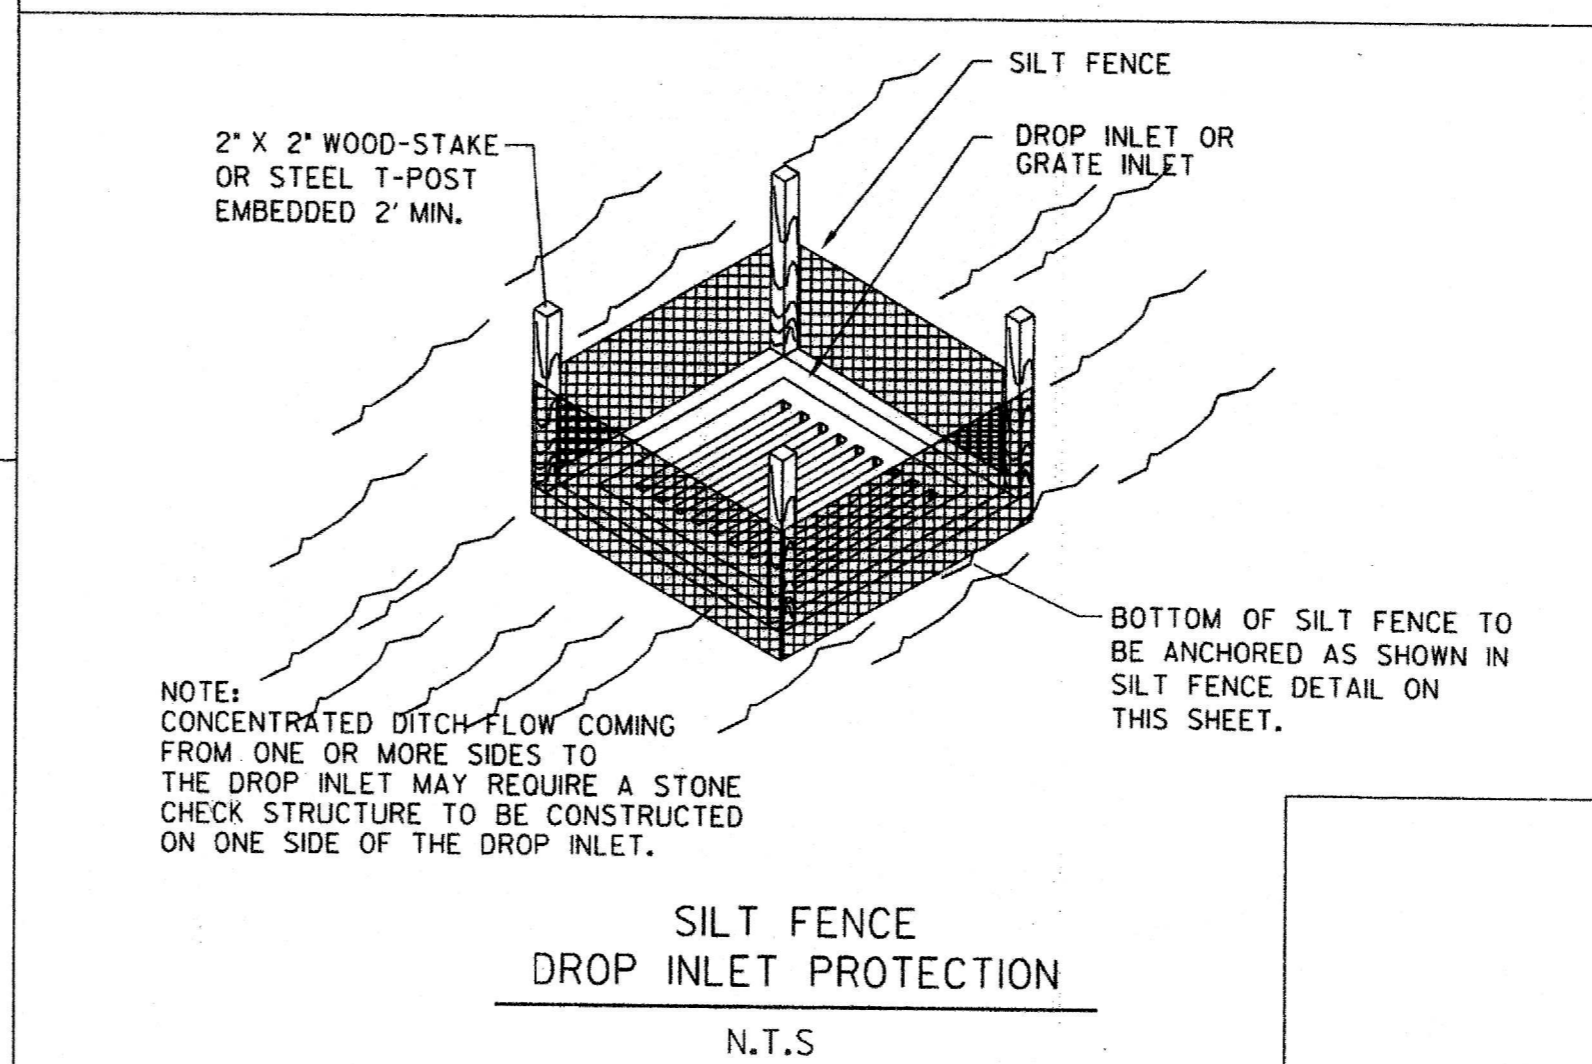


NOTE: CONCENTRATED DITCH FLOW COMING FROM ONE OR MORE SIDES TO THE DROP INLET MAY REQUIRE A STONE CHECK STRUCTURE TO BE CONSTRUCTED ON ONE SIDE OF THE DROP INLET.

SILT FENCE DROP INLET PROTECTION
N.T.S.

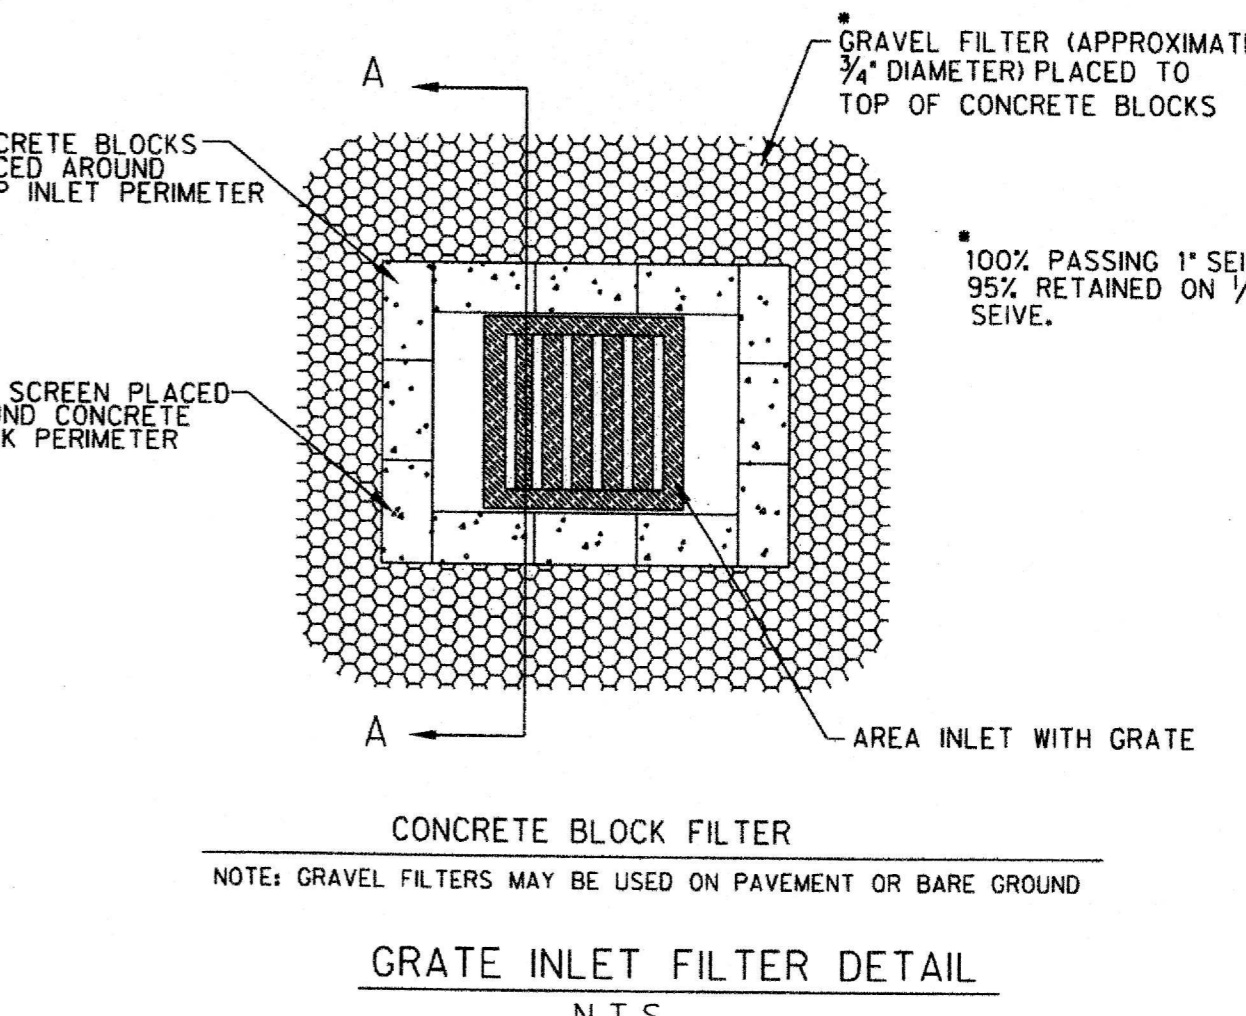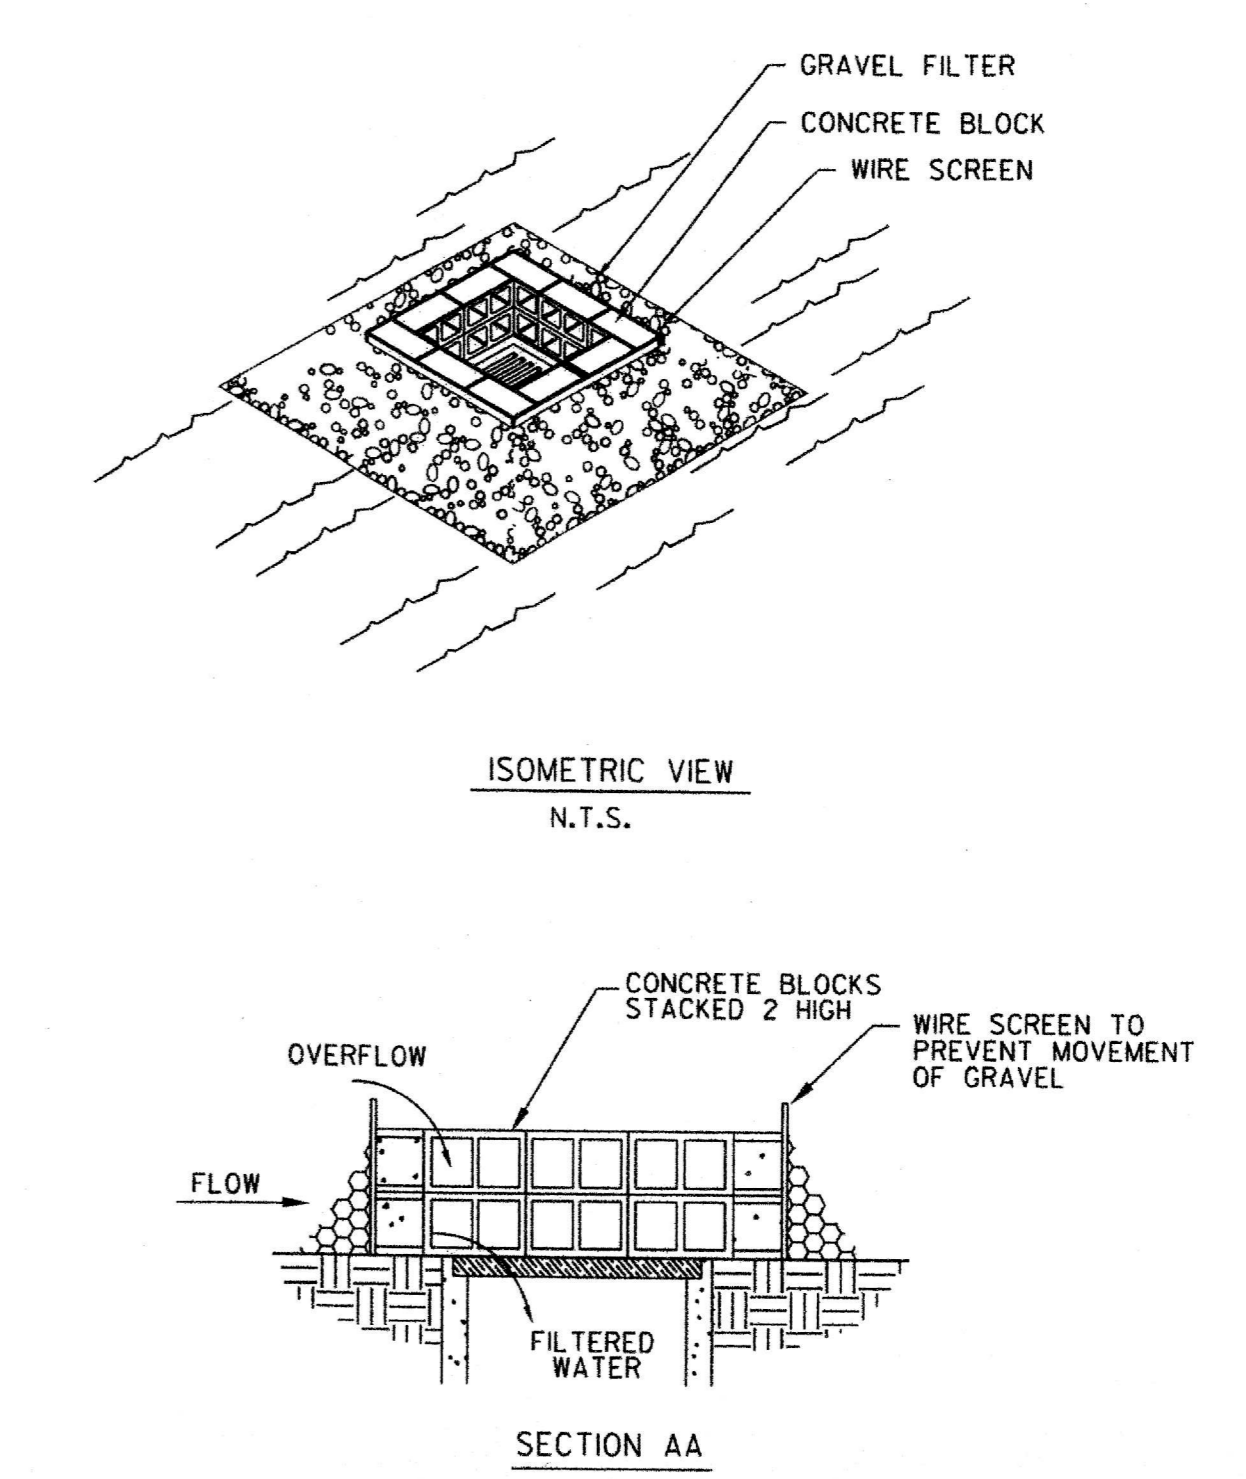

GRATE INLET FILTER DETAIL
N.T.S.

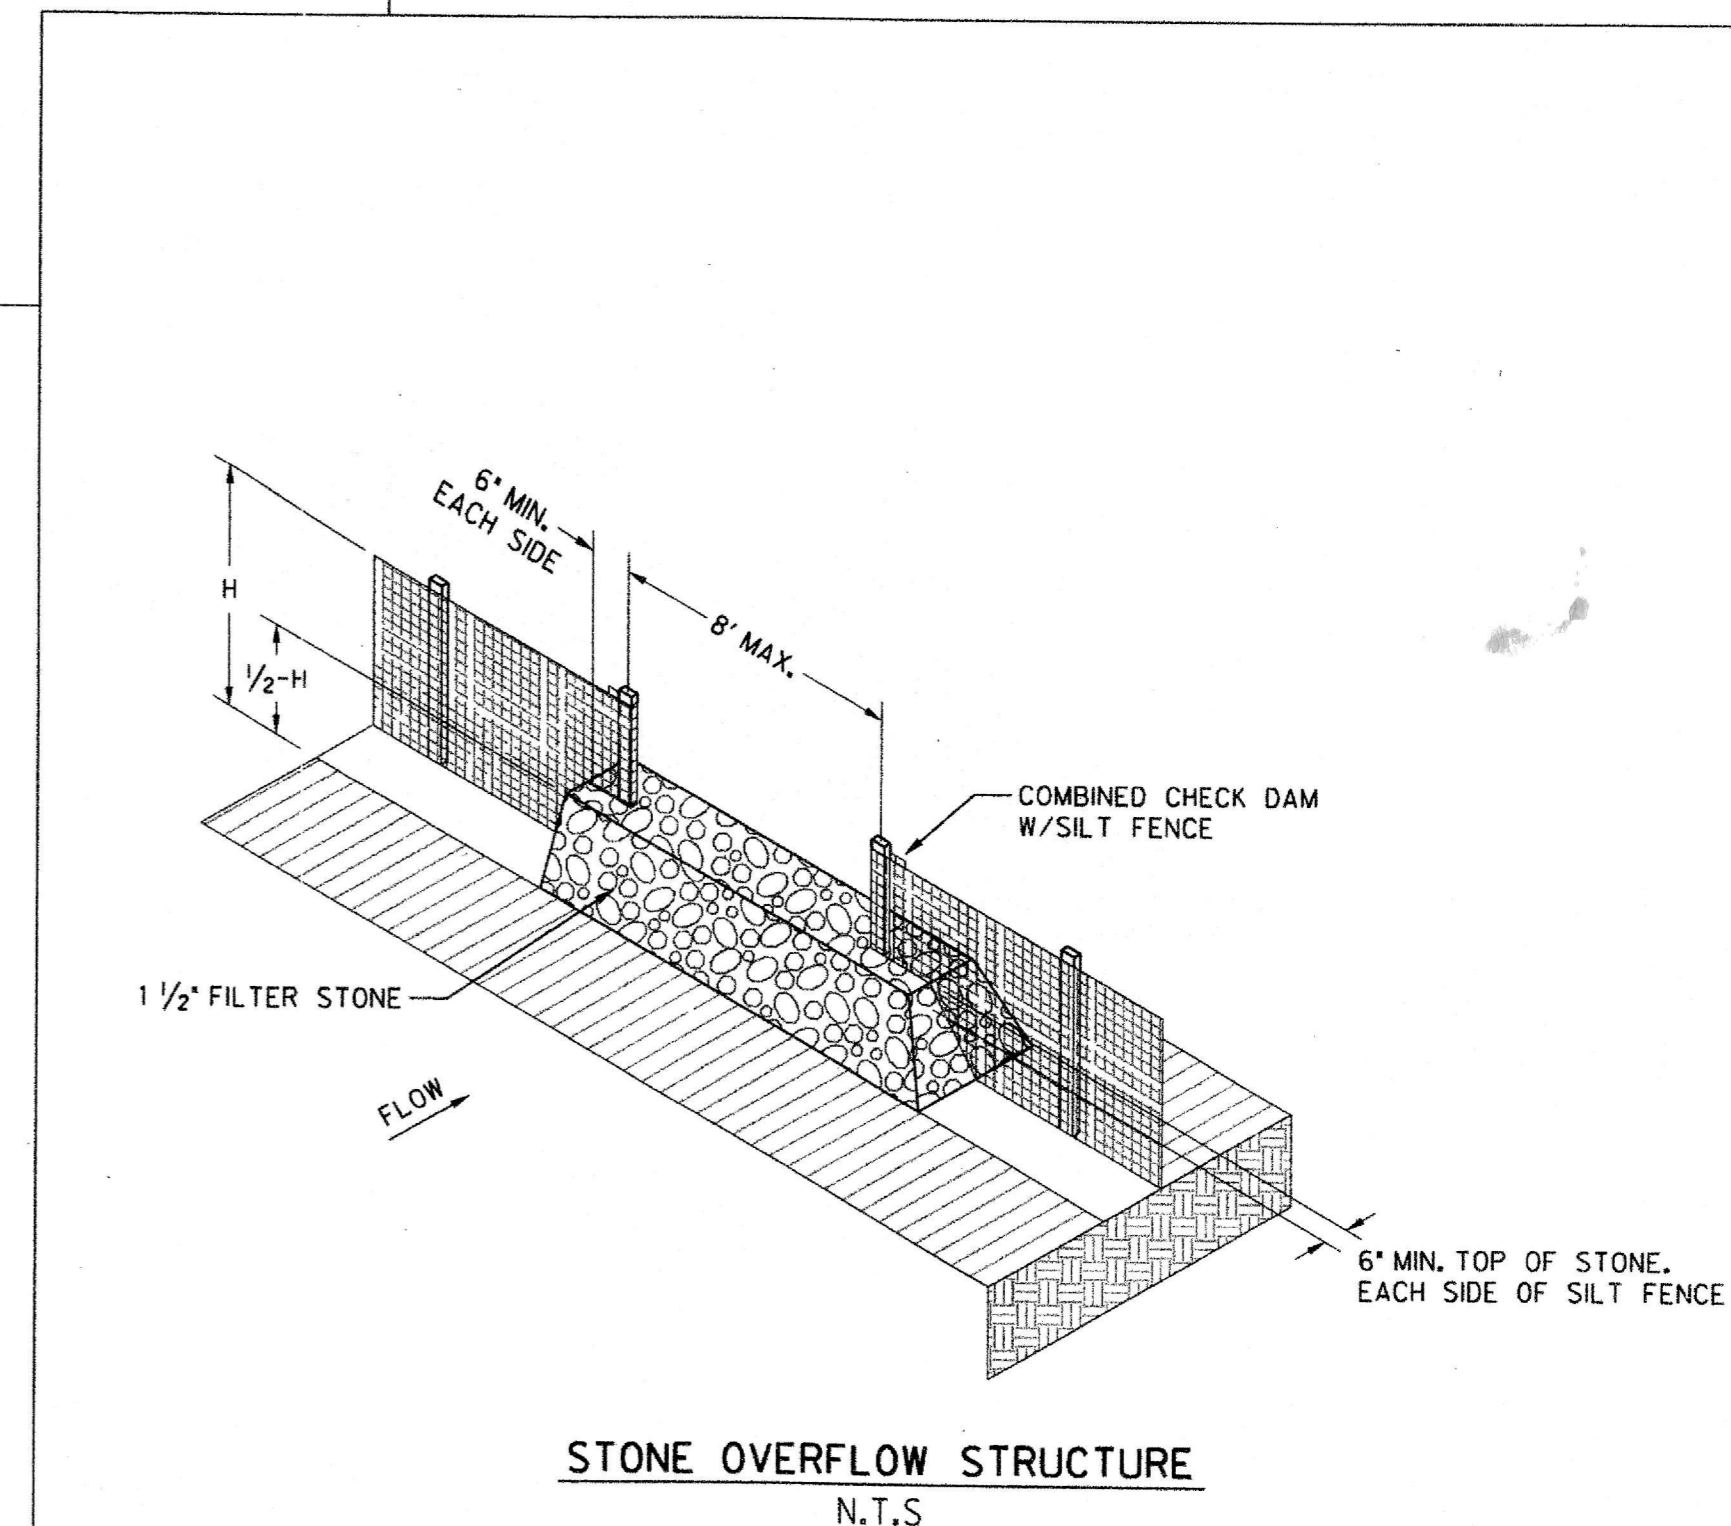

STONE OVERFLOW STRUCTURE
N.T.S.

DASEKE RESIDENCE
5656 CELESTIAL ROAD
CITY OF ADDISON, TEXAS

HALFF
1201 NORTH BOVENSER ROAD
DALLAS, TEXAS 75081-2275
TEL: (214) 353-1300
FAX: (214) 353-0066
TIPO: 89-312

Revision	Date	Description
1	09-27-2010	Rev. for Permit and Construction



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Checked By: IH
Scale: AS NOTED
Sheet Title
EROSION CONTROL NOTES & DETAILS

C4.02
Sheet Number

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