
FOR

PARKING EXPANSION

TOWN PROJECT #18-02

4970 LANDMARK PLACE DALLAS, TEXAS

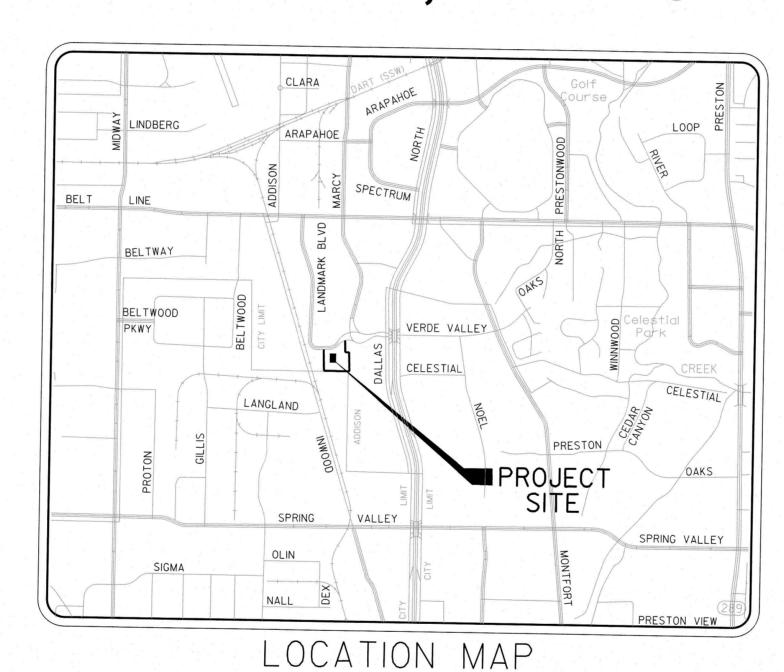

SCALE/NOT TO SCALE

SHEET INDEX				
SHEET#	SHEET NAME			
C0.00	COVER SHEET			
C0.01	EXISTING PLAT			
C0.02	GENERAL NOTES			
C0.03	SURVEY CONTROL PLAN			
C1.01	PAVING / DIMENSION CONTROL PLAN			
C2.01	GRADING PLAN			
C3.01	EROSION CONTROL PLAN			
C3.02	EROSION CONTROL NOTES & DETAILS			
LP0.01	LANDSCAPE PLAN			

	REVISION TABLE		
NUMBER	DESCRIPTION	DATE	
1	REMOVED CARPORTS	03/29/18	

OWNER

NAME: SEVEN OWLS, LP STREET: CONTACT:

4970 LANDMARK PLACE CITY, STATE ZIP: DALLAS, TX 75254 ANDREW SUTTON asutton@exponenthr.com 214-346-3114

DEVELOPER

NAME: STREET:

EMAIL:

TEL:

FRANKFURT MF CONSTRUCTION, LP 5950 SHERRY LN. SUITE 205

CITY, STATE ZIP: DALLAS, TX 75225 CONTACT: **ROSS FRAKFURT**

EMAIL: Ross@Frankfurt properties.com

TEL: 469-232-3998

ENGINEER

HALFF ASSOCIATES, INC. 1201 NORTH BOWSER ROAD RICHARDSON, TX. 75081 CONTACT: KEATON MAI, P.E. EMAIL: KMAI@HALFF.COM TEL: (214) 346-6200 TBPE FIRM# F-312




1201 NORTH BOWSER ROAD **RICHARDSON, TX 75081-2275** TEL (214) 346-6200 FAX (214) 739-0095



APPROVED FOR CONSTRUCTION INFRASTRUCTURE & DEVELOPMENT SERVICES

DATE: 4/10/18

IN APPROVING THESE PLANS, THE TOWN OF ADDISON ASSUMES NO RESPONSIBILITY FOR THEIR ADEQUACY, WHICH REMAINS WITH THE ENGINEER OF RECORD. 16801 WESTGROVE DRIVE, ADDISON, TX 75001 - (972) 450-2871

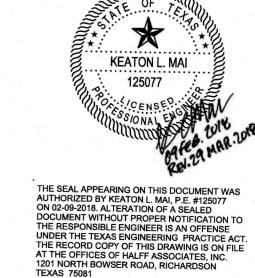

C_{0.01}

*NOT TO SCALE

EXISTING PLAT

Project No.: 33678

CAD

FEBRUARY 2018

AS SHOWN

ANSION

ARKING E

×

KEATON L. MAI

125077

Sheet Number

GENERAL NOTES:

- Contractor is responsible for, and must obtain prior to construction, all necessary construction permits required by the Town of Addison.
- The Contractor shall abide by all applicable federal, state, and local laws governing excavation. The Contractor shall provide detailed plans and specifications for trench safety systems that comply with applicable laws governing excavation. These plans shall be sealed by an Engineer experienced in the design of trench safety systems and licensed by the State of Texas. Submit plan to the Owner prior to commencing work. The Contractor shall be solely responsible for all aspects of work related to excavation.
- 3. Existing utility locations shown are taken from available records provided by the utility Owner and field locations of surface appurtenances. Locations shown are generally schematic in nature and may not accurately reflect the size and location of each particular utility. Some utility lines may not be shown. Contractor shall assume responsibility for actual field location and protection of existing facilities whether shown or not. Contractor shall also assume responsibility for repairs to existing facilities, whether shown or not, damaged by contractor's activities. Differences in horizontal or vertical location of existing utilities shall not be a basis for additional expense.
- 4. Contractor shall locate and adjust existing utility manhole lids, cleanouts, water valves and other surface appurtenances as required for new construction. Contractor shall coordinate utility adjustments with other disciplines and the appropriate utility agencies and provide for all fees for permits, connections, inspections, etc. These adjustments shall be considered incidental to the construction contract.
- 5. The Contractor shall protect existing property monumentation and primary control. Any such points which the Contractor believes will be destroyed shall have offset points established by the Contractor prior to construction. Any monumentation destroyed by the Contractor shall be reestablished at his expense.
- 6. Barricading and traffic control during construction shall be the responsibility of the Contractor and shall conform to the latest edition of the "Texas Manual on Uniform Traffic Control Devices", Part VI in particular. Traffic flow and access shall be maintained during all phases of the construction. The Contractor is responsible for providing traffic safety measures for work on project.
- 7. Onsite planametric and topographic mapping taken from data provided by Republic National, dated October 2017. Boundary data taken from Survey by Republic National, dated October 2017.
- Any damages that may occur to real property or existing improvements shall be restored by the Contractor to at lease the same condition that the real property or existing improvements were in prior to the damages. This restoration shall be subject to the Owner's approval; moreover, this restoration shall not be a basis for additional compensation to the Contractor. Restoration shall include, but not be limited to, regrassing, revegetation, replacing fences, replacing trees, etc.
- 9. It shall be the responsibility of the Contractor to:
 - A. Prevent any damage to private property and property owner's poles, fences, shrubs,

DEMOLITION NOTES:

Owner's representative.

be covered.

- B. Provide access to all drives during construction.
- C. Protect all underground utilities to remain in service. D. Notify all utility companies and verify location of all utilities prior to start of construction.
- Contractor shall maintain positive drainage at all time during construction. Ponding of water in streets, drives, truck courts, trenches, etc. will not be allowed.
- 11. Contractor shall maintain existing sanitary sewer and water service at all times during construction.
- 12. Contractor is responsible for coordination with utility companies and adjustment of existing sanitary sewer cleanouts, water meters and any other appurtenances to new grade as required.
- 13. Pavement removal and repair shall conform to the City of Addison requirements. All sawcuts shall be full depth cuts. Contractor shall make efforts to protect concrete and/or asphalt edges. Any large spalled or broken edges shall be removed by sawcutting pavement prior to replacement.

For additional extents of demolition, refer to Grading and Paving / Dimension Control Plans.

Information provided on this plan does not delineate any underground foundations or objects that currently may

The Contractor shall be responsible for proper removal and disposal of materials as required by the Owner or

PAVING NOTES:

- Contractor's work shall include pavement removal and disposal required for new walk, drive, curb, gutter and other paving features. Contractor shall be responsible for all coordination, inspection and testing required by the Owner and/or the Town of Addison.
- For new pavement use minimum 3500 p.s.i. portland cement concrete reinforced with #3 bars at 18-inch on center.
- Paving sections shall be sawcut in $12' \times 12'$ squares.
- All dimensions are to face of curb and are perpendicular to property line. These dimensions are provided to tie the site plan to the property lines.
- All sidewalks shall maintain 2% cross slope maximum.

GRADING NOTES:

- All site work details shall be done in accordance with the Standard Details of the Town of Addison and conform to the requirements of the plans and contract documents.
- The Contractor shall administer sprinklers for dust control, earthwork or base construction as required or as directed by the Engineer in accordance with the Town of Addison Standards.
- Contractor's work shall include pavement removal and disposal required for new walk. drive, curb, gutter and other grading features. Contractor shall be responsible for all coordination, inspection and testing required by the Owner and/or the Town of Addison.
- All sidewalks shall maintain 2% cross slope maximum.
- 4:1 is the maximum allowable slope within the earthen areas.
- All areas within the project limits shall be cleared of all stumps, roots, debris, and any above surface growth.
- A quantity of topsoil sufficient for placing six (6) inches of topsoil on proposed landscape areas shall be stripped and stockpiled.
- Prior to fill placement, existing subgrade shall be scarified and recompacted to required density and moisture content.
- Fill material shall be compacted to 98 percent of maximum dry density as determined by the Standard Proctor Test, ASTM D 698. In conjunction with the compacting operation, fill material shall be brought to a moisture content ranging from (-2) percentage points above update to City of Dallas requirement optimum to (+4) percentage points above optimum (-2 to +4
- The contractor shall hire a materials testing company to perform compaction tests at a
- A site erosion control plan and stormwater pollution prevention plan shall be prepared and provided to the Town of Addison by others prior to start of construction. These plans shall conform to federal, state, and local requirements.
- 14. The Contractor shall revegetate all disturbed areas to meet the Ownerr's requirements.



APPROVED FOR CONSTRUCTION INFRASTRUCTURE & DEVELOPMENT SERVICES

IN APPROVING THESE PLANS, THE TOWN OF ADDISON ASSUMES NO RESPONSIBILITY FOR THEIR ADEQUACY, WHICH REMAINS WITH THE ENGINEER OF RECORD.

16801 WESTGROVE DRIVE, ADDISON, TX 75001 - (972) 450-2871

THIS PLAN CONFORMS WITH DESIGN STANDARDS INCLUDED IN THE TOWN OF ADDISON TRANSPORTATION PLAN. WATER SYSTEM REQUIREMENTS, WASTE WATER SYSTEM REQUIREMENTS, AND DRAINAGE CRITERIA MANUAL

AS SHOWN Sheet Title **GENERAL NOTES**


Project No.: 33678

Drawn By: CAD Checked By: KM

FEBRUARY 2018

C0.02 Sheet Number

EXPANSION DMARK PLACE PARKING E

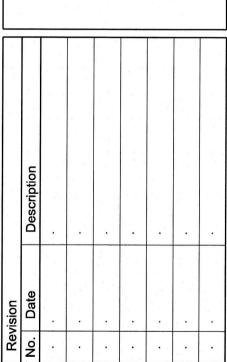






THE SEAL APPEARING ON THIS DOCUMENT W AUTHORIZED BY KEATON L. MAI, P.E. #125077 ON 02-09-2018, ALTERATION OF A SEALED


TEXAS 75081 TBPE FIRM #F-312

ON 02-09-2018. ALTERATION OF A SEALED DOCUMENT WITHOUT PROPER NOTIFICATION TO THE RESPONSIBLE ENGINEER IS AN OFFENSE UNDER THE TEXAS ENGINEERING PRACTICE ACT. THE RECORD COPY OF THIS DRAWING IS ON FILE AT THE OFFICES OF HALFF ASSOCIATES, INC. 1201 NORTH BOWSER ROAD, RICHARDSON TEXAS. 75091

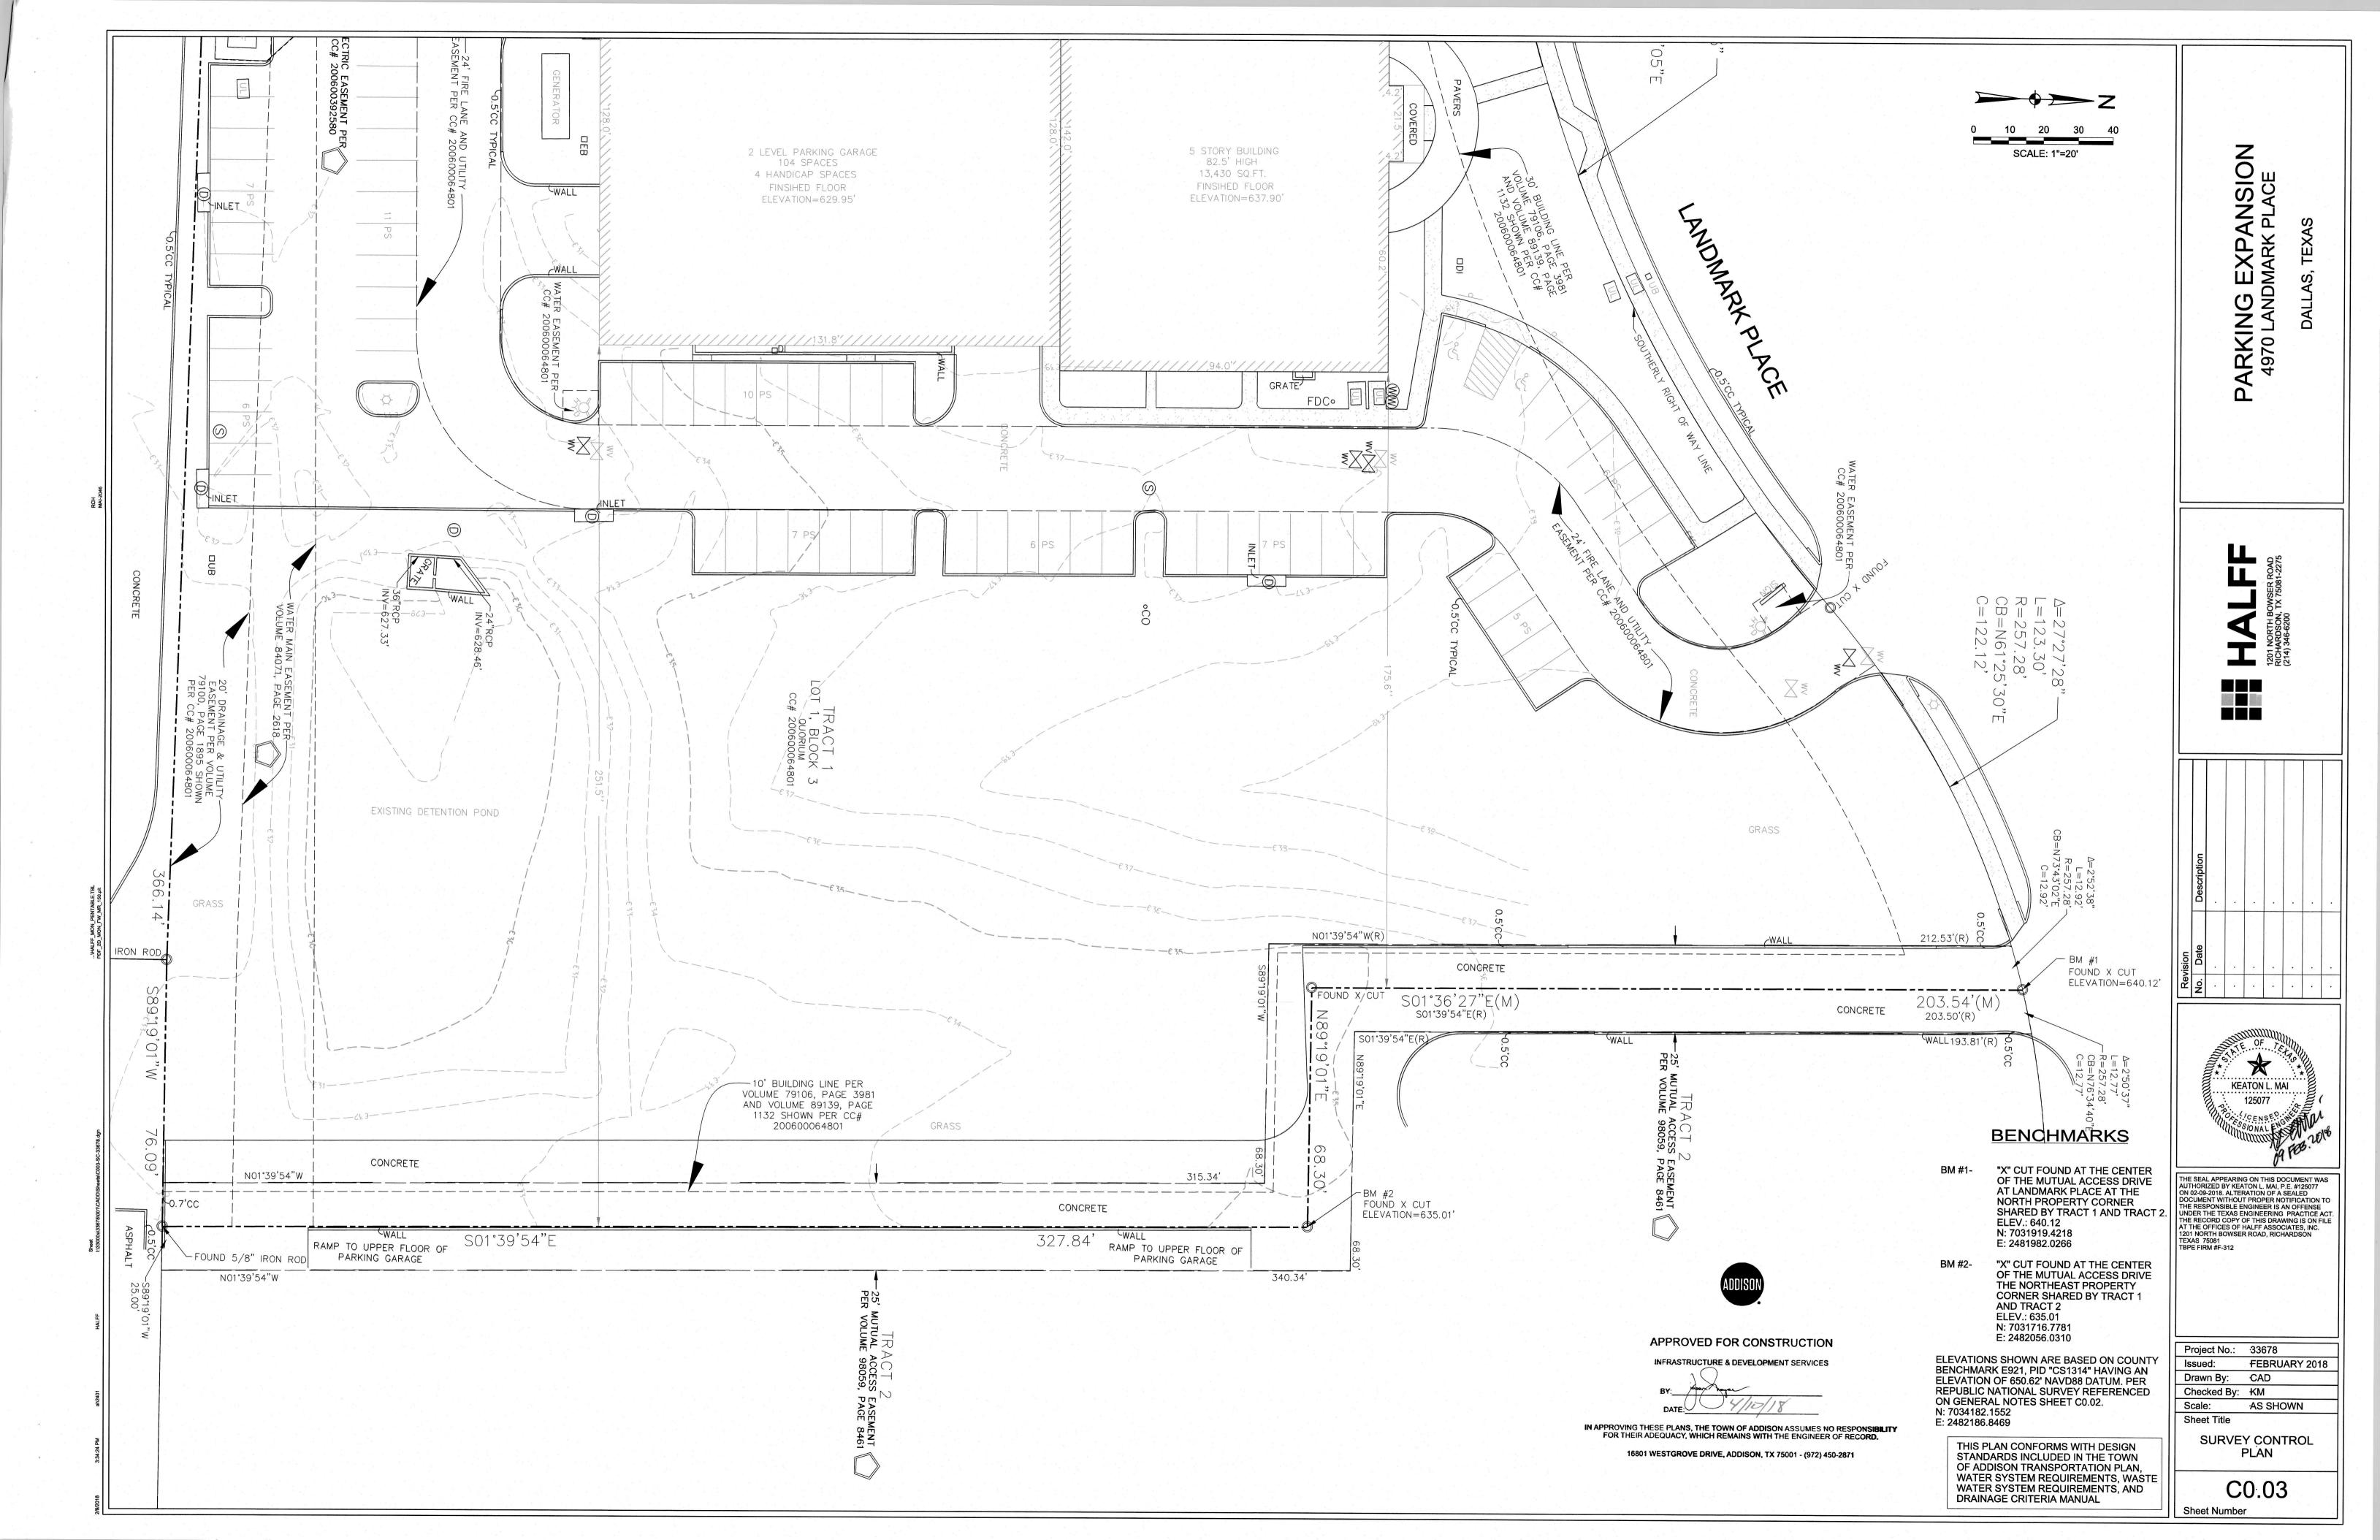

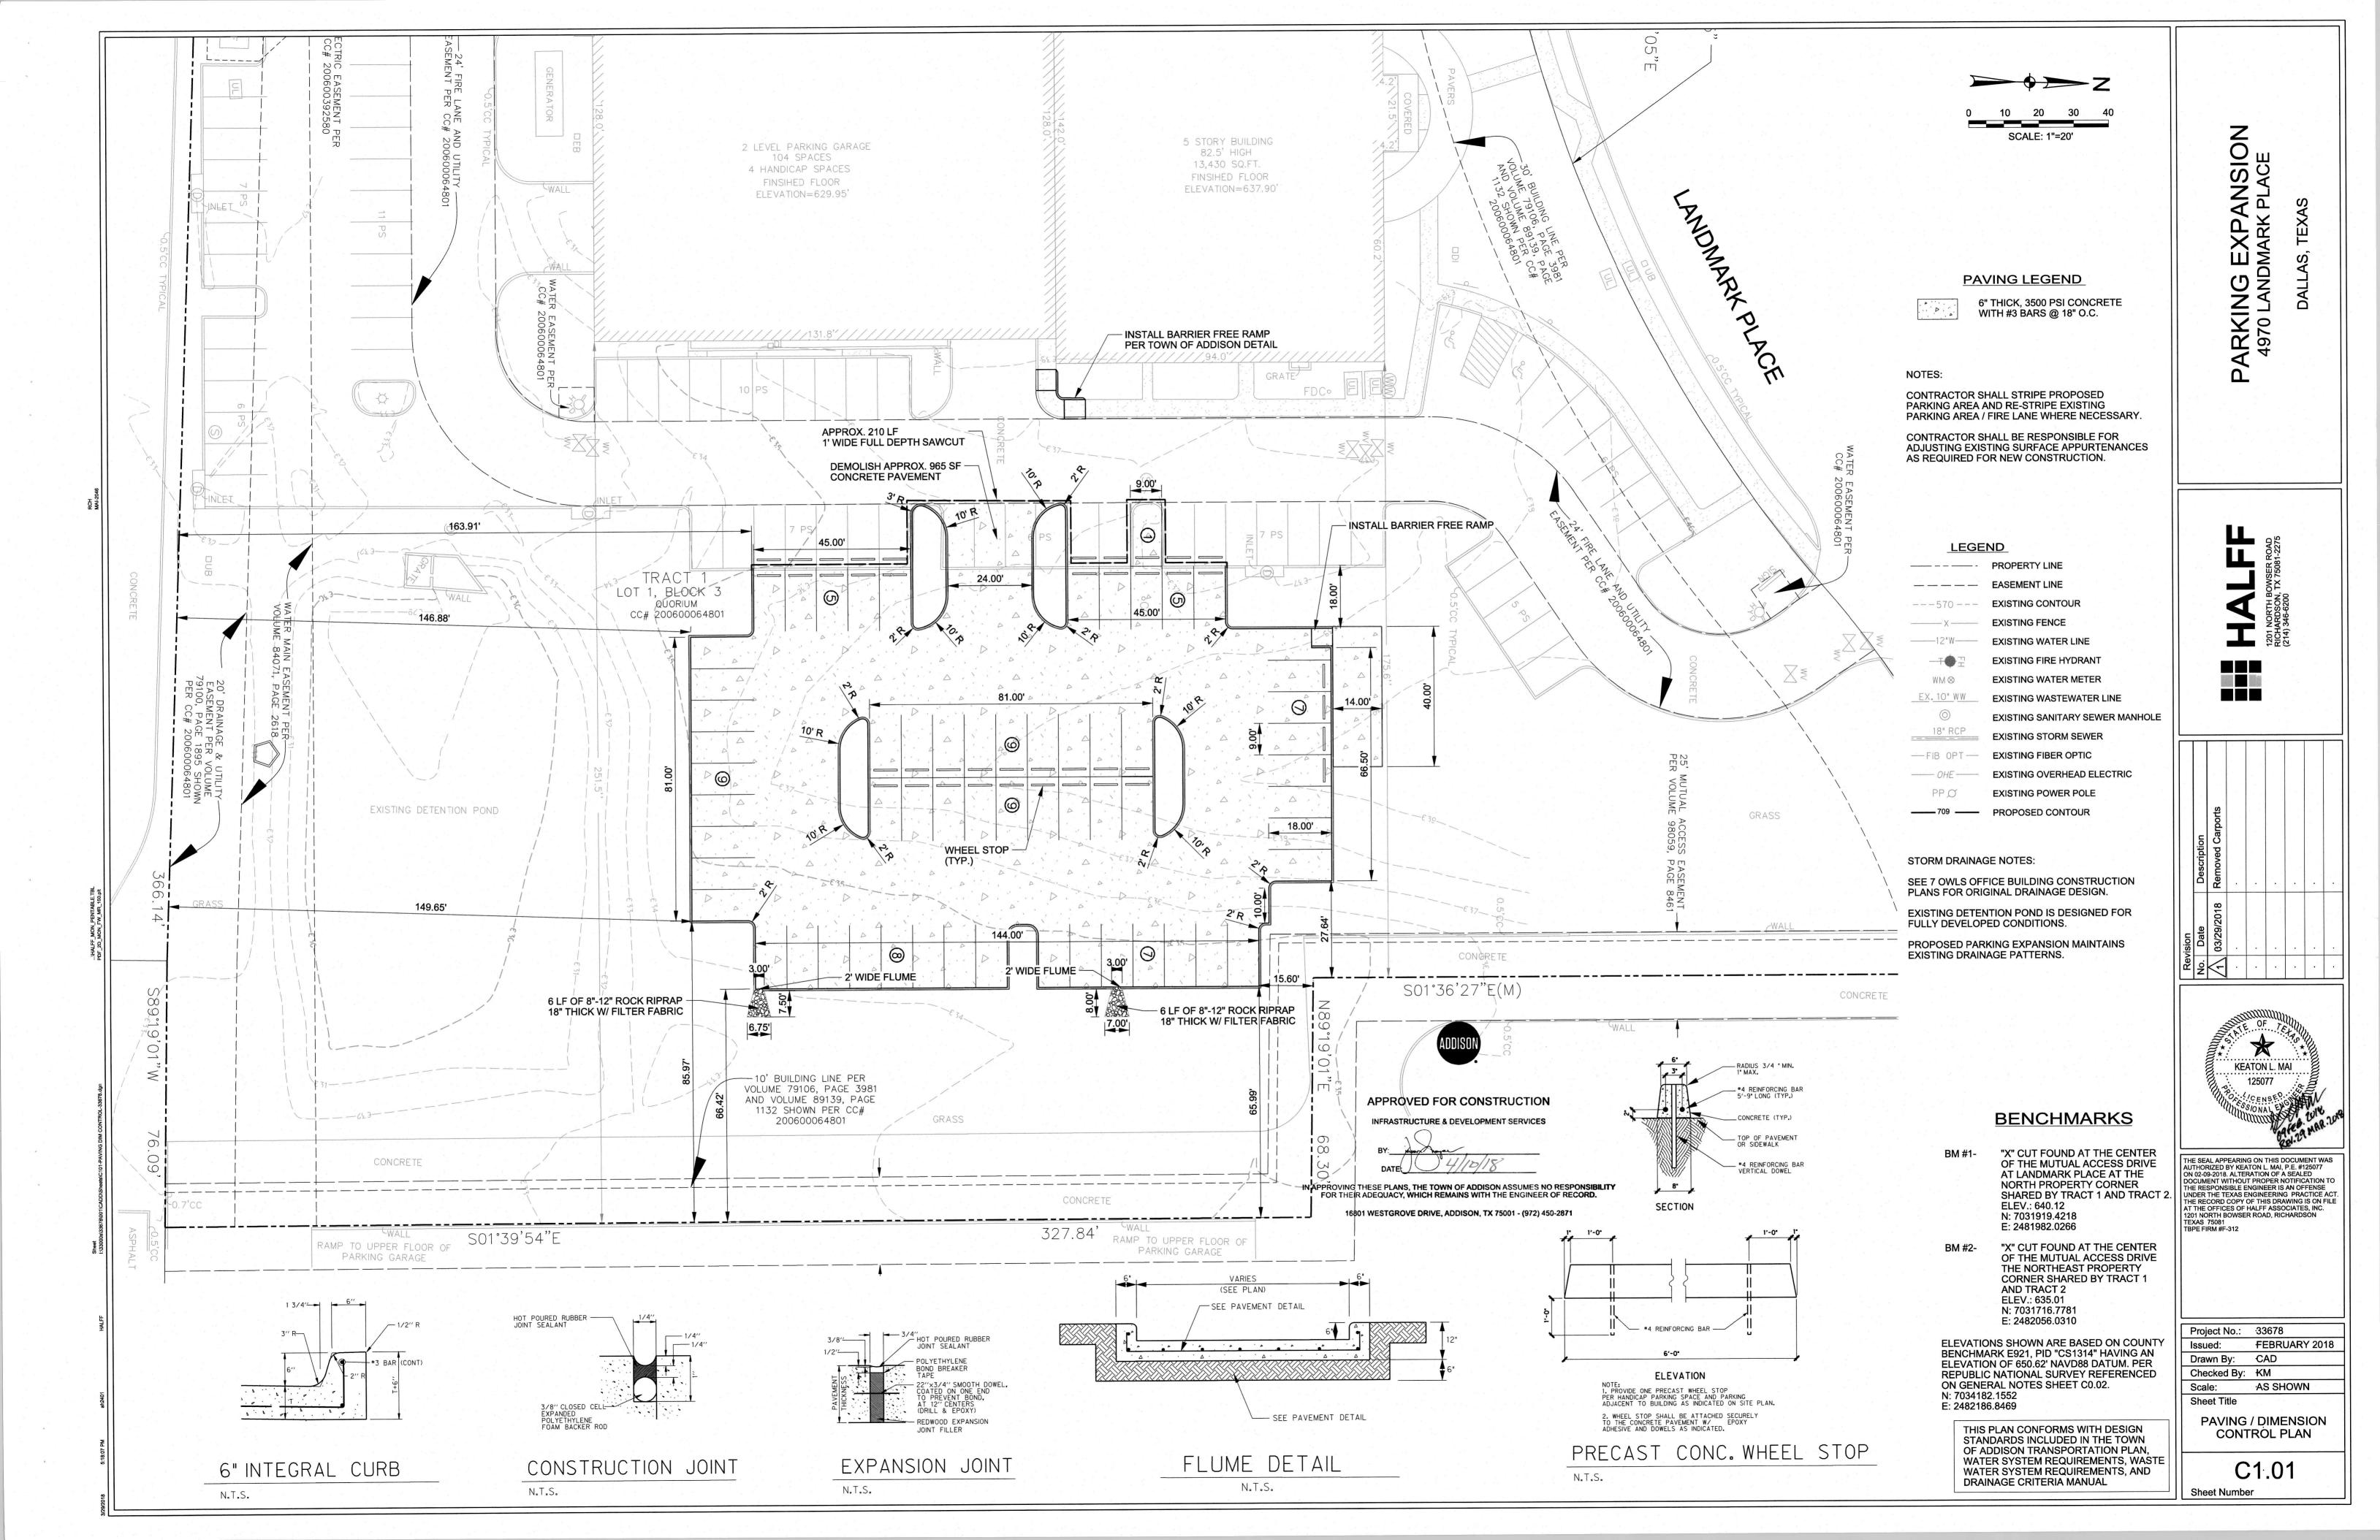

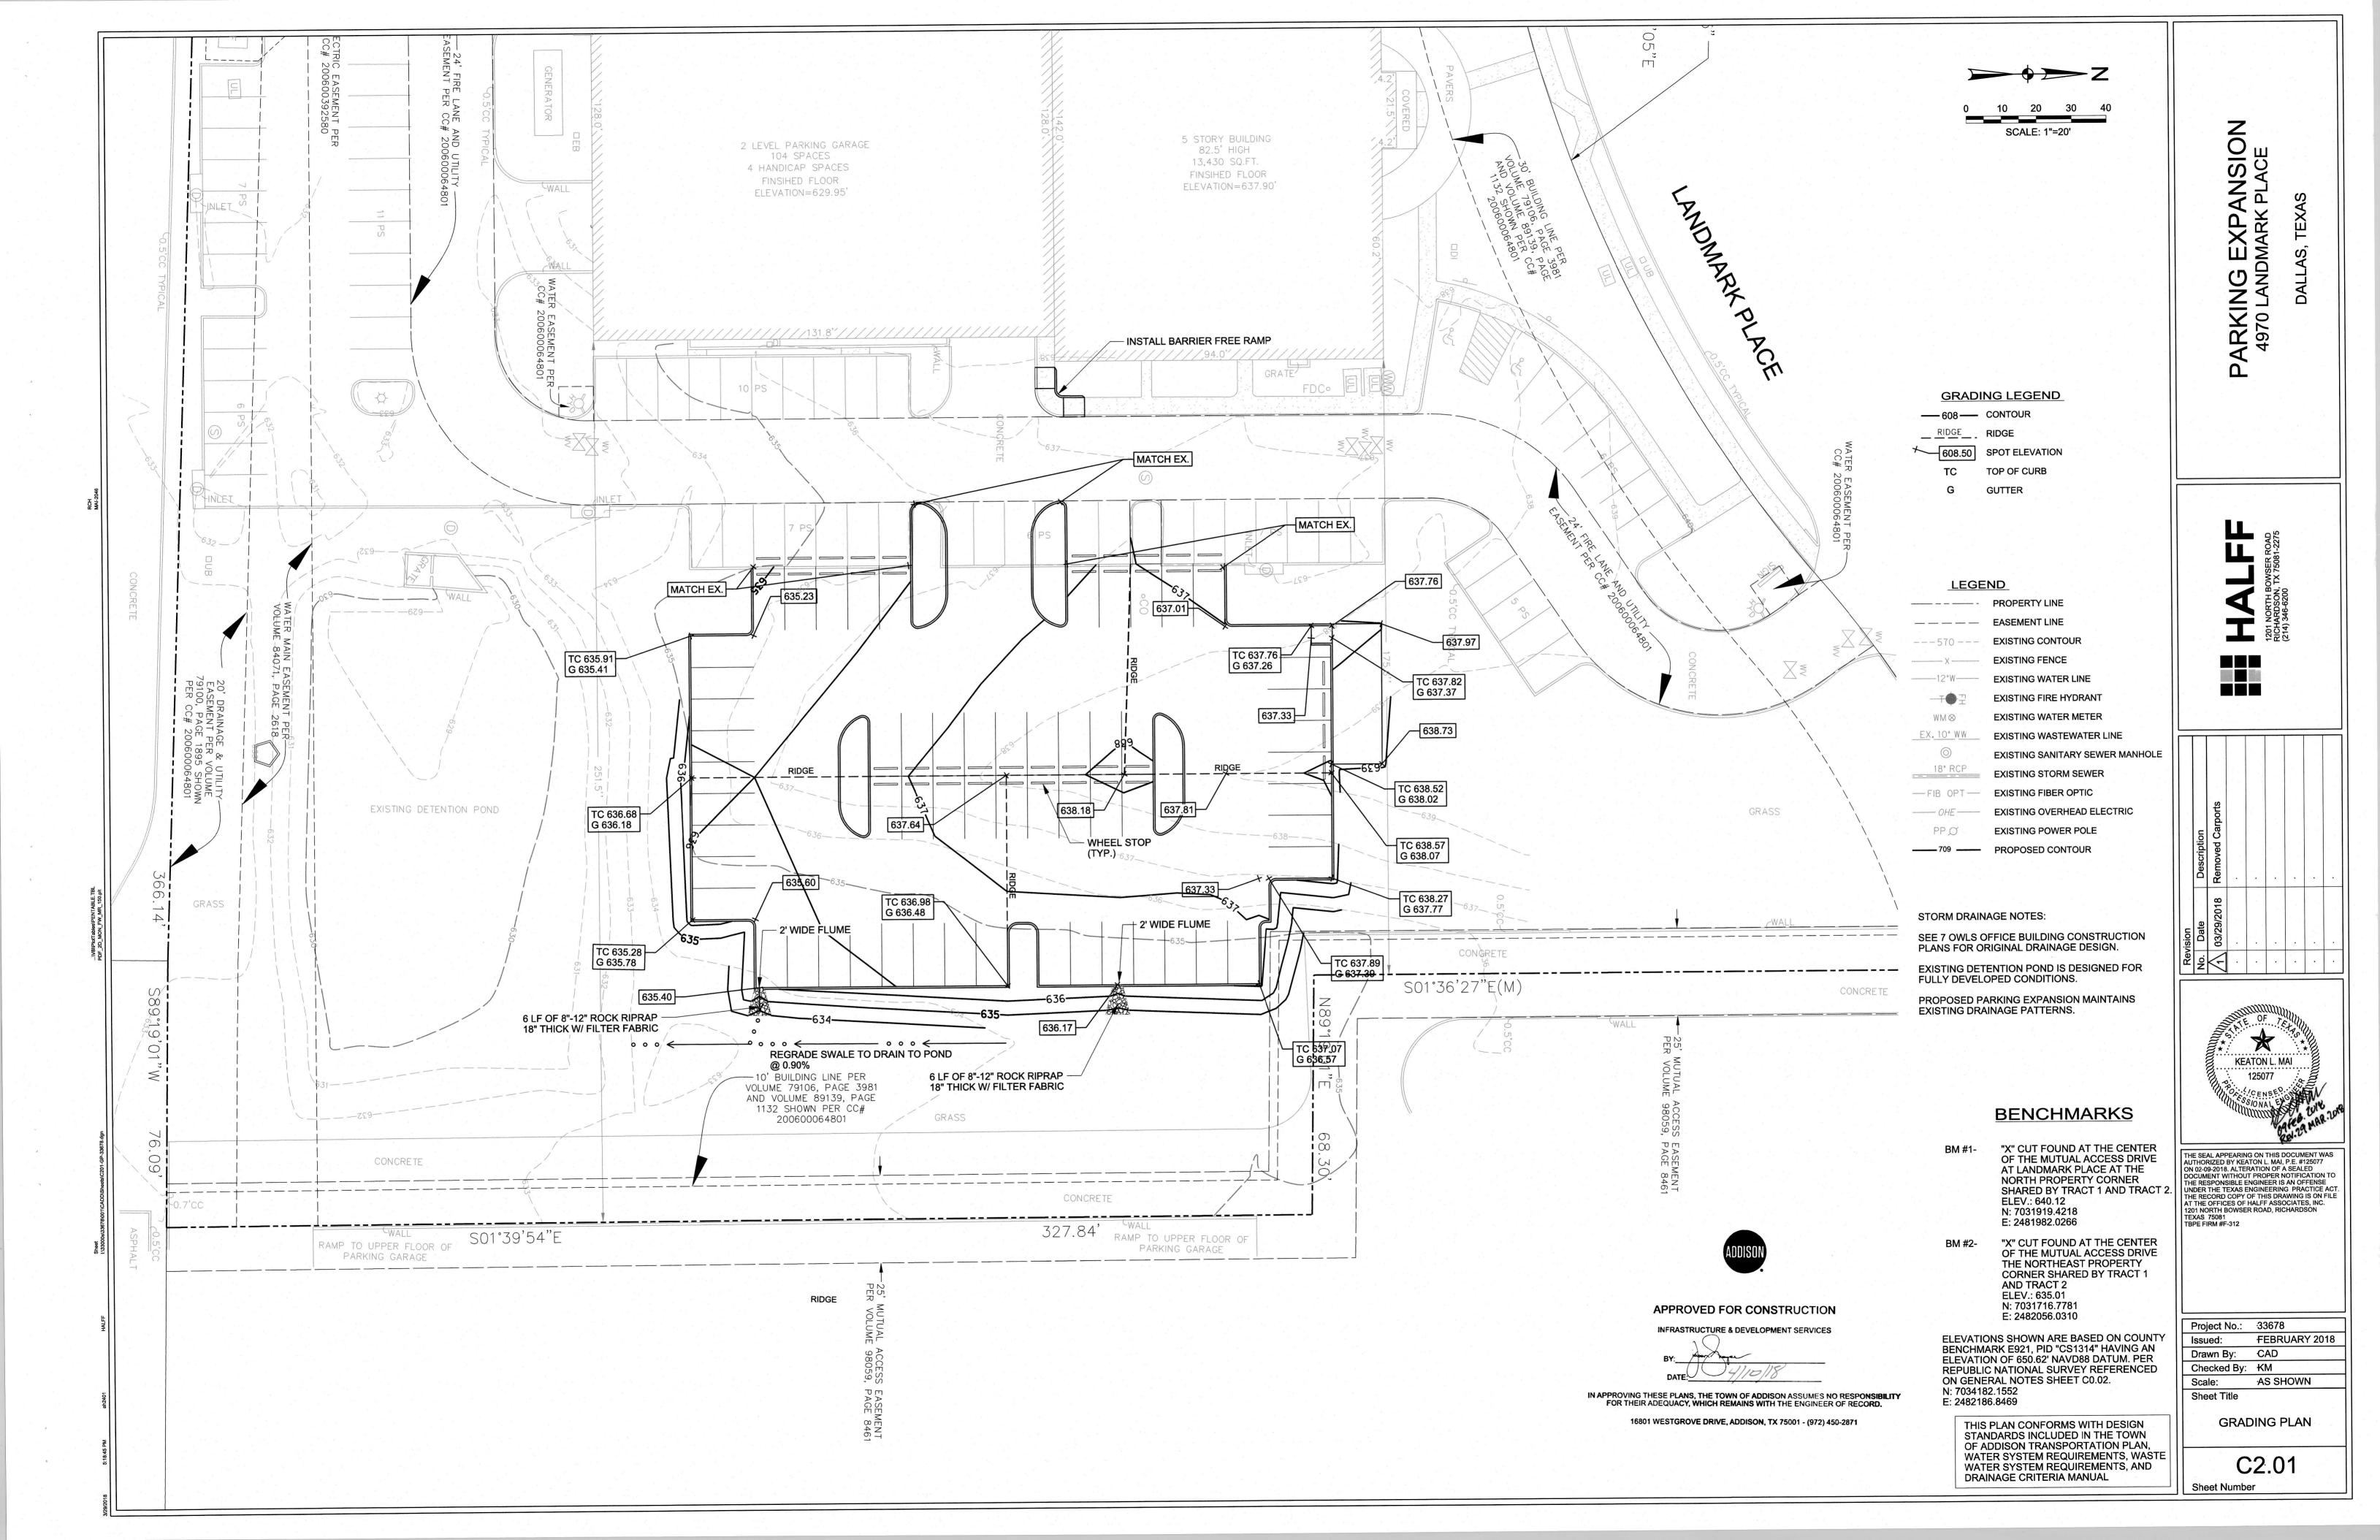

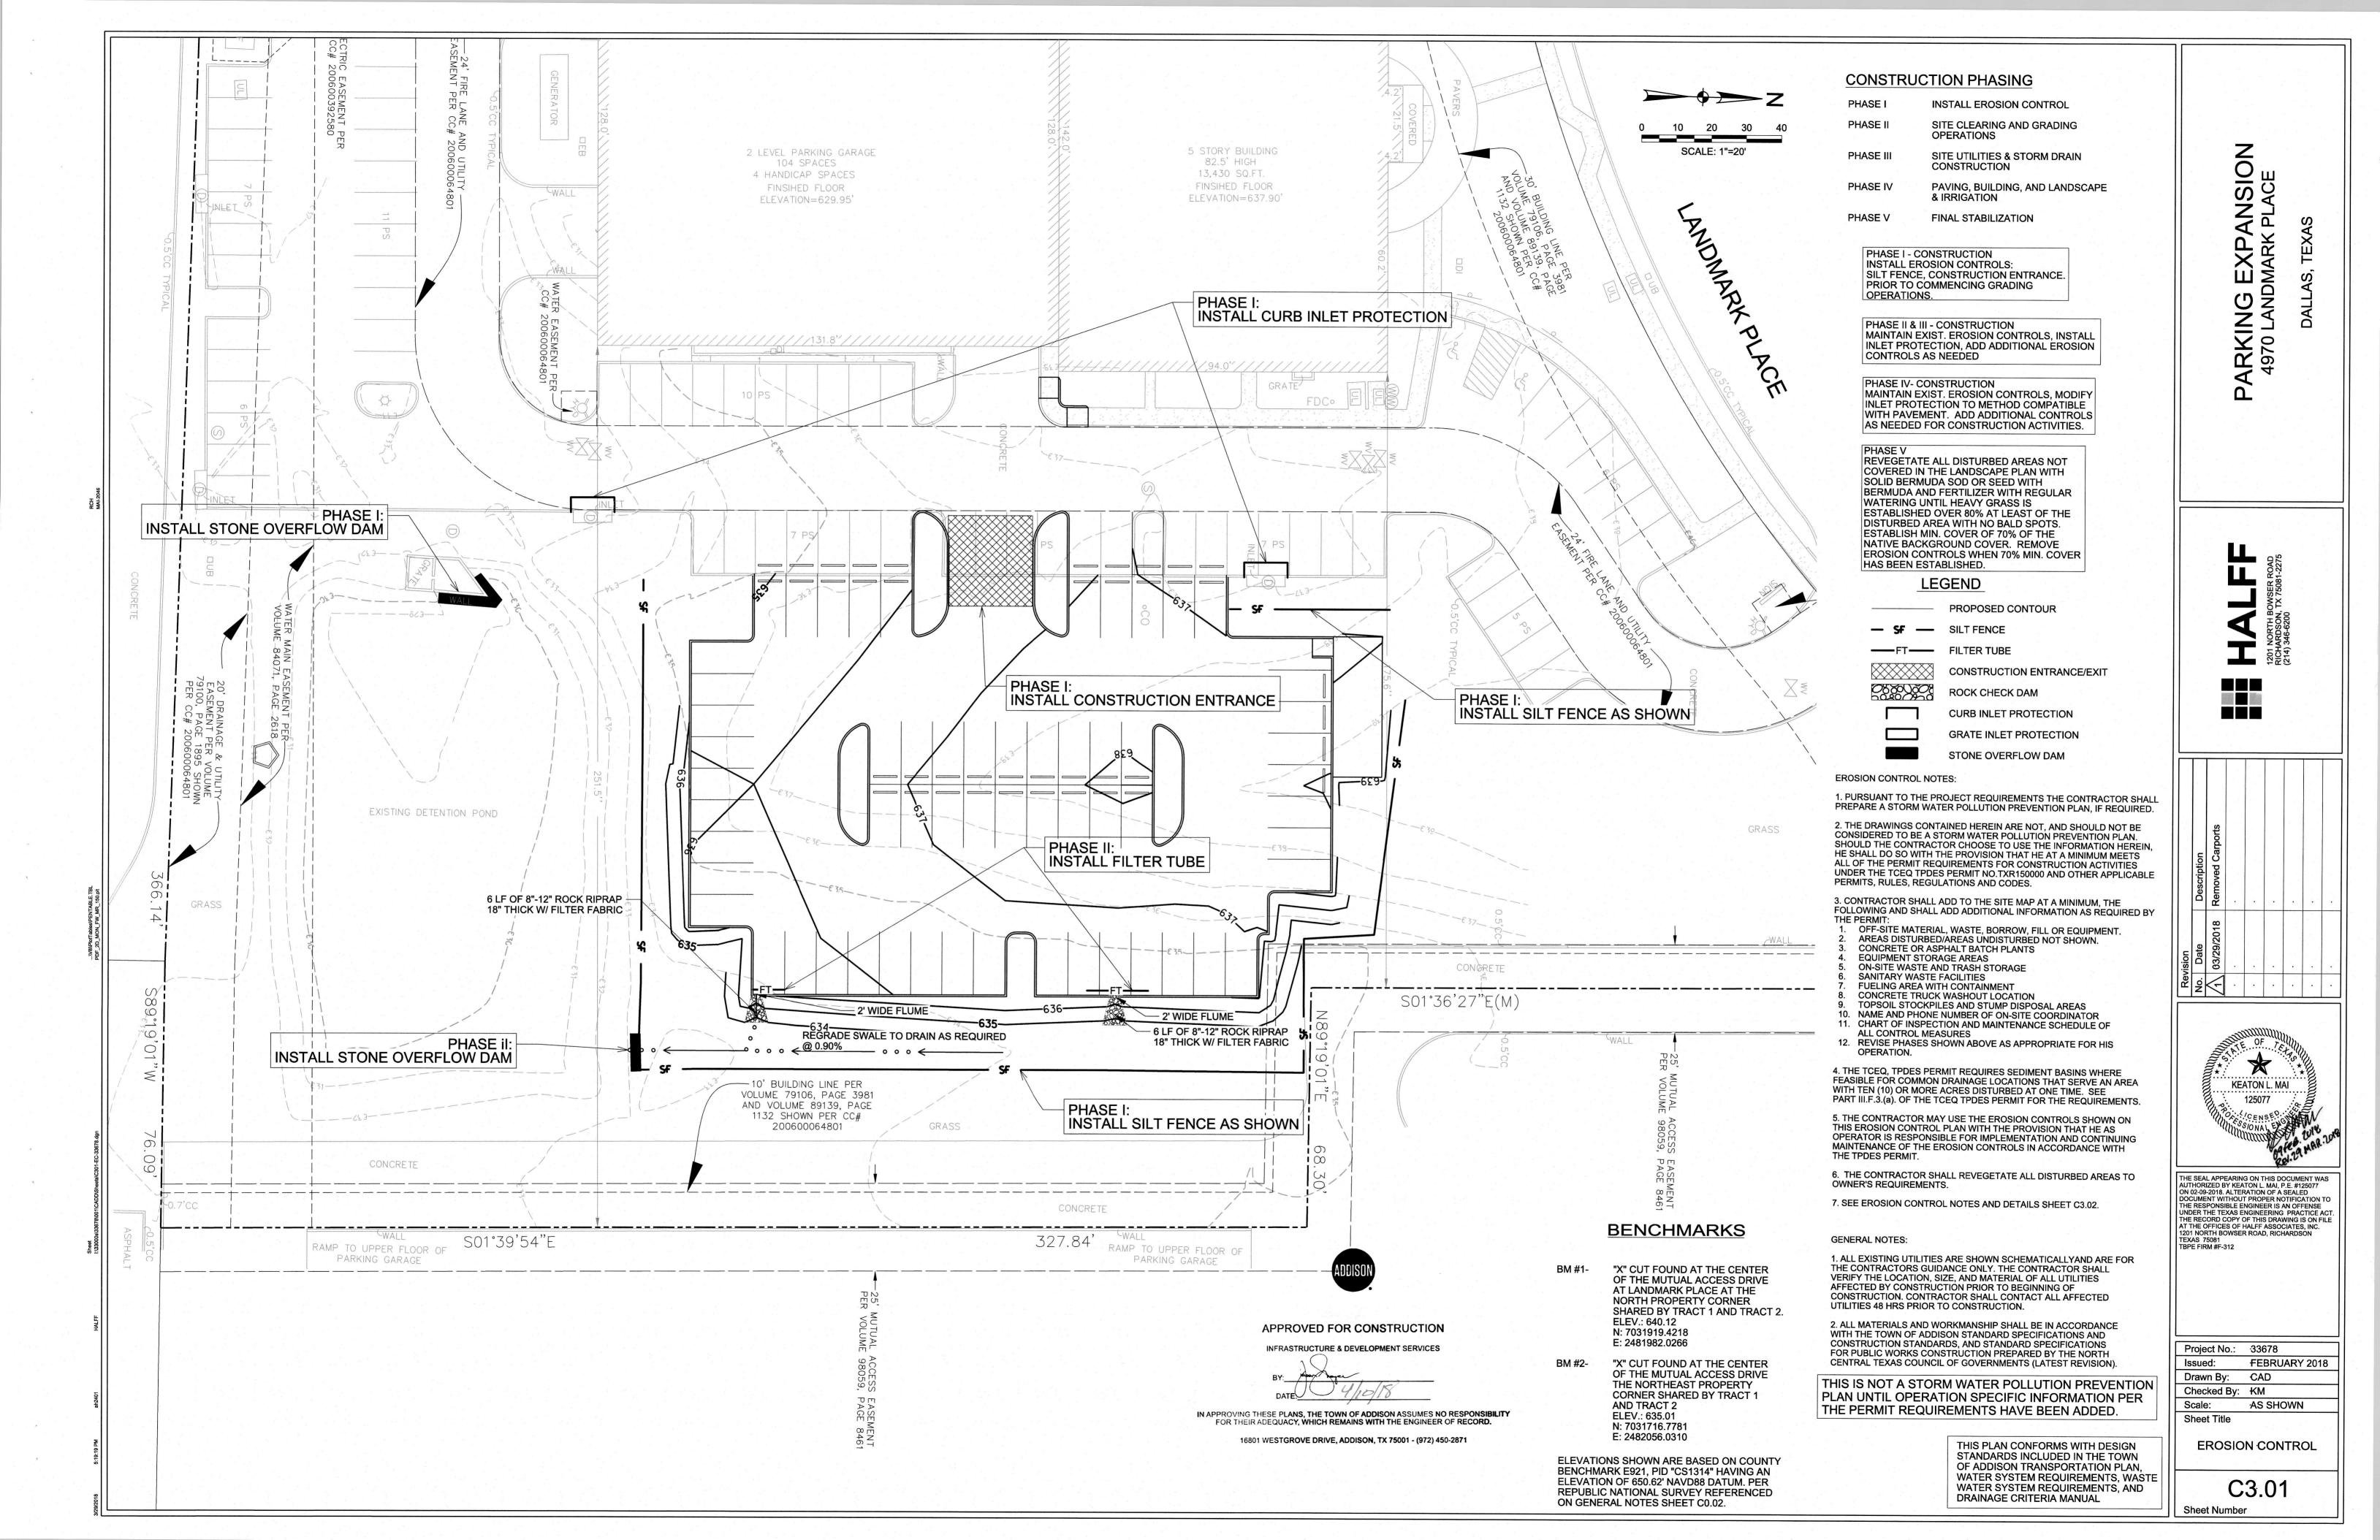

- 1. The Contractor is responsible for implementing a Storm Water Pollution Prevention Plan (SWP3) in accordance with TCEO Texas Pollutant Discharge Elimination System (TPDES) Permit No. TXR150000 (PERMIT). The details shown on this sheet represent typical methods for controlling erosion during construction and are intended for the Contractors guidance in the implementation of the Pollution Prevention Plan. The plan shall comply with the PERMIT and Federal. State and local requirements. The plan shall include, but not be limited to, preparation and submittal of a Notice of Intent (NOI) to the TCEO, if the project is 5 acres or larger and preparation of all plans and documentation as required by the PERMIT.
- 2. It is the intent of the information provided on these documents to be used as a general guideline for the Contractor. The SWP3 to be prepared shall meet the current requirements set forth in the TCEO's TPDES generalpermit for storm water discharges from construction sites as well as any local requirements.
- 3. The Contractor shall be responsible for maintaining erosion controlduring construction and for obtaining any required construction related drainage permits, or making any construction related notifications. An inspection report that summarizes inspection activities and implementation of the SWP3 shall be performed as required by the PERMIT and retained by the Contractor and made a part of the construction documents. The Contractor shall provide copies of all SWP3 documents including, but not limited to, inspection records, original plans, and modified plans to the Owner at contract close-out. During construction the contractor shall provide copies of the inspection reports to the Owner on a monthly basis.
- 4. Temporary storm drainage and/or erosion control material shall be suitable for this application and shall be installed with the proper techniques by the Contractor as required by NCTCOG Standard Specifications for Public Works Construction. Temporary storm drainage and/or erosion controlmaterial shall be removed by the Contractor, in addition to any excavations backfilled by the Contractor, in accordance with NCTCOG Standard Specifications for Public Works Construction when temporary erosion control devices are no longer needed as specified in the PERMIT. Maintenance of the permanent erosion control measures at the site will be assumed by the Owner at contract close out and acceptance of the work.
- 5. The Contractor shall maintain the SWP3 in accordance with the TCEO Permit and make the SWP3 available, upon request, to the TCEQ and/or Owner.
- 6. The Contractor must amend the SWP3 whenever there is a change in design, construction, operation, or maintenance of the SWP3, or when the existing SWP3 proves ineffective. Modifications shall not compromise the intent of the requirements of the PERMIT. Modifications including design and all additional materials and work shall be accomplished by the Contractor at no additional expense to the Owner.
- 7. The Contractor shall inspect his stabilization and erosion control measures at a minimum of once every 14 days, and within 24 hours after any storm event greater than 0.5 inches, or once every 7 days. The Contractor shall repair inadequacies revealed by the inspection before the next storm event and he shall modify his SWP3 within 7 days of the inspection.
- 8. The Contractor shall adopt and implement appropriate construction site management practices to prevent the discharge of oils, grease, paints, gasoline, and other pollutants to storm water. Appropriate practices shall include, but not be limited to: designating areas for equipment maintenance and repair; collecting wastes periodically; maintaining conveniently located waste receptacles, and designating and controlling equipment washdown.
- 9. Borrow areas, if excavated, shall be protected and stabilized by the Contractor in a manner acceptable to the Owner and in accordance with PERMIT requirements.
- 10. All non-paved areas shall be seeded and mulched with erosion protection grass by the Contractor immediately upon completion of final grading. This includes all ditches and embankments. The Contractor shall maintain final grading. and keep seeded areas watered until fully established and accepted by Owner.
- 11. The Contractor shall construct a silt fence at locations suggested on plans as appropriate or as modified in his SWP3 to fit site conditions at the time of placement, and all borrow and stock pile areas. The silt fence shall be constructed as detailed on this plan. The Contractor shall remove accumulated silt when it reaches a depth 6 inches. The Contractor shall dispose of the removed silt in a location approved by the Owner and in such a manner as to not contribute to erosion and sedimentation. The Contractor shall remove the silt fence when the site is completely stabilized in accordance with the PERMIT.
- 12. The Contractor shall designate material and equipment storage areas mutually agreed to by the Owner. The storage areas shall be graded for positive drainage, and the surface stabilized with a minimum of 2 inches of compacted flex base on 6 inches of scarified and recompacted subgrade by the Contractor. A silt fence shall be installed by the Contractor around the storage areas to prevent eroded material from leaving the site.
- 13. All inlets (onsite and offsite) receiving drainage water from disturbed areas shall be protected by the Contractor as per details shown or other Owner approved methods to prevent eroded material from being transported into inlets. The inlet protection shall be constructed as shown on these plans.


THIS IS NOT A STORM WATER POLLUTION PREVENTION PLAN. THE CONTRACTOR MUST PREPARE ALL RELEVANT DOCUMENTS INCLUDING

REQUIRED BY THE PERMIT.

HIS OPERATION SPECIFIC INFORMATION PER THE TCEQ TPDES PERMIT


NO. TXR150000, INCLUDING ALL DOCUMENTATION & CERTIFICATIONS AS


14. The notes and details contained herin do not relieve the Contractor and Owner of meeting and implementing the requirements of the PERMIT.

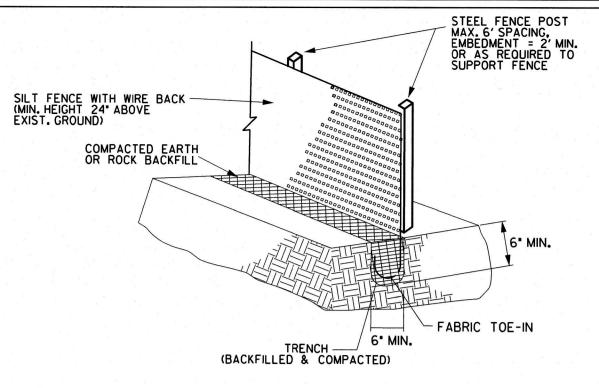

SILT FENCE N.T.S.

- SILT FENCE GENERAL NOTES:
- 1. STEEL POSTS WHICH SUPPORT THE SILT FENCE SHALL BE INSTALLED WITH A SLIGHT ANGLE TOWARD THE ANTICIPATED RUNOFF SOURCE. POST MUST BE EMBEDDED A MINIMUM OF TWO FEET.
- 2. THE TOE OF THE SILT FENCE SHALL BE TRENCHED IN WITH A SPADE OR MECHANICAL TRENCHER, SO THAT THE DOWNSLOPE FACE OF THE TRENCH IS FLAT AND PERPENDICULAR TO THE LINE OF FLOW. WHERE FENCE CANNOT BE TRENCHED IN (e.g. PAVEMENT), WEIGHT FABRIC FLAP WITH WASHED GRAVEL ON UPHILL SIDE TO PREVENT FLOW UNDER FENCE.
- 3. THE TRENCH MUST BE A MINIMUM OF 6 INCHES DEEP AND 6 INCHES WIDE TO ALLOW FOR THE SILT FENCE FABRIC TO BE LAID IN THE GROUND AND BACKFILLED WITH COMPACTED MATERIAL.
- 4. SILT FENCE SHOULD BE SECURELY FASTENED TO EACH STEEL SUPPORT POST OR TO WOVEN WIRE, WHICH IS IN TURN ATTACHED TO THE STEEL FENCE POST. THERE SHALL BE A 6' DOUBLE OVERLAP, SECURELY FASTENED WHERE ENDS OF FABRIC MEET.
- 5. INSPECTION SHALL BE MADE WEEKLY OR AFTER EACH RAINFALL. REPAIR OR REPLACEMENT SHALL BE MADE PROMPTLY AS NEEDED.
- 6. SILT FENCE SHALL BE REMOVED WHEN THE SITE IS COMPLETELY STABILIZED SO AS NOT TO BLOCK OR IMPEDE STORM FLOW OR DRAINAGE.
- 7. ACCUMULATED SILT SHALL BE REMOVED WHEN IT REACHES A DEPTH OF 6 INCHES. THE SILT SHALL BE DISPOSED OF IN AN APPROVED SITE AND IN SUCH A MANNER AS TO NOT CONTRIBUTE TO ADDITIONAL SILTATION.

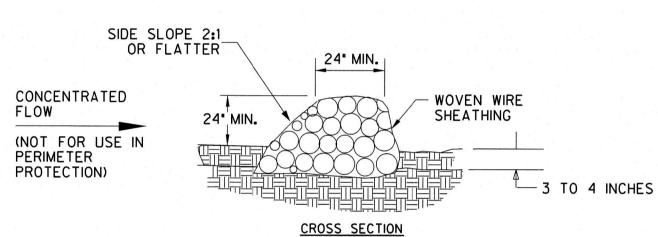

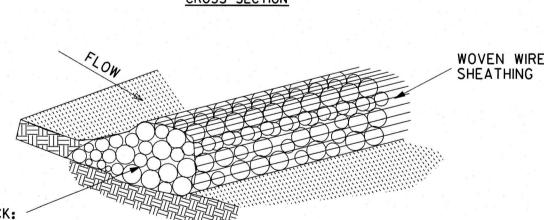


OPEN GRADED ROCK: 4-8" DIAMETER-STREAM FLOW 3-5" DIAMETER-OTHER CONDITIONS

ISOMETRIC VIEW

ROCK CHECK DAM

ROCK CHECK DAM GENERAL NOTES:

- WOVEN WIRE SHEATHING SHALL HAVE MAXIMUM OPENING OF ONE (1)
 INCH AND A MINIMUM WIRE SIZE OF 20 GAUGE AND SHALL BE SECURED
 WITH SHOAT RINGS.
- 2. THE ROCK BERM SHALL BE INSPECTED WEEKLY OR AFTER EACH RAIN AND SHALL BE REPLACED WHEN THE STRUCTURE CEASES TO FUNCTION PROPERLY.
- 3. WHEN SILT REACHES A DEPTH EQUAL TO ONE-THIRD OF THE HEIGHT OF THE BERM OR ONE FOOT, WHICHEVER IS LESS, THE SILT SHALL BE REMOVED AND DISPOSED OF IN AN APPROVED MANNER.
- 4. WHEN THE SITE IS COMPLETELY STABILIZED, THE BERM AND ACCUMULATED SILT SHALL BE REMOVED AND DISPOSED OF IN AN APPROVED MANNER.

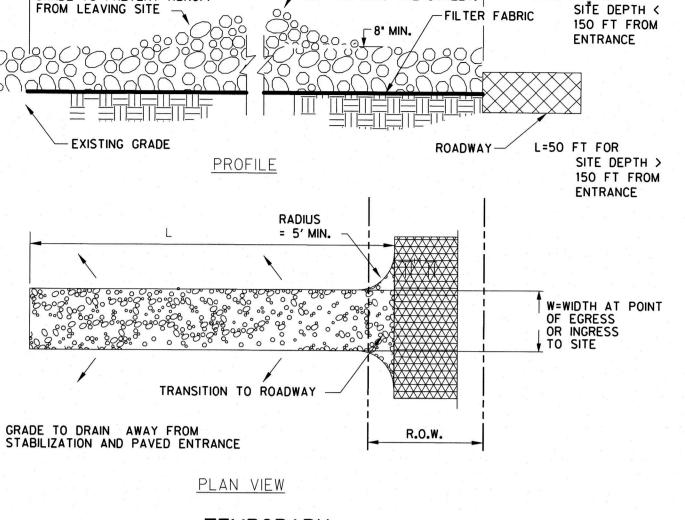


CROWN TO MINIMIZE RUNOFF

GETTING INTO THE STREET.


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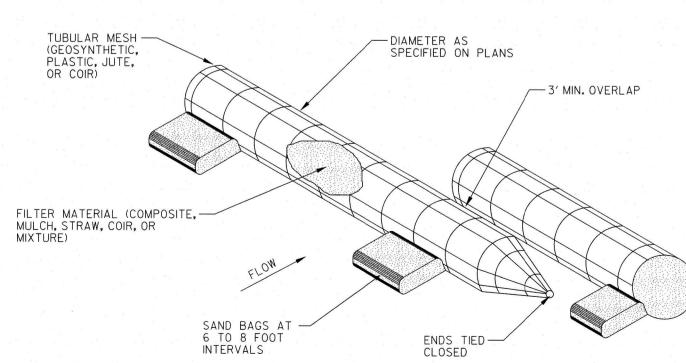
TEMPORARY CONSTRUCTION ENTRANCE DETAIL N.T.S.

GRADE TO PREVENT RUNOFF

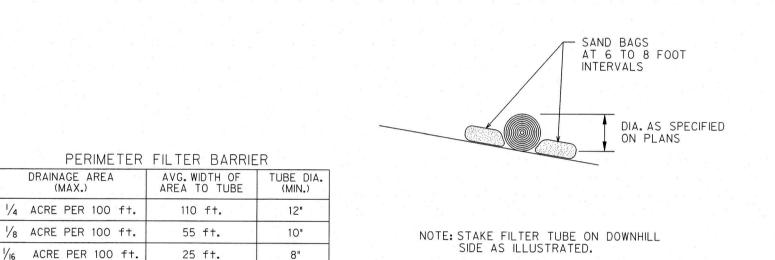

SECTION A-A



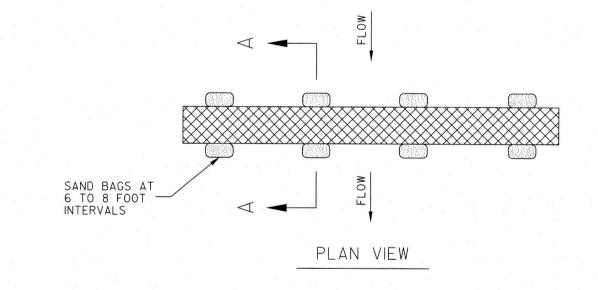

APPROVED FOR CONSTRUCTION




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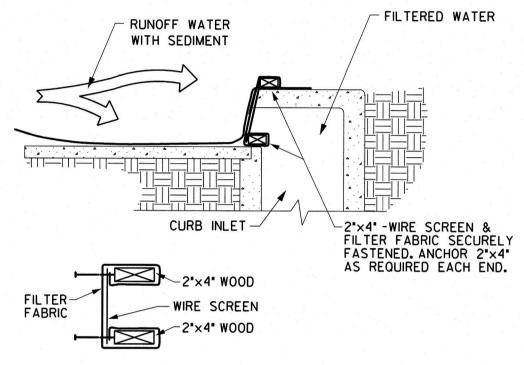
16801 WESTGROVE DRIVE, ADDISON, TX 75001 - (972) 450-2871




1. AN ALTERNATE FILTER TUBE IS A SILT DIKE, EROSION EEL, OR OWNER APPROVED

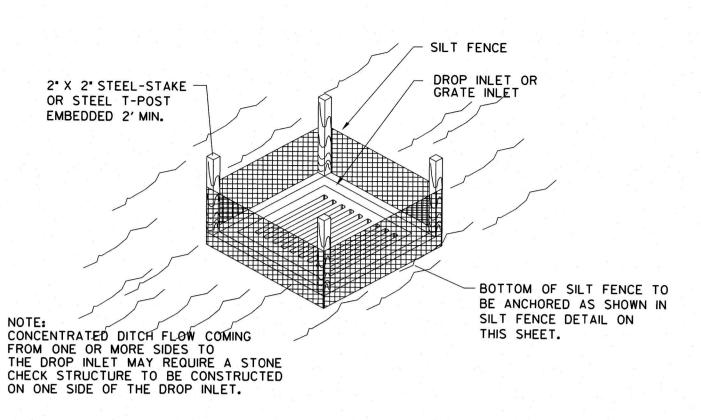


SILT FENCE DROP INLET PROTECTION



FILTER FABRIC CURB INLET PROTECTION N.T.S.

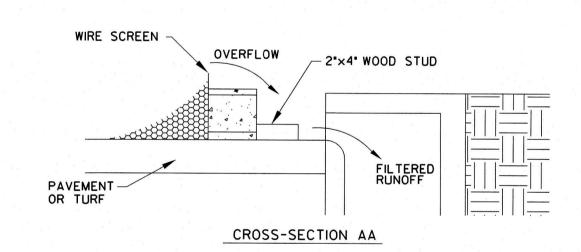

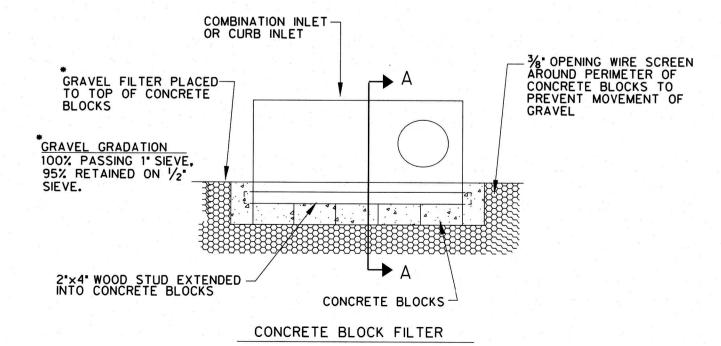


COMBINATION CURB INLET FILTER PROTECTION

N.T.S.

THIS PLAN CONFORMS WITH DESIGN STANDARDS INCLUDED IN THE TOWN OF ADDISON TRANSPORTATION PLAN. WATER SYSTEM REQUIREMENTS, WASTE WATER SYSTEM REQUIREMENTS, AND DRAINAGE CRITERIA MANUAL

ANSION RKING 4970 LAND

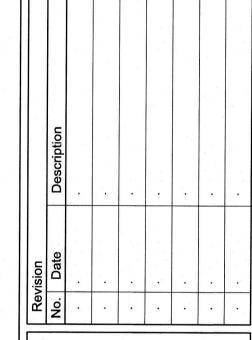




THE SEAL APPEARING ON THIS DOCUMENT WAS AUTHORIZED BY KEATON L. MAI, P.E. #12507 ON 02-09-2018. ALTERATION OF A SEALED DOCUMENT WITHOUT PROPER NOTIFICATION T THE RESPONSIBLE ENGINEER IS AN OFFENSE UNDER THE TEXAS ENGINEER IS AN OFFENSE UNDER THE TEXAS ENGINEERING PRACTICE ACT. THE RECORD COPY OF THIS DRAWING IS ON FILE AT THE OFFICES OF HALFF ASSOCIATES, INC. 1201 NORTH BOWSER ROAD, RICHARDSON TEXAS 75081 TBPE FIRM #F-312

Project No.: 33678 **FEBRUARY 2018** Issued: Drawn By: CAD


Checked By: KM Scale: **AS SHOWN** Sheet Title

EROSION CONTROL NOTES & DETAILS

C3.02 Sheet Number

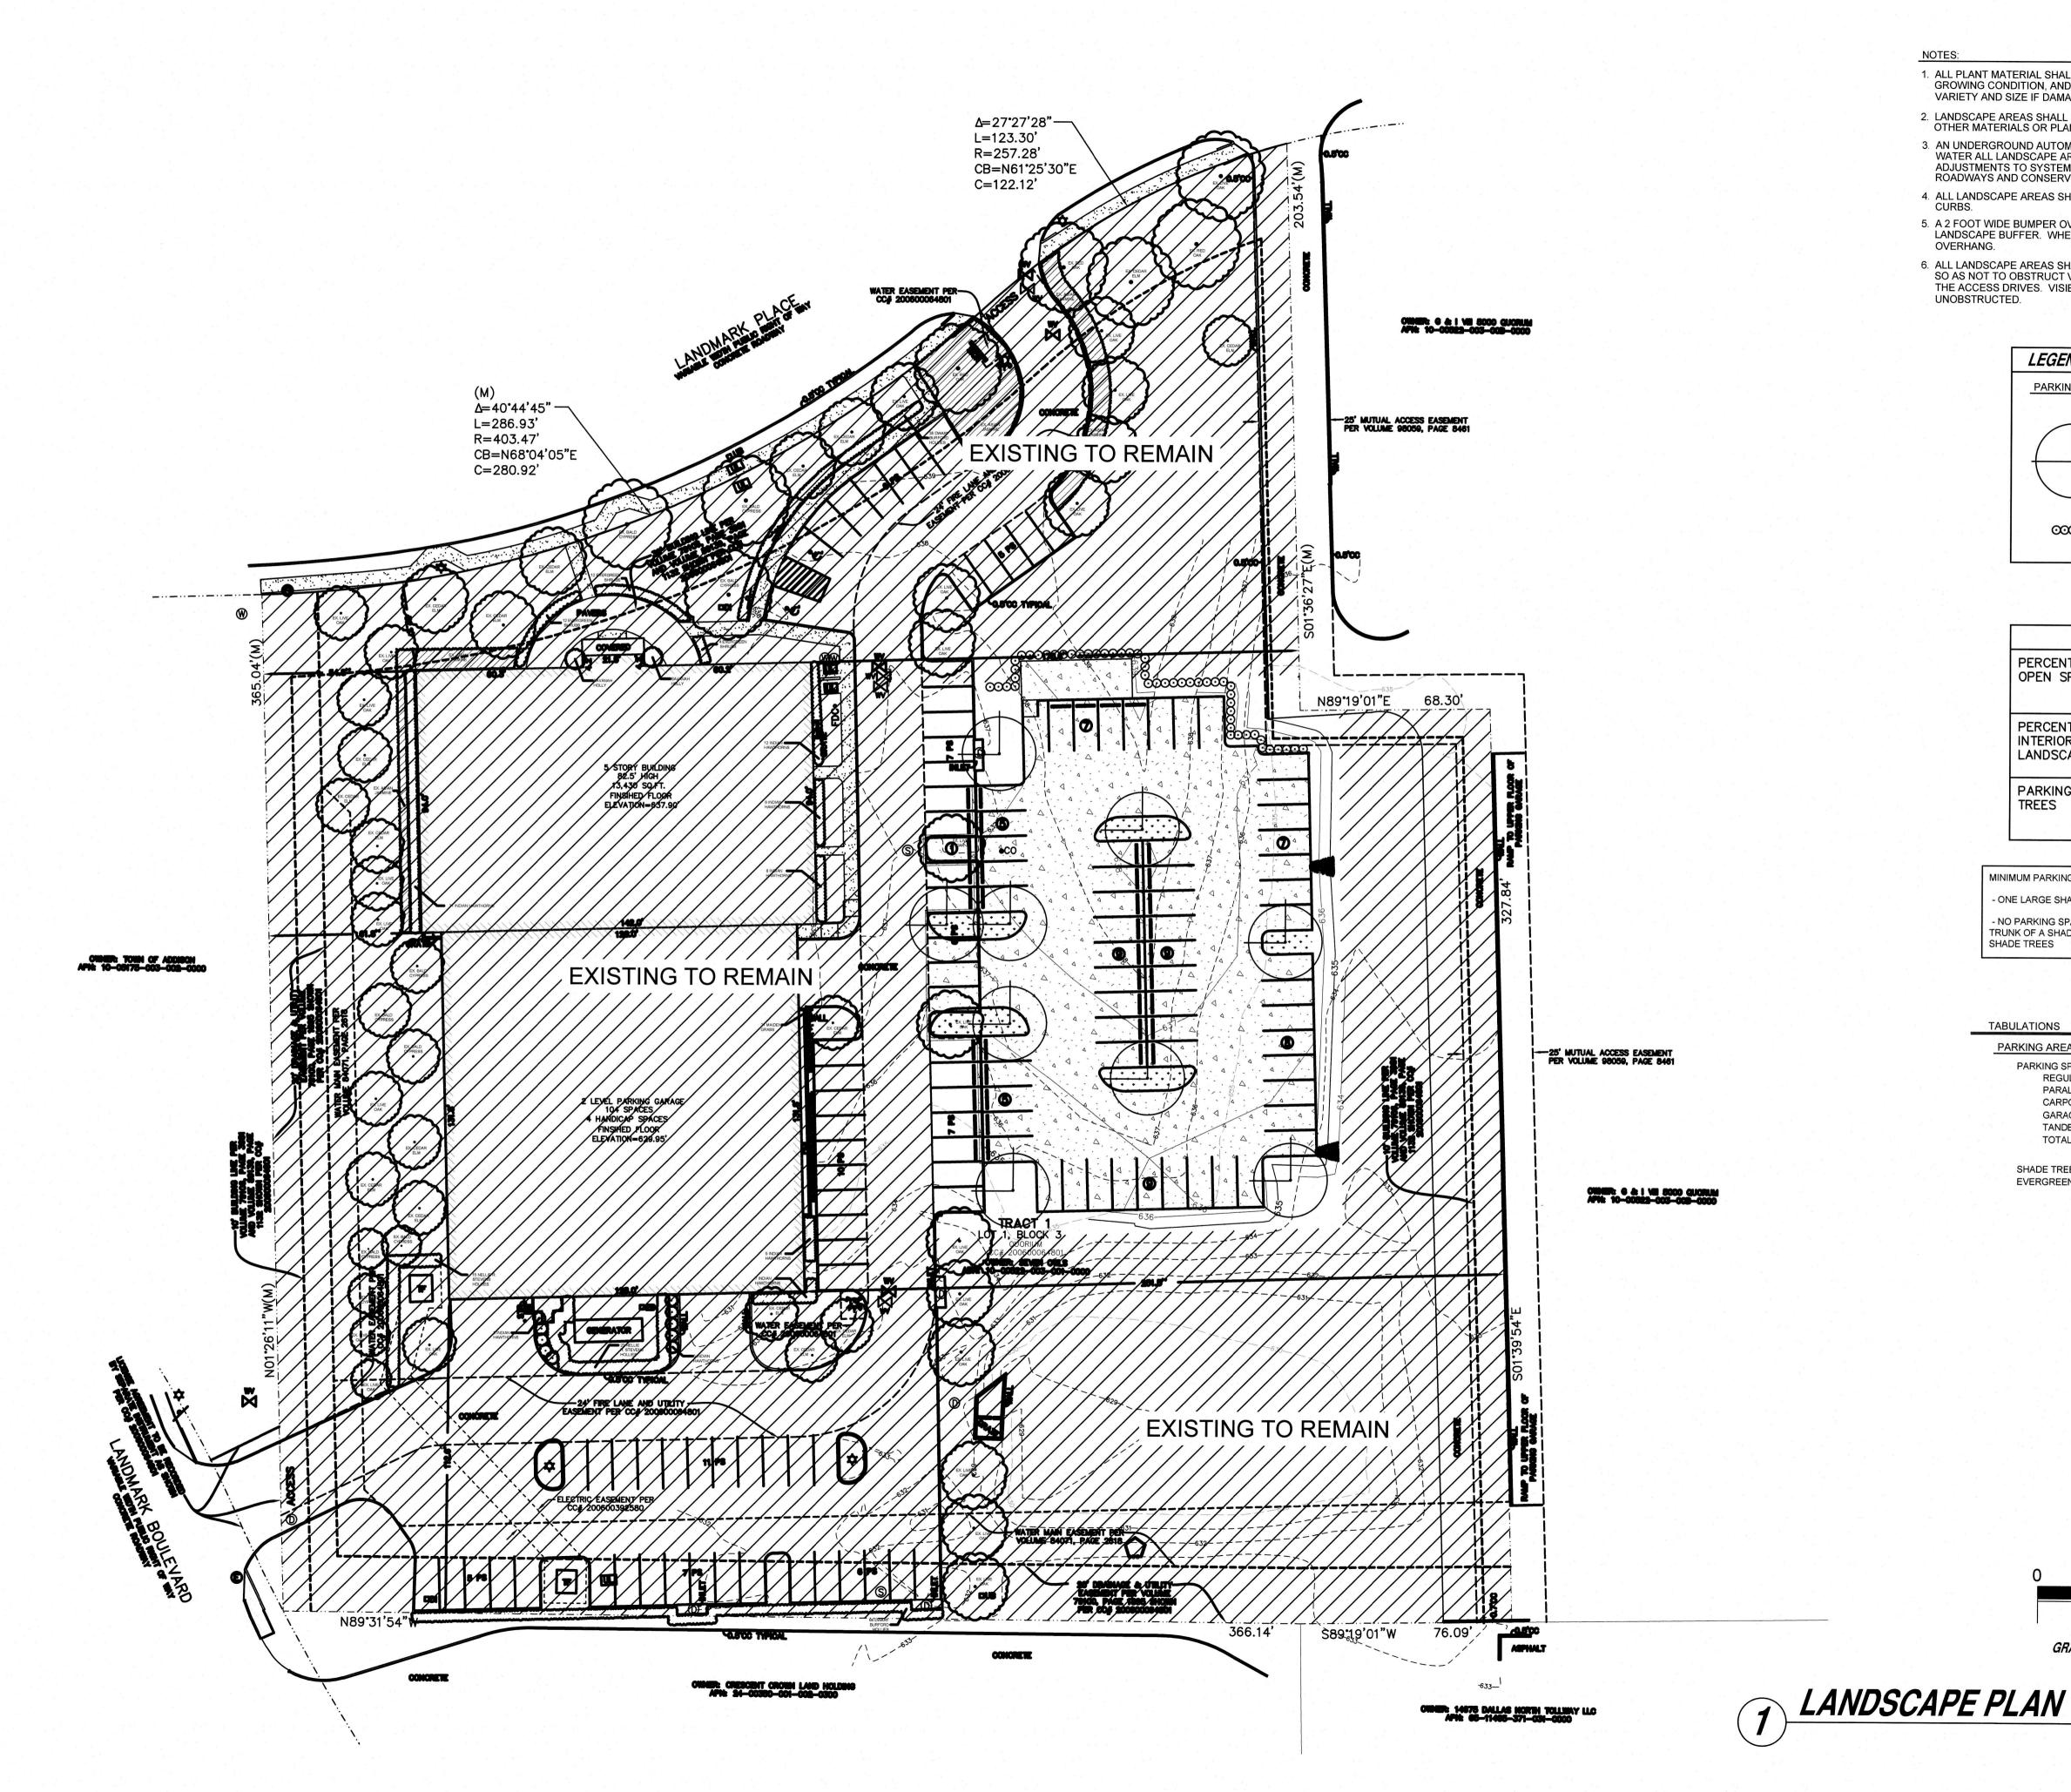

- 1. ALL PLANT MATERIAL SHALL BE MAINTAINED BY OWNER IN A HEALTHY AND GROWING CONDITION, AND REPLACED WITH PLANT MATERIAL OF SIMILAR VARIETY AND SIZE IF DAMAGED, DESTROYED OR REMOVED.
- LANDSCAPE AREAS SHALL BE KEPT FREE OF TRASH, LITTER, WEEDS AND OTHER MATERIALS OR PLANTS NOT A PART OF THE LANDSCAPING.
- 3. AN UNDERGROUND AUTOMATIC IRRIGATION SYSTEM SHALL BE INSTALLED TO WATER ALL LANDSCAPE AREAS, INCLUDING RIGHT-OF-WAY AREAS. ADJUSTMENTS TO SYSTEM WILL LIMIT OVER-SPRAY ONTO ADJACENT ROADWAYS AND CONSERVE WATER TO THE GREATEST EXTENT POSSIBLE.
- 4. ALL LANDSCAPE AREAS SHALL BE PROTECTED BY RAISED SIX INCH CONCRETE
- 5. A 2 FOOT WIDE BUMPER OVERHANG SHALL PROVIDED IN ADDITION TO LANDSCAPE BUFFER. WHEEL STOPS MAY BE USED IN LIEU OF BUMPER OVERHANG.
- 6. ALL LANDSCAPE AREAS SHALL BE CONSTRUCTED, INSTALLED AND MAINTAINED SO AS NOT TO OBSTRUCT VIEW OF MOTORISTS BETWEEN THE STREET AND THE ACCESS DRIVES. VISIBILITY TRIANGLES SHALL ALWAYS REMAIN UNOBSTRUCTED.

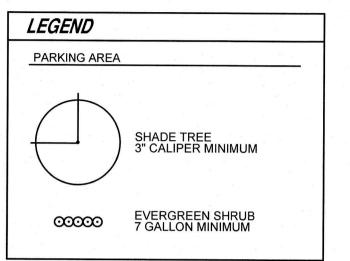

	REQUIRED	PROVIDED
PERCENTAGE OF OPEN SPACE	10%	10%
PERCENTAGE OF INTERIOR PARKING LANDSCAPE	5%	10%
PARKING LOT TREES	6	9

MINIMUM PARKING LOT TREE REQUIREMENTS:


- ONE LARGE SHADE TREE PER 10 PARKING SPACES

- NO PARKING SPACE MAY BE LOCATED FURTHER THAN 50' FROM THE TRUNK OF A SHADE TREE, OR FARTHER THAN 75' FROM TWO OR MORE SHADE TREES

0	TABULATIONS	i en e ^{n e} n de	1 44 1 1 1 1 1 1 1 1 1 1 1 1 1 1 1 1 1
	PARKING AREA	11	
	PARKING SPACES REGULAR PARALLEL CARPORT GARAGE TANDEM TOTAL:		61 0 0 0 0 0
	SHADE TREES PROVIDED: EVERGREEN SHRUBS PROVIDED:		9 52

*Thes and Shrubs must be from Towns approved 1 St.

NOTE: NO TREE IS TO BE PLANTED CLOSER THAN 36" TO THE PAVED PORTION OF ANY PARKING SURFACE

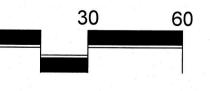



GRAPHIC SCALE IN FEET

SCALE: 1"=30'-0"

CLIENT:

E.S. Frankfurt Management, Inc. 5950 Sherry Lane Suite 205 Dallas, TX 75225

Contact: Eric Frankfurt

landscape architects Meeks Design Group 1755 n. collins blvd., #300 richardson, tx 75080 p: (972) 690-7474 f: (972) 690-7878



PERMIT

ADDISON, TEXAS OB NUMBER: LWD-1801

LANDSCAPE PLAN

LP0.01