

ID STUDIO 4, LLC

1431 GREENWAY DR. SUITE 150 IRVING, TEXAS 75038 TEL: 972.870.1288 WWW.IDSTUDIO4.COM

FRONT BURNER RESTAURANTS 5206 BELT LINE ROAD DALLAS, TEXAS 75254

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8-5-2019

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Design Cumulus Firm #14810 2080 N. Highw Grand Prairie, Tel. 214.235.0


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SHEET NAME:

DEMOLITION PLAN


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AND DETAILS

CHANGES MADE TO PLANS BASED ON INFORMATION PROVIDED BY CONTRACTOR/OWNER/DESIGN TEAM. SET FOR REFERENCE ONLY.

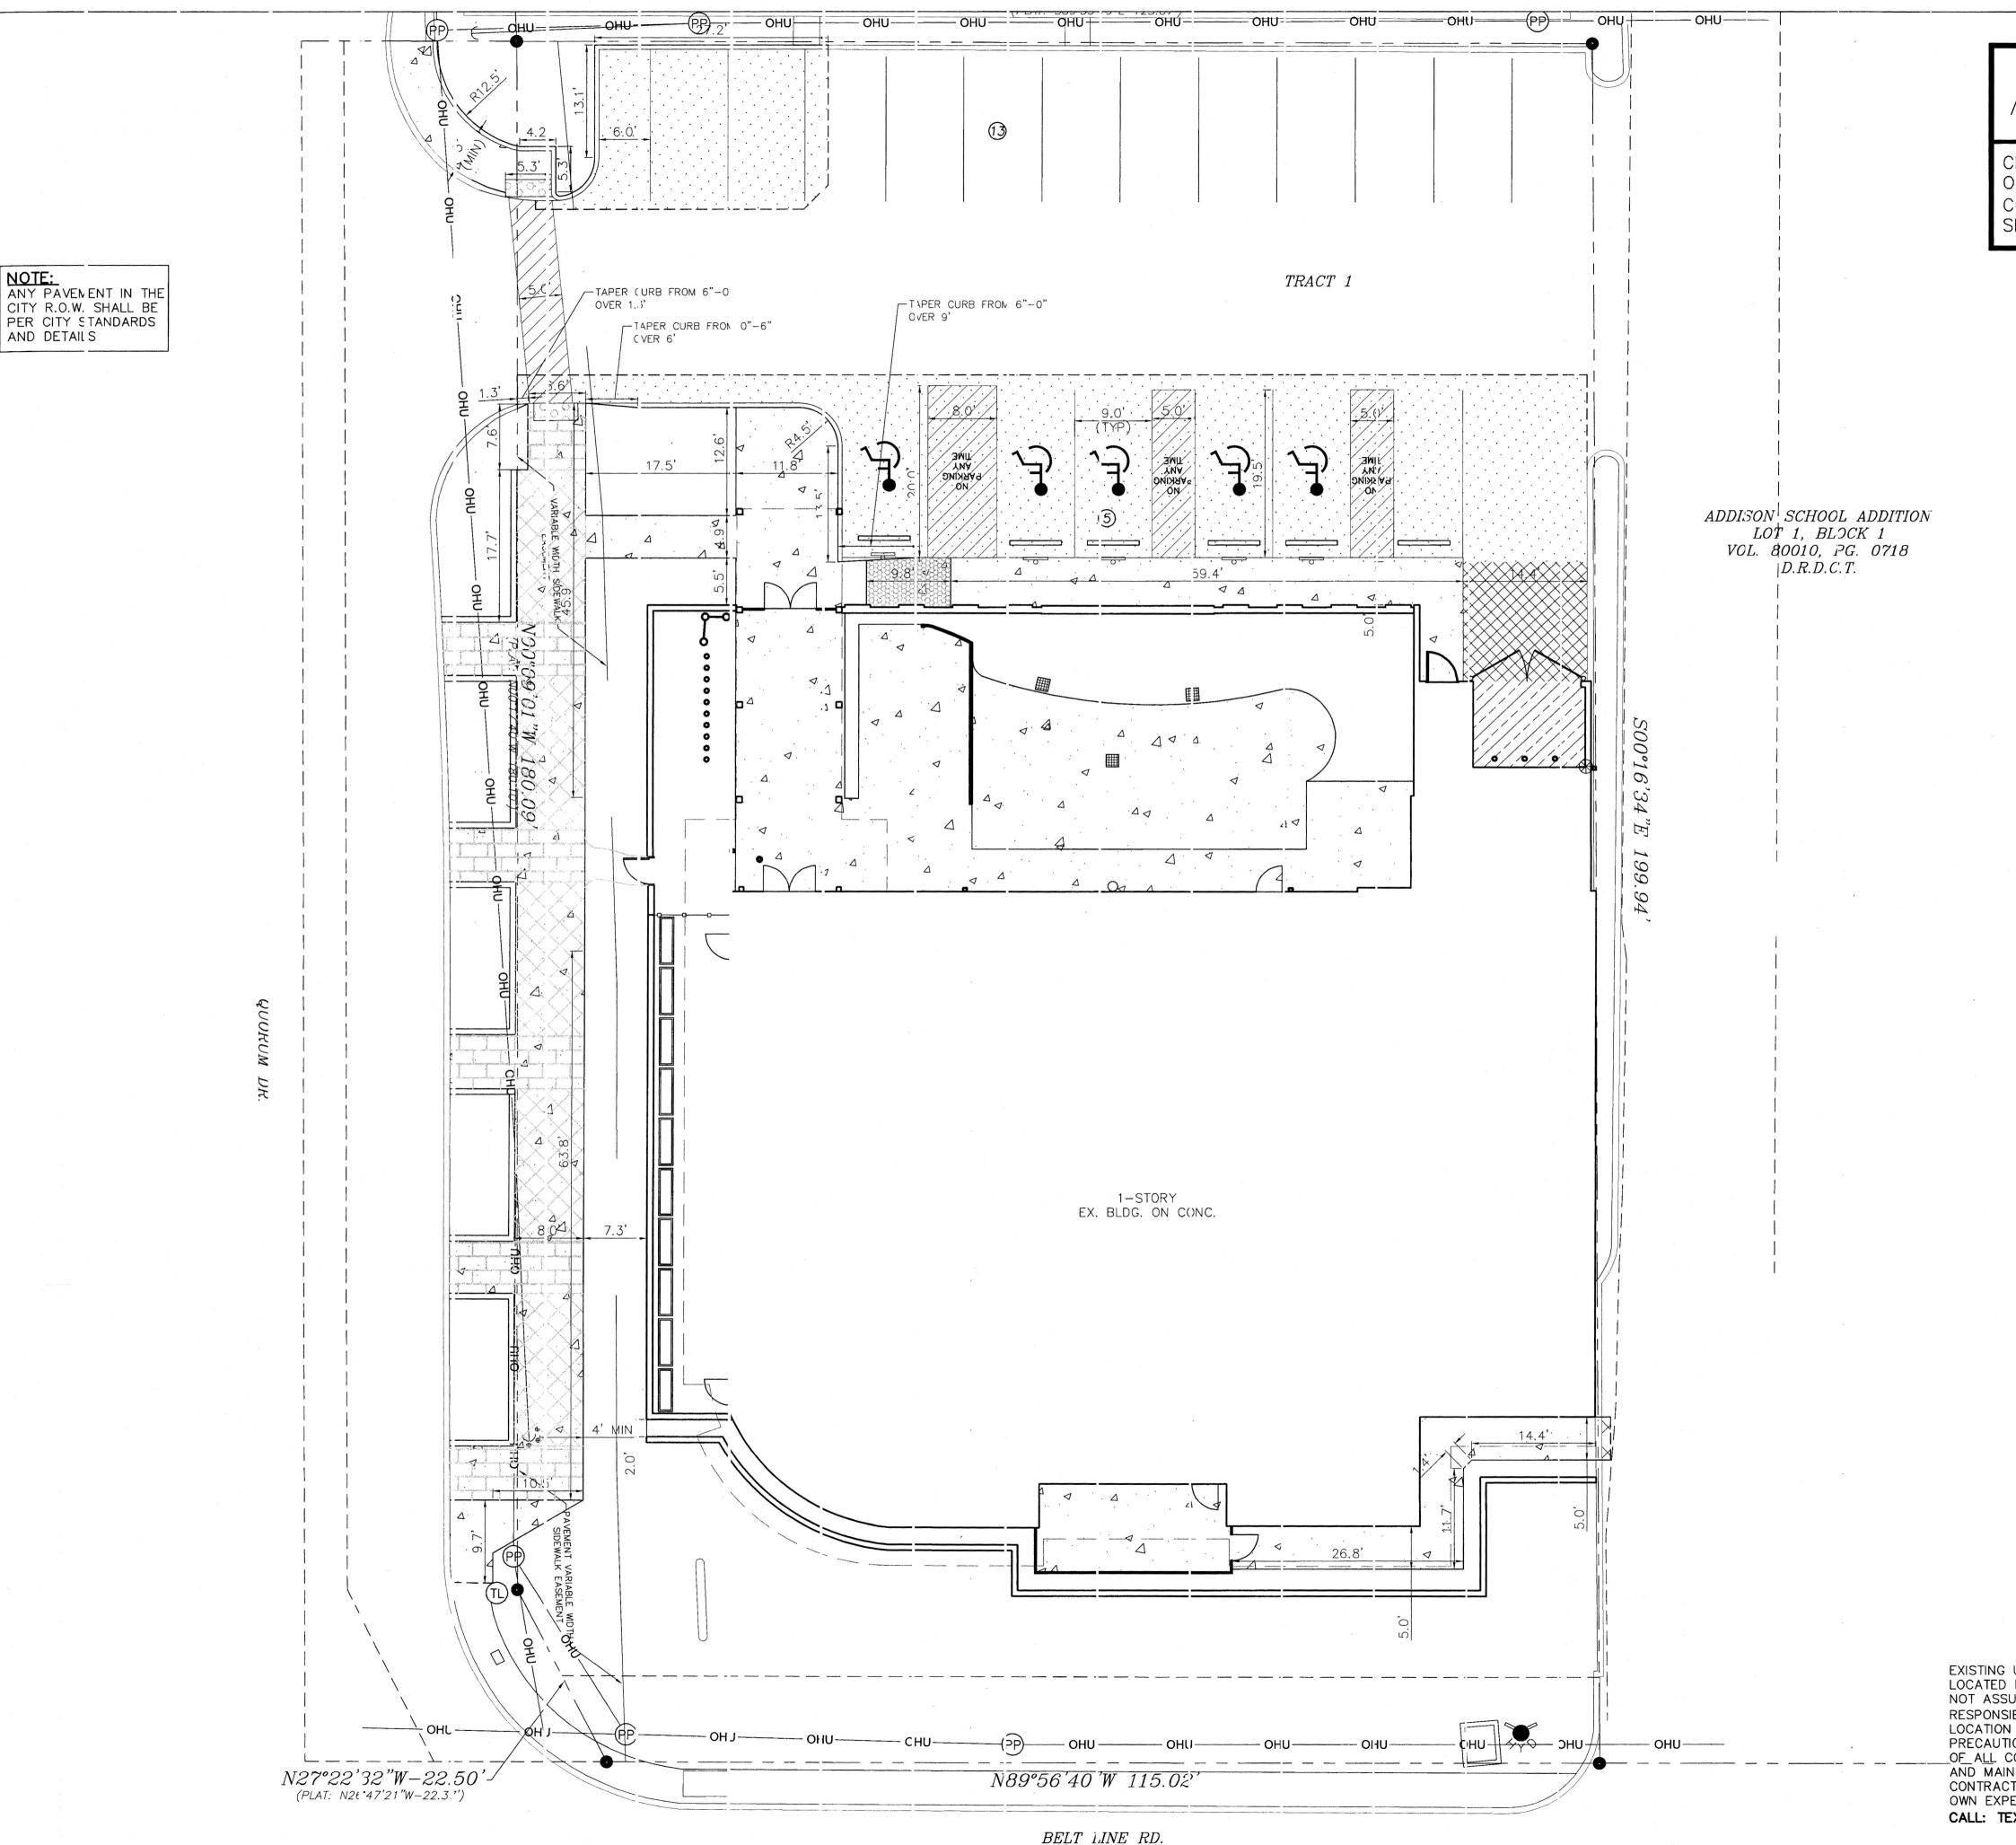

LEGEND

— — EXISTING CURB

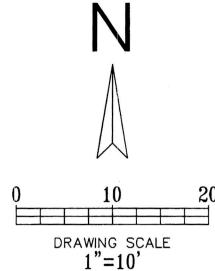- CONSTRUCT LONGITUDINAL BUTT JOINT

- PROPOSED PARKING SPACES IN A ROW

- PROPOSED BARRIER FREE RAMP

----- - PROPOSED SAWCUT

REPORT).

- 4" 3000 PSI REINFORCED CONCRETE PAVEMENT. REFERENCE ARCHITECT LANDSCAPE PLANS FOR ADDITIONAL INFORMATION.

- 5" 3600 PSI REINFORCED CONCRETE PAVEMENT


ON 6" MINIMUM STABILIZED SUBGRADE (PER



GEOTECHNICAL REPORT). -- 8" 3600 PSI REINFORCED CONCRETE (#3 BARS AT 12" O.C.E.W.) PAVEMENT ON LIME STABILIZED AND COMPACTED SUBGRADE (PER GEOTECHNICAL



REFERENCE STRUCTURAL PLANS FOR DUMPSTER AREA

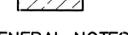

WHERE THEY ABUT.

 ALL MATERIALS AND CONSTRUCTION WITHIN STREET RIGHT-OF-WAY SHALL CONFORM TO THE CITY STANDARD CONSTRUCTION DETAILS AND SPECIFICATIONS.

- 2. IT SHALL BE THE RESPONSIBILITY OF THE CONTRACTOR TO PROTECT ALL PUBLIC UTILITIES IN THE CONSTRUCTION OF THIS PROJECT. ALL MANHOLES, CLEANOUTS, VALVE BOXES, FIRE HYDRANTS, ETC. MUST BE ADJUSTED TO PROPER LINE AND GRADE BY THE CONTRACTOR PRIOR TO AND AFTER THE FLACING OF PERMANENT PAVING. UTILITIES MUST BE MAINTAINED TO PROPER LINE AND GRADE DURING CONSTRUCTION OF THIS
- 3. THE CONTRACTOR SHALL BE RESPONSIBLE FOR COORDINATING WITH ALL APPROPRIATE UTILITY COMPANIES FOR THE LOCATION OF ALL UTILITIES WITHIN THE CONSTRUCTION AREA.
- 4. THE PAVING CONTRACTOR SHALL NOT PLACE PERMANENT PAVEMENT UNTIL ALL SLEEVING FOR IRRIGATION, ELECTRIC GAS, TELEPHONE, CABLE TV. SITE IRRIGATION WATER LINES, ETC. HAVE BEEN TESTED AND PASSED. IT SHALL BE THE PAVING CONTRACTOR'S RESPONSIBILITY TO INSURE THAT ALL SLEEVING IS IN PLACE PRIOR TO PLACING OF PERMANENT
- 5. ALL PAVING AND EARTHWORK OPERATIONS SHALL CONFORM TO THE RECOMMENDATIONS IN THE GEOTECHNICAL INVESTIGATION REPORT.
- 6. ALL DIMENSIONS ARE FROM BACK OF CURB, EDGE OF PAVEMENT, OR FACE OF BUILDING UNLESS OTHERWISE NOTED.
- 7. ALL SIDEWALKS SHALL MAINTAIN A 2% MAXIMUM CROSS SLOPE AND 5% MAXIMUM IN THE DIRECTION OF PEDESTRIAN TRAVEL.
- 8. SLOPE WITHIN THE HANDICAP PARKING AREA SHALL NOT EXCEED 2% IN ANY DIRECTION.

9. CONTRACTOR TO MATCH EXISTING JOINTS WITH JOINTS IN NEW PAVING

- 10. PARKING AND HANDICAP STRIPING TO BE PER ADA/TAS STANDARDS.
- 11. ALL CURB RADII ARE 1.5' UNLESS OTHERWISE SPECIFIED (EXCEPT FOR AT END OF PARKING SPACES AND FLUMES WHERE THE RADII ARE O').
- 12. CONTRACTOR IS RESPONSIBLE FOR PREPARING AND PERMITTING ANY REQUIRED TRAFFIC CONTROL PLAN(S). TCP MUST BE SUBMITTED TO T.O.A. FOR REVIEW AND APPROVAL PRIOR TO BEGINNING CONSTRUCTION.
- 13. ALL PUBLIC R.O.W. WORK TO BE COORDINATED WITH CITY'S DEPARTMENT OF PUBLIC WORKS.
- 14. REFERENCE LANDSCAPE PLAN FOR POSSIBLE PAVERS, SPECIAL SIDEWALK SUFACING, ETC.
- 15. REFERENCE ARCHITECT PLANS FOR STRIPING, SITE SIGNAGE, FINISHES,

!!! CAUTION !!! UNDERGROUND UTILITIES

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CALL: TEXAS ONE CALL @ 1-800-245-4545 AT LEAST 48 HRS PRIOR TO CONSTRUCTION.



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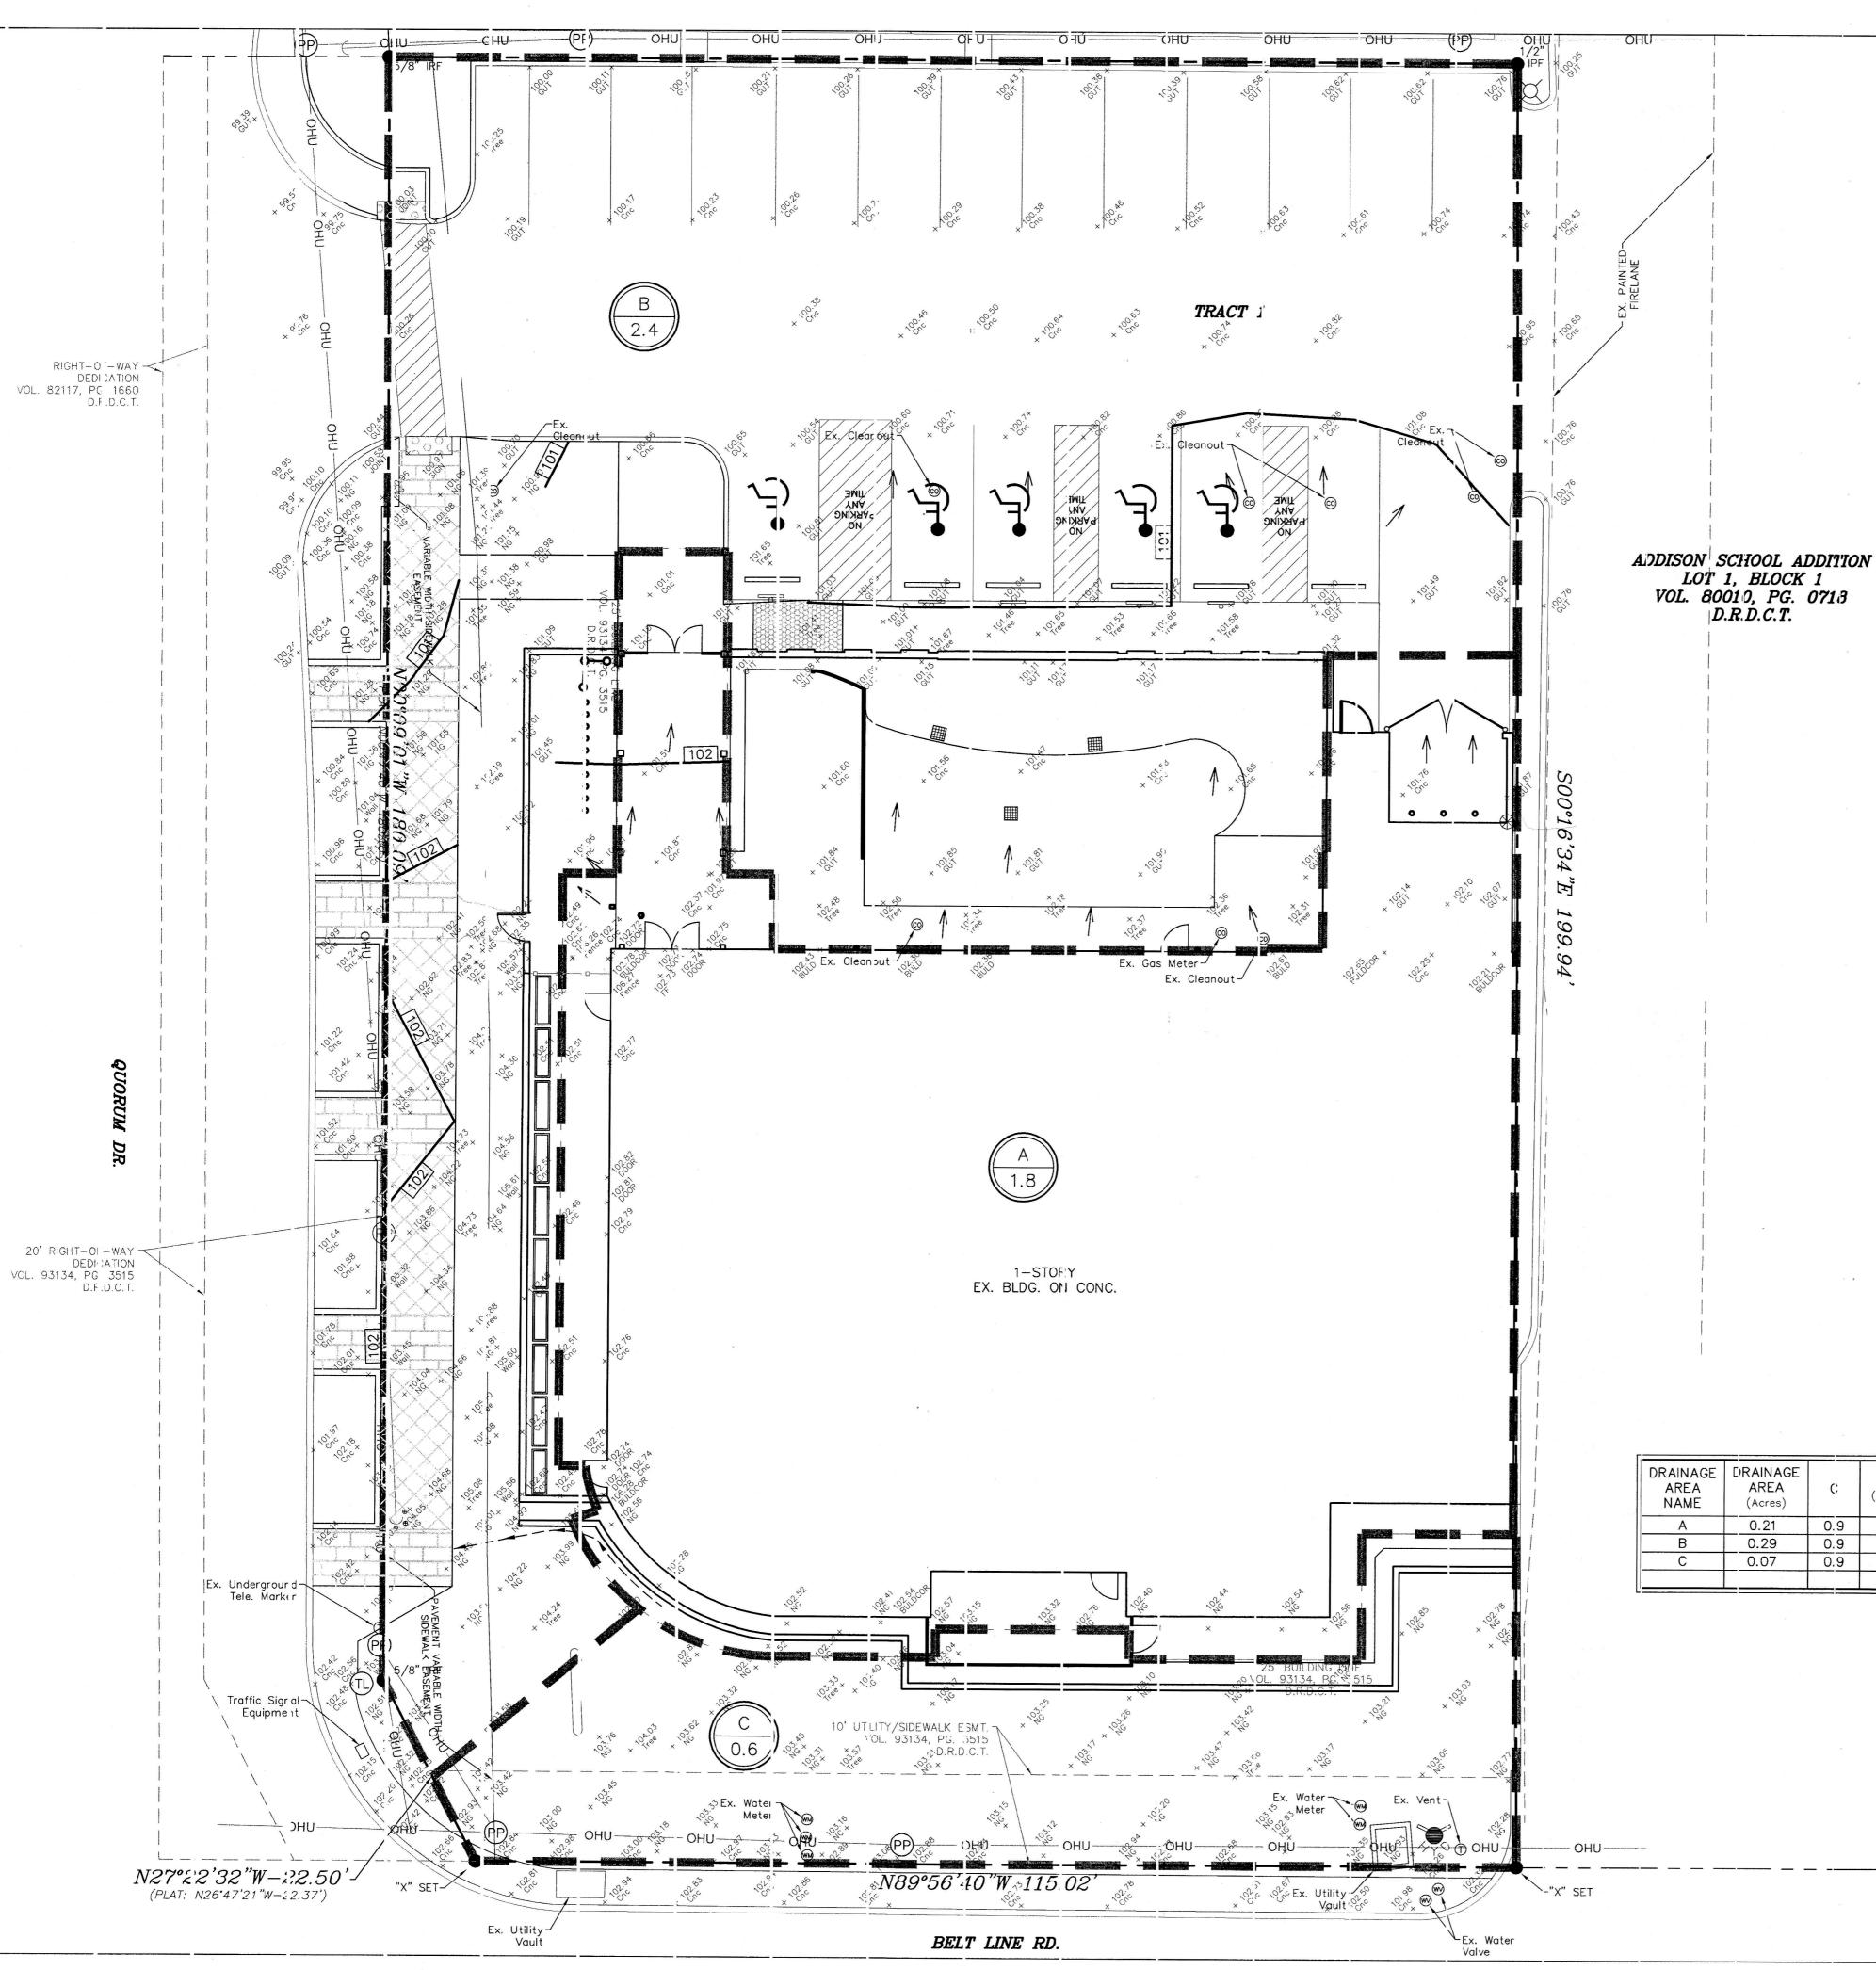
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PAVING PLAN


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PROJECT NUMBER:



CHANGES MADE TO PLANS BASED ON INFORMATION PROVIDED BY CONTRACTOR/OWNER/DESIGN TEAM. SET FOR REFERENCE ONLY.



DRAWING SCALE 1"=10'
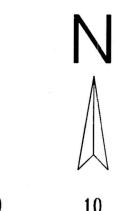
<u>LEGEND</u>

- EXISTING CONTOUR -- PROPOSED CONTOUR

- EXISTING CURB

DRAINAGE CRITERIA

1100=9.27 in/hr tc=10 min.

 $Q=C \mid A$

C=0.90

- - - - - PROPOSED VALLEY

-- PROPOSED FLOW ARROW


- PROPOSED CURB - EXISTING STORM - DRAINAGE AREA DIVIDE

-- PROPOSED RIDGE

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: FRONT BURNER RESTAL 5206 BELT LINE ROAD DALLAS, TEXAS 75254

DESCRIPTION

SHEET NAME:

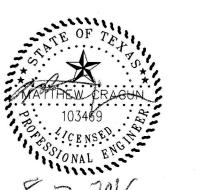DRAINAGE AREA MAP

SHEET:

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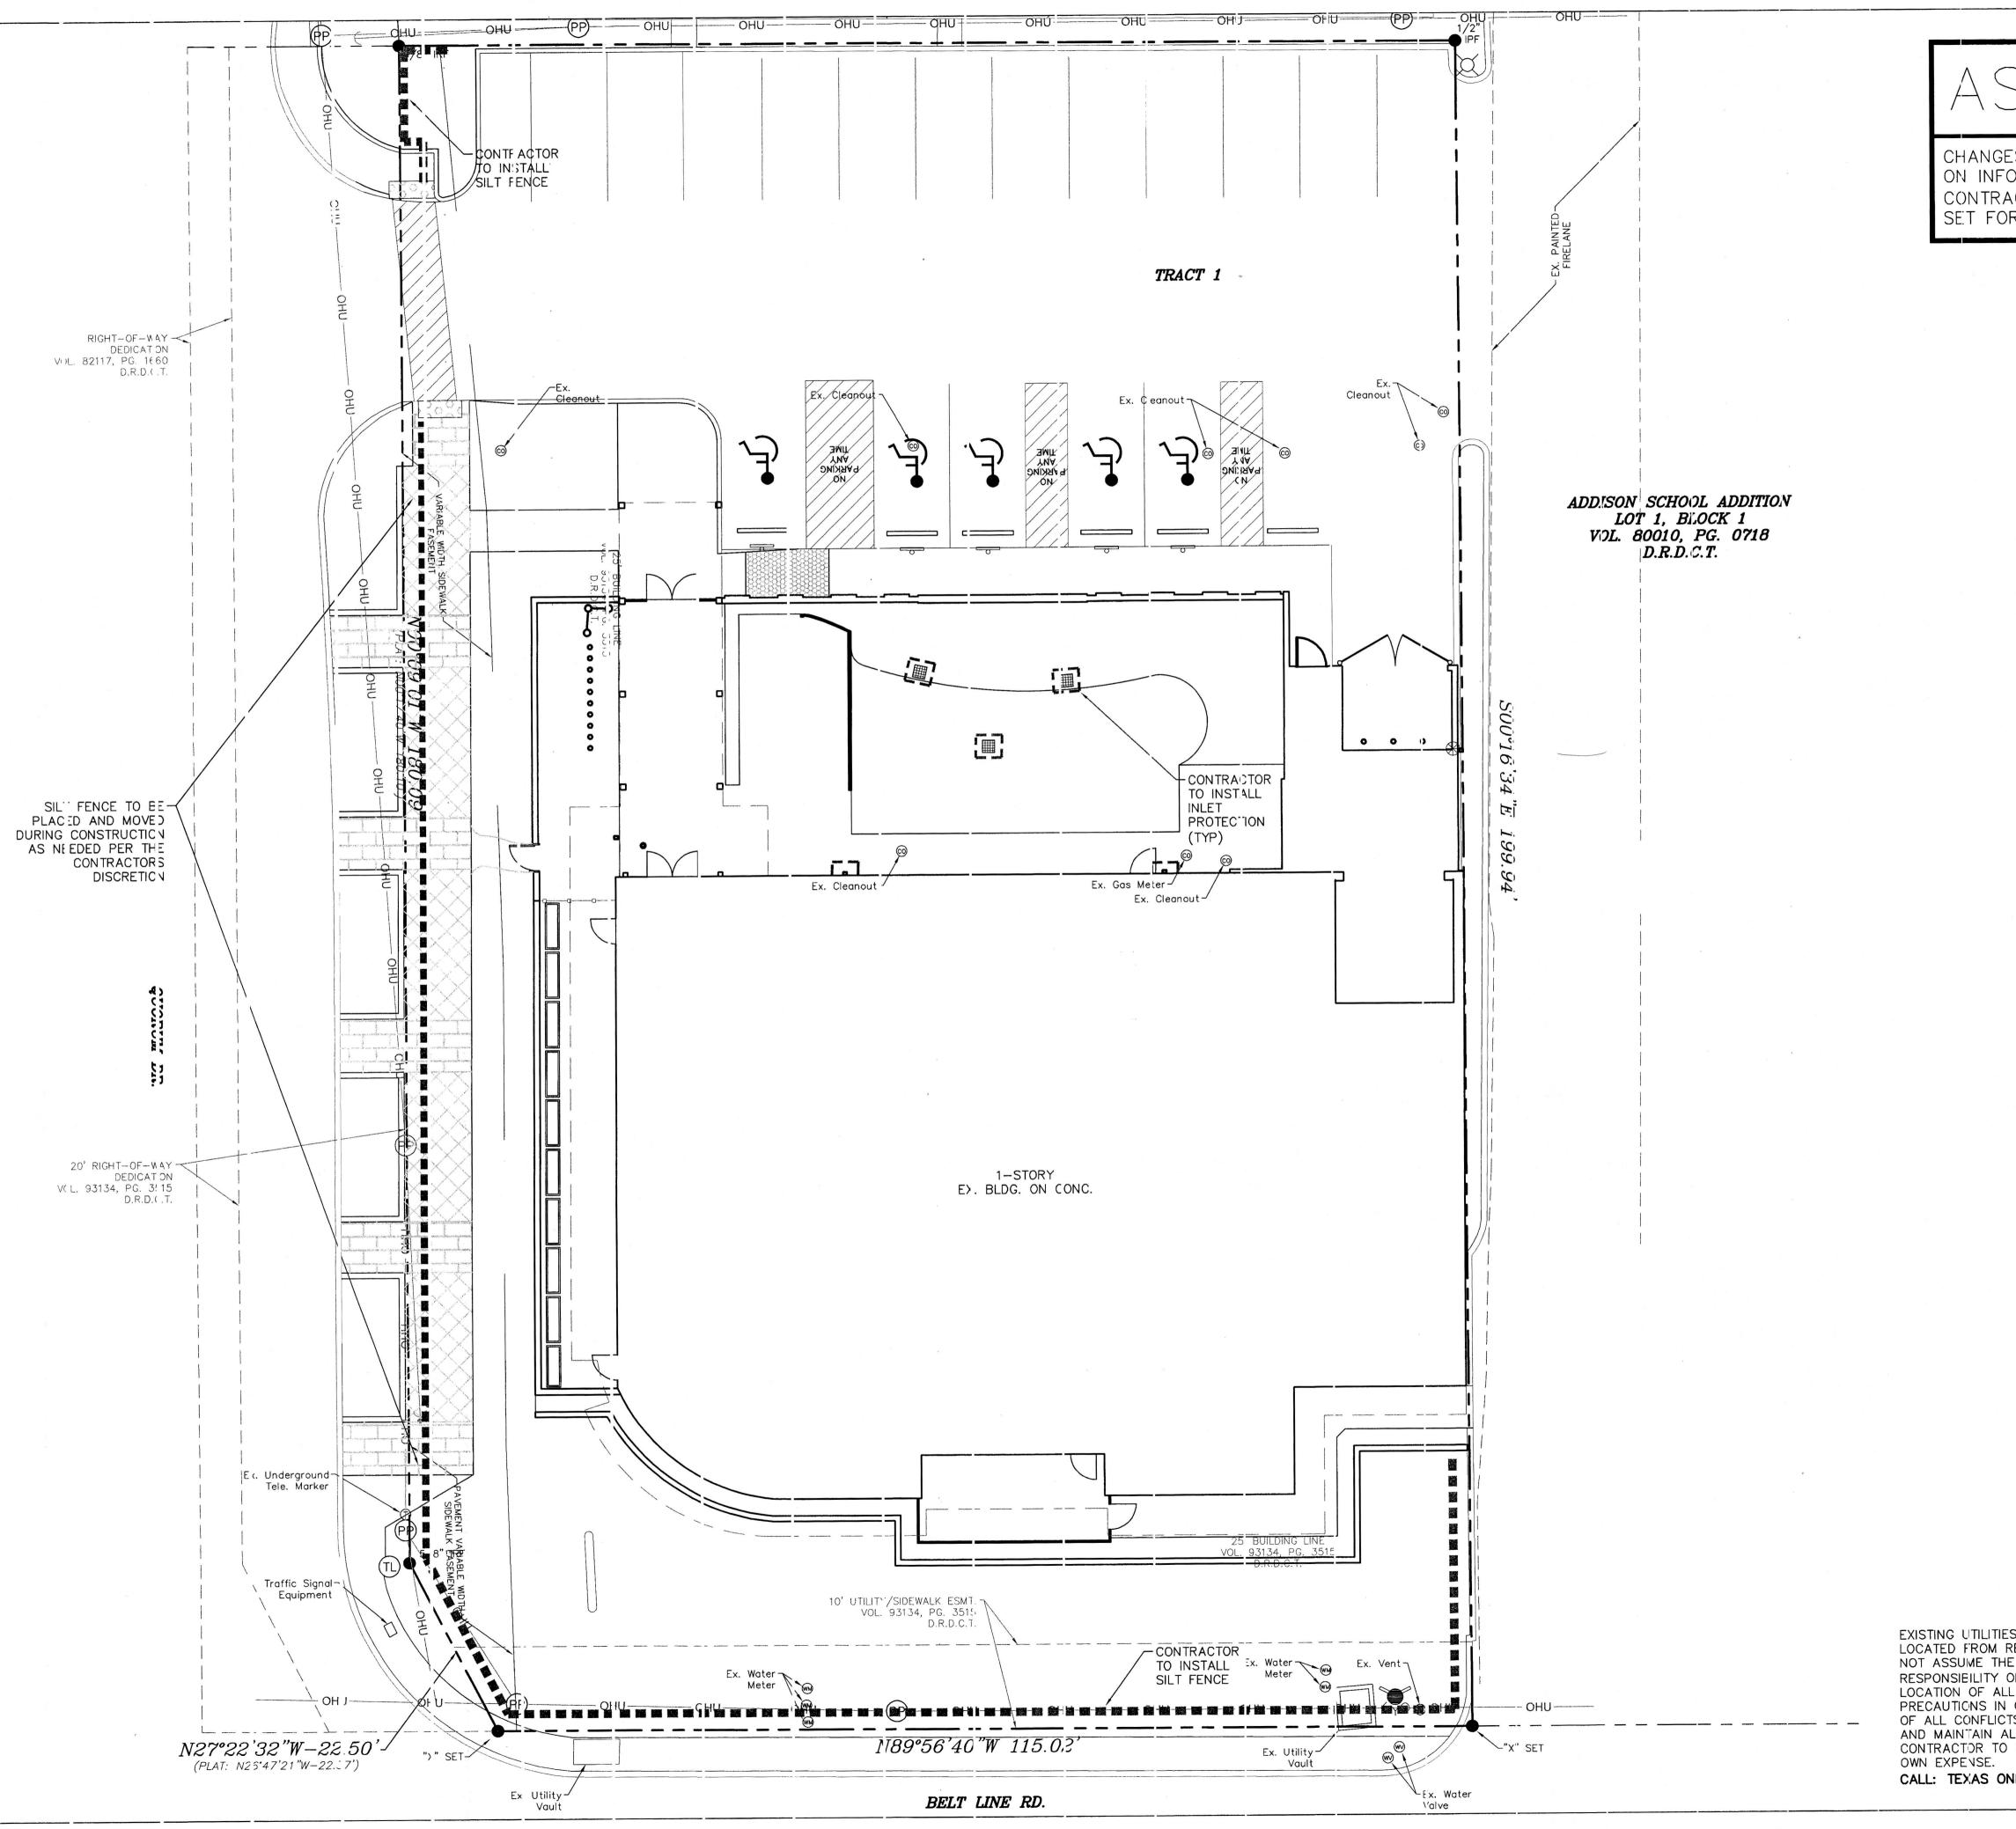
ADDISON PROJECT #15-02

DRAINAGE DATA CHART


DRAINAGE AREA NAME	DRAINAGE AREA (Acres)	c	Tc (min)		Q100 (cfs)	COMMENTS		
Α	0.21	0.9	10	9.27	1.8	DRAINS TO ROOF DRAINS AREA INTO "B"		
В	0.29	0.9	10	9.27	2.4	DRAINS OFFSITE TO EXISTING ROAD		
С	0.07	0.9	10	9.27	0.6	DRAINS OFFSITE TO EXISTING ROAD		

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DRAWING SCALE

1"=10'

LEGEND

 EXISTING CONTOUR ---690--- PROPOSED CONTOUR PROPOSED VALLEY PROPOSED RIDGE - PROPOSED FLOW ARROW EXISTING CURB - PROPOSED CURB SILT FENCE - INLET PROTECTION

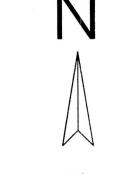GENERAL NOTES:

1. EROSION CONTROL DEVICES AS SHOWN ON THE EROSION CONTROL PLAN FOR THE PROJECT SHALL BE INSTALLED PRIOR TO THE START OF THE LAND DISTURBING ACTIVITIES ON THE PROJECT.

2. ALL EROSION CONTROL DEVICES ARE TO BE INSTALLED IN ACCORDANCE WITH THE APPROVED PLANS AND SPECIFICATIONS FOR THE PROJECT.

3. IF THE EROSION CONTROL PLAN AS APPROVED CANNOT CONTROL EROSION AND OFF-SITE SEDIMENT FROM THE PROJECT THE EROSION CONTROL PLAN WILL BE REQUIRED TO BE REVISED AND/OR ADDITIONAL EROSION CONTROL DEVICES WILL BE REQUIRED ON SITE.

4. IF OFF-SITE SOIL BORROW OR SPOIL SITES ARE USED IN CONJUNCTION WITH THIS PROJECT, THIS INFORMATION SHALL BE DISCLOSED AND SHOWN ON THE EROSION CONTROL PLAN. THESE AREAS SHALL BE STABILIZED WITH PERMANENT GROUND COVER PRIOR TO FINAL APPROVAL OF THE PROJECT.

5. THE CONTRACTOR IS RESPONSIBLE FOR PROVIDING THE STORM WATER POLLUTION AND PREVENTION PLAN (SWPPP) IF REQUIRED.

6. REFERENCE LANDSCAPE PLAN FOR TREE PROTECTION INFORMATION

NOTE:
THIS PLAN REFLECTS MINIMUM REQUIREMENTS ONLY, AND DOES NOT CONSTITUTE A STORM WATER POLLUTION PREVENTION PLAN. THE CONTRACTOR SHALL PROVIDE ADDITIONAL CONTROLS AS REQUIRED BY FIELD CONDITIONS AND CONSTRUCTION SCHEDULING. THE CONTRACTOR SHALL COMPLY FULLY WITH ANY APPLICABLE REQUIREMENTS AS ESTABLISHED IN THE CURRENT TPDES GENERAL PERMITS FOR STORM WATER DISCHARGES FROM CONSTRUCTION ACTIVITIES IN REGION 6.

NCTCOG PUBLISHES ACCEPTABLE CONTROLS IN A REFERENCE MANUAL ENTITLED "STORM WATER QUALITY BEST MANAGEMENT PRACTICES FOR CONSTRUCTION ACTIVITIES.". THIS MANUAL CAN BE OBTAINED THROUGH THE INTERNET AT: WWW.DFWSTORMWATER.COM.

!!! CAUTION !!!
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FRONT BURNER RESTAURANTS 5206 BELT LINE ROAD DALLAS, TEXAS 75254

972.905.7139

8-7-2015

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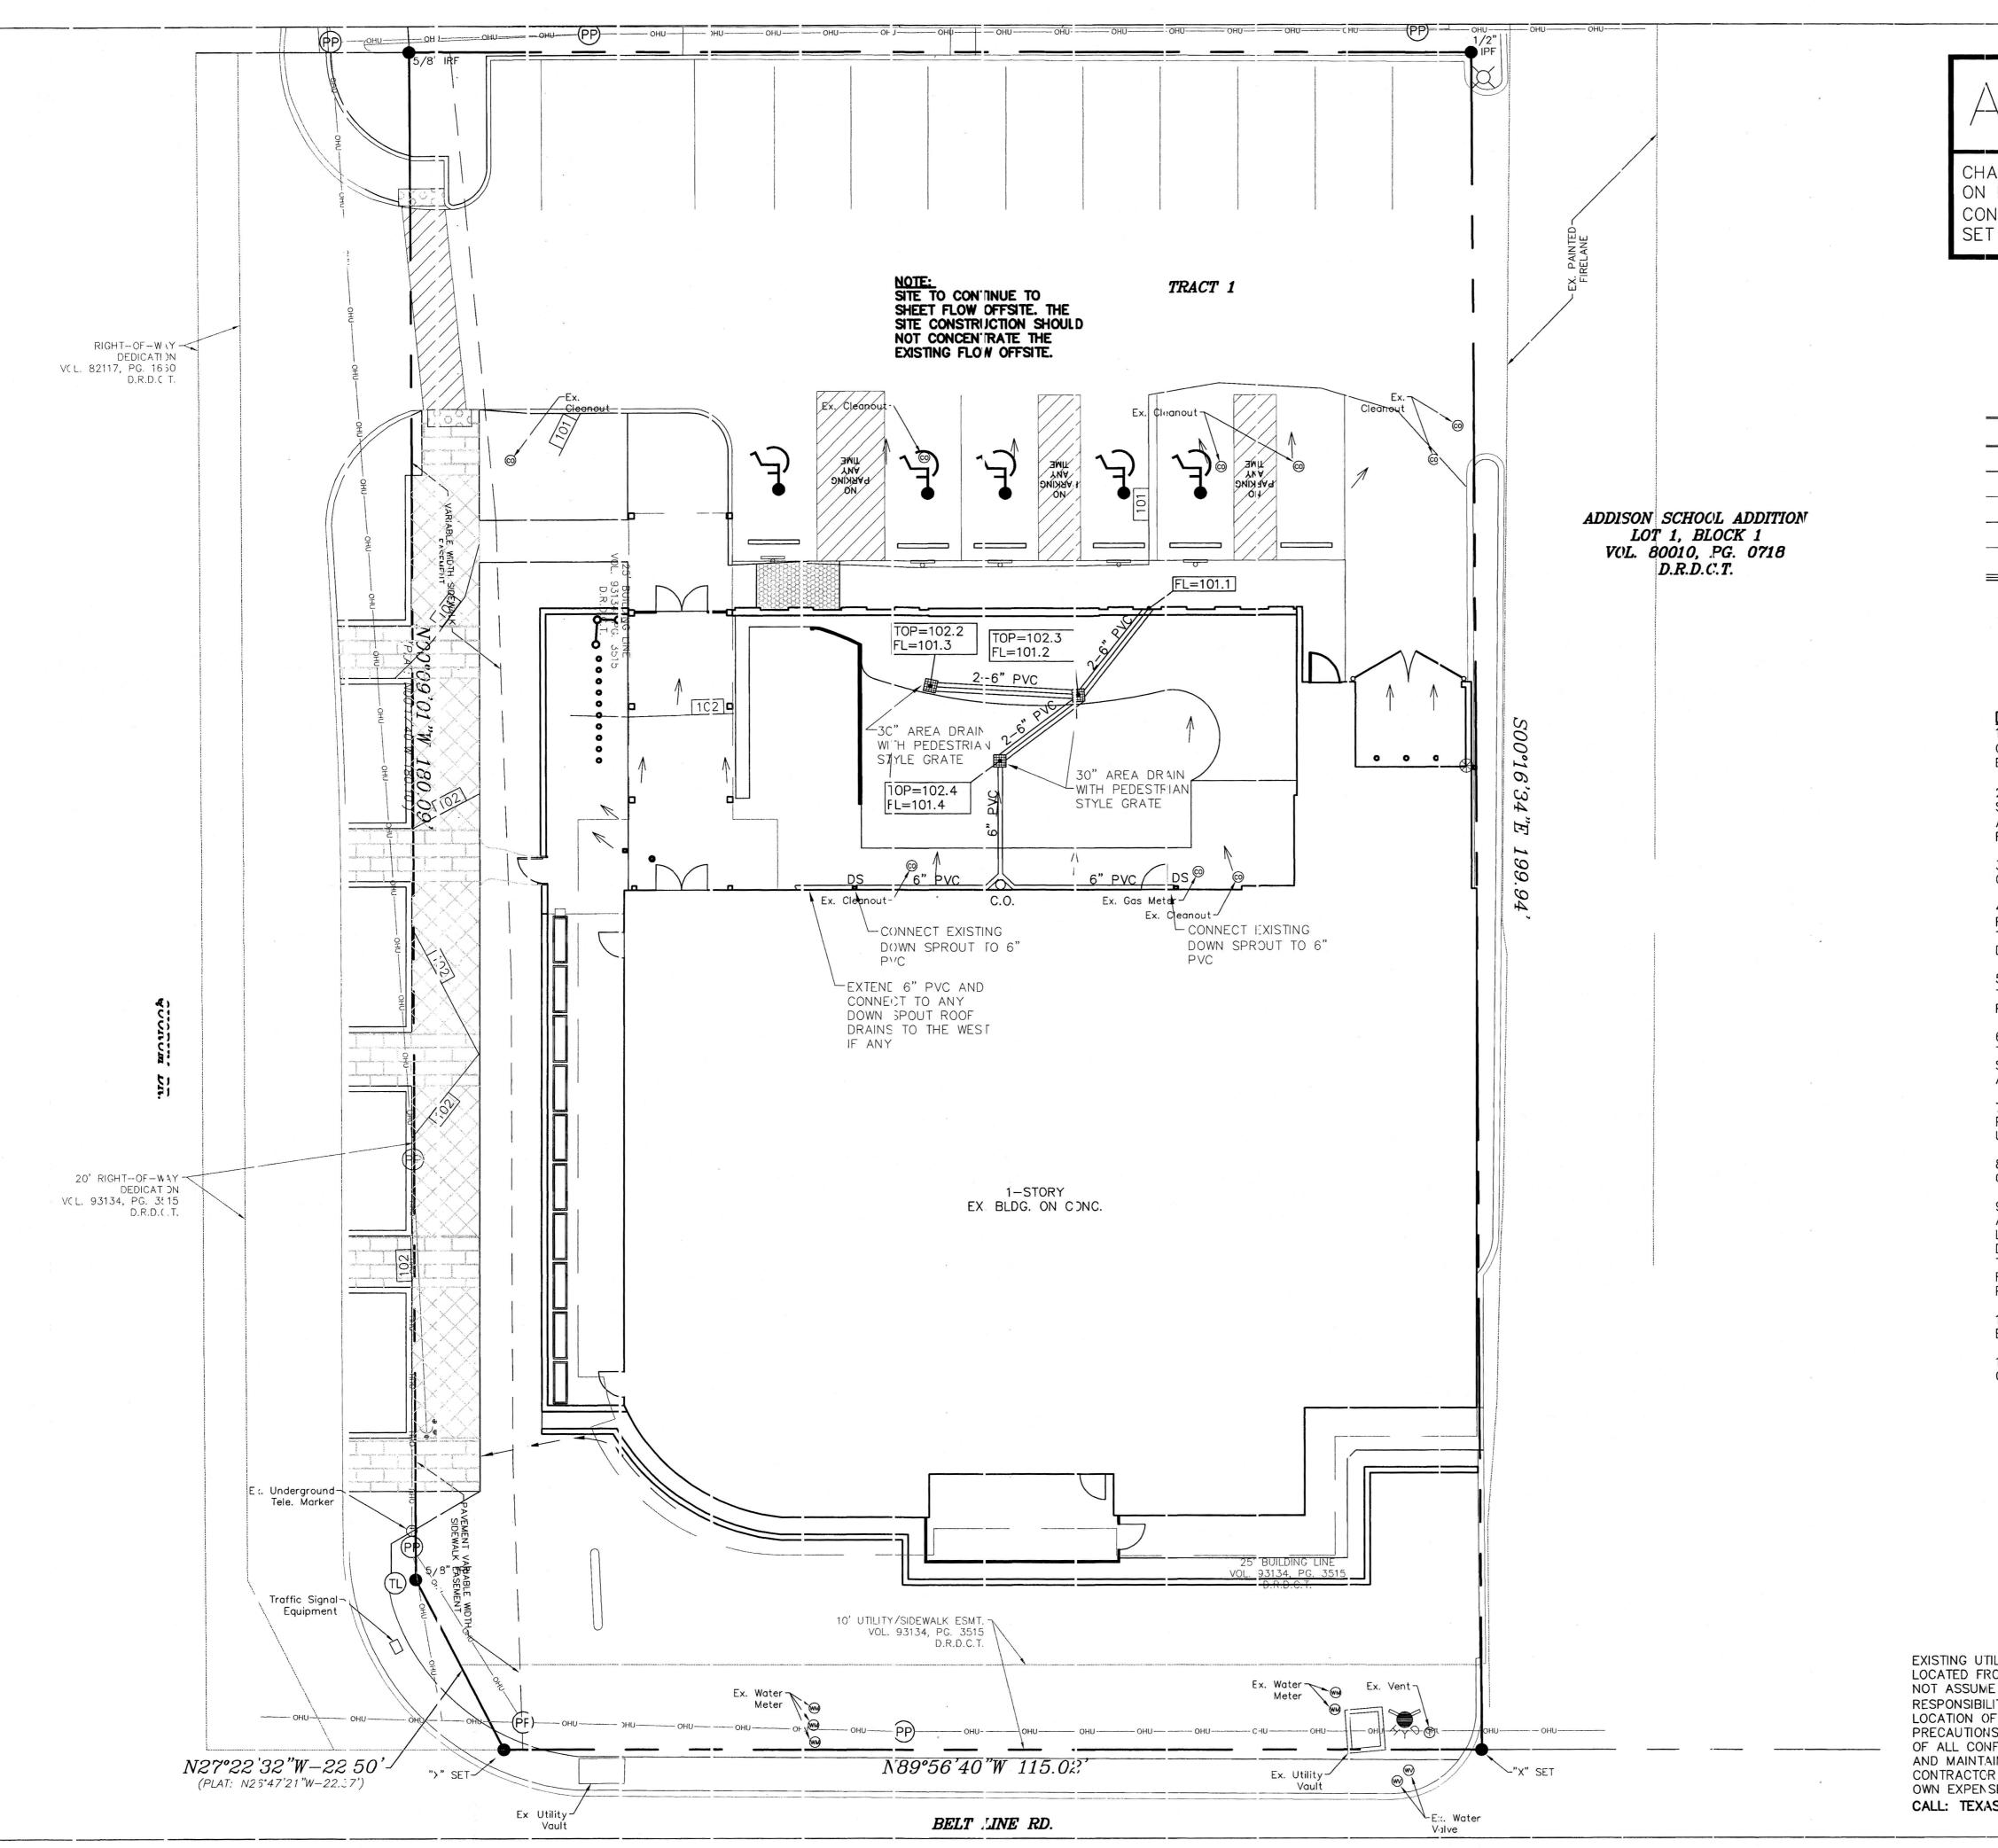
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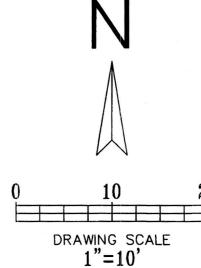
EROSION CONTROL PLAN

SHEET:

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<u>LEGEND</u>

- EXISTING CURB

- PROPOSED CURB

- PROPOSED SANITARY SEWER PIPE

- EXISTING SANITARY SEWER PIPE

- PROPOSED WATER PIPE

- EXISTING WATER PIPE

- PROPOSED STORM PVC/HDPE PIPE

1. ALL MATERIALS AND CONSTRUCTION SHALL CONFORM TO THE CITY'S STANDARD CONSTRUCTION DETAILS AND SPECIFICATIONS EXCEPT AS NOTED HEREIN OR APPROVED BY THE CITY.

2. ALL STORM SEWER PIPE 15" AND SMALLER SHALL BE SDR-35 PVC, ADS N-12 DRAINAGE PIPE OR APPROVED EQUAL ALL STORM SEWER PIPE 18" AND LARGER SHALL BE CLASS III

3. ALL DRAINAGE STRUCTURES SHALL HAVE A MINIMUM COMPRESSIVE STRENGTH OF 4500 PSI AT 28 DAYS.

4. ALL PRECAST BOX CULVERTS, DRAINAGE STRUCTURES AND RCP WILL REQUIRE A CERTIFICATION FROM THE MANUFACTURER THAT THE PRODUCT MEETS THE DESIGN REQUIREMENTS AND 28 DAY COMPRESSIVE STRENGTH.

5. CONTRACTOR SHALL HAVE A TRENCH SAFETY PLAN AND A TRAFFIC CONTROL PLAN (IF REQUIRED) AT THE TIME OF PRE-CONSTRUCTION MEETING.

6. CONTRACTOR SHALL BE RESPONSIBLE FOR MAINTAINING STANDARDS, TEXAS STATE LAW, AND O.S.H.A. STANDARDS FOR ALL EXCAVATIONS.

7. CONSTRUCTION SHALL BEGIN AT DOWNSTREAM END OF PROJECT AND CONTINUE UPSTREAM WITH PIPE GROOVES FACING

8. CONTRACTOR SHALL PROTECT ALL PUBLIC UTILITIES IN THE CONSTRUCTION OF THIS PROJECT.

9. THE LOCATION OF ALL UTILITIES INDICATED ON THESE PLANS ARE TAKEN FROM EXISTING PUBLIC RECORDS. THE EXACT LOCATION AND ELEVATION OF ALL PUBLIC UTILITIES MUST BE DETERMINED BY THE CONTRACTOR. IT SHALL BE THE DUTY OF THE CONTRACTOR TO ASCERTAIN WHETHER ANY ADDITIONAL FACILITIES OTHER THAN THOSE SHOWN ON THE PLANS MAY BE

10. ALL TRENCH BACKFILL FOR PUBLIC STORM SEWER SHALL BE COMPACTED AS REQUIRED BY THE CITY.

11. ALL MATERIAL, LABOR, ETC FOR STORM SEWER CONSTRUCTION TO BE PROVIDED BY CONTRACTOR.

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Design Cumulus Firm #14810 2080 N. Highw

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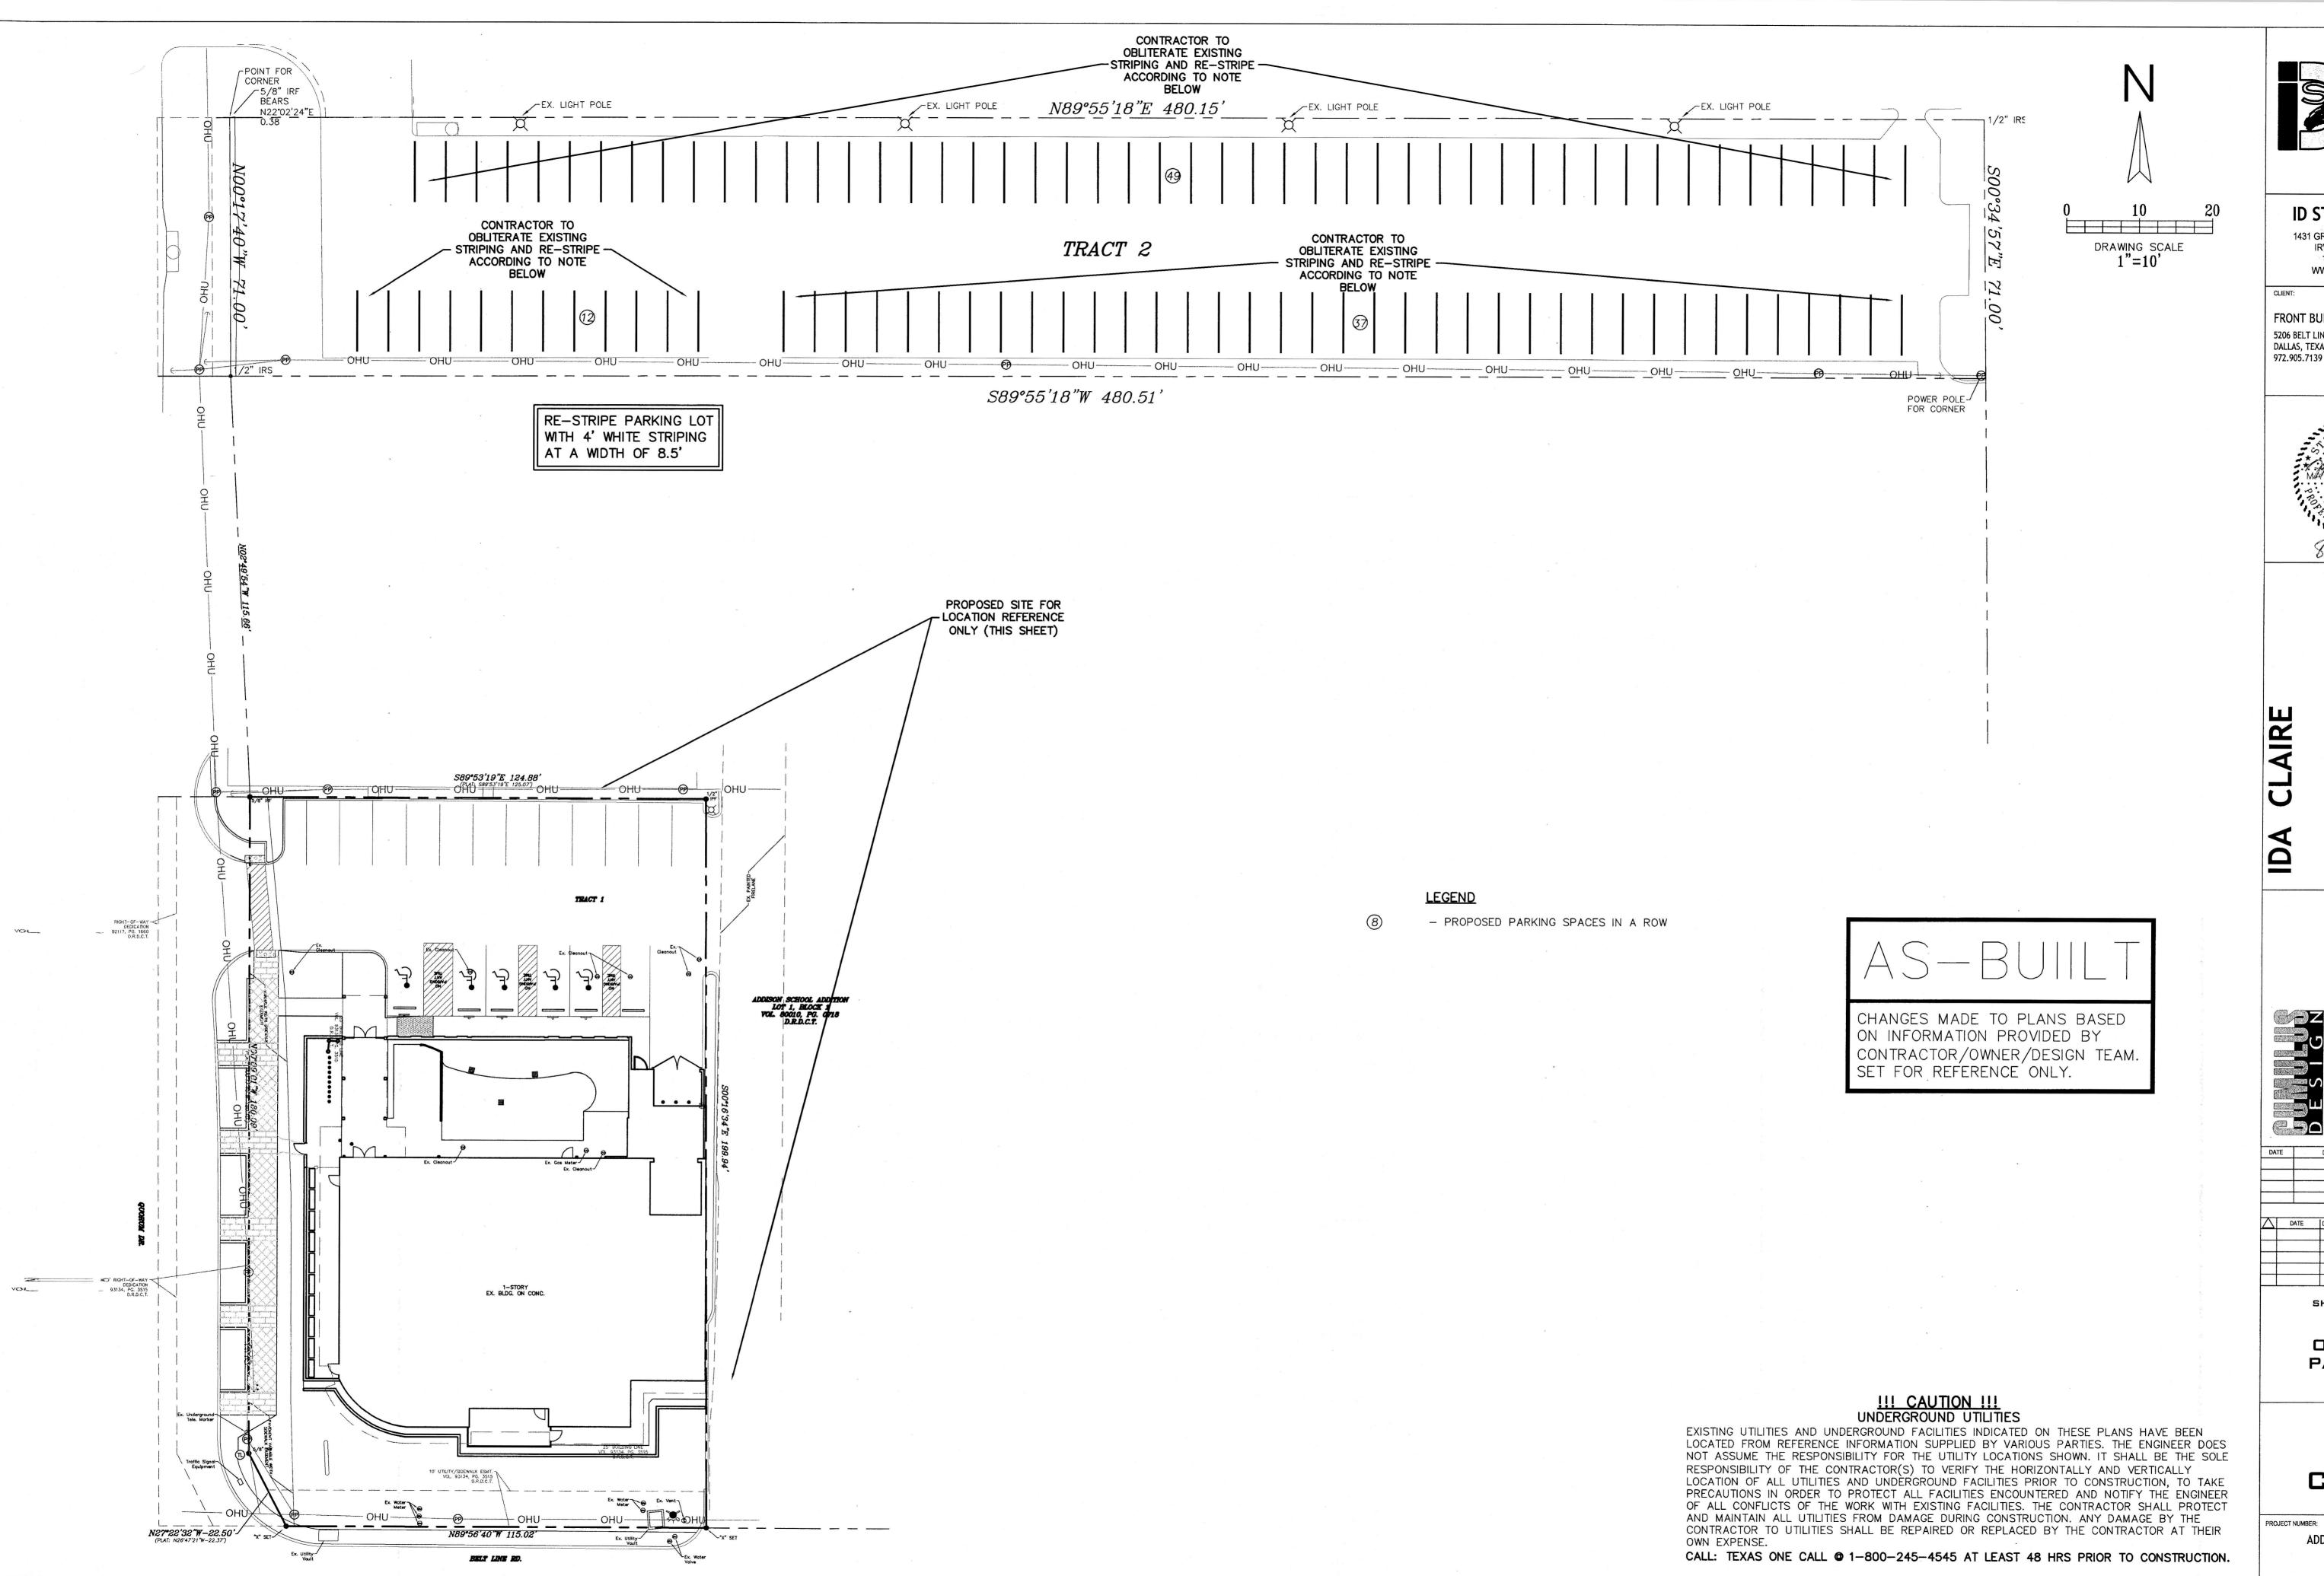
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STORM SEWER PLAN

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PROJECT NUMBER:



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FRONT BURNER RESTAURAL 5206 BELT LINE ROAD DALLAS, TEXAS 75254 972.905.7139

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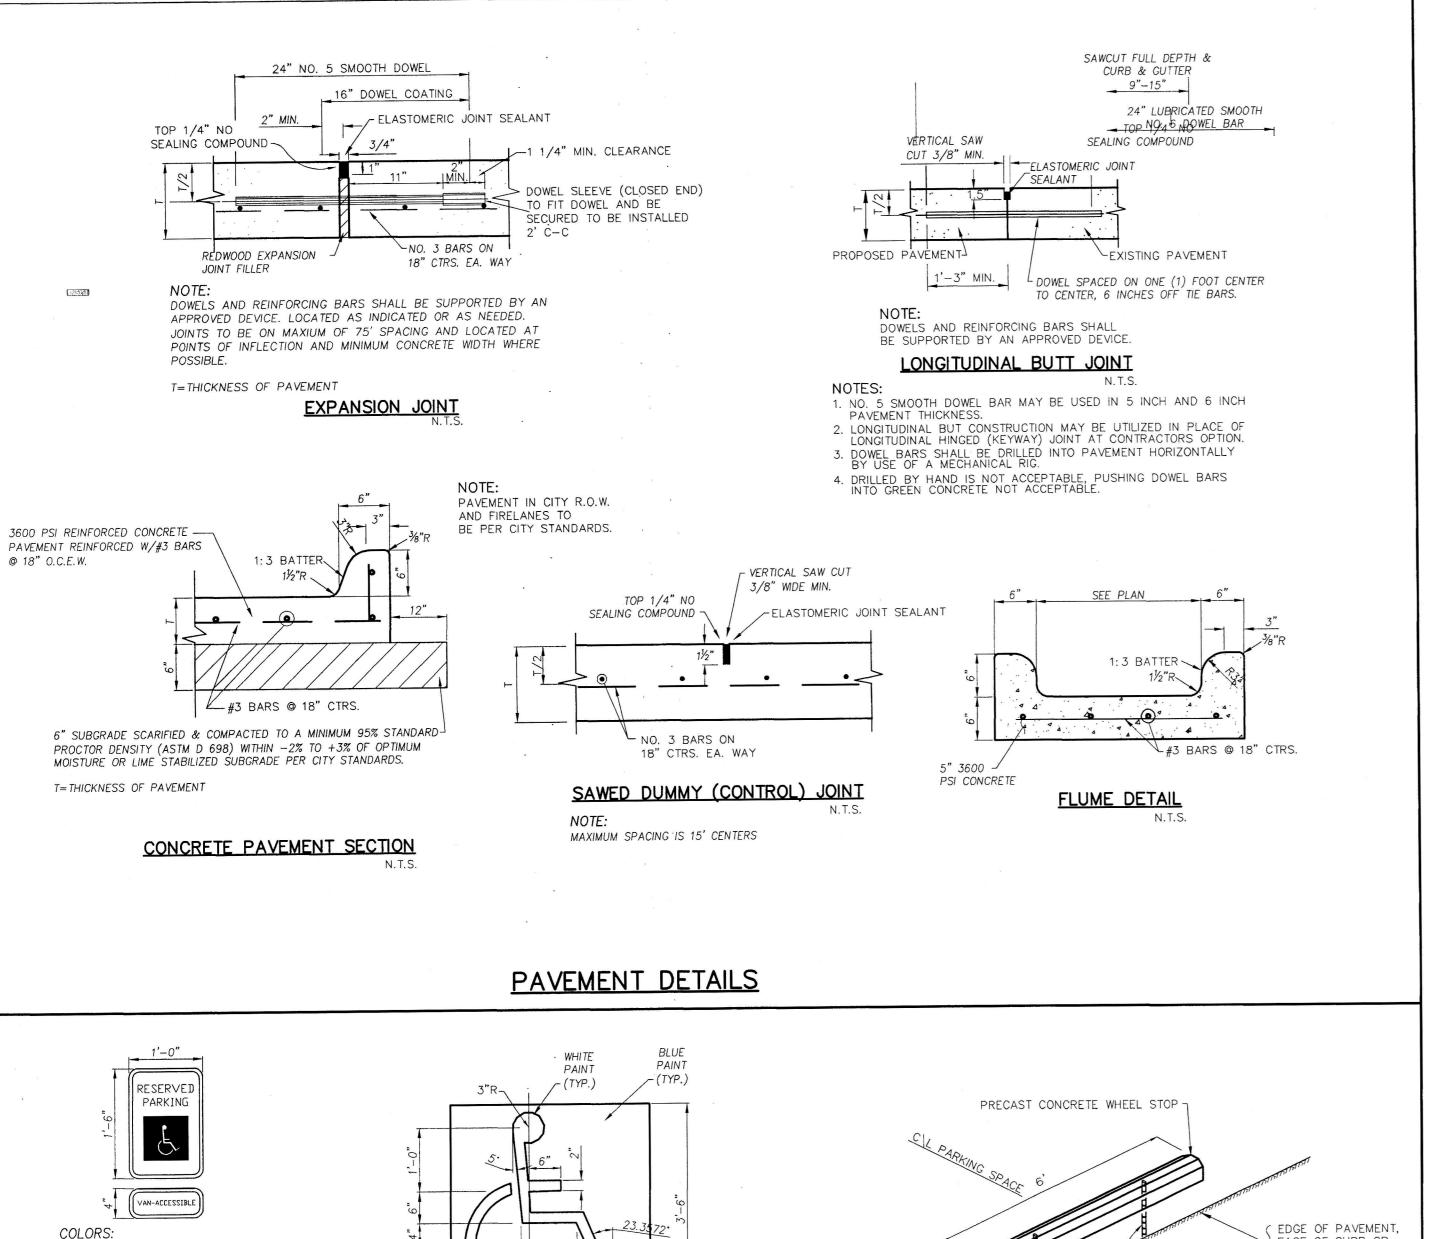
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OFFSITE PARKING PLAN

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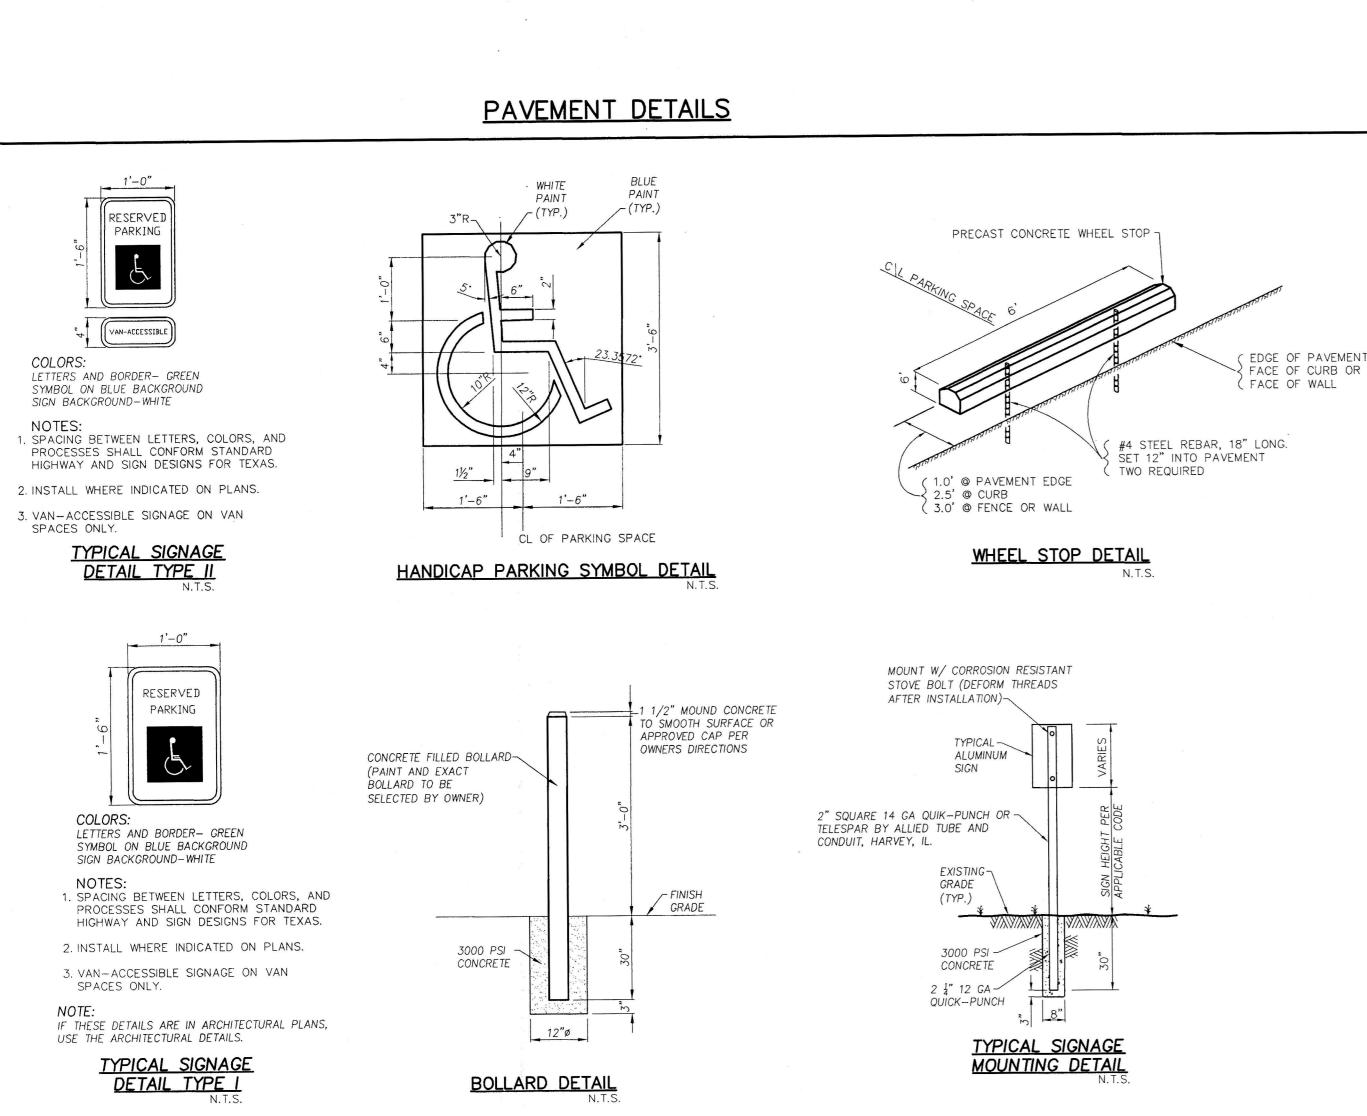
ADDISON PROJECT

#15-02




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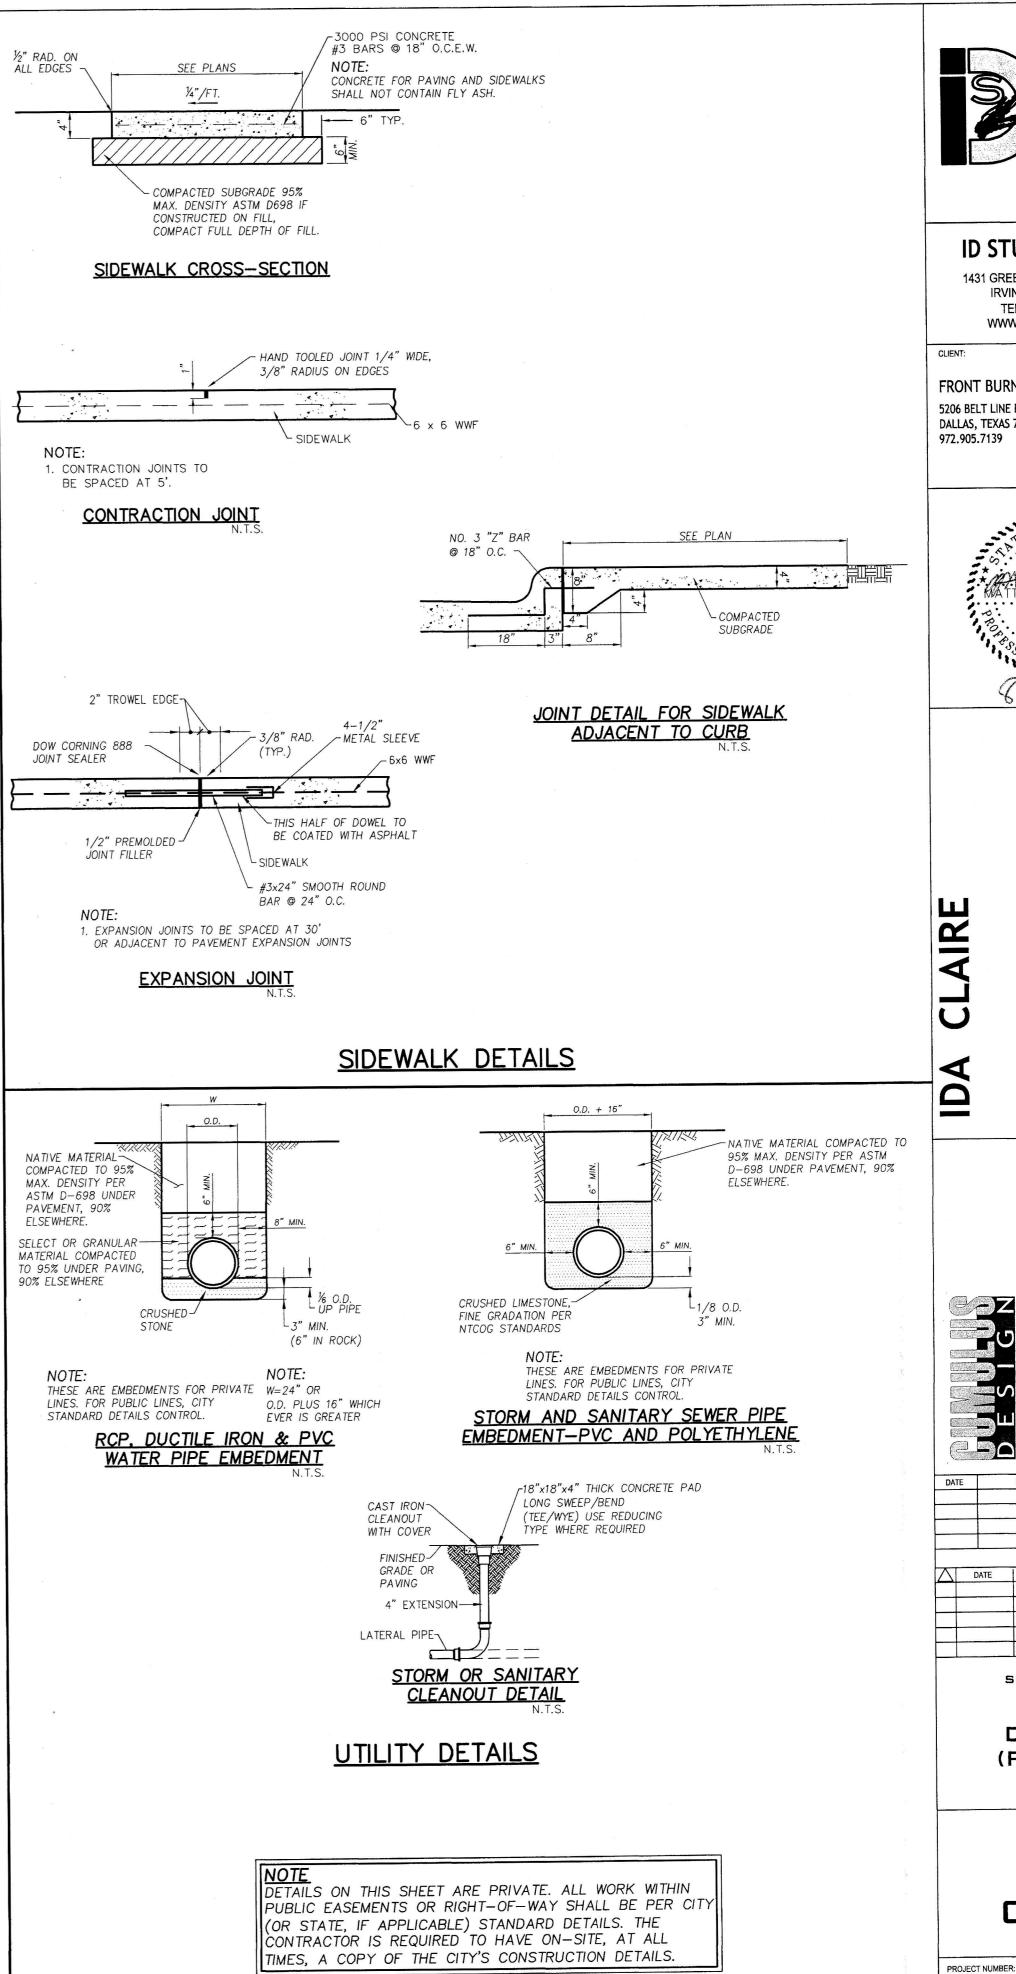
@ 18" O.C.E.W.




MISCELLANEOUS DETAILS

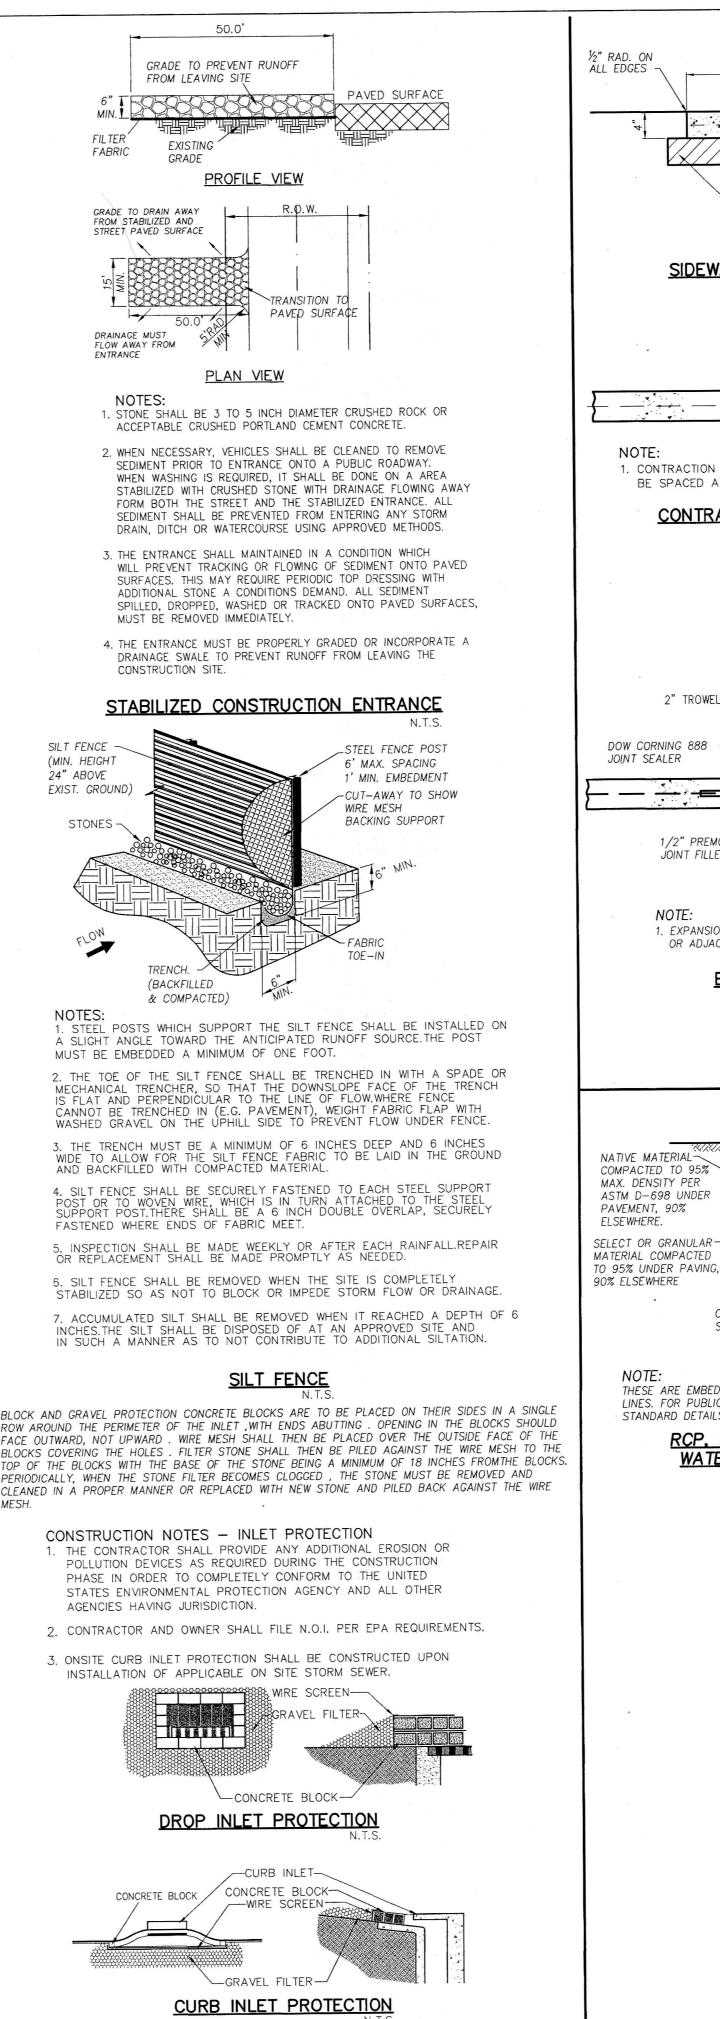

EROSION CONTROL



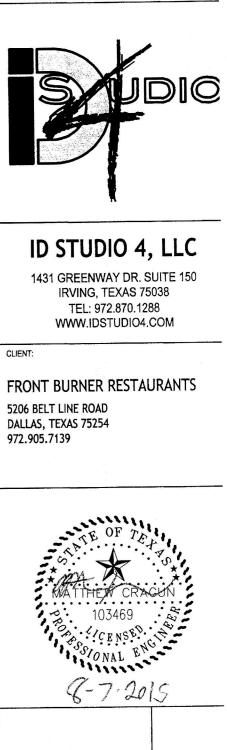

sign

DESCRIPTION

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DETAILS


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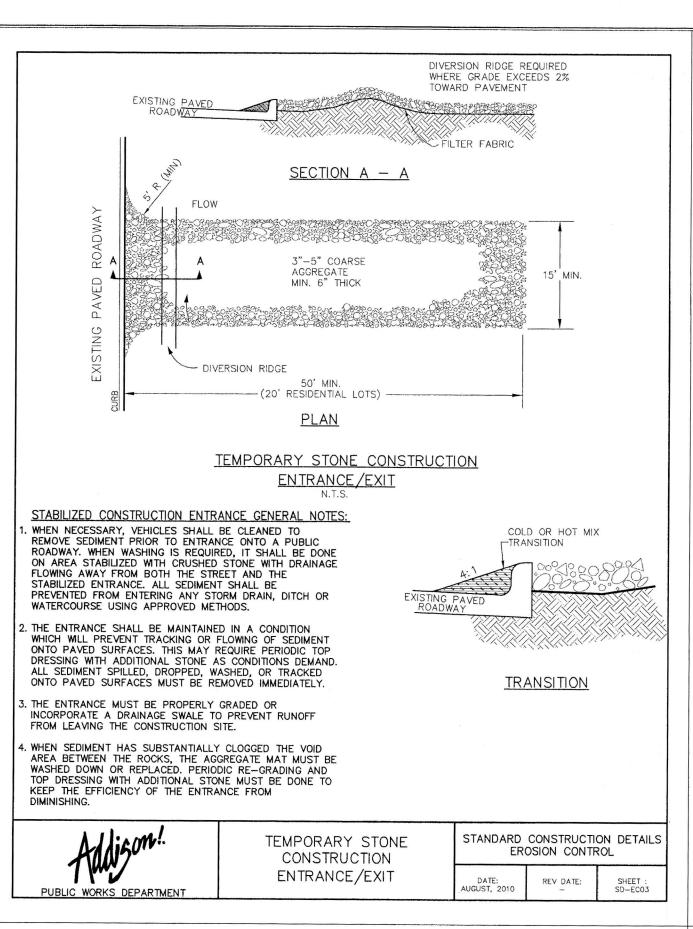
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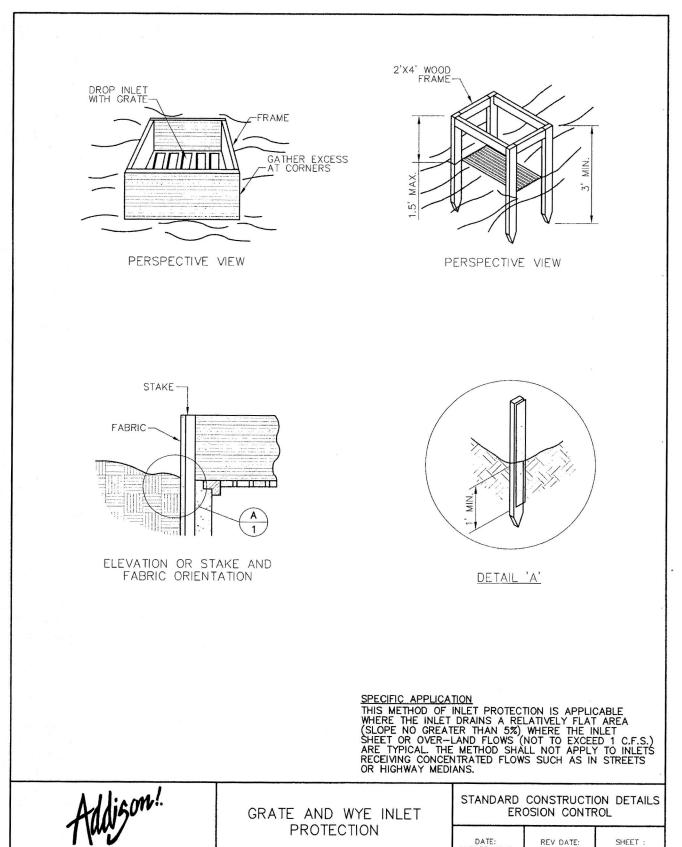
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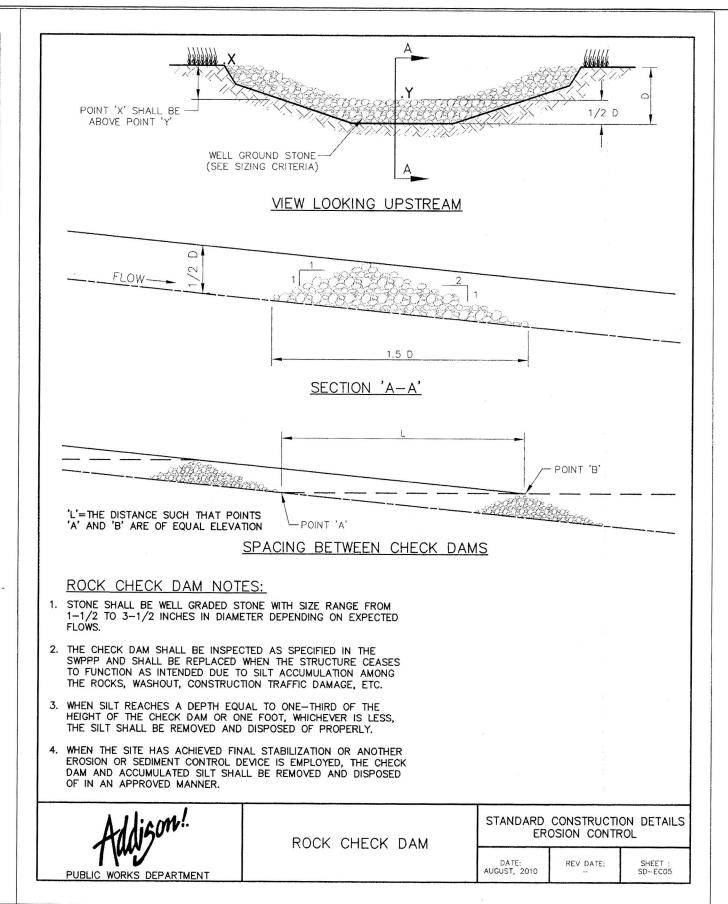
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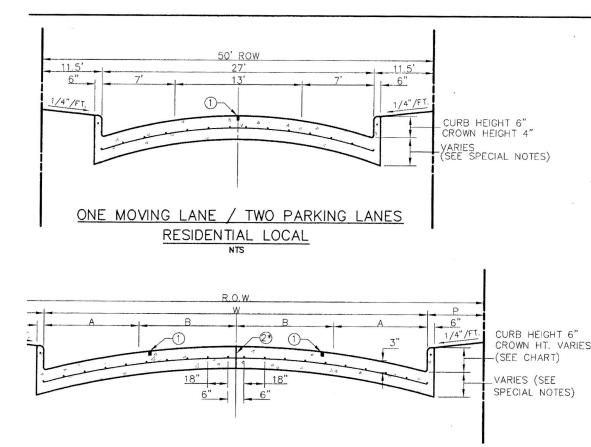
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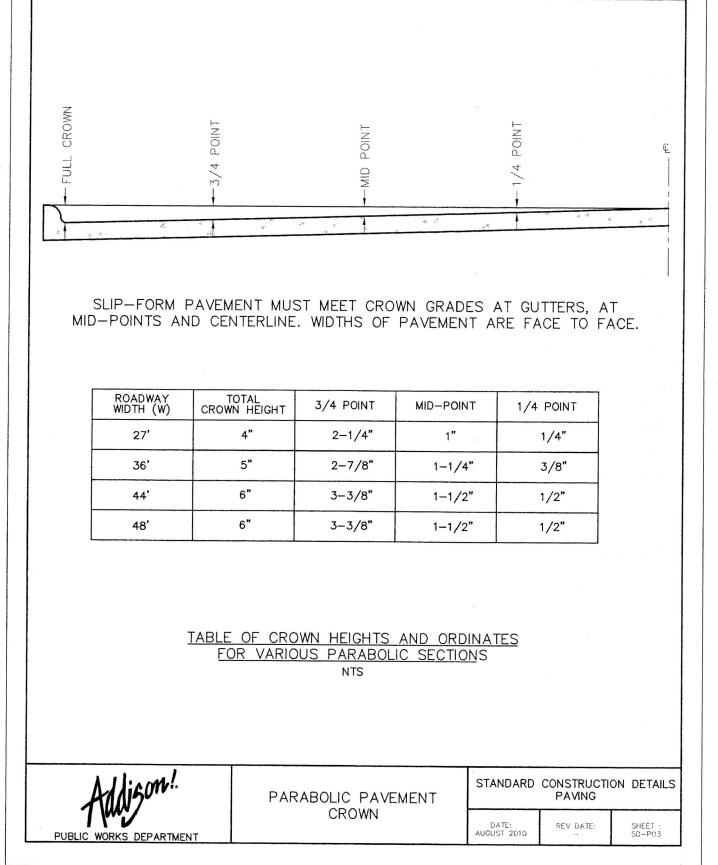



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PAVEMENT OF 36' WIDTH STREETS IS	S ALLOWED WHE	RE APPRO	OVED BY 1	THE PUBLIC WOR	RKS DEPT.	
TYPE	STREET WIDTH (W)	A	В	R.O.W. WIDTH	Р	CROWN HT.
COLLECTOR	36' *	7'	11'	60'	12'	5"
IAL / INDUSTRIAL COLLECTOR	44'	10'	12'	64'	10'	6"
IAL / INDUSTRIAL COLLECTOR	48'	12'	12'	68'	10'	6"


FOUR MOVING LANES OR TWO MOVING LANES / TWO PARKING LANES

SITUDINAL DUMMY JOINT. ON JOINT (FULL WIDTH PAVEMENT IS ALLOWED WHERE APPROVED BY THE PUBLIC WORKS RCING BARS SHALL BE No. 3 TRANSVERSE BARS TO BE SPACED ON 18" CENTERS. AL BARS SHALL BE PLACED ON 18" CENTERS EXCEPT WHERE NOTED. ORCEMENT SHALL BE CONTINUOUS No. 3 BAR.

dison!	REINFORCED CONCRETE	STANDARD CONSTRUCTION DETAILS PAVING			
KS DEPARTMENT	PAVEMENT	DATE: AUGUST 2010	REV DATE:	SHEET : SDP02	

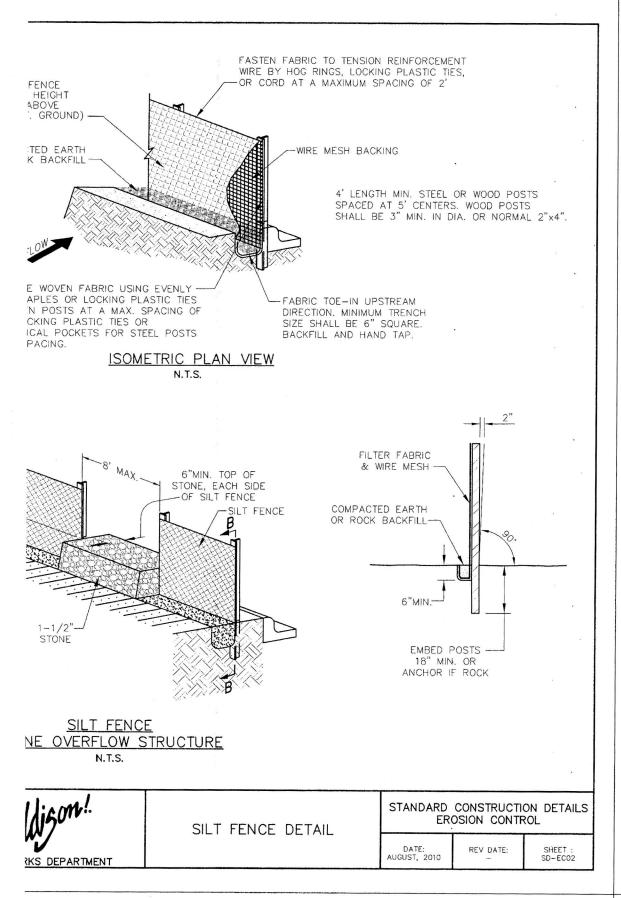

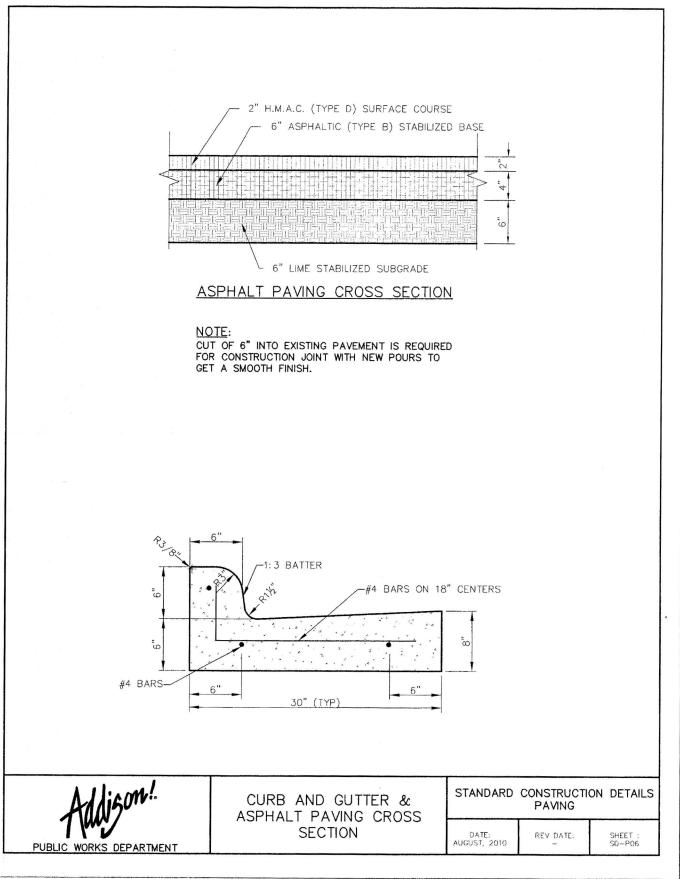

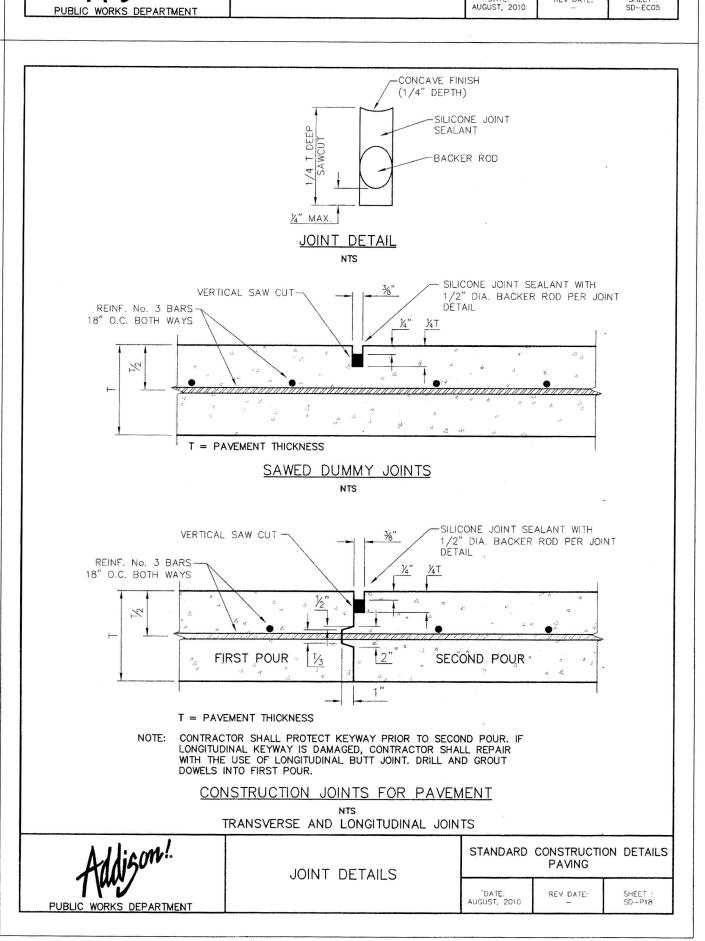



FRONT BURNER F 5206 BELT LINE I DALLAS, TEXAS 7

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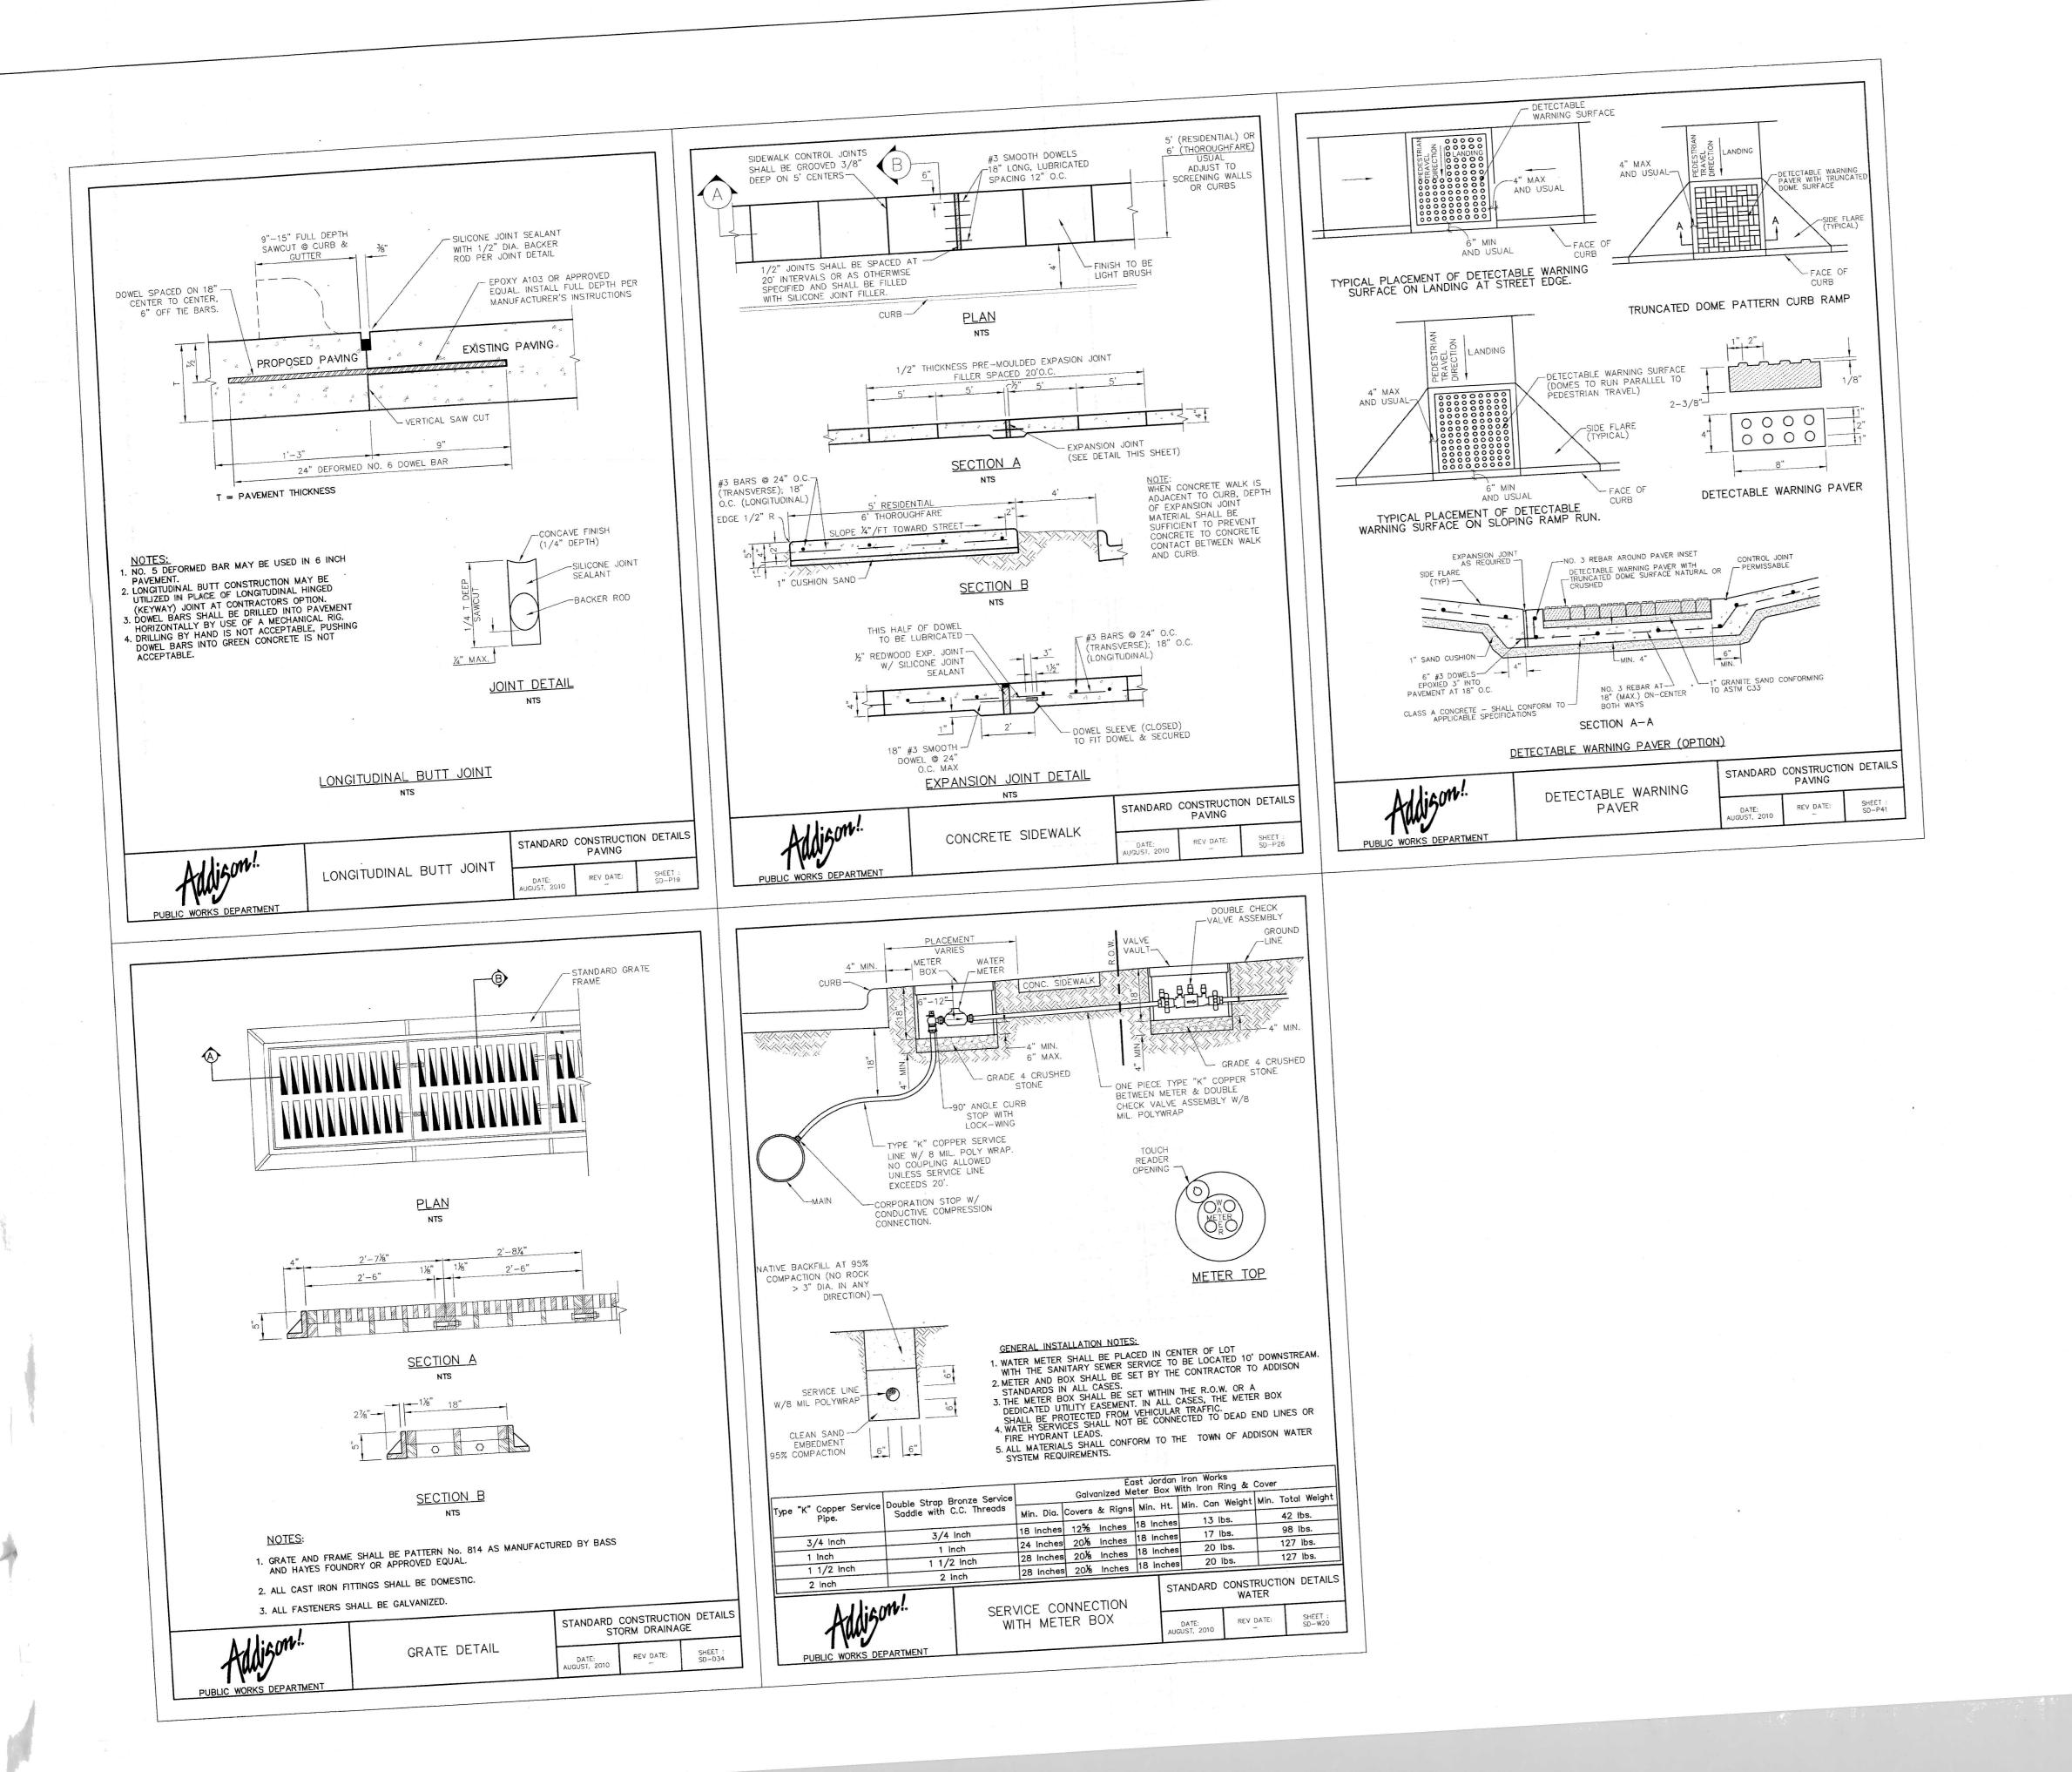
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IENT:

FRONT BURNER RESTAURANTS

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THIS DOCUMENT IS
RELEASED FOR
THE PURPOSE OF
REVIEW UNDER THE
AUTHORITY OF
MATTHEW CRAGUN,
P.E.
NO. 103469 ON
08/05/15.

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ELTLINE ROAD
IN TEXAS 75254
: FRONT BURNER RESTAUR
5206 BELT LINE ROAD
DALLAS, TEXAS 75254

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Cumulus Design Firm #14810 2080 N. Highway 360, Suit Grand Prairie, Texas 7505 Tel. 214.235.0367

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CITY DETAILS

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