

BU	JILDING AREA AND HEIGH	ЧТ
BUILDING	GFA AREA	OVERALL
NAME	SF	HEIGHT
HANGAR I	36028	51' - 8 1/2"
HANGAR II	50654	59' - 5 1/4"
HANGAR III	44610	56' - 10 5/8"
FBO	14237	37' - 9"


COVERA	GE AREA
	AR
IMPERVIOUS	611512.9
PERVIOUS	66280.7


DOMESTIC WA	TER METER
HANGAR I	2" DOMESTI
HANGAR II AND FBO	2" DOMESTI
HANGAR III	2" DOMESTI


IGATION	2" IRRIGAT


FIRE SERV	ICE TABLE
HANGAR I	8" FIRE
HANGAR II AND FBO	8" FIRE
HANGAR III	6" FIRE




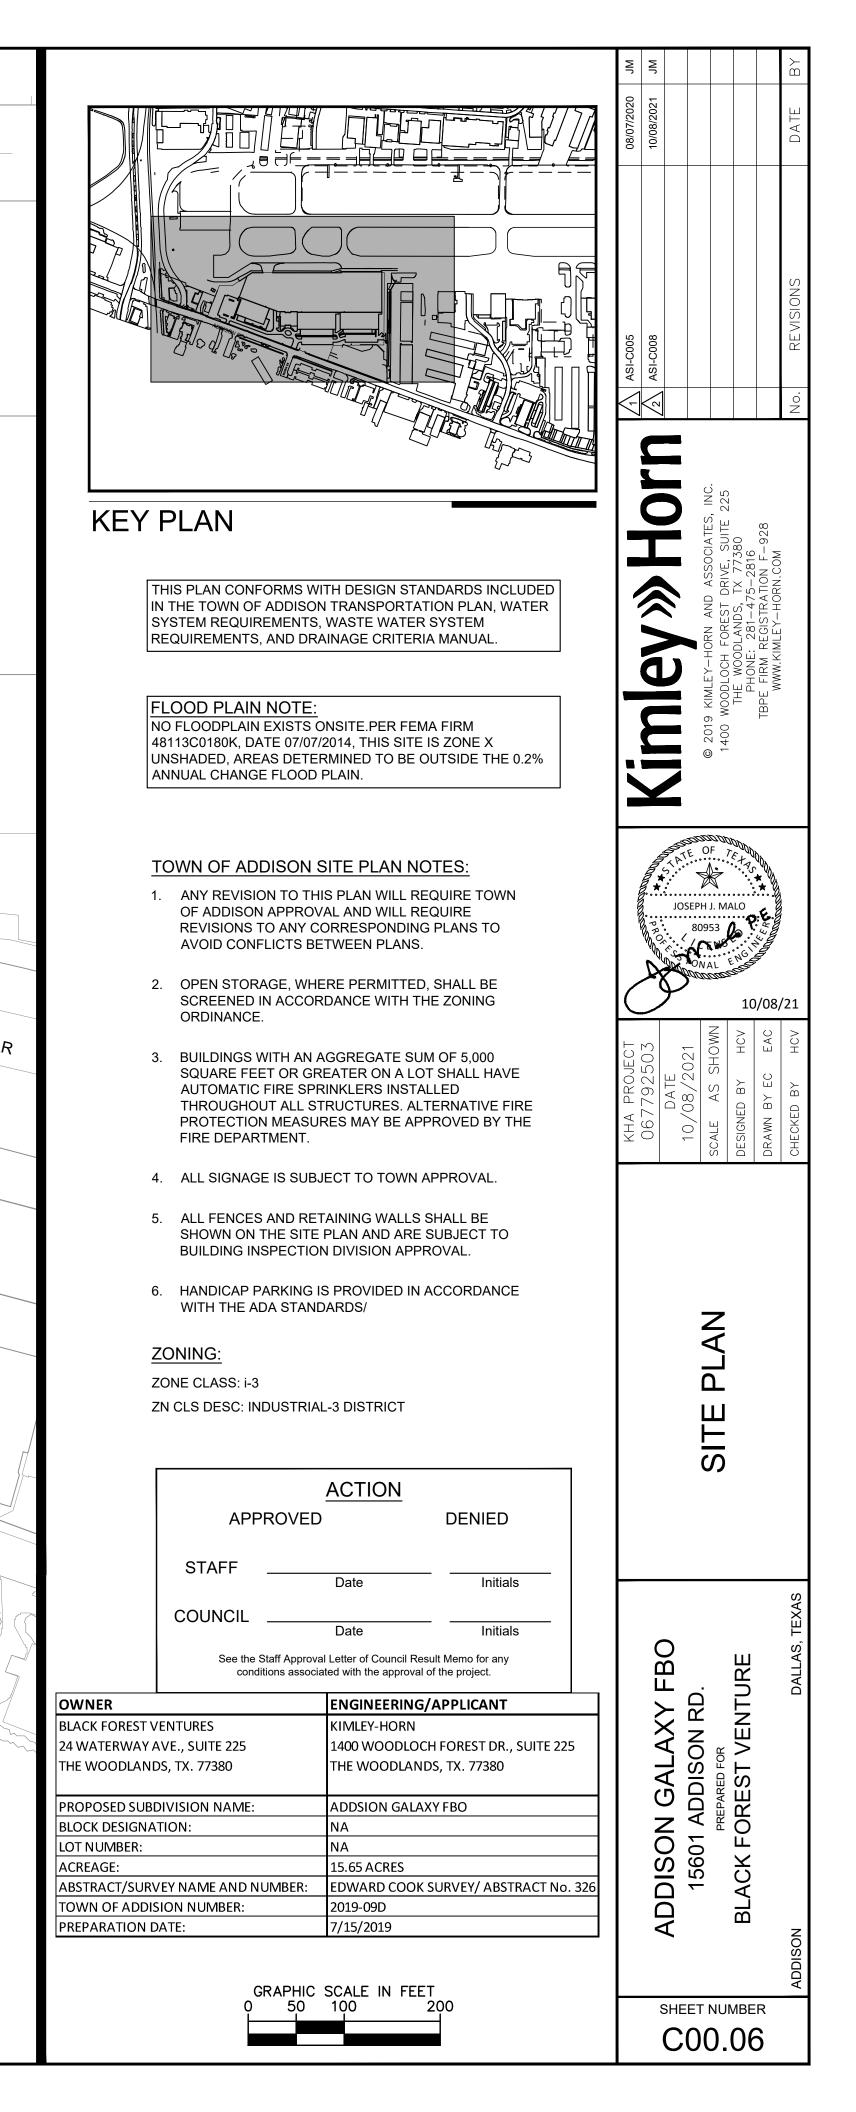


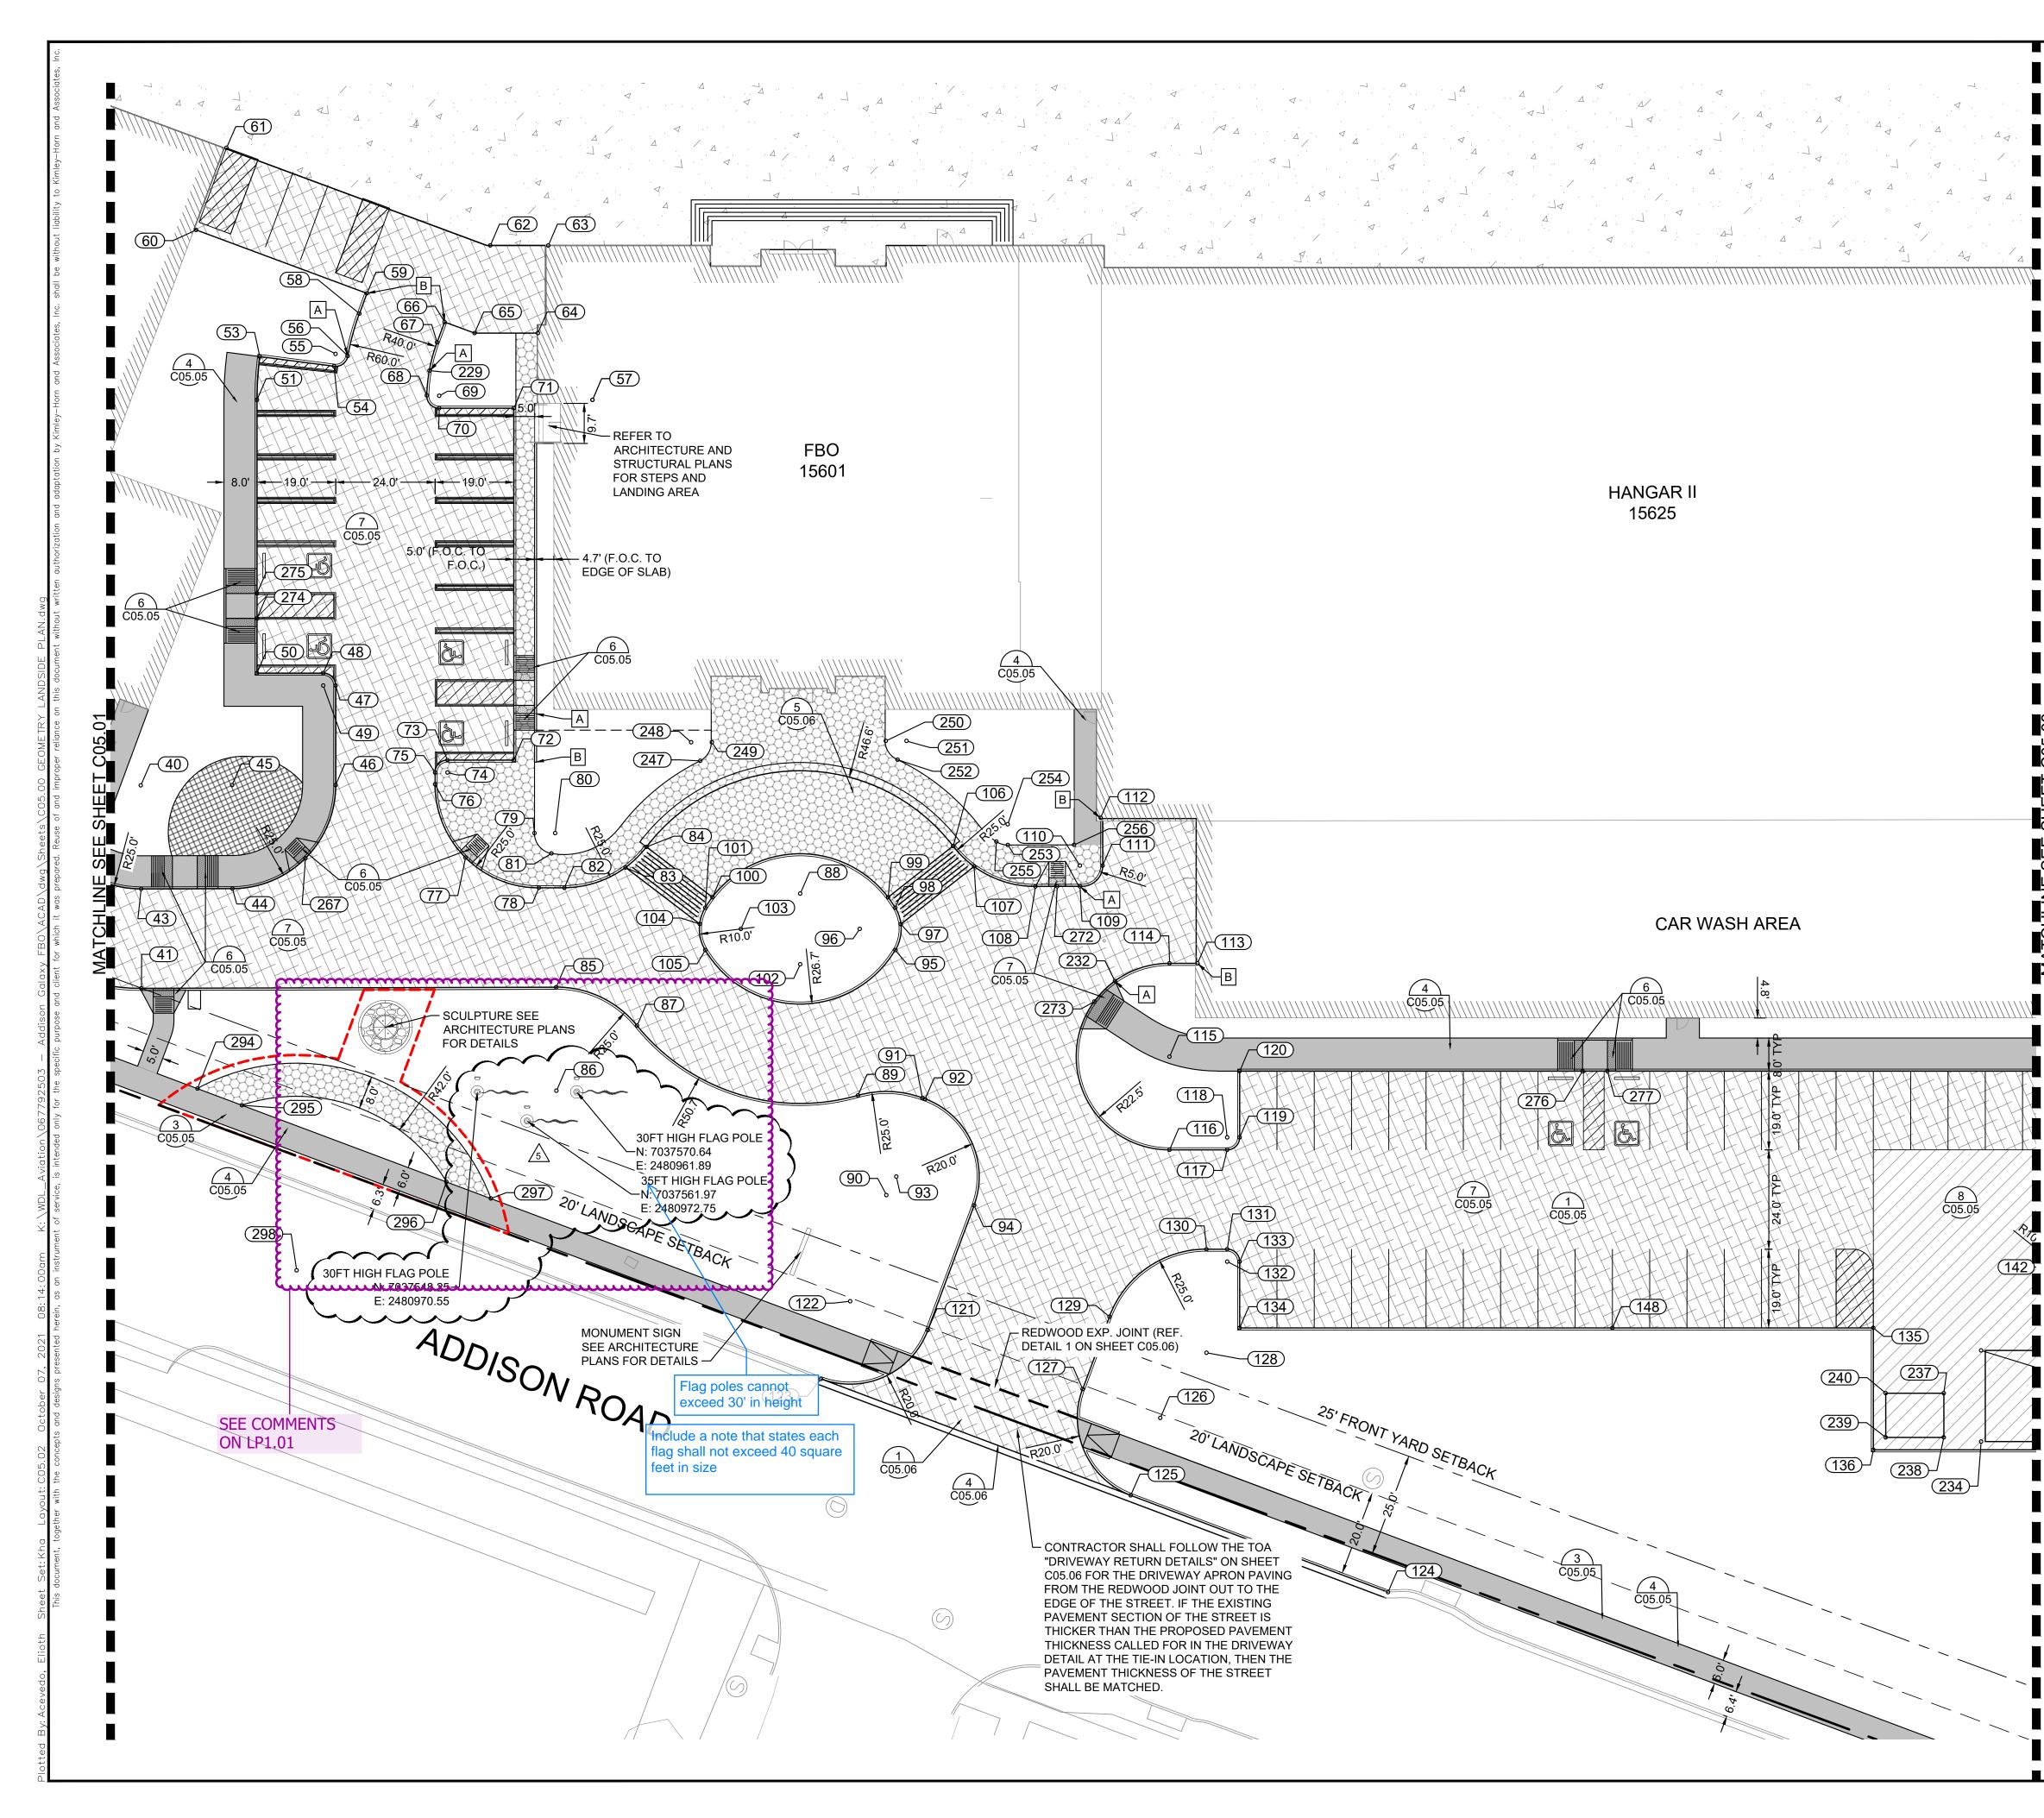


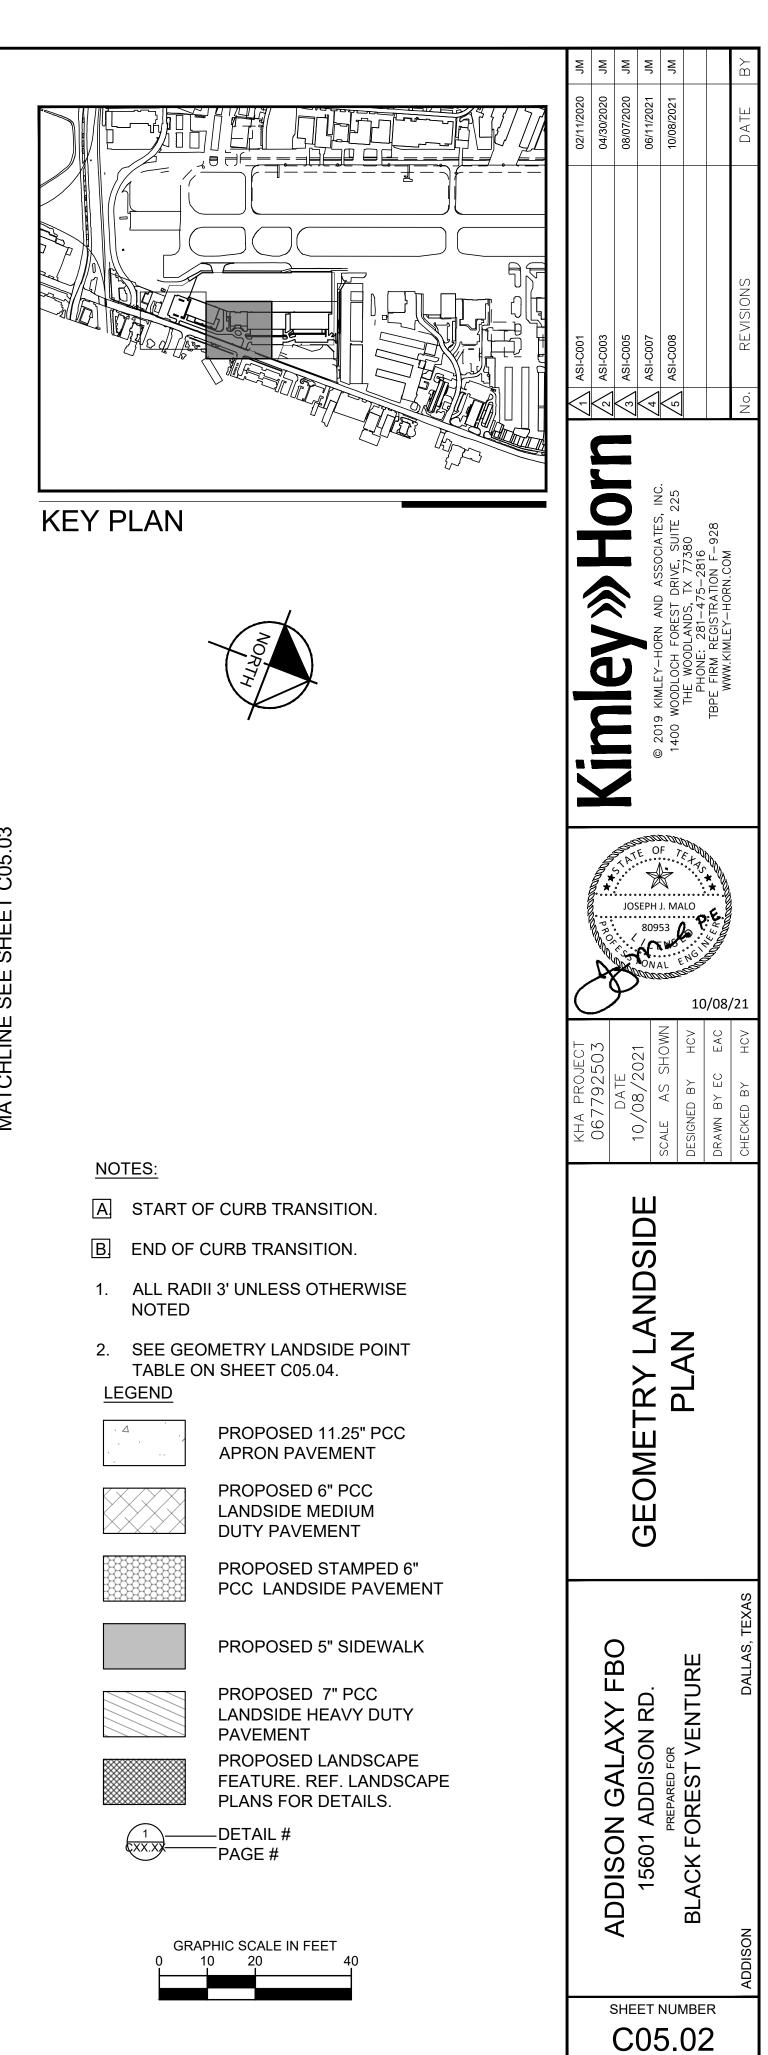

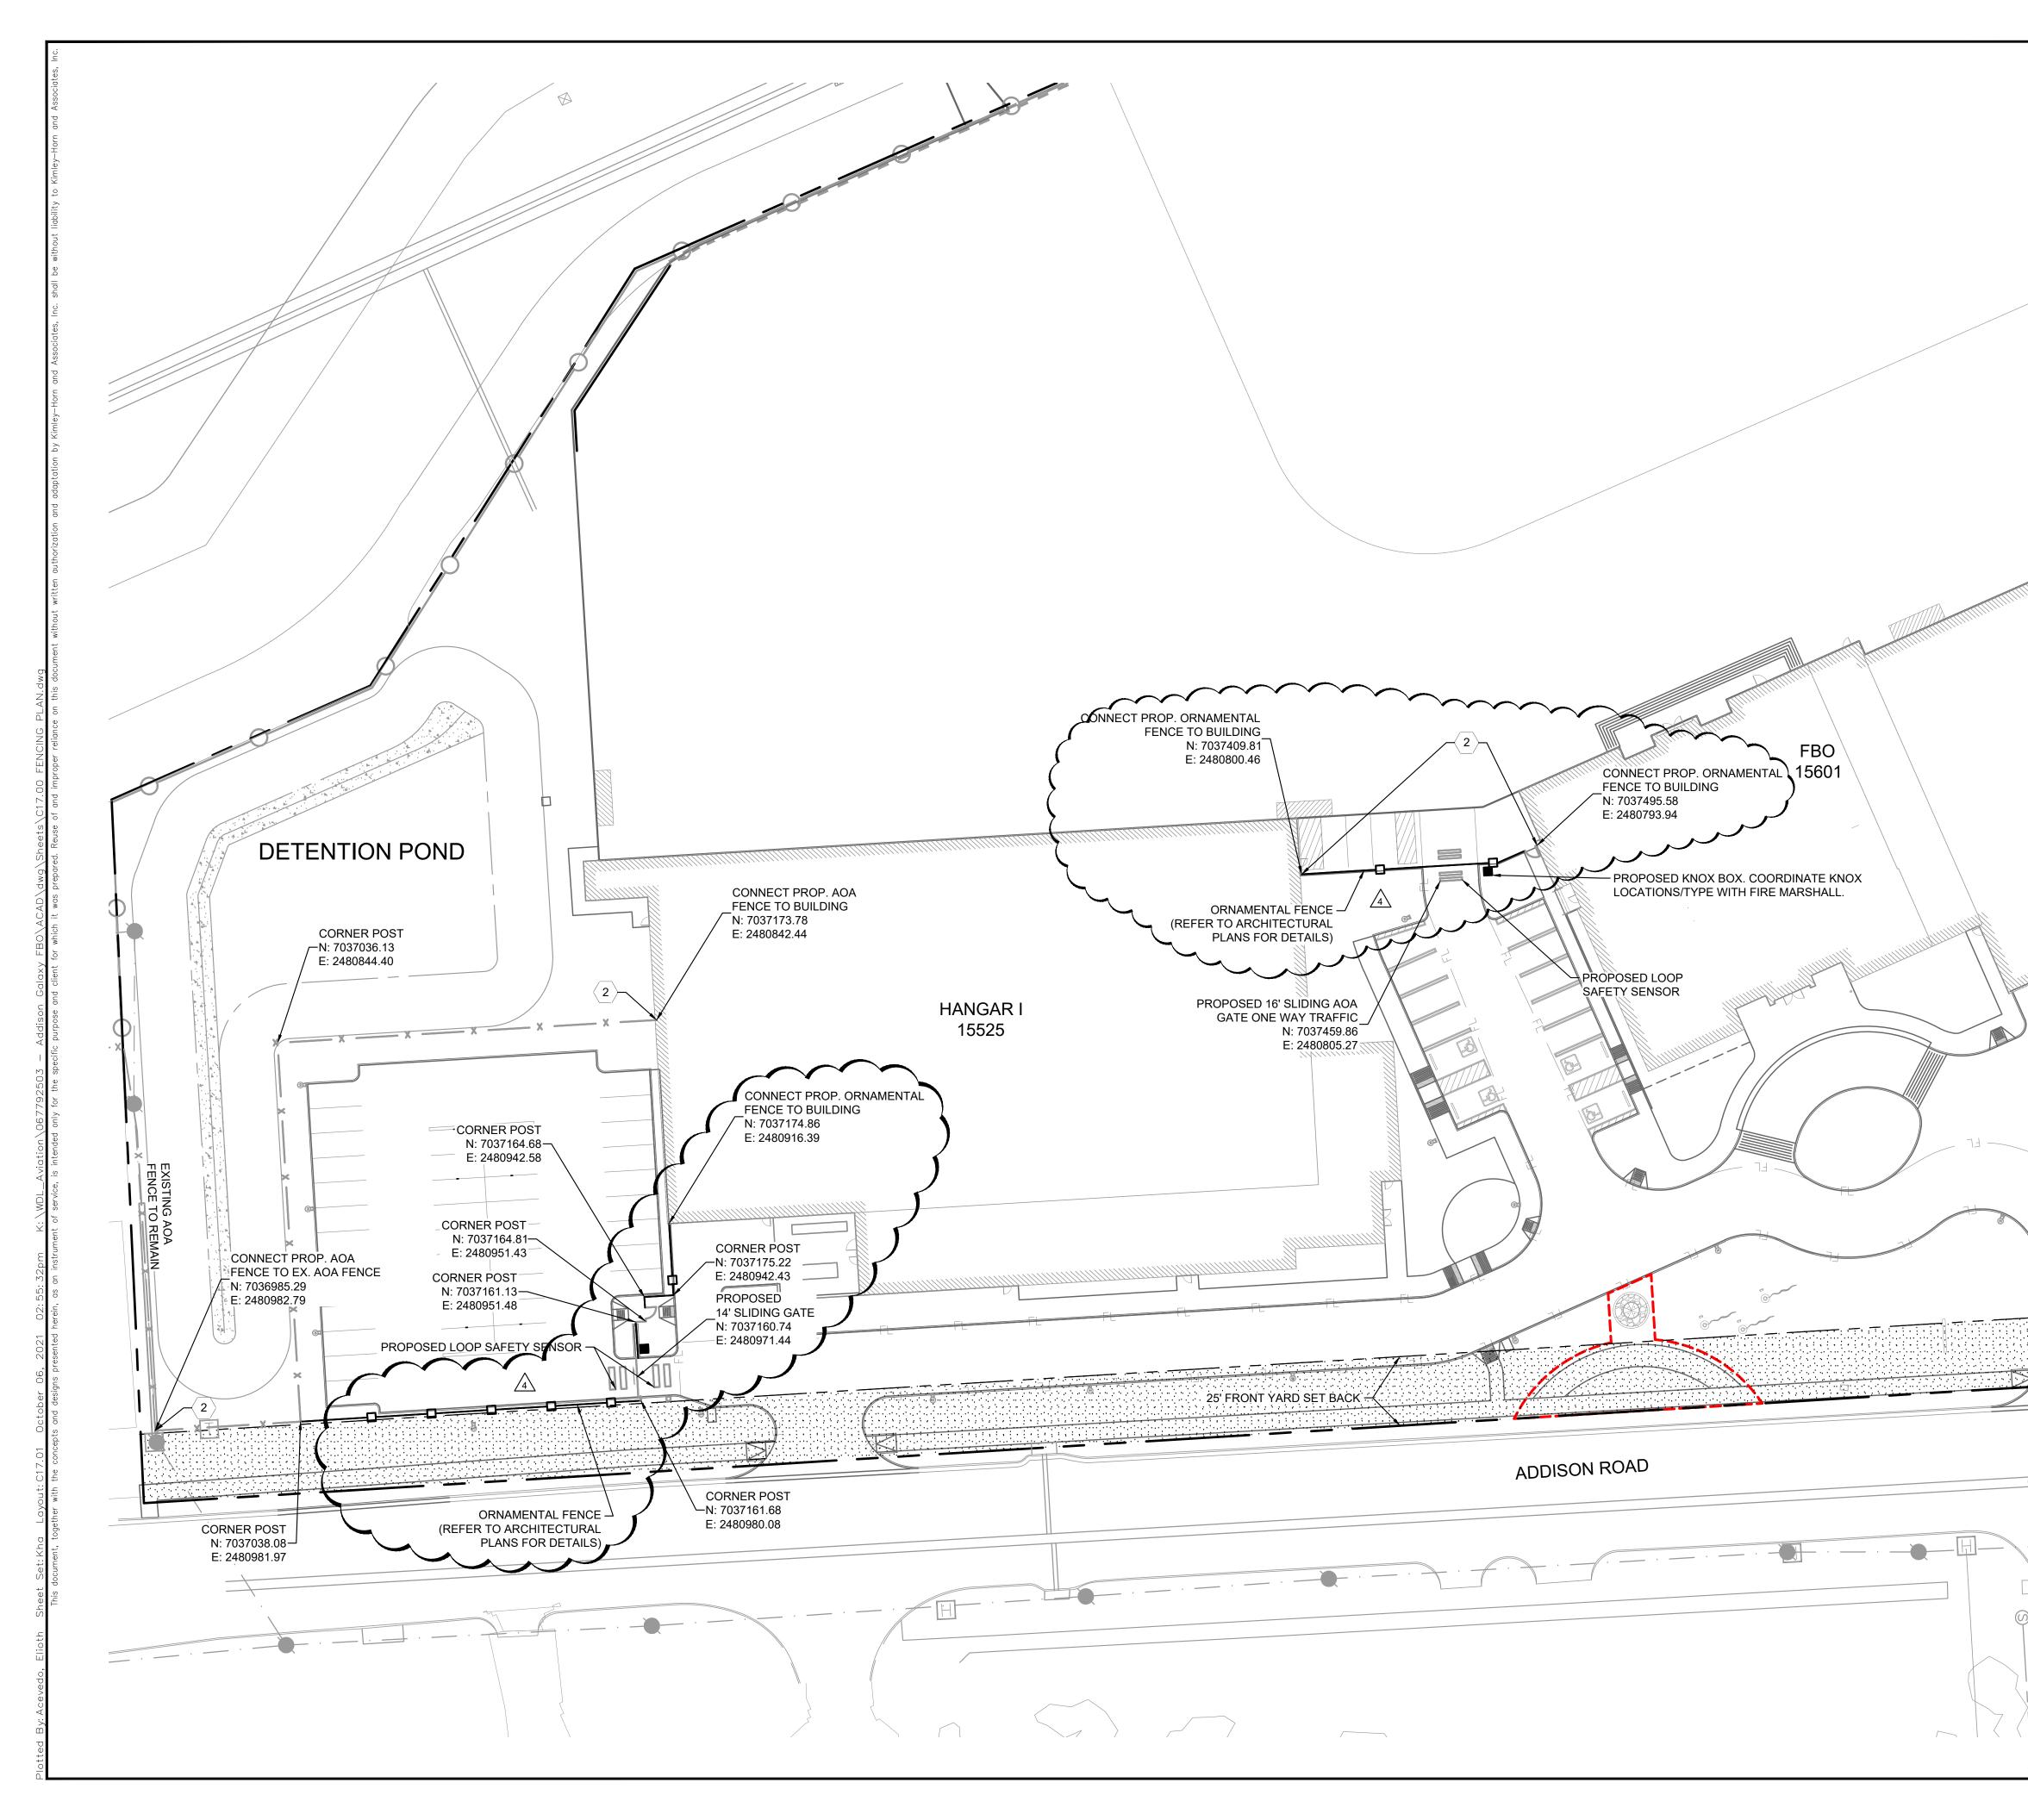

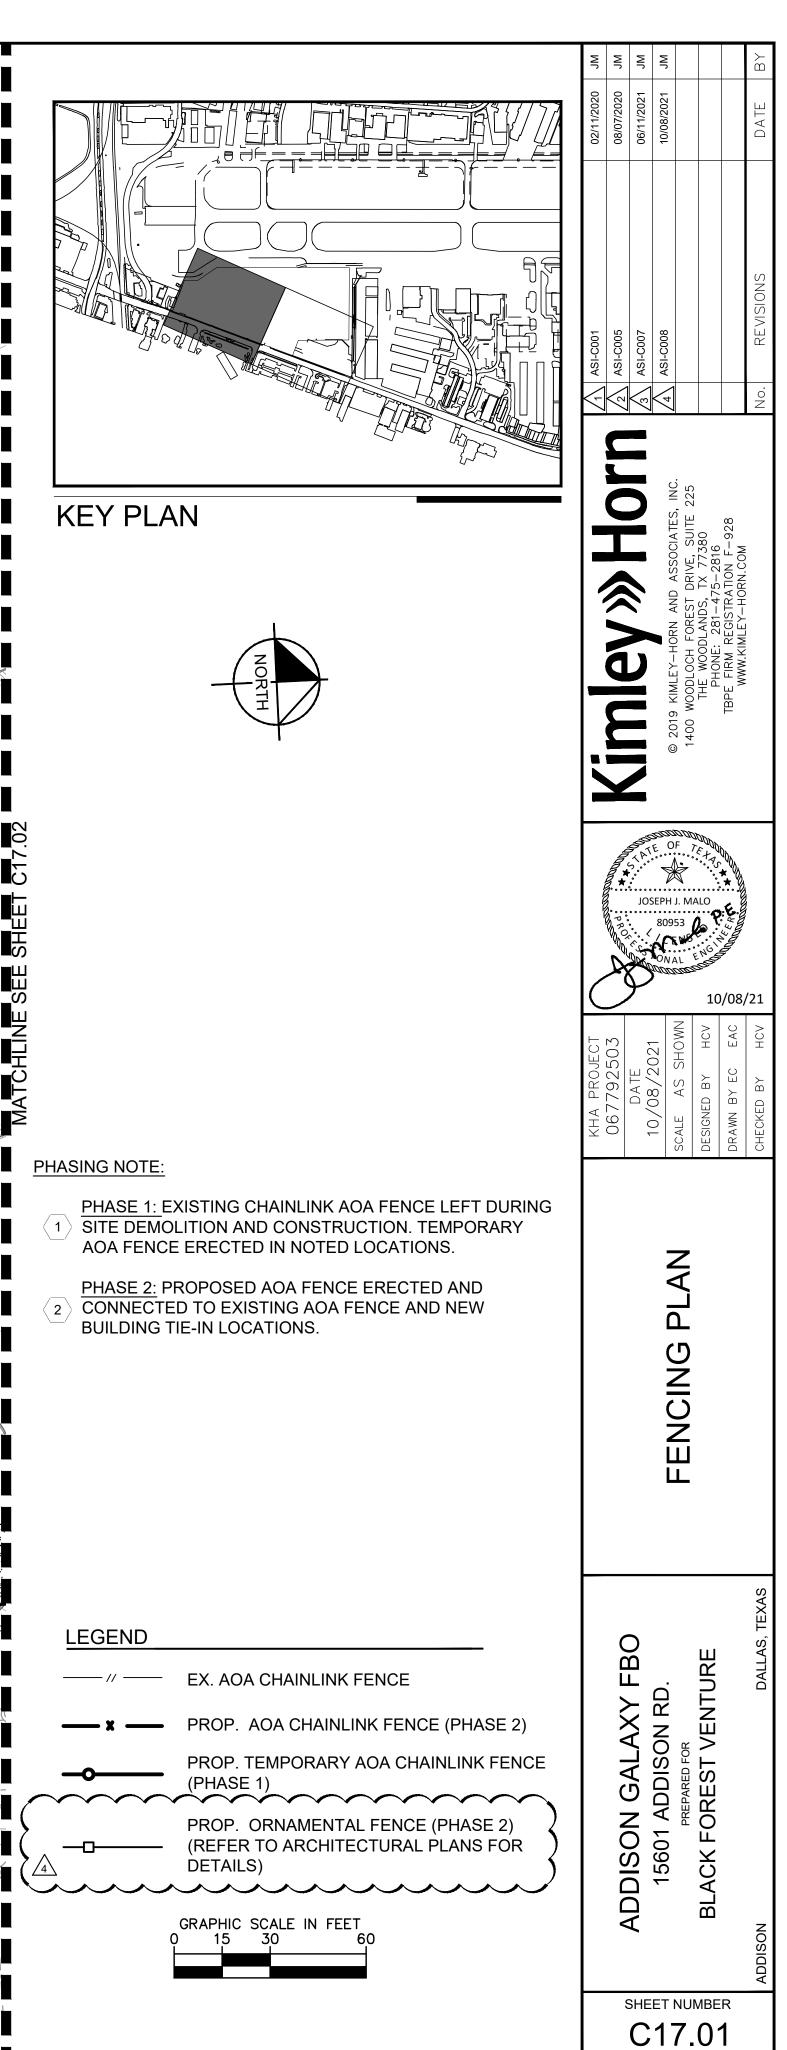

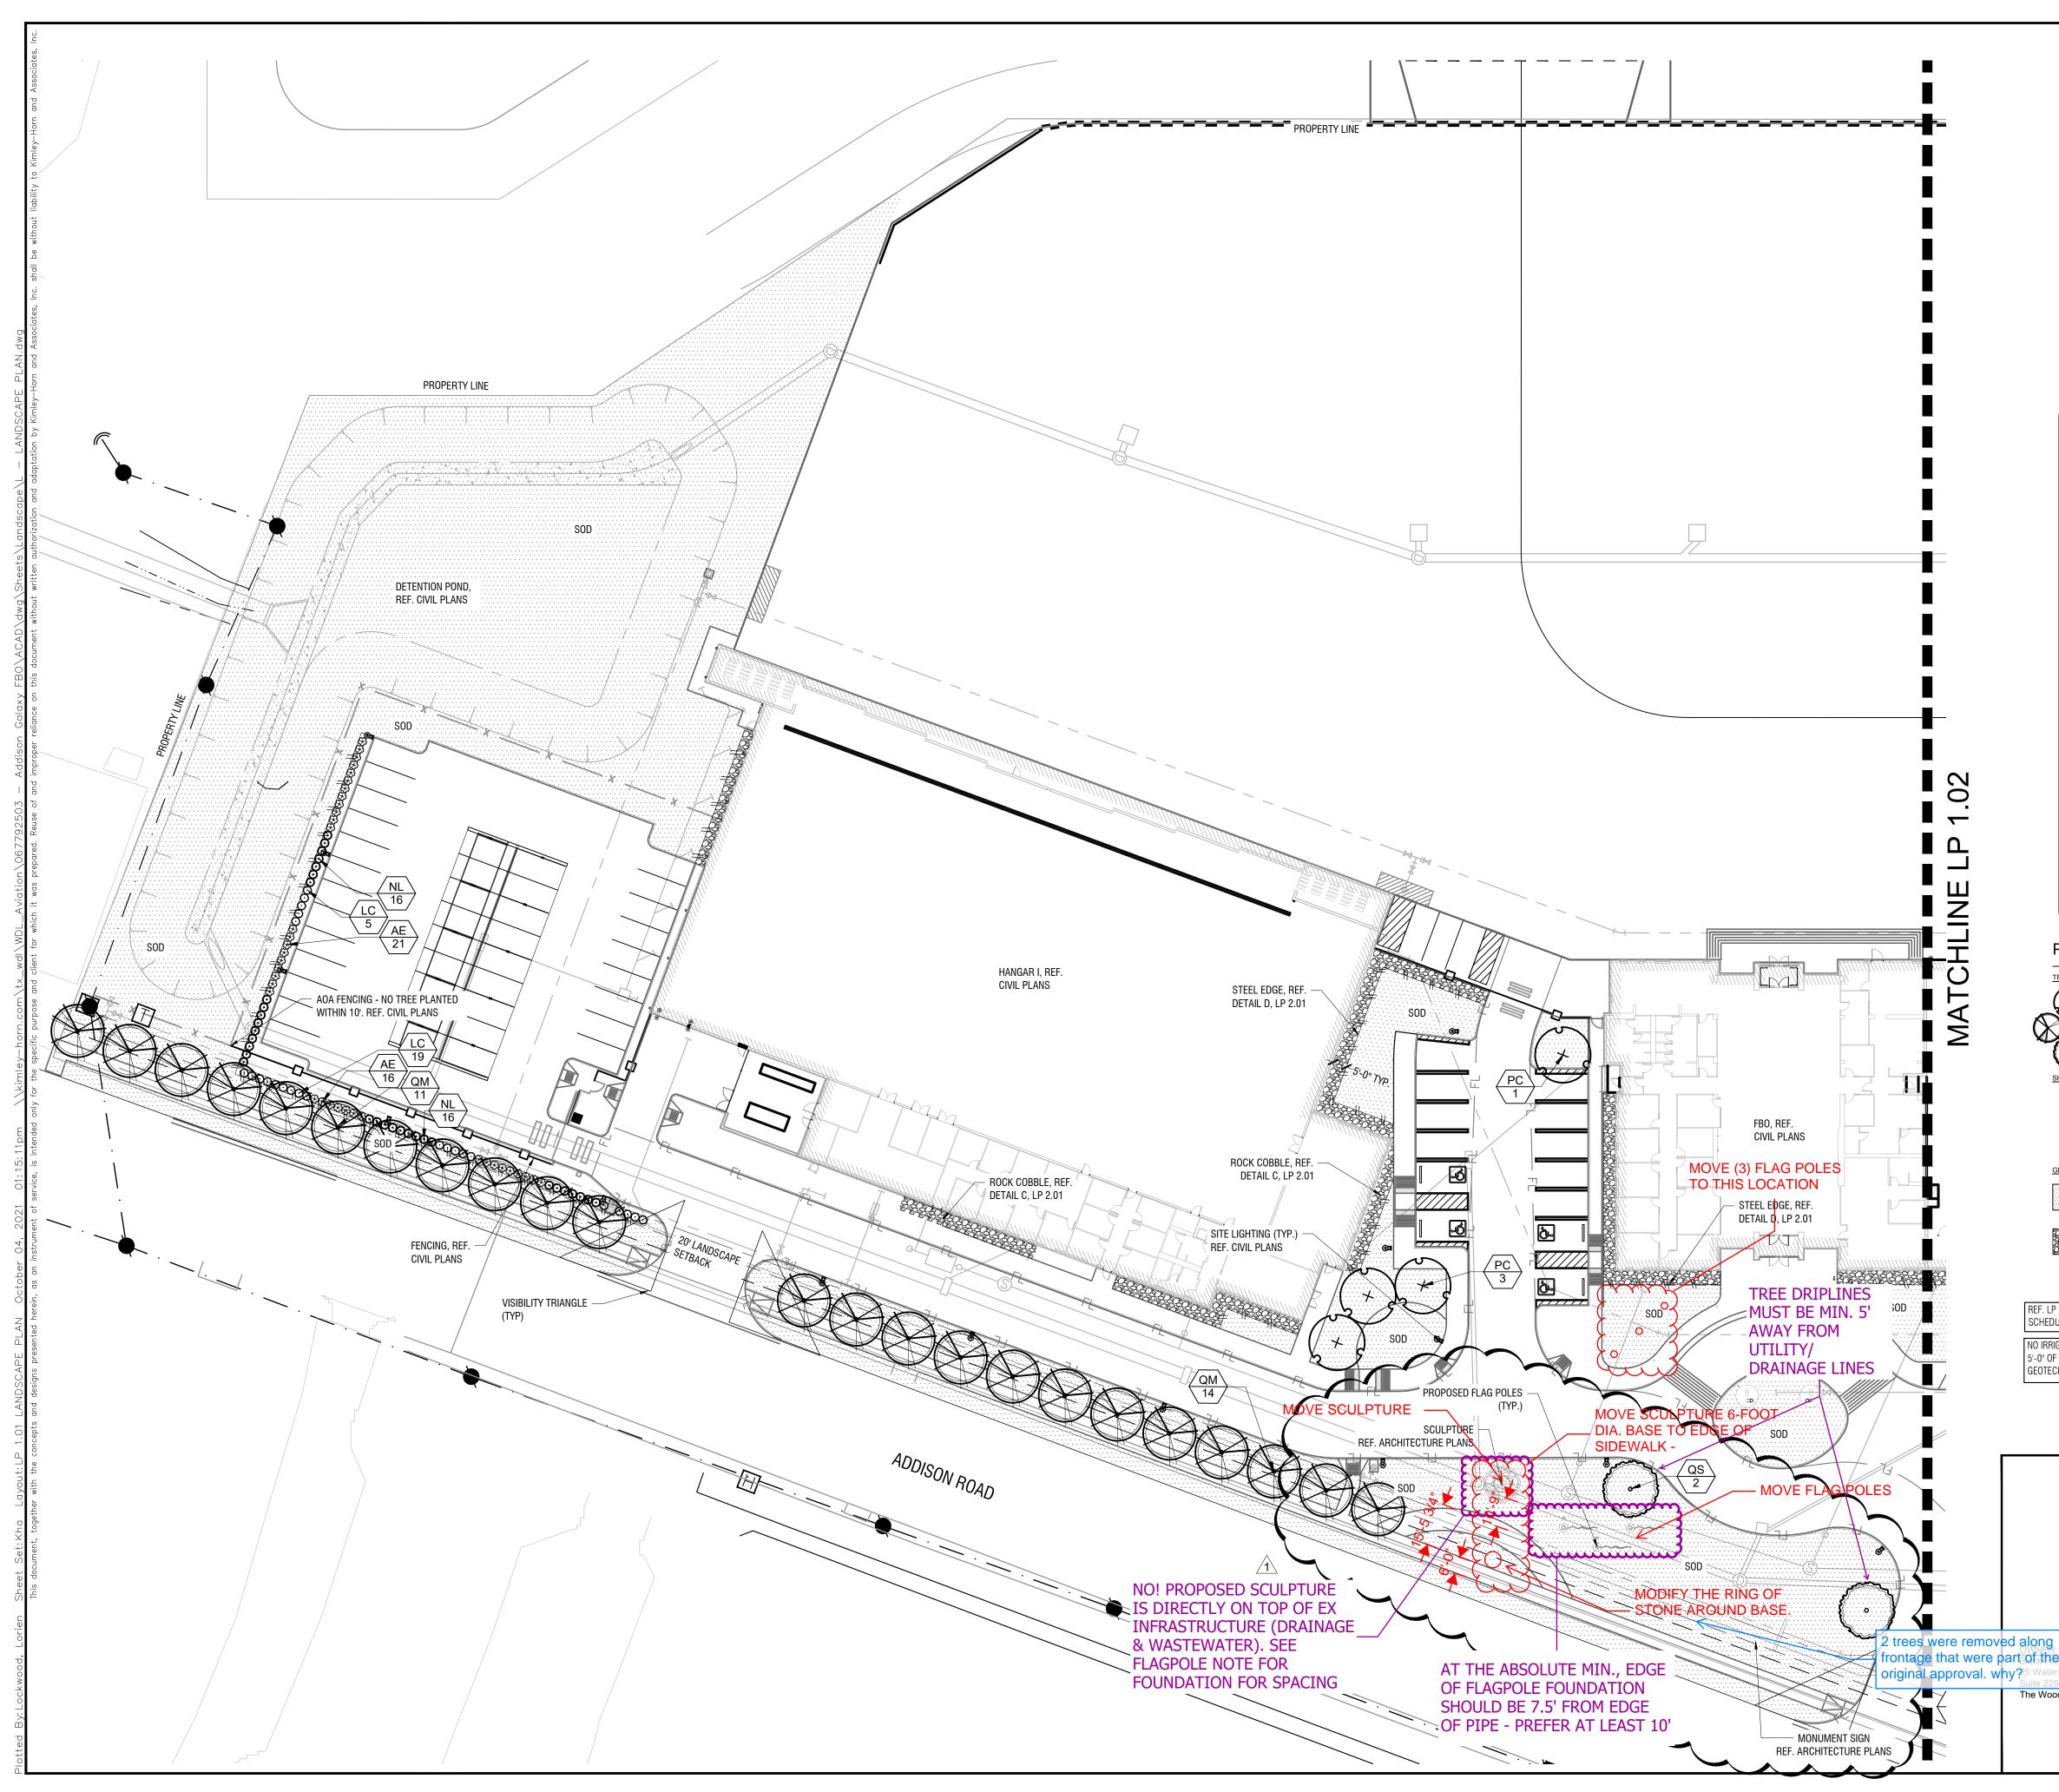

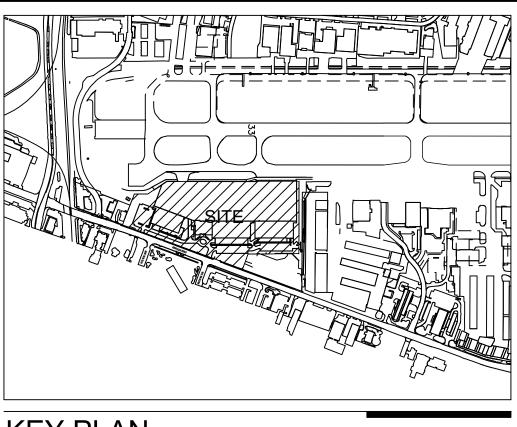

KEY PLAN


Landscaping Requirements	<u>Required</u>	<u>Provided</u>
Minimum landscape area should be 10% of the total site area.		
683,194 SF x 10% = 68,319 SF	68,319 SF (10%)	78,296 SF (11%)
Street landscape buffers shall be one 4" caliper shade tree for each 30 LF of frontage and evergreen shrubs planted 3- 3.5 on center.		
990 LF / 30 LF $=$ 33 Trees	33 Trees	29 New Trees + 4 Existing Trees
Landscape Screening and Buffering	<u>Required</u>	<u>Provided</u>
Surface parking lot screening must be at least 3.5 feet higher than the finished elevation of the adjacent parking lot. Evergreen shrub planted three feet on center in a single row in a bed at least 42 inches wide.	Yes	Yes
The perimeter parking lot landscape strip shall be at least 5 feet wide for sites larger than 10,000 SF. Minimum requirement for perimeter landscaping 5 feet wide and greater shall be one 4" caliper shade tree for each 35 LF of perimeter and one shrub planted 3-3.5 feet on center.	Yes	Yes - Due to AOA fence regulations, trees have been relocated on site
558 LF of perimeter parking / 35 LF $=$ 16 Trees	16 Trees	16 Trees
Surface Parking Lot Landscaping	<u>Required</u>	<u>Provided</u>
The required percentage of interior parking lot landscaping shall be 5% for 7,000 - 49,999 SF of interior parking area.		
48,594 SF Interior Parking x $5\% = 2,429$ SF Planting Area	2,429 SF Planting Area	2,779 SF Planting Area
Large shade trees must be provided in each parking lot at minimum average density of one shade tree for each ten required parking spaces on the lot.	Yes	Yes
155 Parking Spaces / 10 $=$ 16 Trees	16 Trees	16 Trees
No required parking space may be located further than 50 feet from the trunk of shade tree, or farther than 75 feet from two or more shade trees.	Yes	N/A per existing site plan

PLANT LEGEND

TREES	CODE	BOTANICAL / COMMON NAME
	PC	PISTACIA CHINENSIS / CHINESE PISTACHE
(k)	QM	QUERCUS MUEHLENBERGII / CHINKAPIN OAK
$\overline{\mathbf{O}}$	QS	QUERCUS SHUMARDII / SHUMARD RED OAK
SHRUBS	CODE	BOTANICAL / COMMON NAME
\oplus	AE	ABELIA X GRANDIFLORA `EDWARD GOUCHER` / GLOSSY ABELIA
\odot	LC	LOROPETALUM CHINENSE `PURPLE DIAMOND` / PURPLE DIAMOND LOROPETALUM
Ð	NL	NANDINA DOMESTICA `LEMON LIME` / LEMON LIME NANDINA
GROUND COVERS	CODE	BOTANICAL / COMMON NAME
	SOD	CYNODON DACTYLON / COMMON BERMUDA GRASS
	RR	RIVER ROCK

REF. LP 2.01 FOR MASTER PLANT SCHEDULE AND NOTES

NO IRRIGATION TO BE LOCATED WITHIN 5'-0" OF BUILDING FOUNDATION PER GEOTECH REPORT.

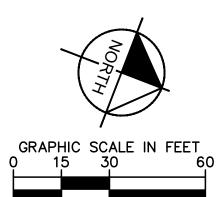

LANDSCAPE ARCHITECT:

13455 Noel Rd, Two Galleria Office Tower Suite 700

Dallas, TX 75240 Contact: Patrick B. Hart, PLA Phone: (972) 770-1300

Kimley»Horn

SHEET NUMBER

LP 1.01


ADDISON GALAXY FBO


15.67 ACRES EDWARD COOK SURVEY ABSTRACT NO. 326 SUBMITTED: 10/23/2019

frontage that were part of the st Ventures original approval. why? Waterway Ave The Woodlands, TX 77380

<u>CIVIL ENGINEER:</u> Kimley Horn 1400 Woodloch Drive Suite 225 The Woodlands, TX 77380 Phone: (281) 475-2816

10, SCALE DESIGN DRAWN Ш \triangleleft ANDSCA ADDISON GALAXY FBO 15601 ADDISON RD. BLACK FOREST VENTURE

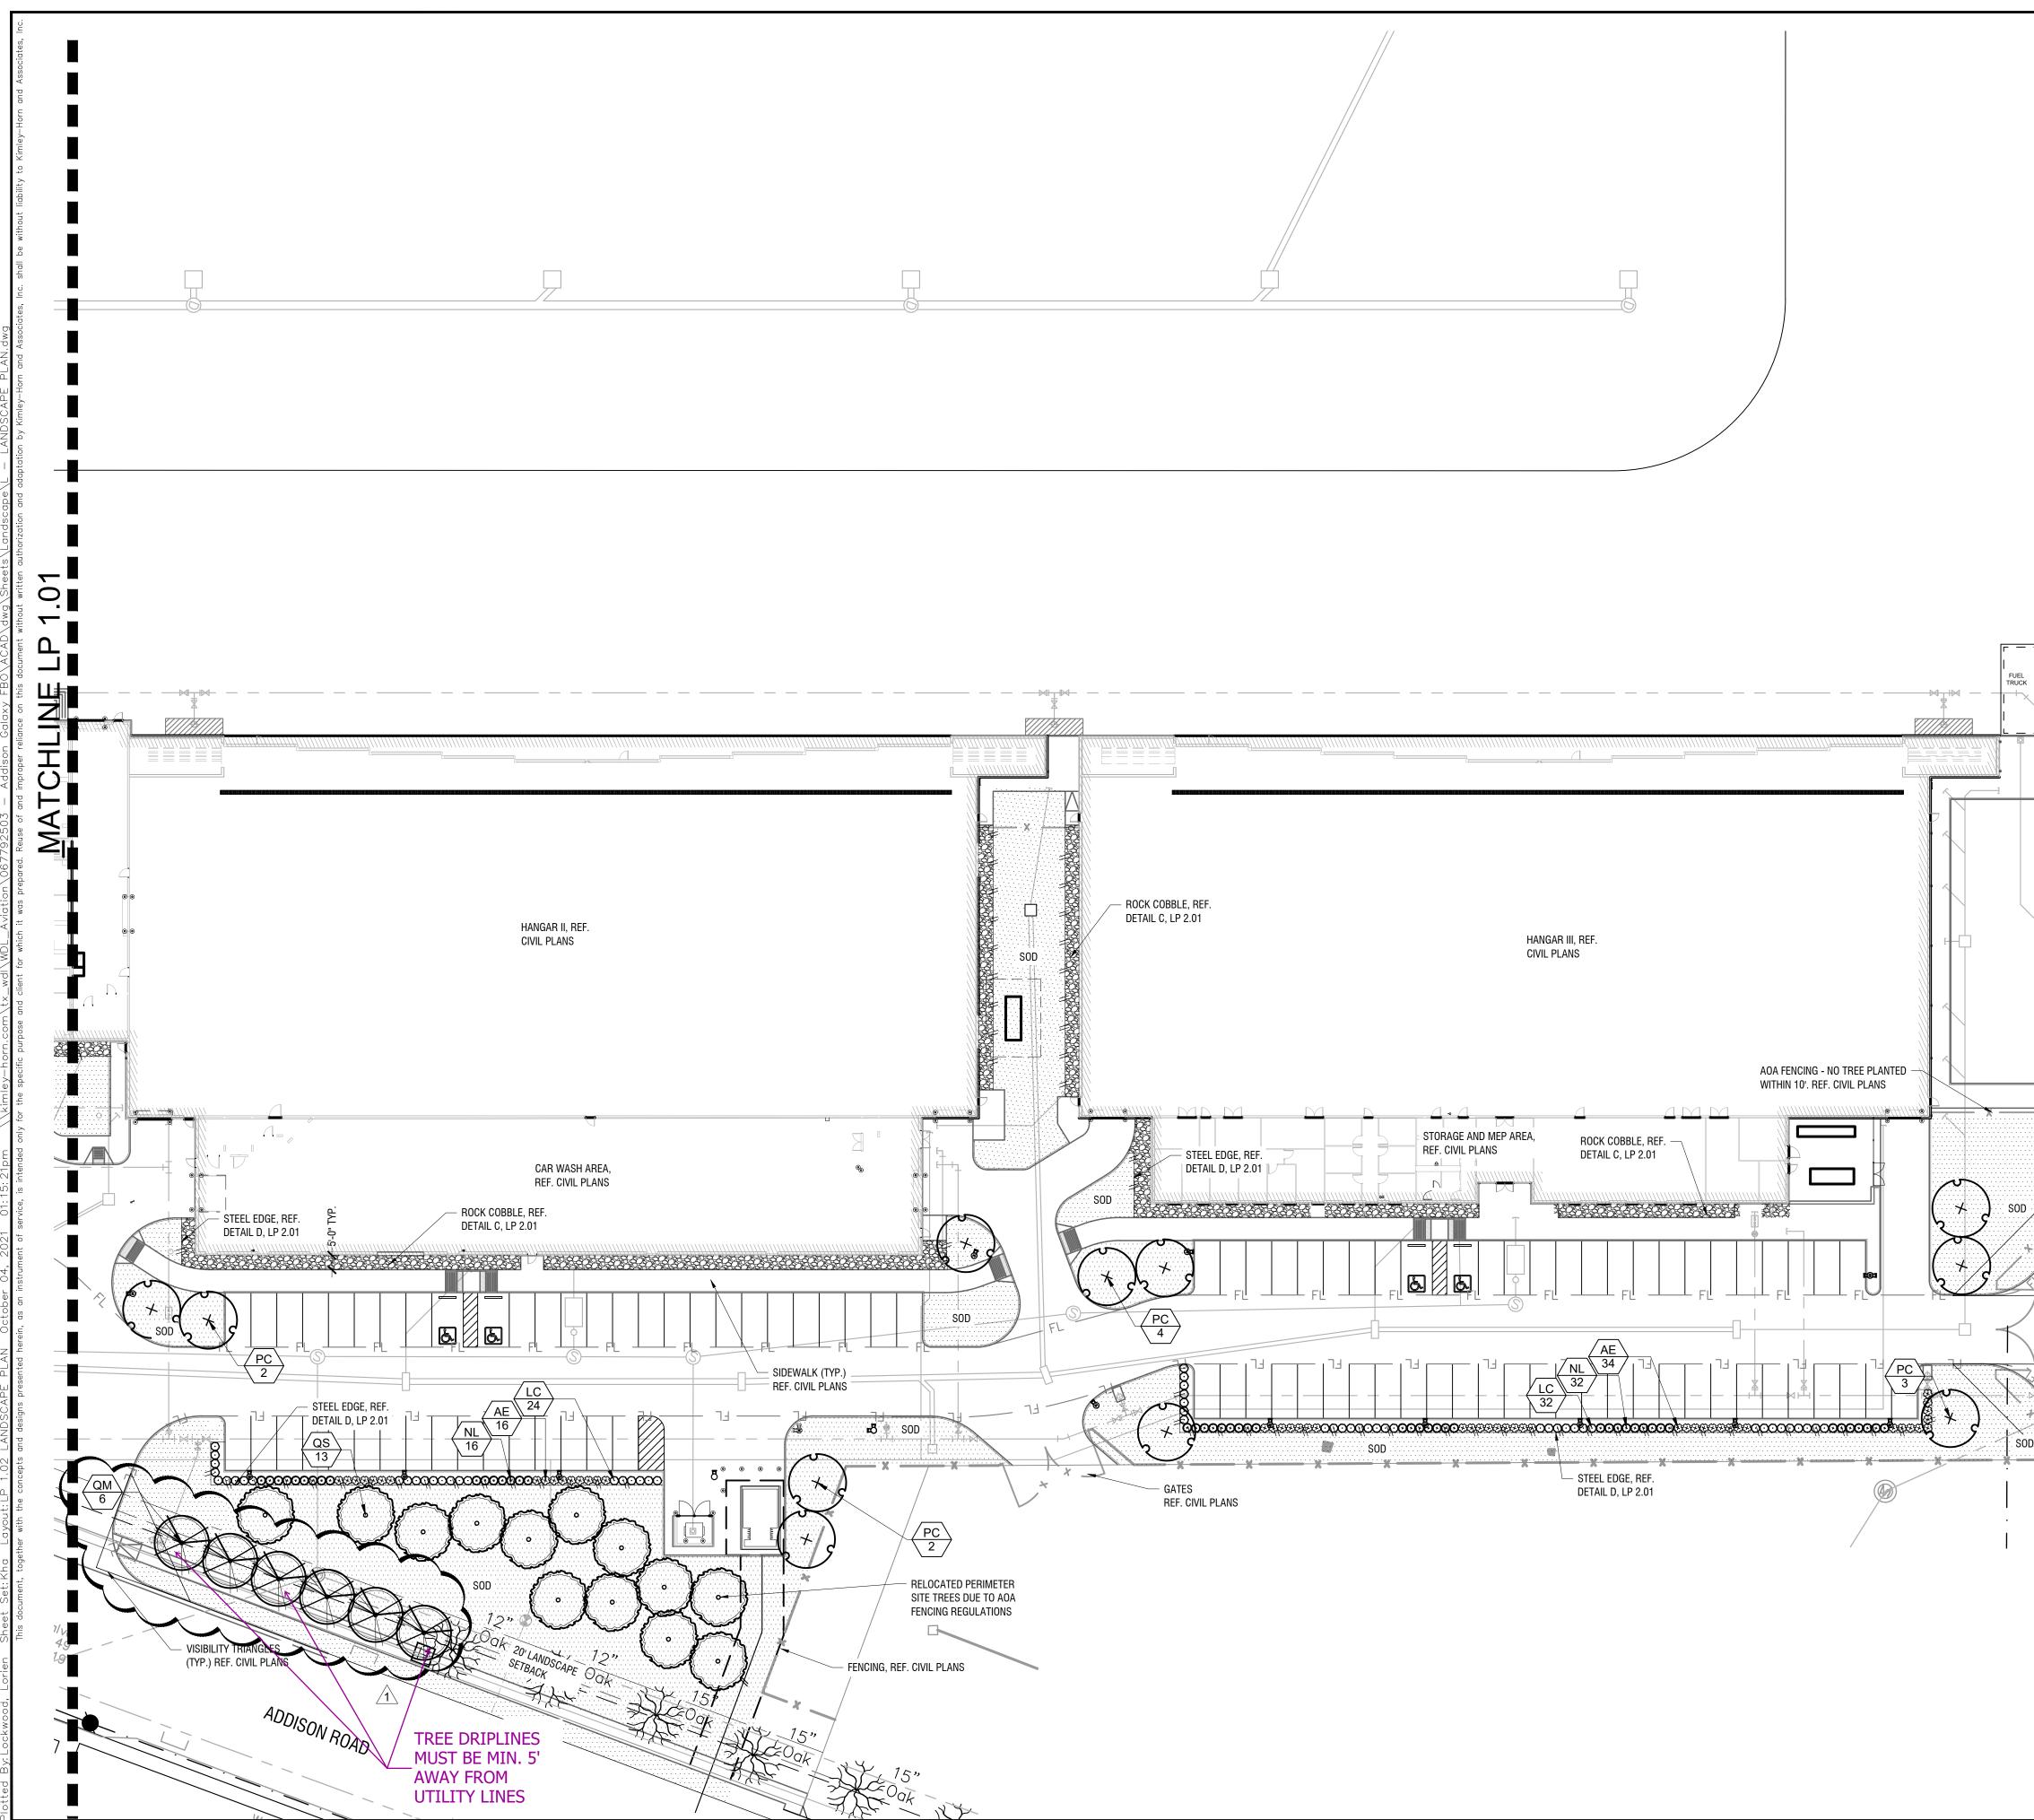


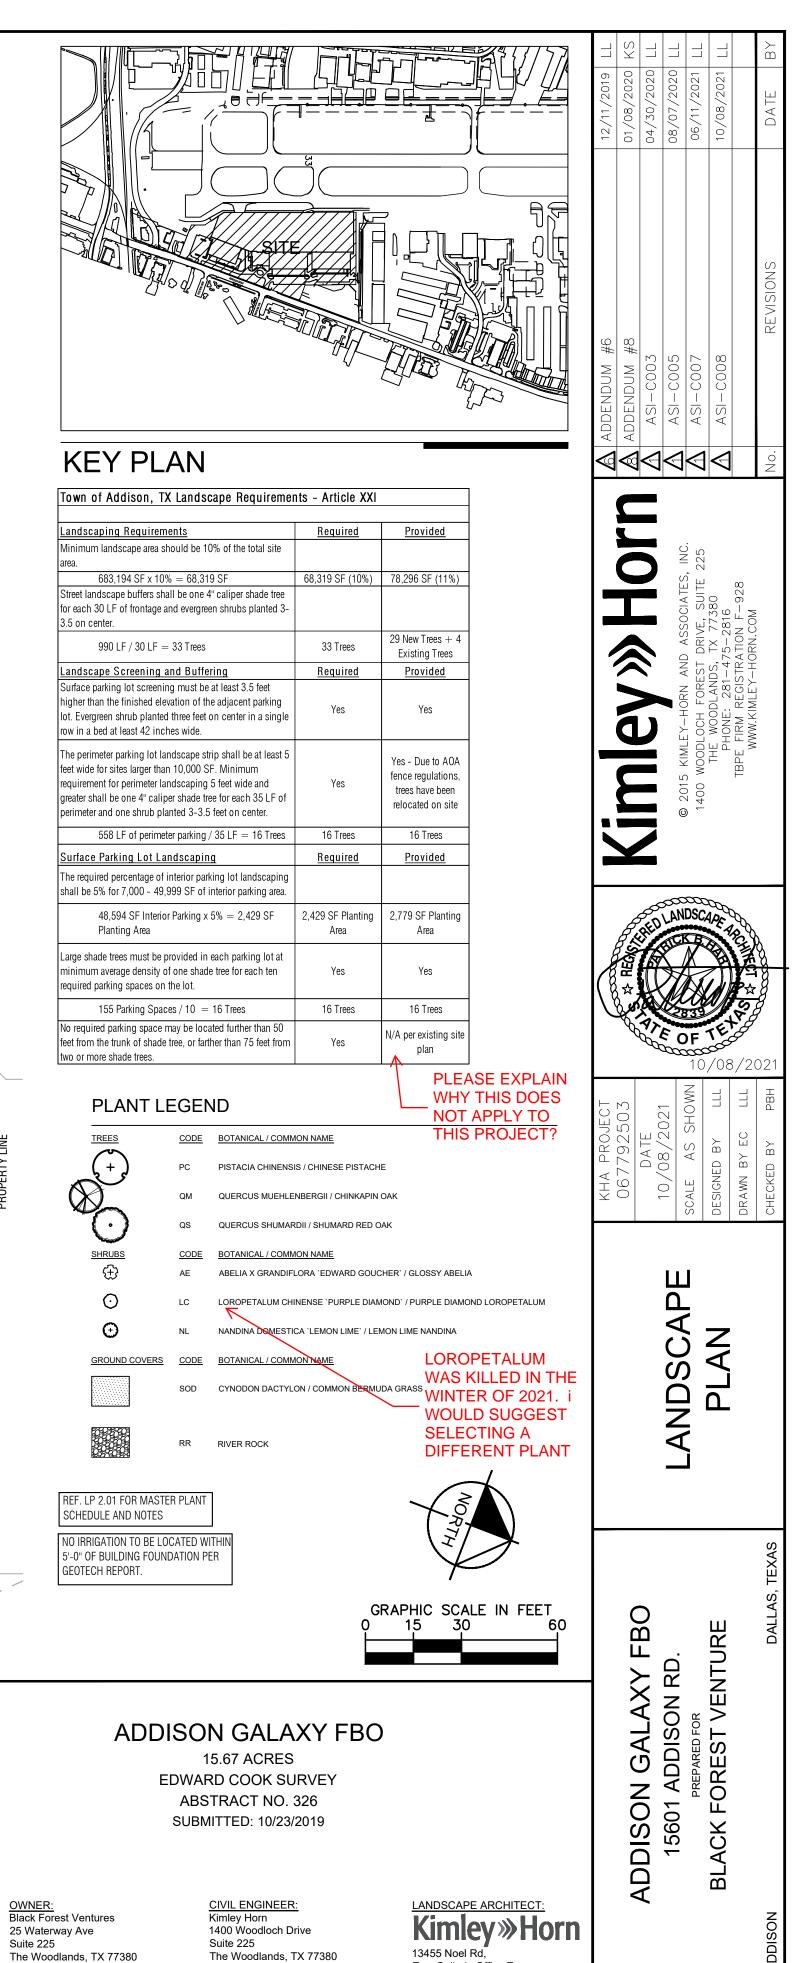


Phone: (281) 475-2816

Two Galleria Office Tower Suite 700 Dallas, TX 75240 Contact: Patrick B. Hart, PLA Phone: (972) 770-1300

SHEET NUMBER LP 1.02

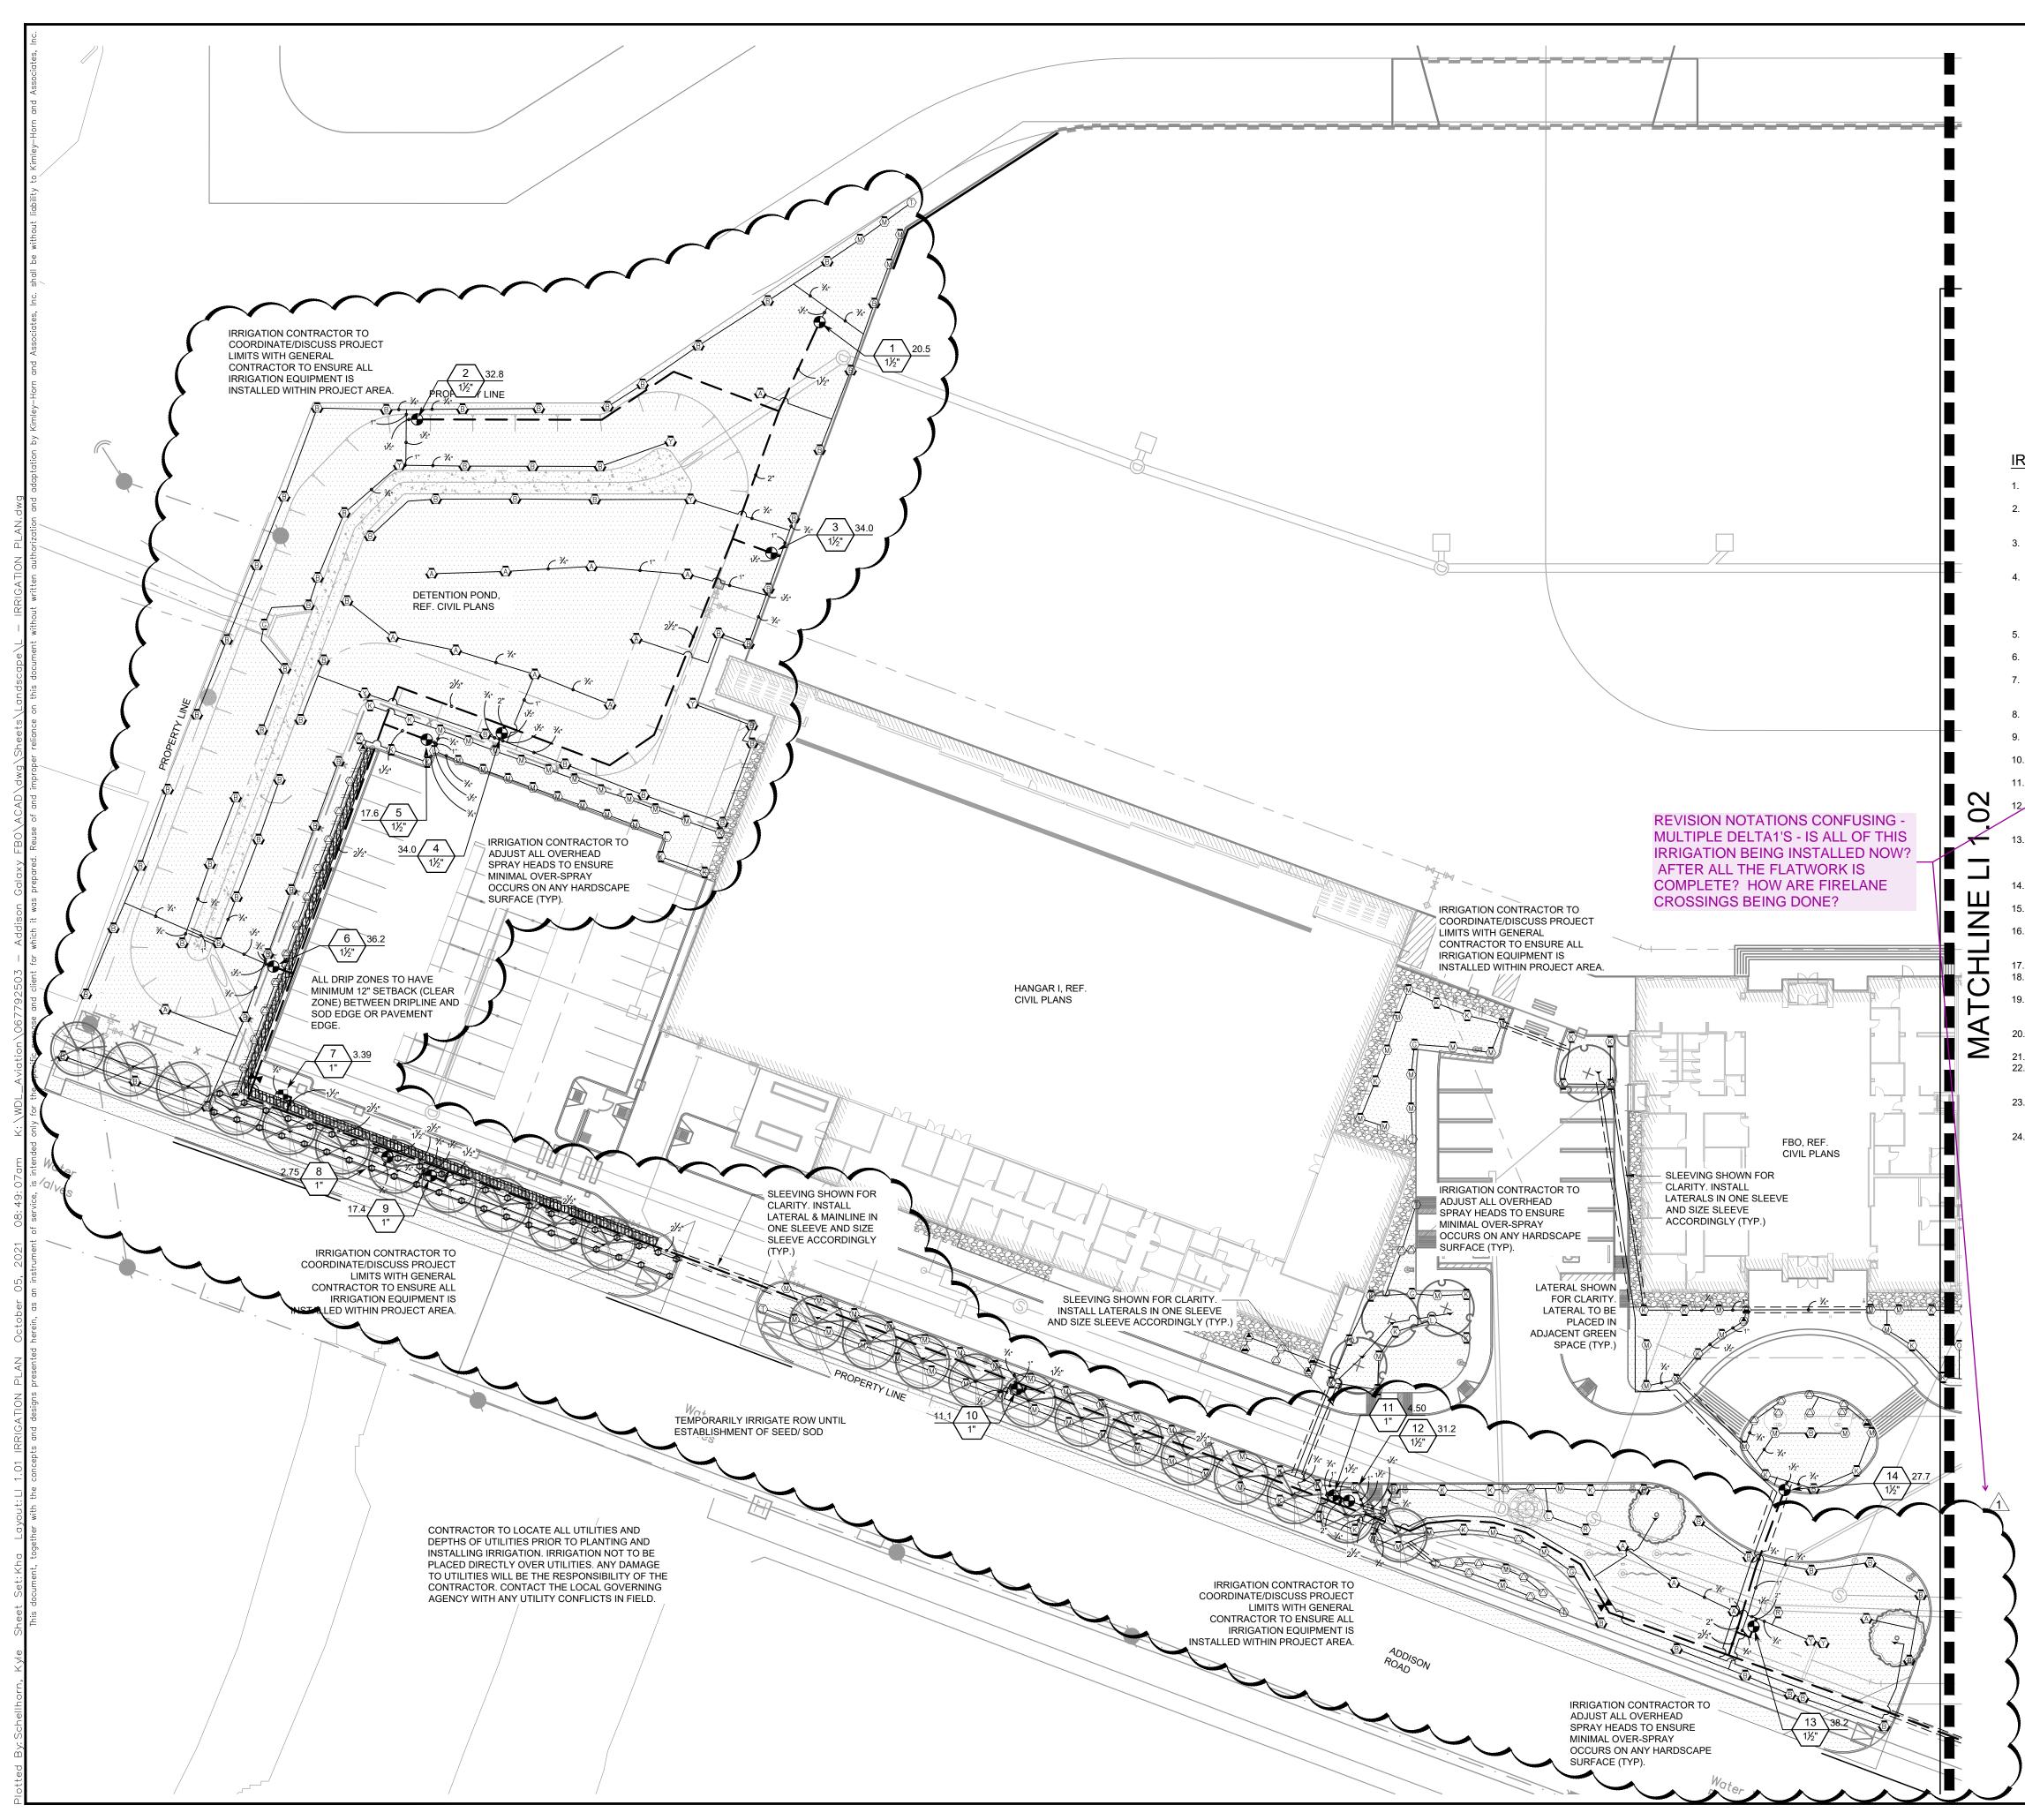

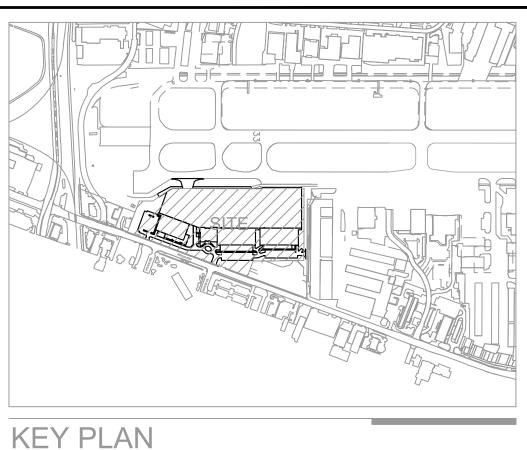

IRRIGATION NOTES:

- 1. CONTRACTOR SHALL VERIFY ALL DIMENSIONS, ELEVATIONS, EQUIPMENT QUANTITIES, AND UTILITY LOCATIONS PRIOR TO BEGINNING WORK. 2. CONTRACTOR SHALL NOTIFY LANDSCAPE ARCHITECT OF ANY DISCREPANCIES IN PLANS OR
- SPECIFICATIONS PRIOR TO BEGINNING OR
- CONTINUING WORK. THE CONTRACTOR SHALL MAKE NO SUBSTITUTIONS, DELETIONS, OR ADDITIONS TO THIS PLAN WITHOUT APPROVAL OF THE LANDSCAPE
- ARCHITECT ALL CONSTRUCTION SHALL CONFORM TO CITY, COUNTY, STATE, AND FEDERAL REQUIREMENTS. IT SHALL BE THE RESPONSIBILITY OF THE IRRIGATION CONTRACTOR TO ENSURE THAT ALL IRRIGATION EQUIPMENT MEETS GOVERNMENT REGULATIONS. CONTRACTOR SHALL ALSO BE RESPONSIBLE FOR OBTAINING ANY NECESSARY PERMITS OR APPROVALS PRIOR TO COMMENCEMENT OF OPERATIONS ON-SITE. COPIES OF THE PERMITS SHALL BE SENT TO THE OWNER/GENERAL CONTRACTOR. THIS PLAN IS SCHEMATIC AND DUE TO THE NATURE OF CONSTRUCTION SLIGHT FIELD MODIFICATIONS MAY BE NECESSARY TO IMPLEMENT PLAN.
- THIS IRRIGATION SYSTEM IS DESIGNED TO THE FOLLOWING STATS: 75 G.P.M. STATIC WATER PRESSURE IS 65 P S I CONTRACTOR TO VERIFY ACTUAL AVAILABLE WATER PRESSURE BEFORE BEGINNING INSTALLATION. CONTRACTOR SHALL NOTIFY LANDSCAPE ARCHITECT IF AVAILABLE WATER PRESSURE EXCEEDS 5 PSI HIGHER OR LOWER THAN AVAILABLE WATER PRESSURE.
- VERIFY CONTROLLER AND RAIN SENSOR LOCATION AND MAINLINE POINT OF CONNECTION AT PROJECT SITE WITH OWNER IRRIGATION SYSTEMS CONNECTED TO POTABLE WATER SUPPLY, SHALL HAVE A BACKFLOW PREVENTER INSTALLED.
- 10. WHERE APPLICABLE IRRIGATION HEADS ARE TO BE ADJUSTED FOR COMPLETE COVERAGE WITH MINIMUM OVER SPRAY BEYOND LANDSCAPE AREAS. 11. EXISTING TREES TO REMAIN ARE TO BE PROTECTED FROM DAMAGE. DO NOT TRENCH OR EXCAVATE WITHIN
- THE CRITICAL ROOT ZONE OF ANY TREE. 12/ IRRIGATION LATERAL LINES, MAIN LINES AND EQUIPMENT MAY BE SHOWN OUTSIDE PROPERTY LINES ON THIS PLAN, ALL IRRIGATION LINES AND EQUIPMENT ARE TO BE WITHIN AND INSTALLED WITHIN THE LIMITS OF THE PROPERTY LINE.
- ALL IRRIGATION SLEEVING TO BE THE RESPONSIBILITY OF THE IRRIGATION CONTRACTOR UNLESS OTHERWISE NOTED. ELECTRICAL WIRES FOR IRRIGATION VALVES AND IRRIGATION LINES ARE TO BE PLACED IN SEPARATE SLEEVES. SEE SLEEVING DETAIL. ALL PRESSURE MAINLINES UNDER ASPHALT PAVEMENT SHALL BE PLACED WITHIN SLEEVES AS NOTED. 14. GENERAL CONTRACTOR AND IRRIGATION CONTRACTOR TO COORDINATE INSTALLATION OF METER,
- BACKFLOW, AND ASSOCIATED APPURTENANCES. ALL PLANT MATERIAL IN TREE HOLDING AREAS SHALL BE MANUALLY WATERED/IRRIGATED TO KEEP MOIST UNTIL PLANTED.
- MAINLINE, VALVES, AND WIRING ARE SHOWN ON DRAWINGS FOR CLARITY, SHOULD BE LOCATED IN ACCESSIBLE GREEN SPACE. CONTRACTOR TO COORDINATE WITH ALL DISCIPLINES TO AVOID CONFLICTS WITH UTILITIES/ STRUCTURES, ETC.
- CONTRACTOR RESPONSIBLE FOR PROVIDING 110 SINGLE PHASE POWER TO CONTROLLER. INSTALLATION OF WORK SHALL BE COORDINATED WITH OTHER CONTRACTORS IN SUCH A MANNER AS TO ALLOW FOR A SPEEDY AND ORDERLY COMPLETION OF ALL WORK ON THE SITE. ALL 24 VAC WIRING SHALL BE OF DIRECT BURIAL COPPER WIRE AS FOLLOWS:
- CONTROL WIRES #14
- COMMON WIRES #12 20. LOCATE ALL VALVES A MINIMUM OF 24" FROM BACK OF CURB OR EDGE OF PAVEMENT, UNLESS NOTED OTHERWISE
- 21. SET SPRAY HEADS 4" FROM BACK OF CURB OR 24" IF PAVEMENT HAS NO CURB. 22. CONTRACTOR SHALL PROVIDE "AS-BUILT" DRAWINGS OF THE FINAL INSTALLATION TO OWNER AT SUBSTANTIAL COMPLETION BEFORE RECEIVING FINAL PAYMENT. "AS-BUILT" DRAWINGS TO BE COLOR
- CODED BY ZONE ON 8.5" X 11" COPY, LAMINATED, AND PLACED IN CONTROLLER. 23. THE SYSTEM HAS BEEN DESIGNED TO PROVIDE 100% COVERAGE, ANY CHANGES MADE IN THE LAYOUT DUE TO FIELD CONDITIONS SHALL BE IN ACCORDANCE WITH THESE STANDARDS. QUANTITIES IN SCHEDULE ARE ESTIMATED. PLAN SHALL TAKE PRECEDENCE.
- IRRIGATION VALVES AND VALVE BOXES SHALL BE LOCATED IN LANDSCAPE BEDS OR GROUNDCOVER AREAS WHENEVER POSSIBLE. ALL REMOTE VALVE BOXES SHALL BE SET FLUSH WITH FINISHED GRADE AND CONTAIN ONE CUBIC FOOT OF CLEAN GRAVEL BENEATH VALVE. LABEL REMOTE BOXES WITH ONE-INCH ALPHA NUMERIC NOTATION CORRESPONDING TO THE APPLICABLE ALPHA CONTROLLER AND NUMERIC STATION.

THIS IRRIGATION PLAN IS DESIGNED TO THE FOLLOWING STATS: 65 PSI AND 120 GPM. IF WATER PRESSURE DOES NOT MEET DESIGN SPECIFICATIONS A BOOSTER PUMP WILL BE REQUIRED AT COST OF CONTRACTOR. CONTACT LANDSCAPE ARCHITECT PRIOR TO INSTALLATION IF SYSTEM HAS +/- 5 PSI THAN DESIGN PRESSURE.

REFERENCE MAXIMUM LATERAL DRIPLINE CHART TO DETERMINE MINIMUM NUMBER OF POINTS OF CONNECTION PER DRIP LINE ZONE.

WHERE LAYOUT FLEXIBILITY EXISTS CENTER FEED LAYOUTS MUST BE USED. THIS ALLOWS FOR EVEN FLOW OF WATER THROUGH THE ZONE.

GRAPHIC SCALE IN FEET 60 REF. SHEET LI 1.02 FOR IRRIGATION SCHEDULE

NO IRRIGATION TO BE LOCATED WITHIN 5'-0" OF BUILDING FOUNDATION PER GEOTECH REPORT.



ADDISON GALAXY FBO 15.67 ACRES

EDWARD COOK SURVEY ABSTRACT NO. 326 SUBMITTED: 10/23/2019


OWNER: Black Forest Ventures 25 Waterway Ave Suite 225 The Woodlands, TX 77380 CIVIL ENGINEER: Kimley Horn 1400 Woodloch Drive Suite 225 The Woodlands, TX 77380 Phone: (281) 475-2816

Kimley »Horn 13455 Noel Rd, Two Galleria Office Tower Suite 700 Dallas, TX 75240 Contact: Patrick B. Hart, PLA Phone: (972) 770-1300

LI 1.01

LANDSCAPE ARCHITECT:

09/06/19 KS	10/24/2019 KU	12/11/2019 KU	01/08/2020 KS	08/06/2020 KU	06/11/2021 KU	10/08/2021 KS	DATE BY	
ADDENDUM #1	igtriangleta addendum #5	🔬 addendum #6	ADDENDUM #8	ASI-C005	ASI-C007	¥▲ ASI-C008	REVISIONS	
$ \Psi $						$\neq \nabla_{\!$	No.	
			© 2021 KIMI EY-HORN AND ASSOCIATES INC	1400 WOODLOCH FOREST DRIVE, SUITE 225	THE WOODLANDS, TX 77380 PHONE: 281-475-2816	TBPE FIRM REGISTRATION F-928 WWW.KIMLEY-HORN.COM		
	к К	YLE K			RICK	RN		
KHA PROJECT	067792503	DATE 10 /00 /2021	1707/00/01	SCALE AS SHOWN	DESIGNED BY KAU	DRAWN BY EC KWS	снескер ву kws	
			IRRIGATION PI AN					
		JUN GALAAT FBU	5601 ADDISON RD.	ED FOR	CK FOREST VENTURE		DALLAS, TEXAS	
			15601 ADD	PREPARED FOR	BLACK FORE		ADDISON	

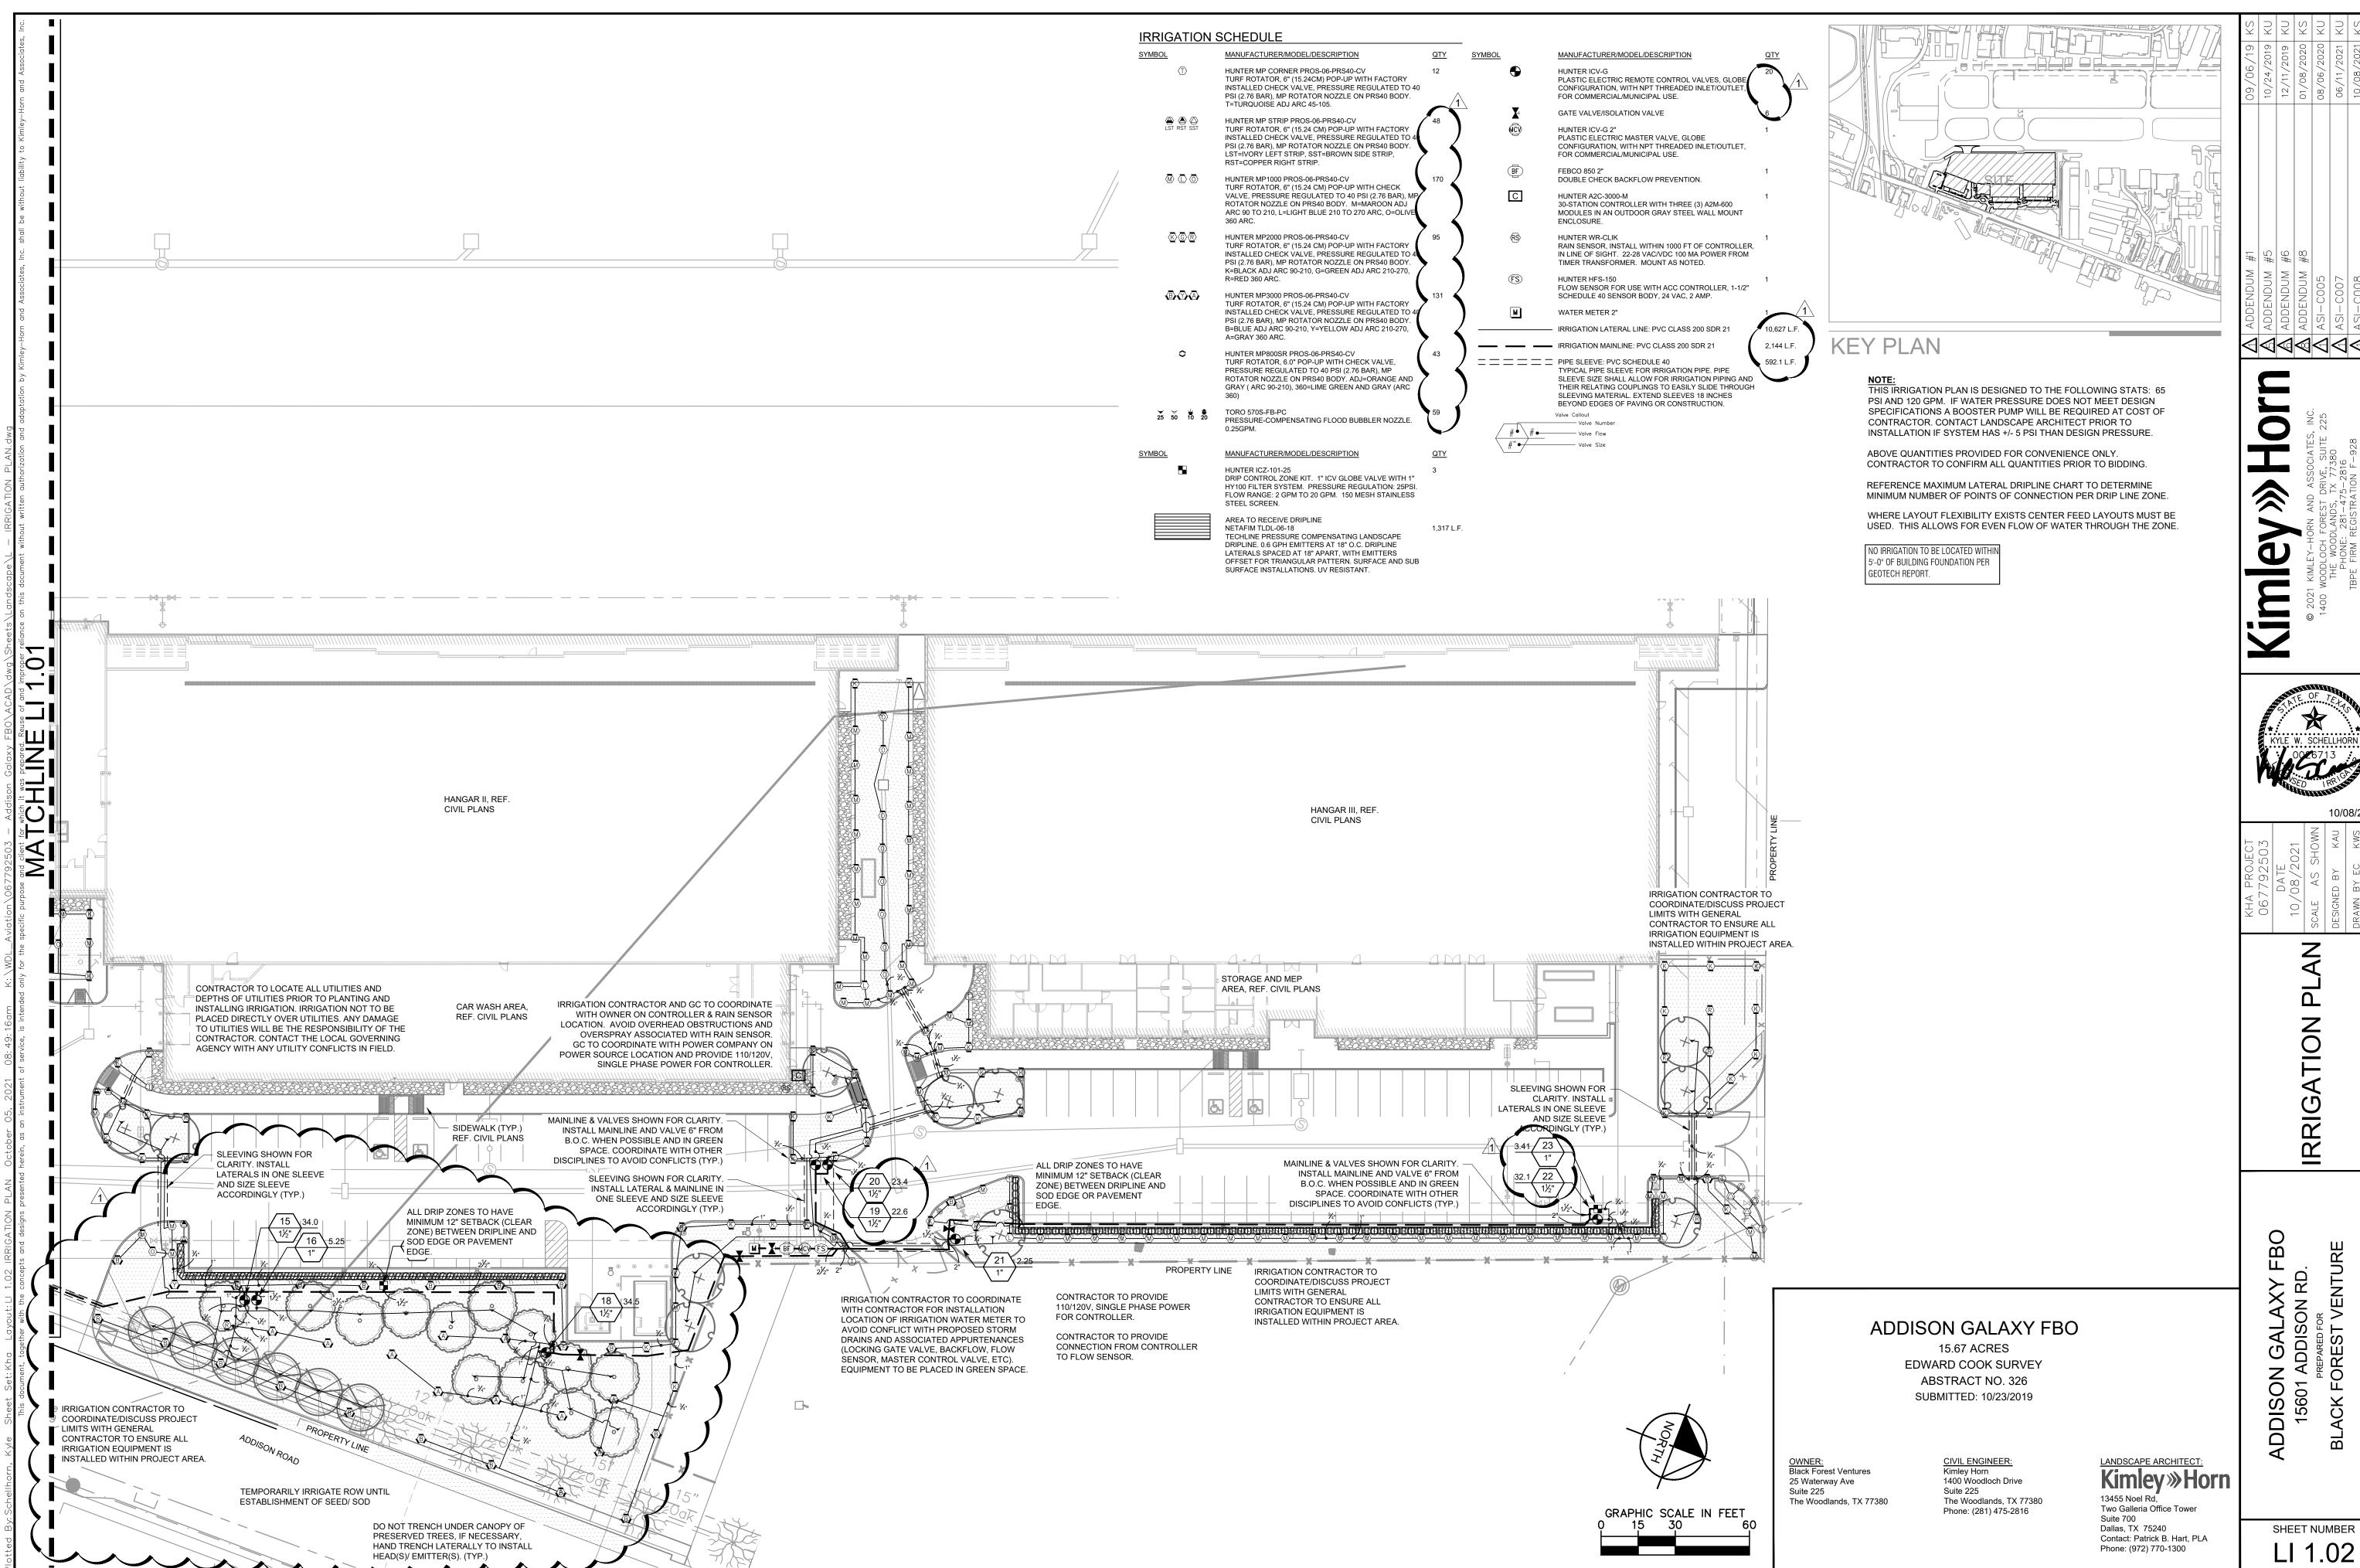

		KHA PROJECT			$ \Delta $ addendum #1		09/06/19 KS
		067792503	K K		ADDENDUM #5		10/24/2019 KU
		DATE	YLE		ADDENDUM #6		12/11/2019 KU
15601 ADDISON RD.			W. S	SOCIATES INC	ADDENDUM #8		01/08/2020 KS
PREPARED FOR		SCALE AS SHOWN		1400 WOODLOCH FOREST DRIVE, SUITE 225	ASI-C005		08/06/2020 KU
BLACK FOREST VENTURE		DESIGNED BY KAU		THE WOODLANDS, TX 77380 PHONE: 281-475-2816	ASI-C007		06/11/2021 KU
		DRAWN BY EC KWS	RN	TBPE FIRM REGISTRATION F-928 WWW.KIMLEY-HORN.COM	ASI-CO08		10/08/2021 KS
ADDISON DALLAS, TEXAS	AS	CHECKED BY KWS			No.	REVISIONS	DATE BY