


Town of Addison, Texas



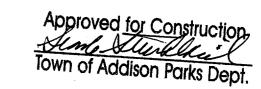

LIST OF DRAWINGS:

LAYOUT AND MATERIALS PLAN

LAYOUT AND MATERIALS PLAN ENLARGEMENT

GRADING PLAN PLANTING PLAN

PLANTING PLAN ENLARGEMENT

IRRIGATION PLAN


DETAILS

DETAILS

EP SITE PLAN ELECTRICAL NOTES





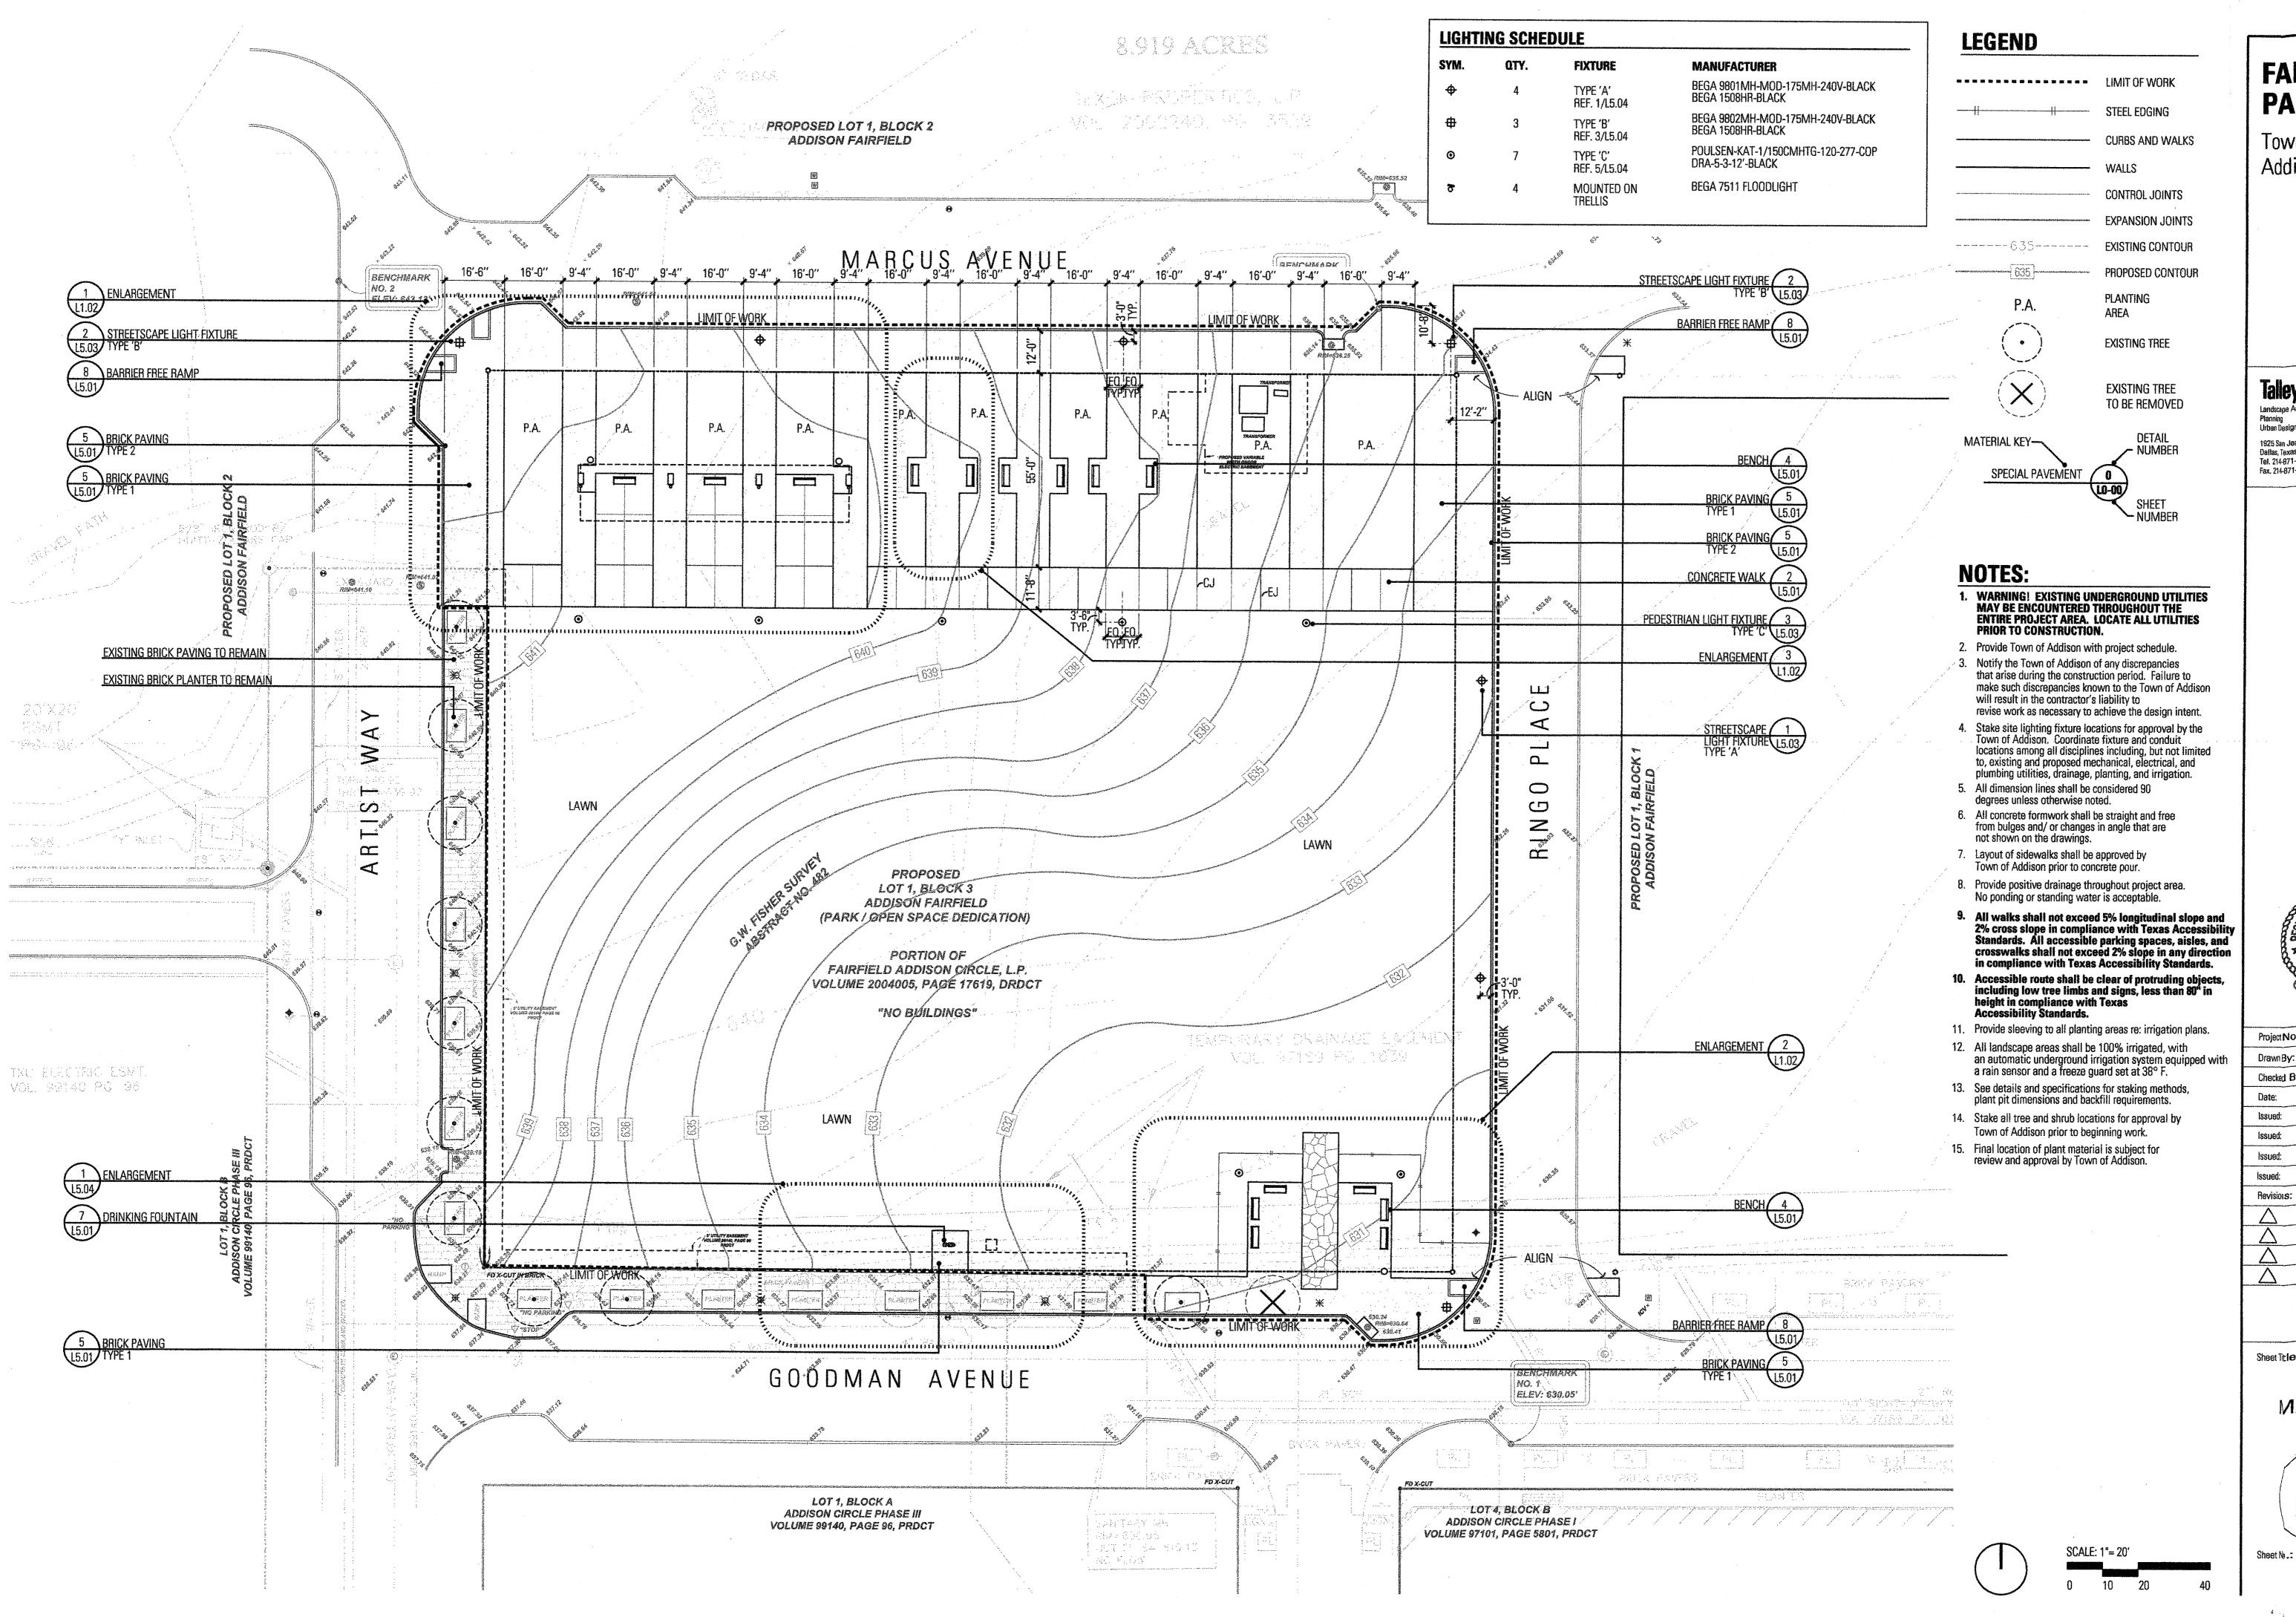

Town of Addison, Texas

TalleyAssociates

Landscape Architecture Urban Design 1925 San Jacinto, Suite 400 Dallas, Texas 75201 Tel. 214-871-7900


Fax. 214-871-7985



Project No. 5034 Drawn By: JW Checked By: CT/KB 5 September 2008 Date: Issued: Issued: Issued: Issued: Revisions:

Sheet Title:

LAYOUT AND MATERIALS PLAN

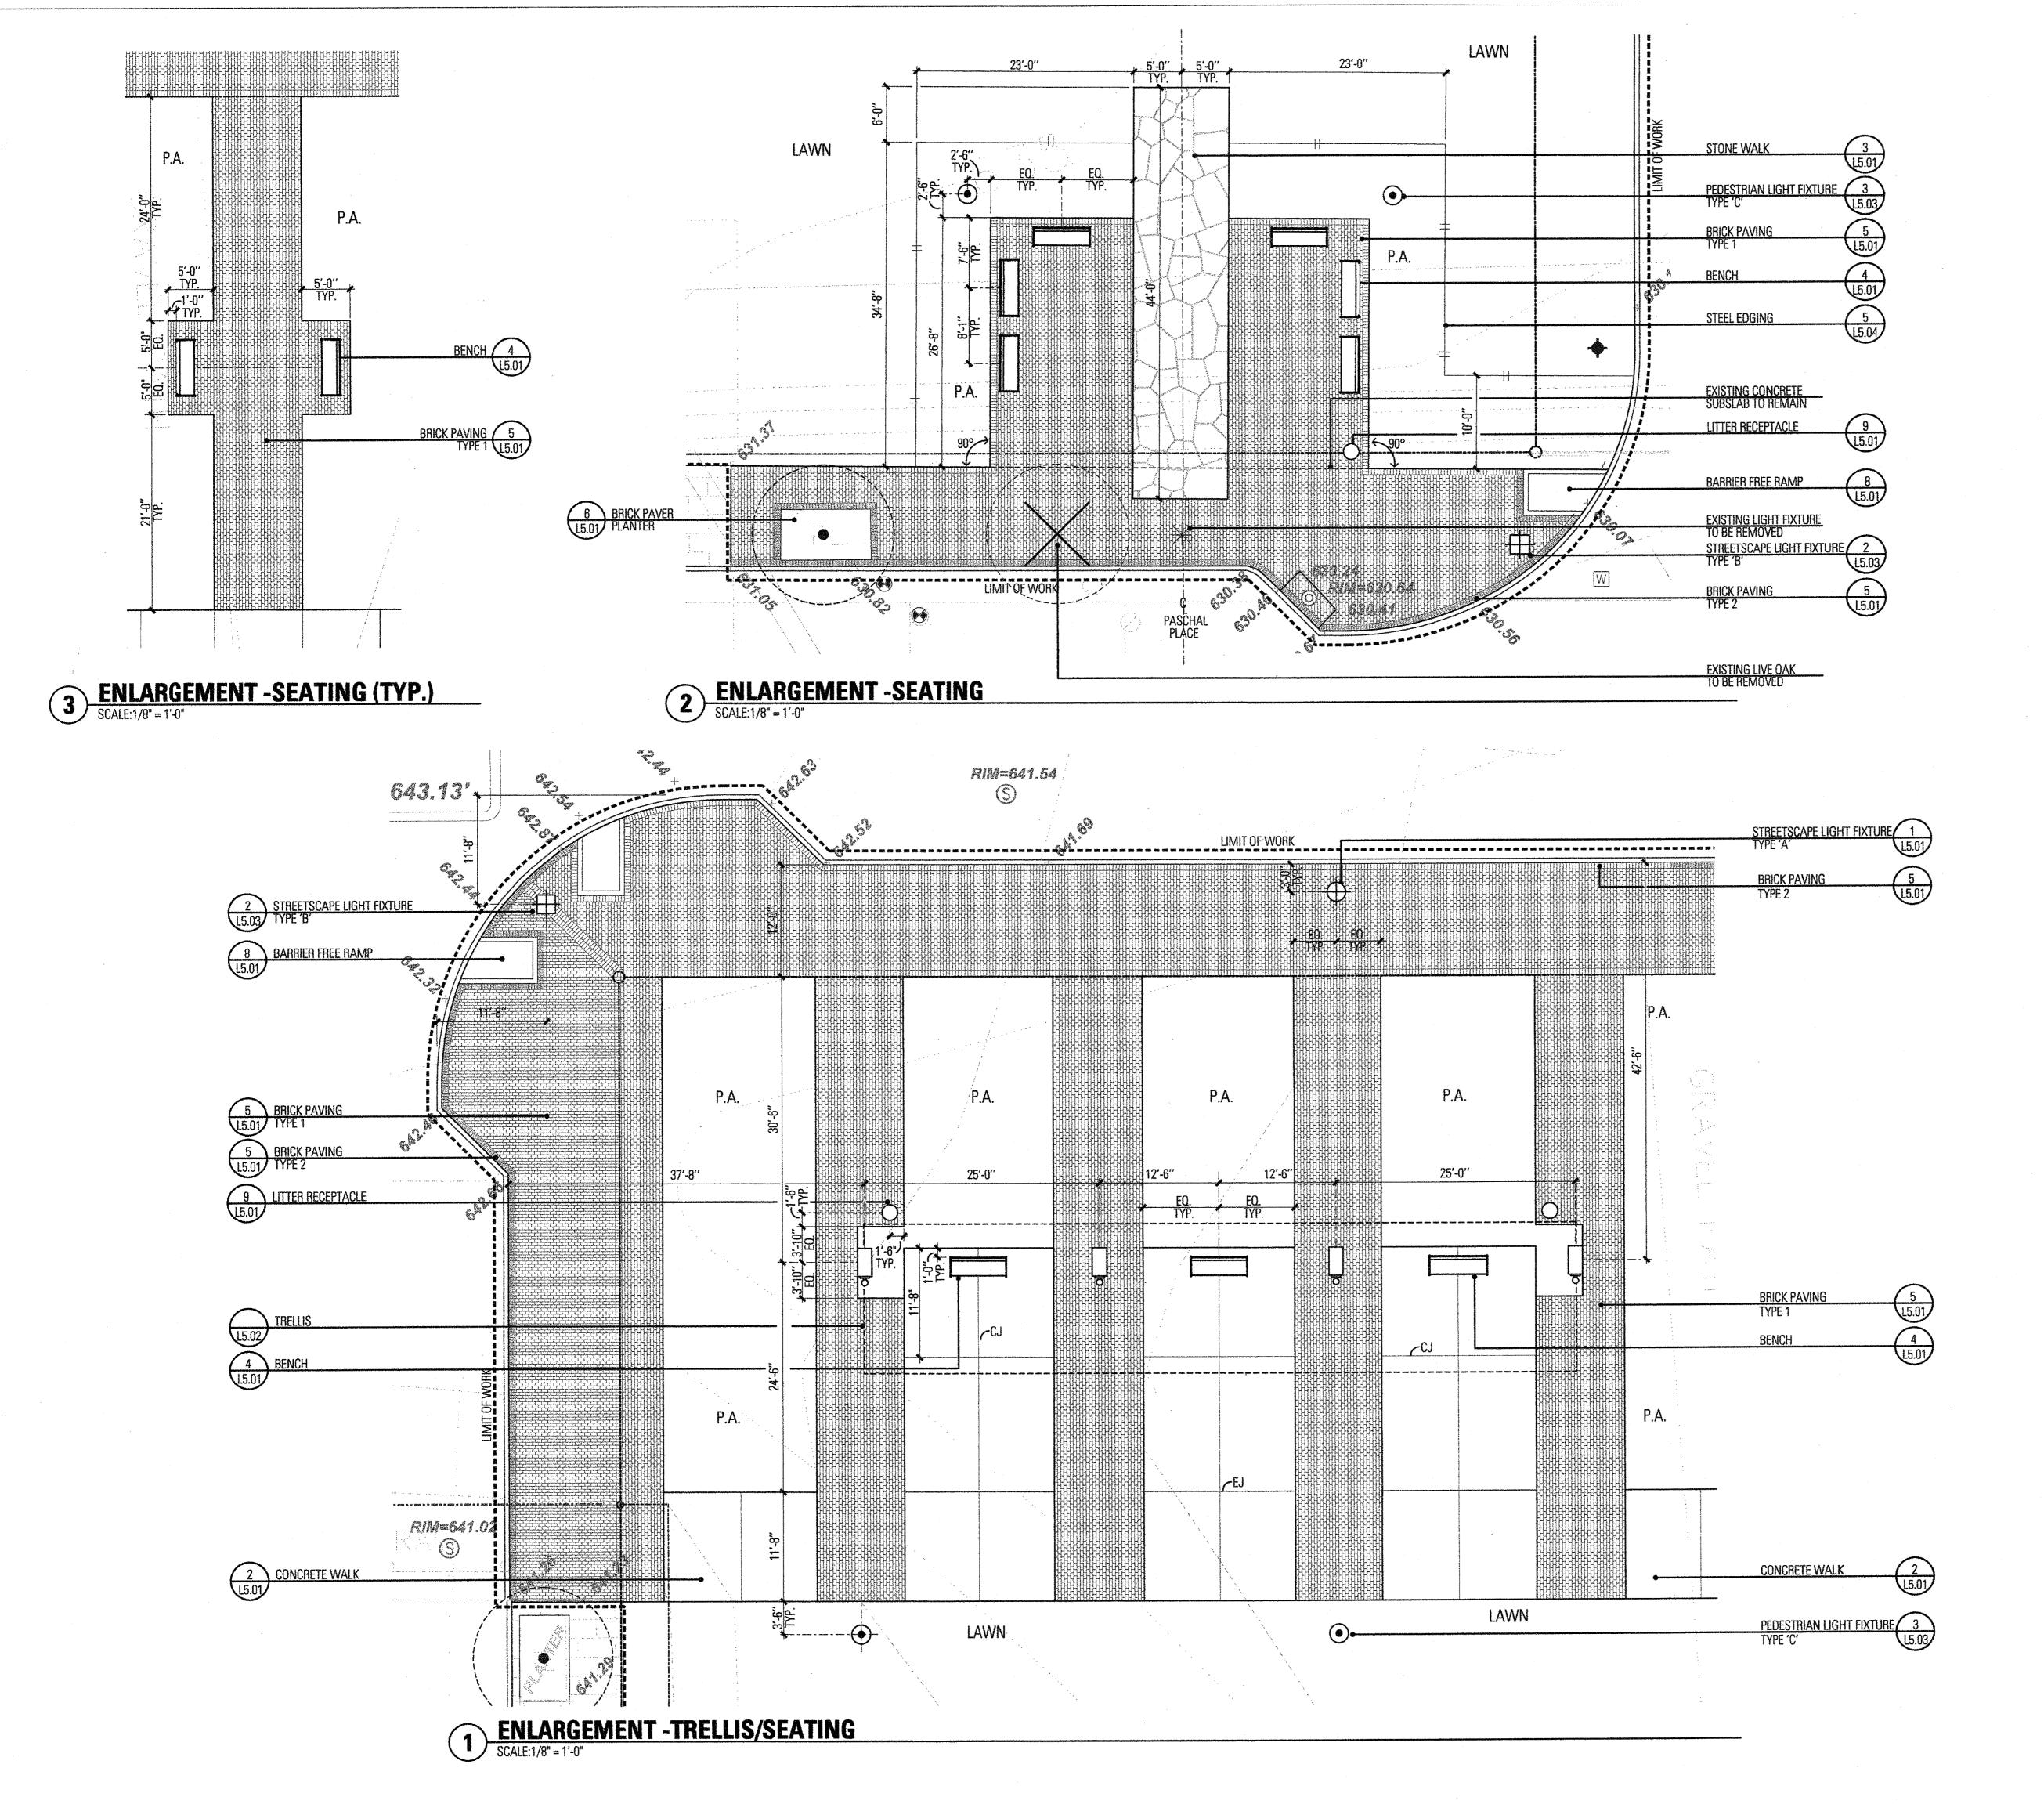

LEGEND

国家中央市场市场市场市场市场	LIMIT OF WORK
	STEEL EDGING
	CURBS AND WALK
	WALLS
	CONTROL JOINTS
- hald-wash deept geory to be a facility to the contract and the contract	EXPANSION JOINTS
635	EXISTING CONTOU
	PROPOSED CONTO
P.A.	PLANTING AREA
	EXISTING TREE
	EXISTING TREE TO BE REMOVED
MATERIAL KEY—	DETAIL NUMBER

NOTES:

- 1. WARNING! EXISTING UNDERGROUND UTILITIES MAY BE ENCOUNTERED THROUGHOUT THE ENTIRE PROJECT AREA. LOCATE ALL UTILITIES PRIOR TO CONSTRUCTION.
- 2. Provide Town of Addison with project schedule.

SPECIAL PAVEMENT

- Notify the Town of Addison of any discrepancies that arise during the construction period. Failure to make such discrepancies known to the Town of Addison will result in the contractor's liability to revise work as necessary to achieve the design intent.
- Stake site lighting fixture locations for approval by the Town of Addison. Coordinate fixture and conduit locations among all disciplines including, but not limited to, existing and proposed mechanical, electrical, and plumbing utilities, drainage, planting, and irrigation.
- All dimension lines shall be considered 90 degrees unless otherwise noted.
- All concrete formwork shall be straight and free from bulges and/ or changes in angle that are not shown on the drawings.
- 7. Layout of sidewalks shall be approved by
- Town of Addison prior to concrete pour.

 8. Provide positive drainage throughout project area.
- No ponding or standing water is acceptable.
- 9. All walks shall not exceed 5% longitudinal slope and 2% cross slope in compliance with Texas Accessibility Standards. All accessible parking spaces, aisles, and crosswalks shall not exceed 2% slope in any direction in compliance with Texas Accessibility Standards.
- in compliance with Texas Accessibility Standards.


 10. Accessible route shall be clear of protruding objects, including low tree limbs and signs, less than 80° in height in compliance with Texas Accessibility Standards.
- 11. Provide sleeving to all planting areas re: irrigation plans.
- All landscape areas shall be 100% irrigated, with an automatic underground irrigation system equipped with a rain sensor and a freeze guard set at 38° F.
- See details and specifications for staking methods, plant pit dimensions and backfill requirements.
- 14. Stake all tree and shrub locations for approval by
- Town of Addison prior to beginning work.
- Final location of plant material is subject for review and approval by Town of Addison.

FAIRFIELD PARK

Town of Addison, Texas

TalleyAssociates

Planning Urban Design 1925 San Jacinto, Suite 400 Dallas, Texas 75201 Tet. 214-871-7900 Fax. 214-871-7985

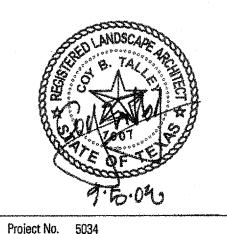



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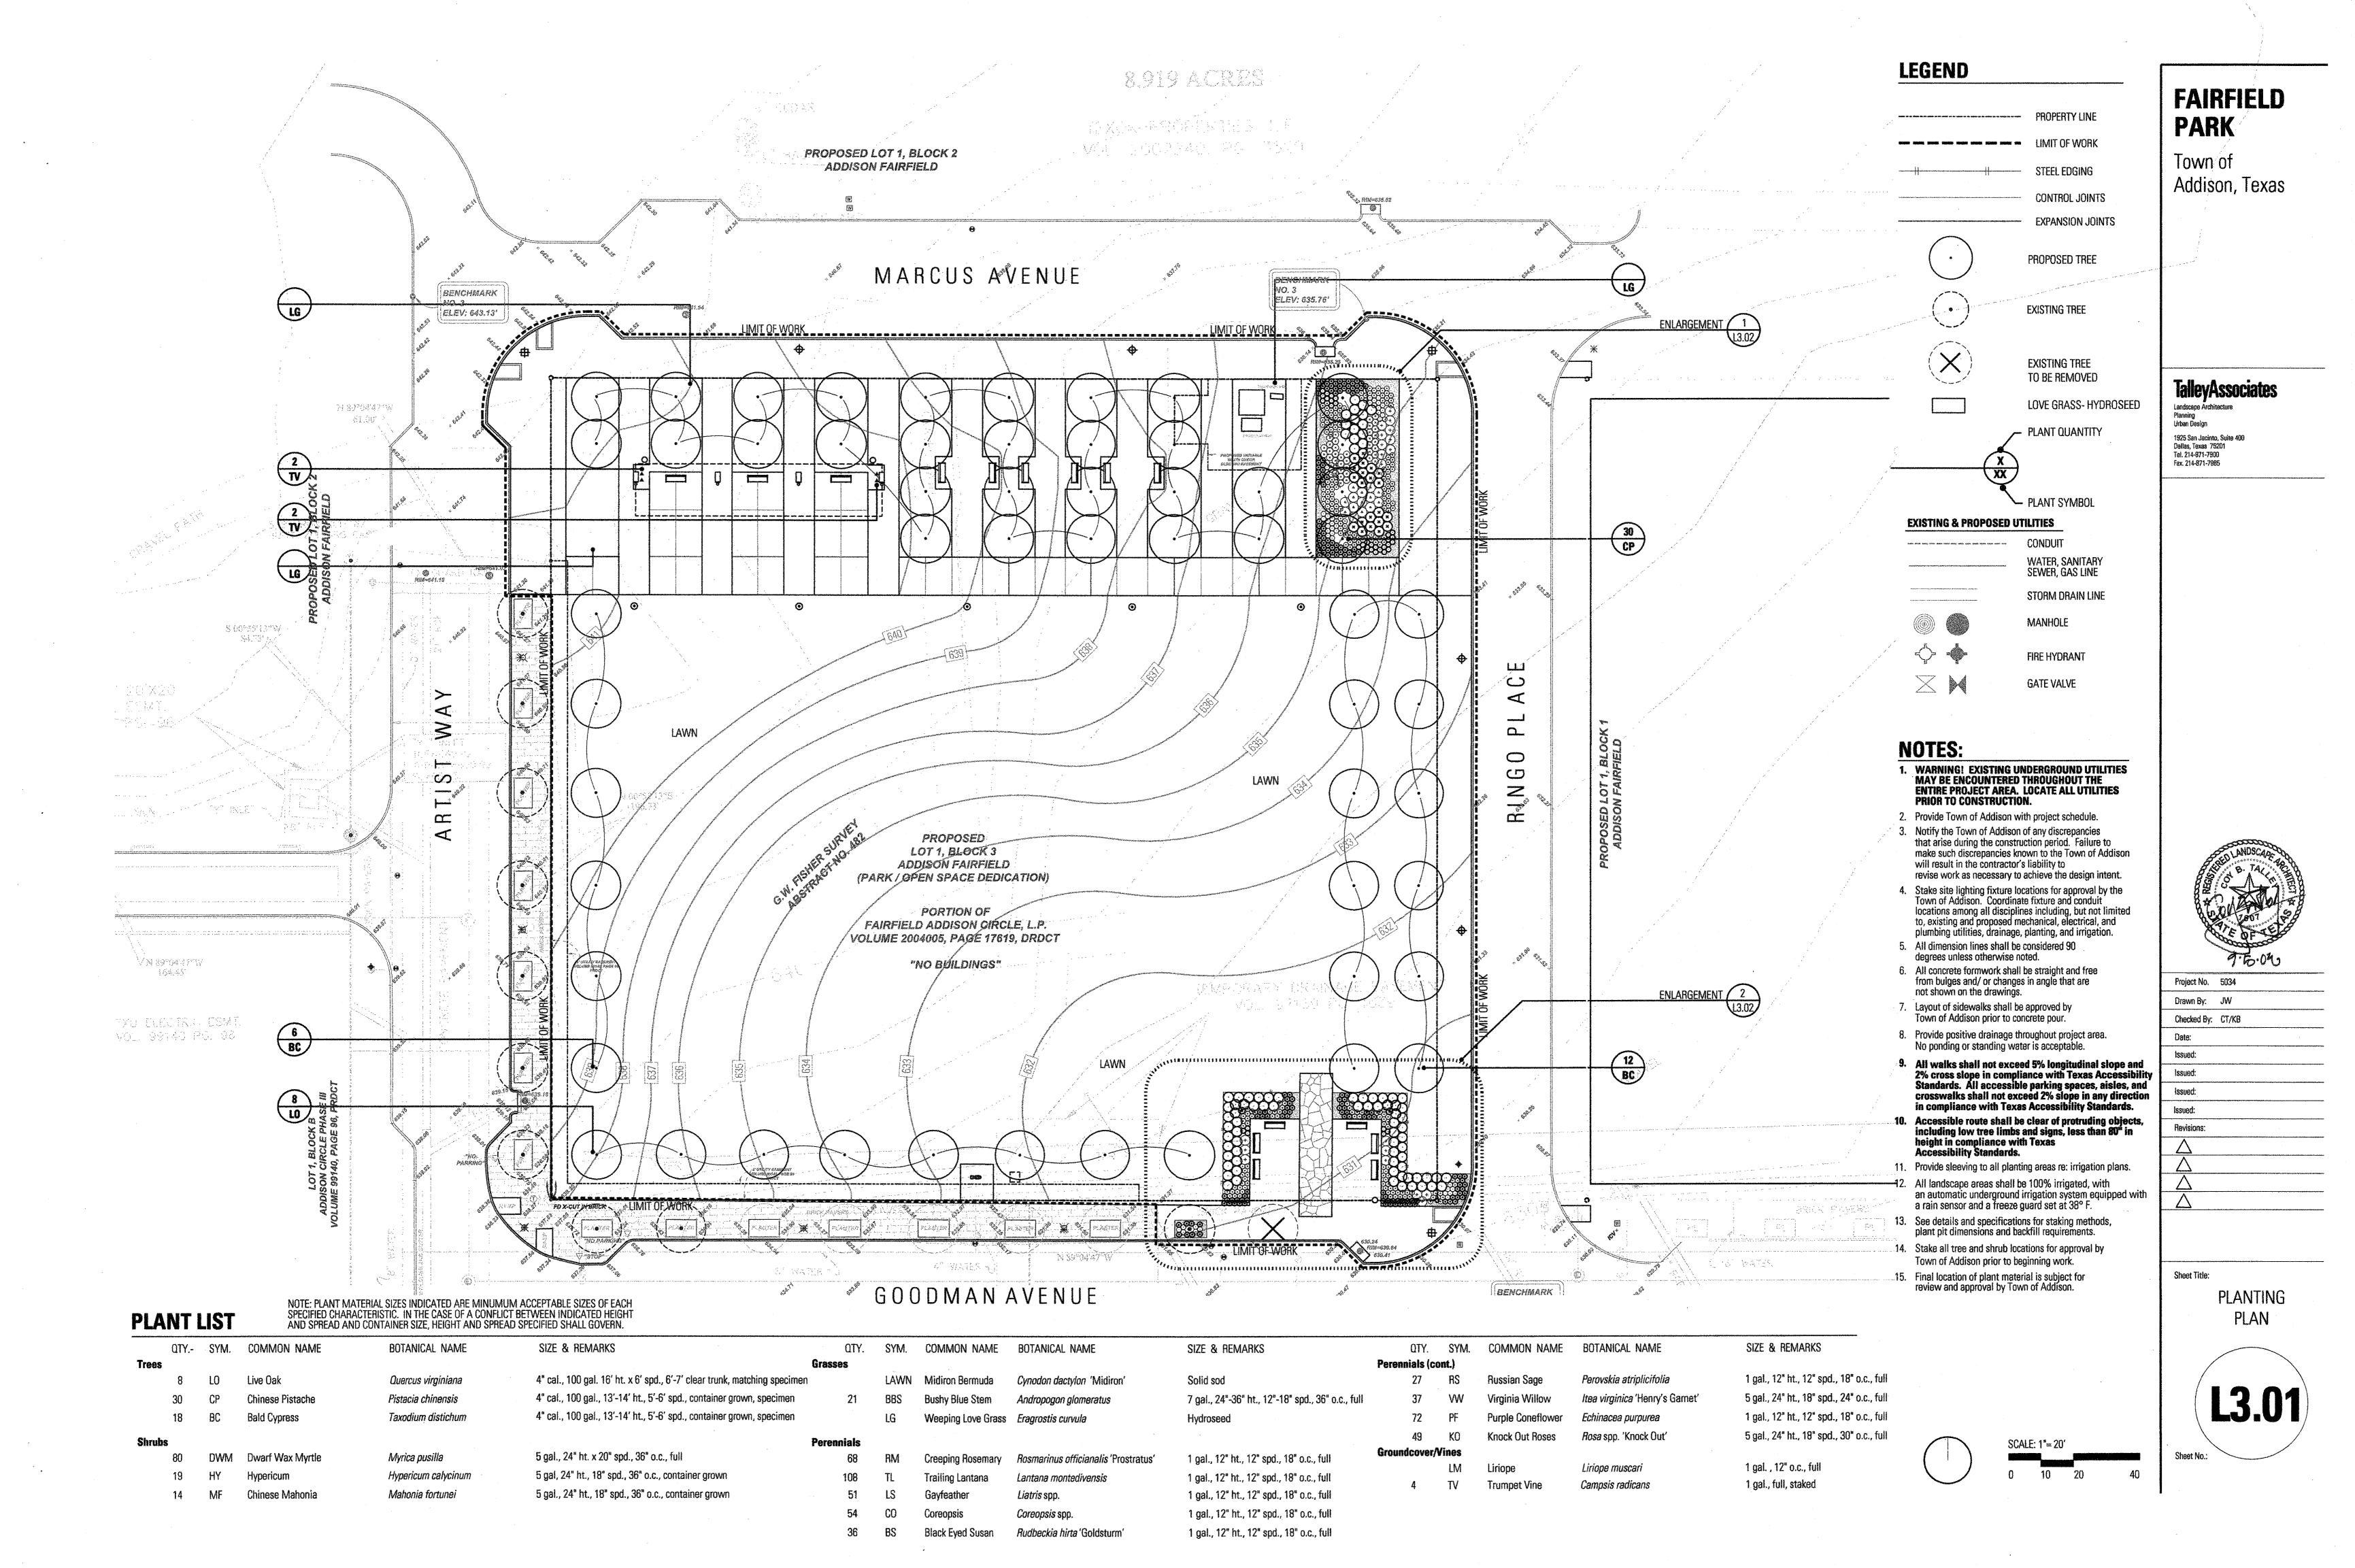
LAYOUT AND MATERIALS PLAN


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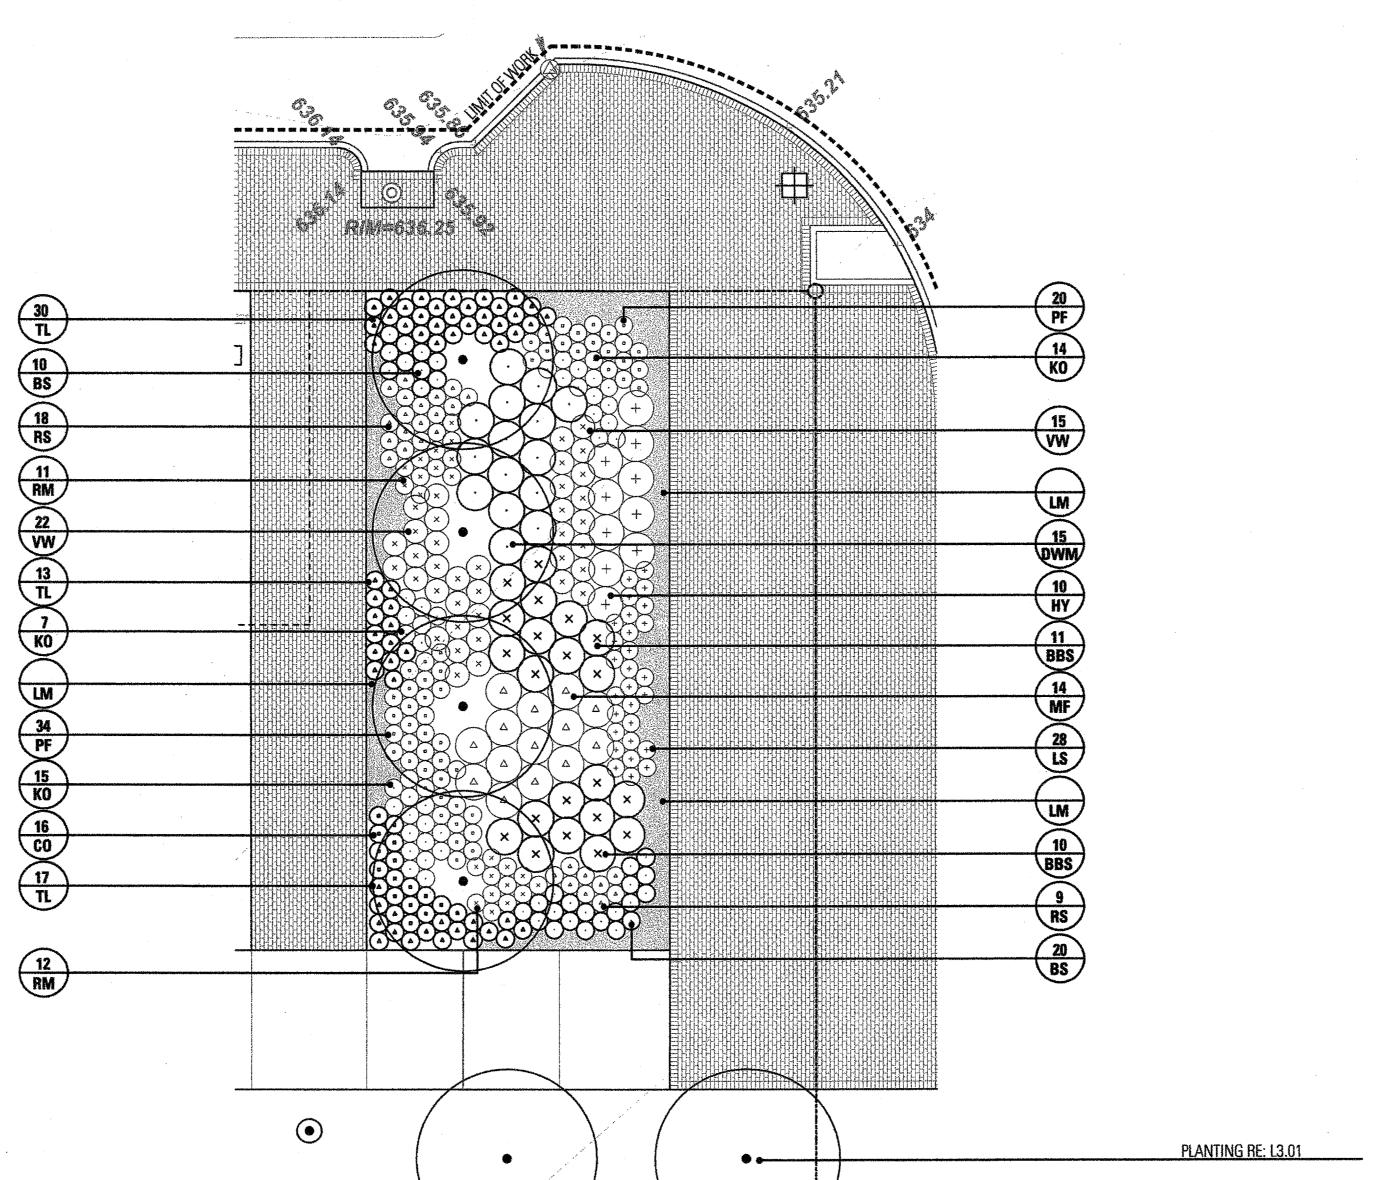






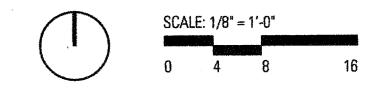

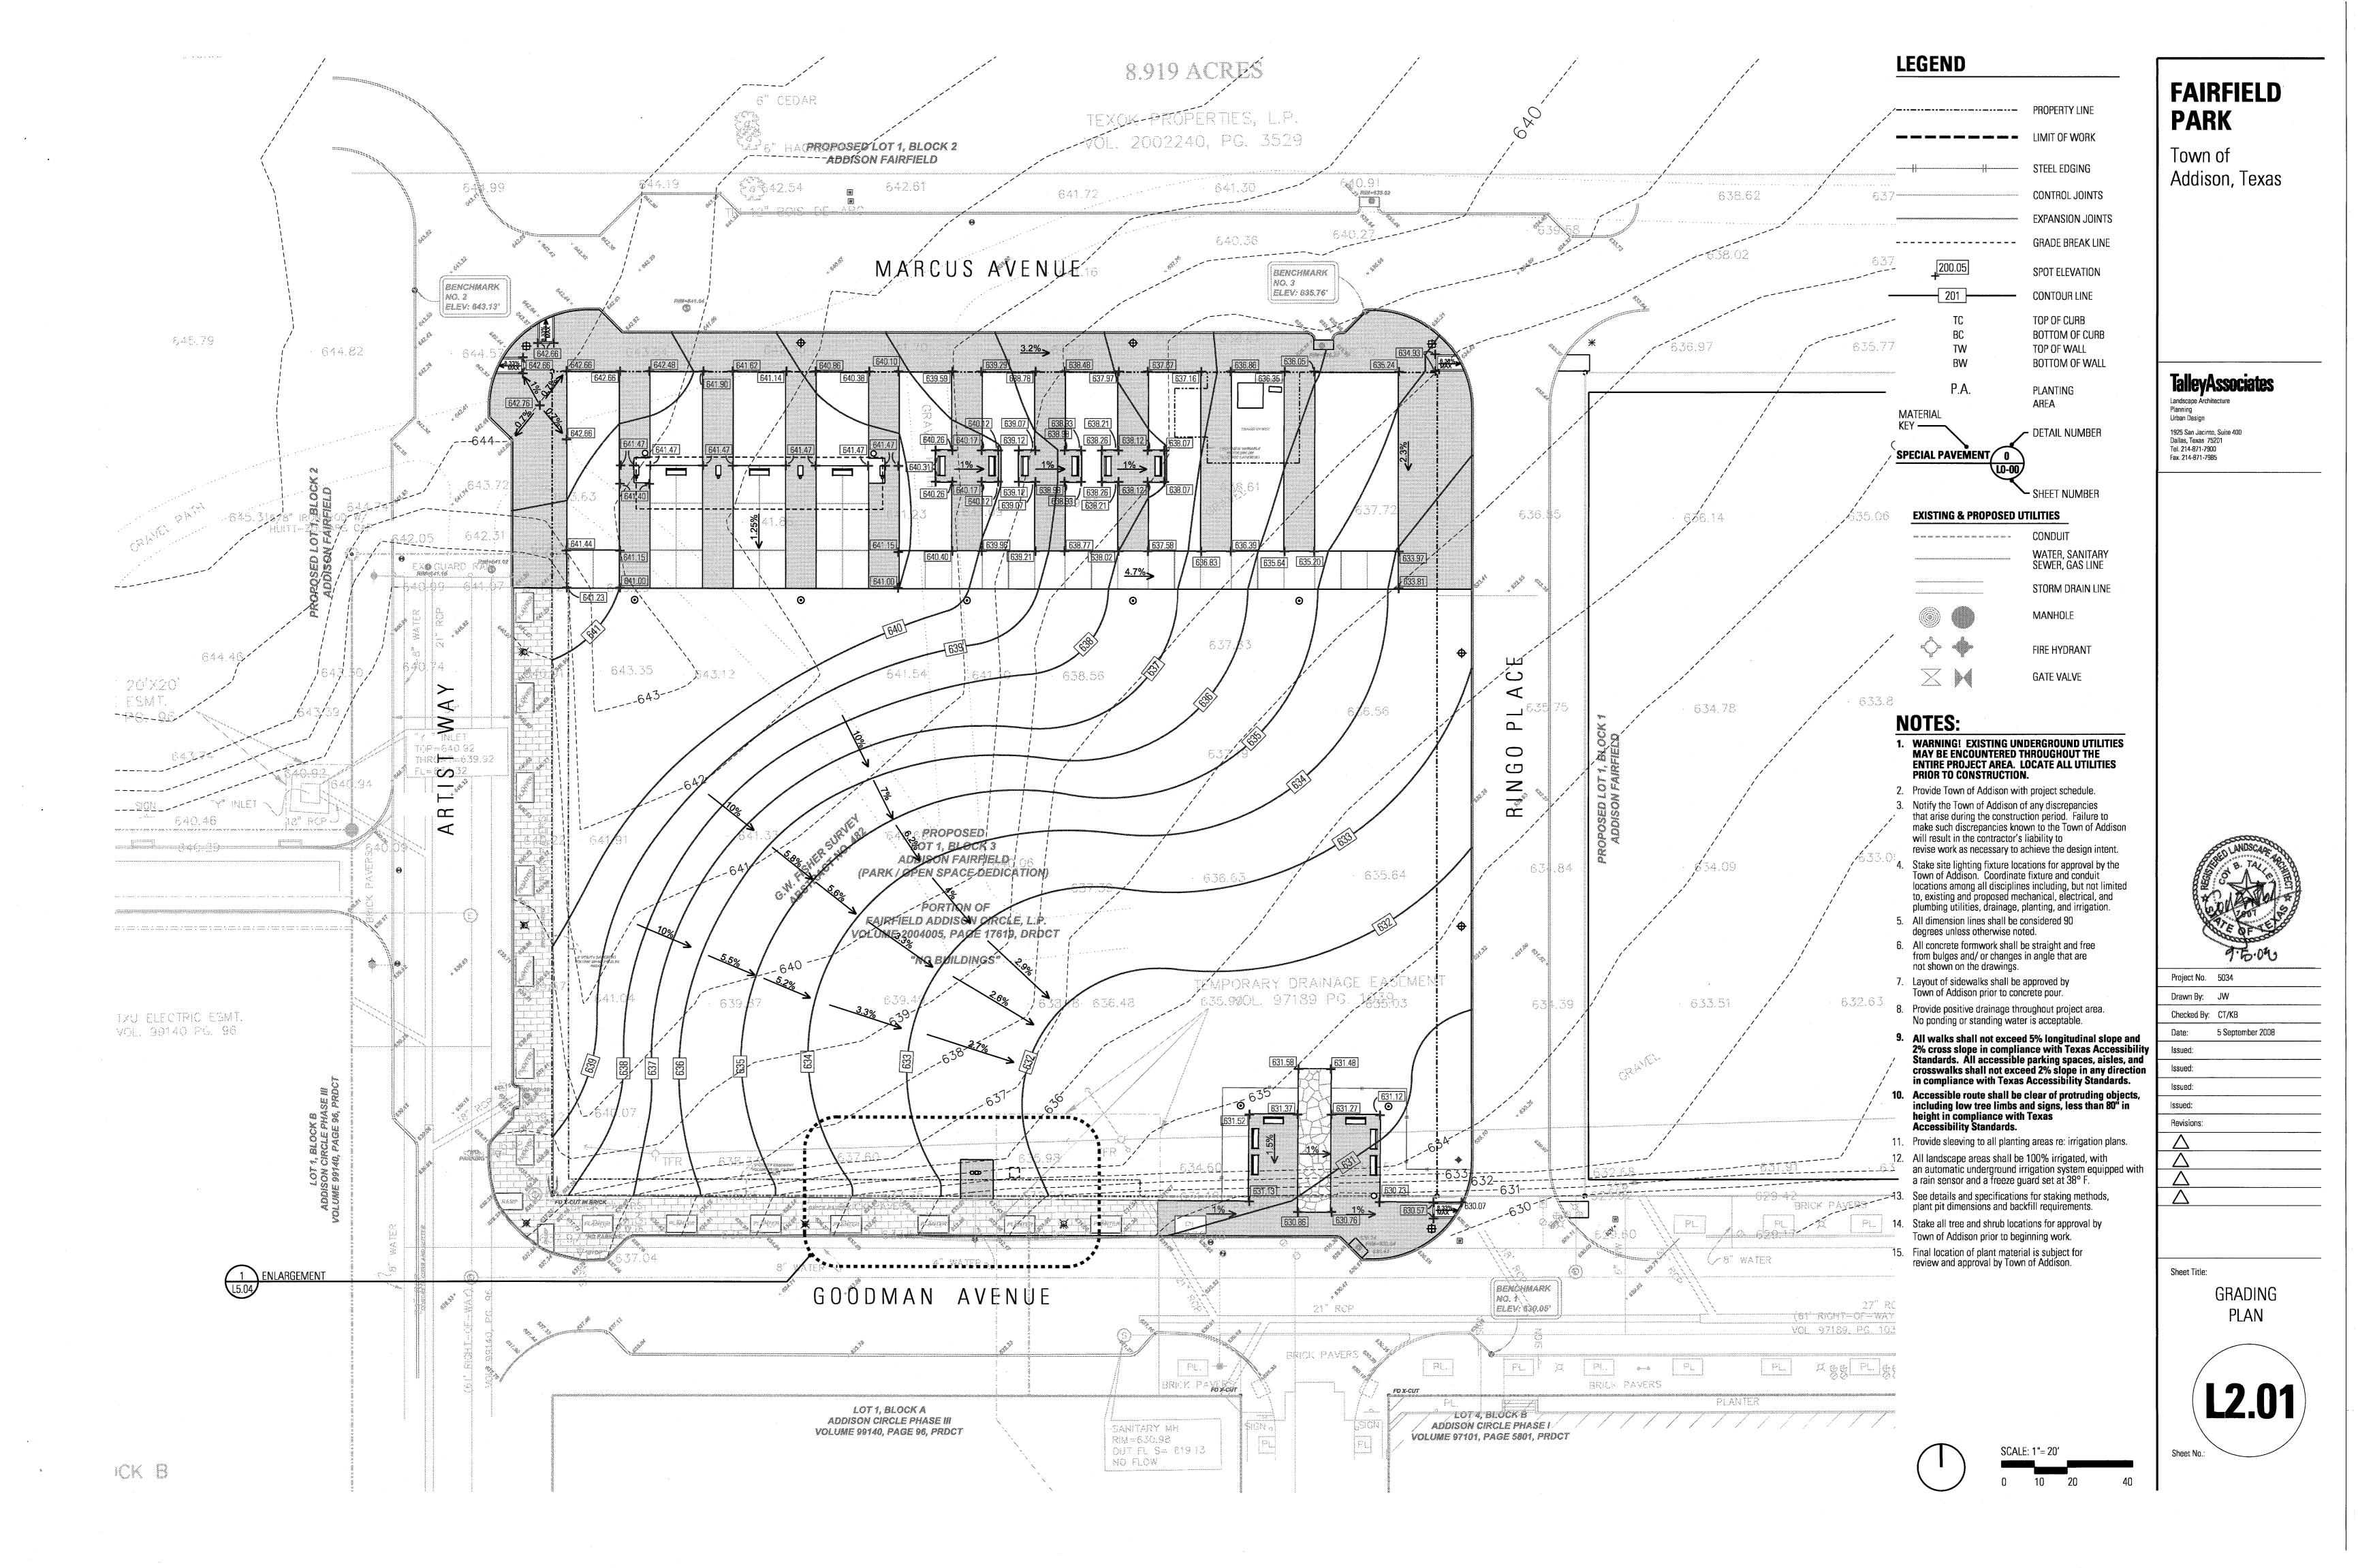

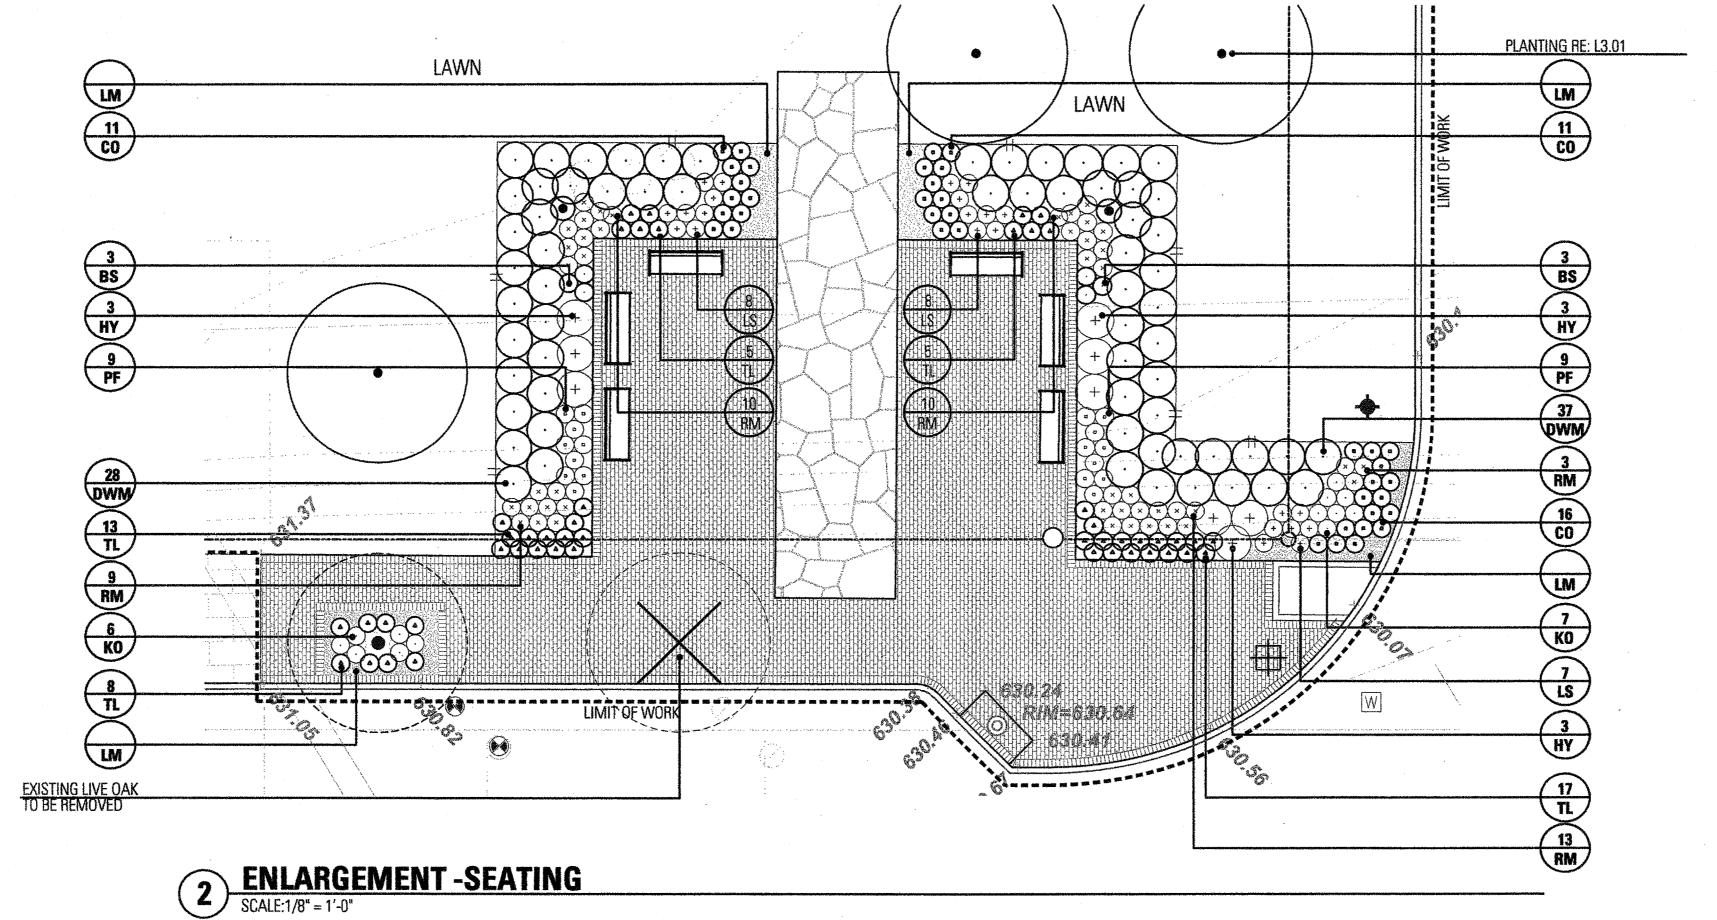

LEGEND FAIRFIELD PARK LIMIT OF WORK Town of STEEL EDGING Addison, Texas CONTROL JOINTS EXPANSION JOINTS PROPOSED TREE **EXISTING TREE EXISTING TREE** TO BE REMOVED **TalleyAssociates** LOVE GRASS- HYDROSEEI 1925 San Jacinto, Suite 400 Dalfas, Texas 75201 Tef. 214-971-7900 Fax. 214-871-7985 - PLANT SYMBOL **EXISTING & PROPOSED UTILITIES** CONDUIT WATER, SANITARY SEWER, GAS LINE STORM DRAIN LINE MANHOLE FIRE HYDRANT **GATE VALVE NOTES:** 1. WARNING! EXISTING UNDERGROUND UTILITIES MAY BE ENCOUNTERED THROUGHOUT THE ENTIRE PROJECT AREA. LOCATE ALL UTILITIES PRIOR TO CONSTRUCTION. Provide Town of Addison with project schedule. 3. Notify the Town of Addison of any discrepancies that arise during the construction period. Failure to make such discrepancies known to the Town of Addison will result in the contractor's liability to revise work as necessary to achieve the design intent. 4. Stake site lighting fixture locations for approval by the Town of Addison. Coordinate fixture and conduit locations among all disciplines including, but not limited to, existing and proposed mechanical, electrical, and plumbing utilities, drainage, planting, and irrigation. 5. All dimension lines shall be considered 90 degrees unless otherwise noted. All concrete formwork shall be straight and free from bulges and/ or changes in angle that are not shown on the drawings. Project No. 5034 Drawn By: JW 7. Layout of sidewalks shall be approved by Town of Addison prior to concrete pour. Checked By: CT/KB 8. Provide positive drainage throughout project area. Date: 5 September 2008 No ponding or standing water is acceptable. issued: 9. All walks shall not exceed 5% longitudinal slope and 2% cross slope in compliance with Texas Accessibility Standards. All accessible parking spaces, aisles, and crosswalks shall not exceed 2% slope in any direction in compliance with Texas Accessibility Standards. issued: Issued: Accessible route shall be clear of protruding objects, including low tree limbs and signs, less than 80" in height in compliance with Texas Accessibility Standards. Revisions: 11. Provide sleeving to all planting areas re: irrigation plans. 12. All landscape areas shall be 100% irrigated, with an automatic underground irrigation system equipped with a rain sensor and a freeze guard set at 38° F. See details and specifications for staking methods, plant pit dimensions and backfill requirements. 14. Stake all tree and shrub locations for approval by Town of Addison prior to beginning work. Final location of plant material is subject for review and approval by Town of Addison. Sheet Title: PLANTING

PLAN


1 ENLARGEMENT - SCALE:1/8" = 1'-0"

INSTALLATION NOTES

- COORDINATE IRRIGATION INSTALLATION WITH PLANTING PLAN AND SITE CONDITIONS TO PROVIDE COMPLETE COVERAGE WITH MINIMUM OVERSPRAY. THE IRRIGATION CONTRACTOR SHALL MAKE MINOR ADJUSTMENTS TO ENSURE PROPER COVERAGE AT NO ADDITIONAL COST
- 2. CONFIRM STATIC WATER PRESSURE OF 60 PSI AT LEAST 7 DAYS BEFORE BEGINNING WORK. STATIC WATER PRESSURE IS LESS THAN STATED ABOVE, DO NOT PROCEED UNTIL DIRECTED SO BY THE LANDSCAPE ARCH.
- 3. THE IRRIGATION CONTRACTOR WILL SECURE ALL REQUIRED PERMITS AND PAY ALL ASSOCIATED FEES UNLESS OTHERWISE NOTED. ALL LOCAL CODES SHALL PREVAIL OVER ANY DISCREPANCIES HEREIN.
- 4. LATERAL PIPE SHALL BE INSTALLED AT A MINIMUM DEPTH OF 12 INCHES. MAINLINE PIPE AND WIRES SHALL BE INSTALLED AT A MINIMUM DEPTH OF 16 INCHES
- 5. UNSLEEVED PIPES MAY BE SHOWN UNDER PAVEMENT FOR GRAPHIC CLARITY ONLY. INSTALL THESE PIPES IN ADJACENT LANDSCAPED AREAS.
- 6. ALL VALVE WIRE CONNECTIONS MUST BE SPLICED WITH A TAN COLORED KING ONE STEP CONNECTOR. ALL VALVE BOX SPLICES ARE TO BE HOUSED IN A LARGE RECTANGULAR ARMOR VALVE BOX.
- SINGLE CONDUCTOR "IRRIGATION WIRE". ALL FIELD WIRE SPLICES SHALL BE ENCASED IN A DBY CONNECTOR. ALL FIELD SPLICES SHALL BE LOCATED IN A ROUND ARMOR VALVE BOX OF SUFFICIENT SIZE TO ALLOW INSPECTION. 8. VALVE BOXES SHALL BE INSTALLED FLUSH WITH GRADE, SUPPORTED BY BRICKS IF NEEDED, WITH 3-4 INCHES OF CLEAN PEA GRAVEL LOCATED BELOW THE VALVE. USE ARMOR 12"
- 9. USE LASCO SWING JOINTS FOR ALL QUICK COUPLER CONNECTIONS.
- 10. ALL SPRAY HEADS SHALL BE CONNECTED WITH A 6" X 1/2" POLYETHYLENE GREEN NIPPLE. ALL ROTOR HEADS SHALL BE CONNECTED WITH A 6" X 3/4" POLYETHYLENE GREEN NIPPLE.
- 11. PROVIDE THREE BUCKNER V075 QUICK COUPLER KEYS WITH HOSE-END SWIVELS.
- 12. CONTRACTOR IS TO CONTACT APPROPRIATE AUTHORITIES AND LOCATE ALL UTILITIES PRIOR TO CONSTRUCTION
- GRID TRUNK LINES SHALL BE RIGID CLASS 200 PVC PIPE, BURIED TO A DEPTH OF 10". DRIPPER LINES SHALL BE INSTALLED IN CENTER FED GRIDS, IN ROWS SPACED 12" APART, AT GRADE. MANUAL FLUSH VALVE, NETAFIM #TLSOV SHALL BE INSTALLED AT FARTHEST POINTS FROM ZONE VALVE. MAXIMUM SINGLE DRIP TUBE RUN SHALL NOT EXCEED 150 LINEAR FEET. USE NETAFIM 17 MM BARBED FITTINGS FOR DRIPPER LINE CONNECTIONS. SET VALVE REGULATORS TO MAX. 30 PSI. TECHLINE CV SHALL BE INSTALLED PERPENDICULAR TO SLOPE FACE. INSTALL TLCV IN-LINE CHECK VALVES FOR EVERY 4.5 FEET OF DRIP LINE ELEVATION CHANGE WITHIN THE ZONE. NETAFIM STAPLES (#TLS6) SHALL BE INSTALLED EVERY 4 LINEAR FEET OF DRIP TUBE. THE CONTRACTOR SHALL CONTACT NETAFIM REPRESENTATIVE MR. DAVID HAMMOND 888.638.2346, AND SCHEDULE PRE-CONSTRUCTION TRAINING ON CORRECT INSTALLATION PROCEEDURES FOR SUB-SURFACE DRIP EQUIPMENT.

LEGEND

- RAINBIRD #1804-PRS POP UP SPRAY HEAD WITH HUNTER PCN-25
- PRESSURE COMPENSATING BUBBLER NOZZLE. RAINBIRD #1804-PRS POP UP SPRAY HEAD WITH HUNTER PCN-50
- PRESSURE COMPENSATING BUBBLER NOZZLE. RAINBIRD #1804-PRS POP UP SPRAY HEAD WITH RAINBIRD NOZZLES
- HUNTER I-20 4" POP UP ROTARY HEAD, PART CIRCLE, #4 NOZZLE
- HUNTER I-20 4" POP UP ROTARY HEAD, FULL CIRCLE, #8 NOZZLE NETAFIM DRIP TUBE INSTALLED AS DETAILED. SEE INSTALLATION NOTE #13.
- IRRITROL 200B SERIES ELECTRIC REMOTE CONTROL VALVE, WITH SPEARS BALL VALVE IRRITROL 200B SERIES ELECTRIC REMOTE CONTROL VALVE, WITH SPEARS BALL VALVE, FOR DRIP ZONES. NETAFIM TECHFILTER #TF075412-100CV SERIES
- SEE INSTALLATION NOTE #13 REGARDING SUBSURFACE IRRIGATION LAYOUT IRRITROL 200B SERIES ELECTRIC REMOTE CONTROL "TREE BUBBLER" VALVE, WITH SPEARS BALL VALVE
- 2" IRRITROL 200 B SERIES MASTER VALVE INSTALLED WITH BLUE WIRE FOR STATION WIRING, AND 2" DATA INDUSTRIAL FLOW METER INSTALLED WITH RAIN MASTER EV-CAB-SEN FLOW METER CABLE, INSTALLED IN 3/4" GRAY PVC CONDUIT WITH 6" OR LARGER J-BOXES PLACED EVERY 200 FEET OR WHERE 360 DEGREES OF FITTING ARE INSTALLED: ONLY SWEEP FITTINGS ARE PERMITTED INSTALL WITHOUT SPLICES.
- BUCKNER V075 3/4" SINGLE LUG QUICK COUPLING VALVE WITH METAL TOP SPEARS BALL VALVE WITH POSITIVE T-HANDLE, SAME SIZE AS PIPE
- WATTS 007 M SERIES D.C.A. INSTALLED PER CITY CODE, SIZE NOTED ON PLAN
 - 1 1/2" IRRIGATION WATER METER AND TAP
- CLASS 200 BELLED PVC MAINLINE PIPE CLASS 200 BELLED (EXCEPT 1/2 INCH #315) PVC LATERAL PIPE 4" CLASS 200 SLEEVE PIPES, BELLED END, UNLESS NOTED OTHERWISE
- L.I.C. SHALL SELECT MPR SERIES SPRAY NOZZLES FOR "HEAD-TO-HEAD" COVERAGE, ADJUSTED FOR MINIMUM OVERSPRAY ONTO WALLS AND WALKS. NO OVERSPRAY INTO STREETS IS PERMITTED.

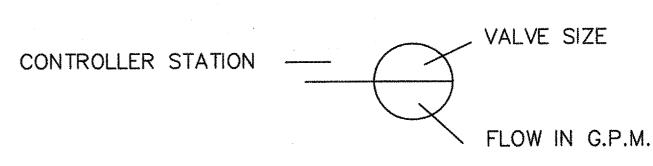



TEXAS L.I.C. #658 100 W. OAK ST., SUITE 101 DENTON, TEXAS 76201

09 / 05 / 08

PHONE: 940.243.2364 FAX: 940.382.2475



FAIRFIELD PARK

Addison, Texas

Town of

TalleyAssociates

Planning Urban Design 1925 San Jacinto, Suite 400 Dalfas, Texas 75201 Tel. 214-871-7900 Fax. 214-871-7985

Project No. 5034 Drawn By: JW Checked By: CT/KB Date: 5 September 2008 Issued: issued: Issued: Revisions:


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L4.01

Sheet No.

PLAN


* L.I.C. IS TO VISIT SITE PRIOR TO CONSTRUCTION TO BECOME FAMILIAR WITH THE EXISTING SITE CONDITIONS PRIOR TO CONSTRUCTION.

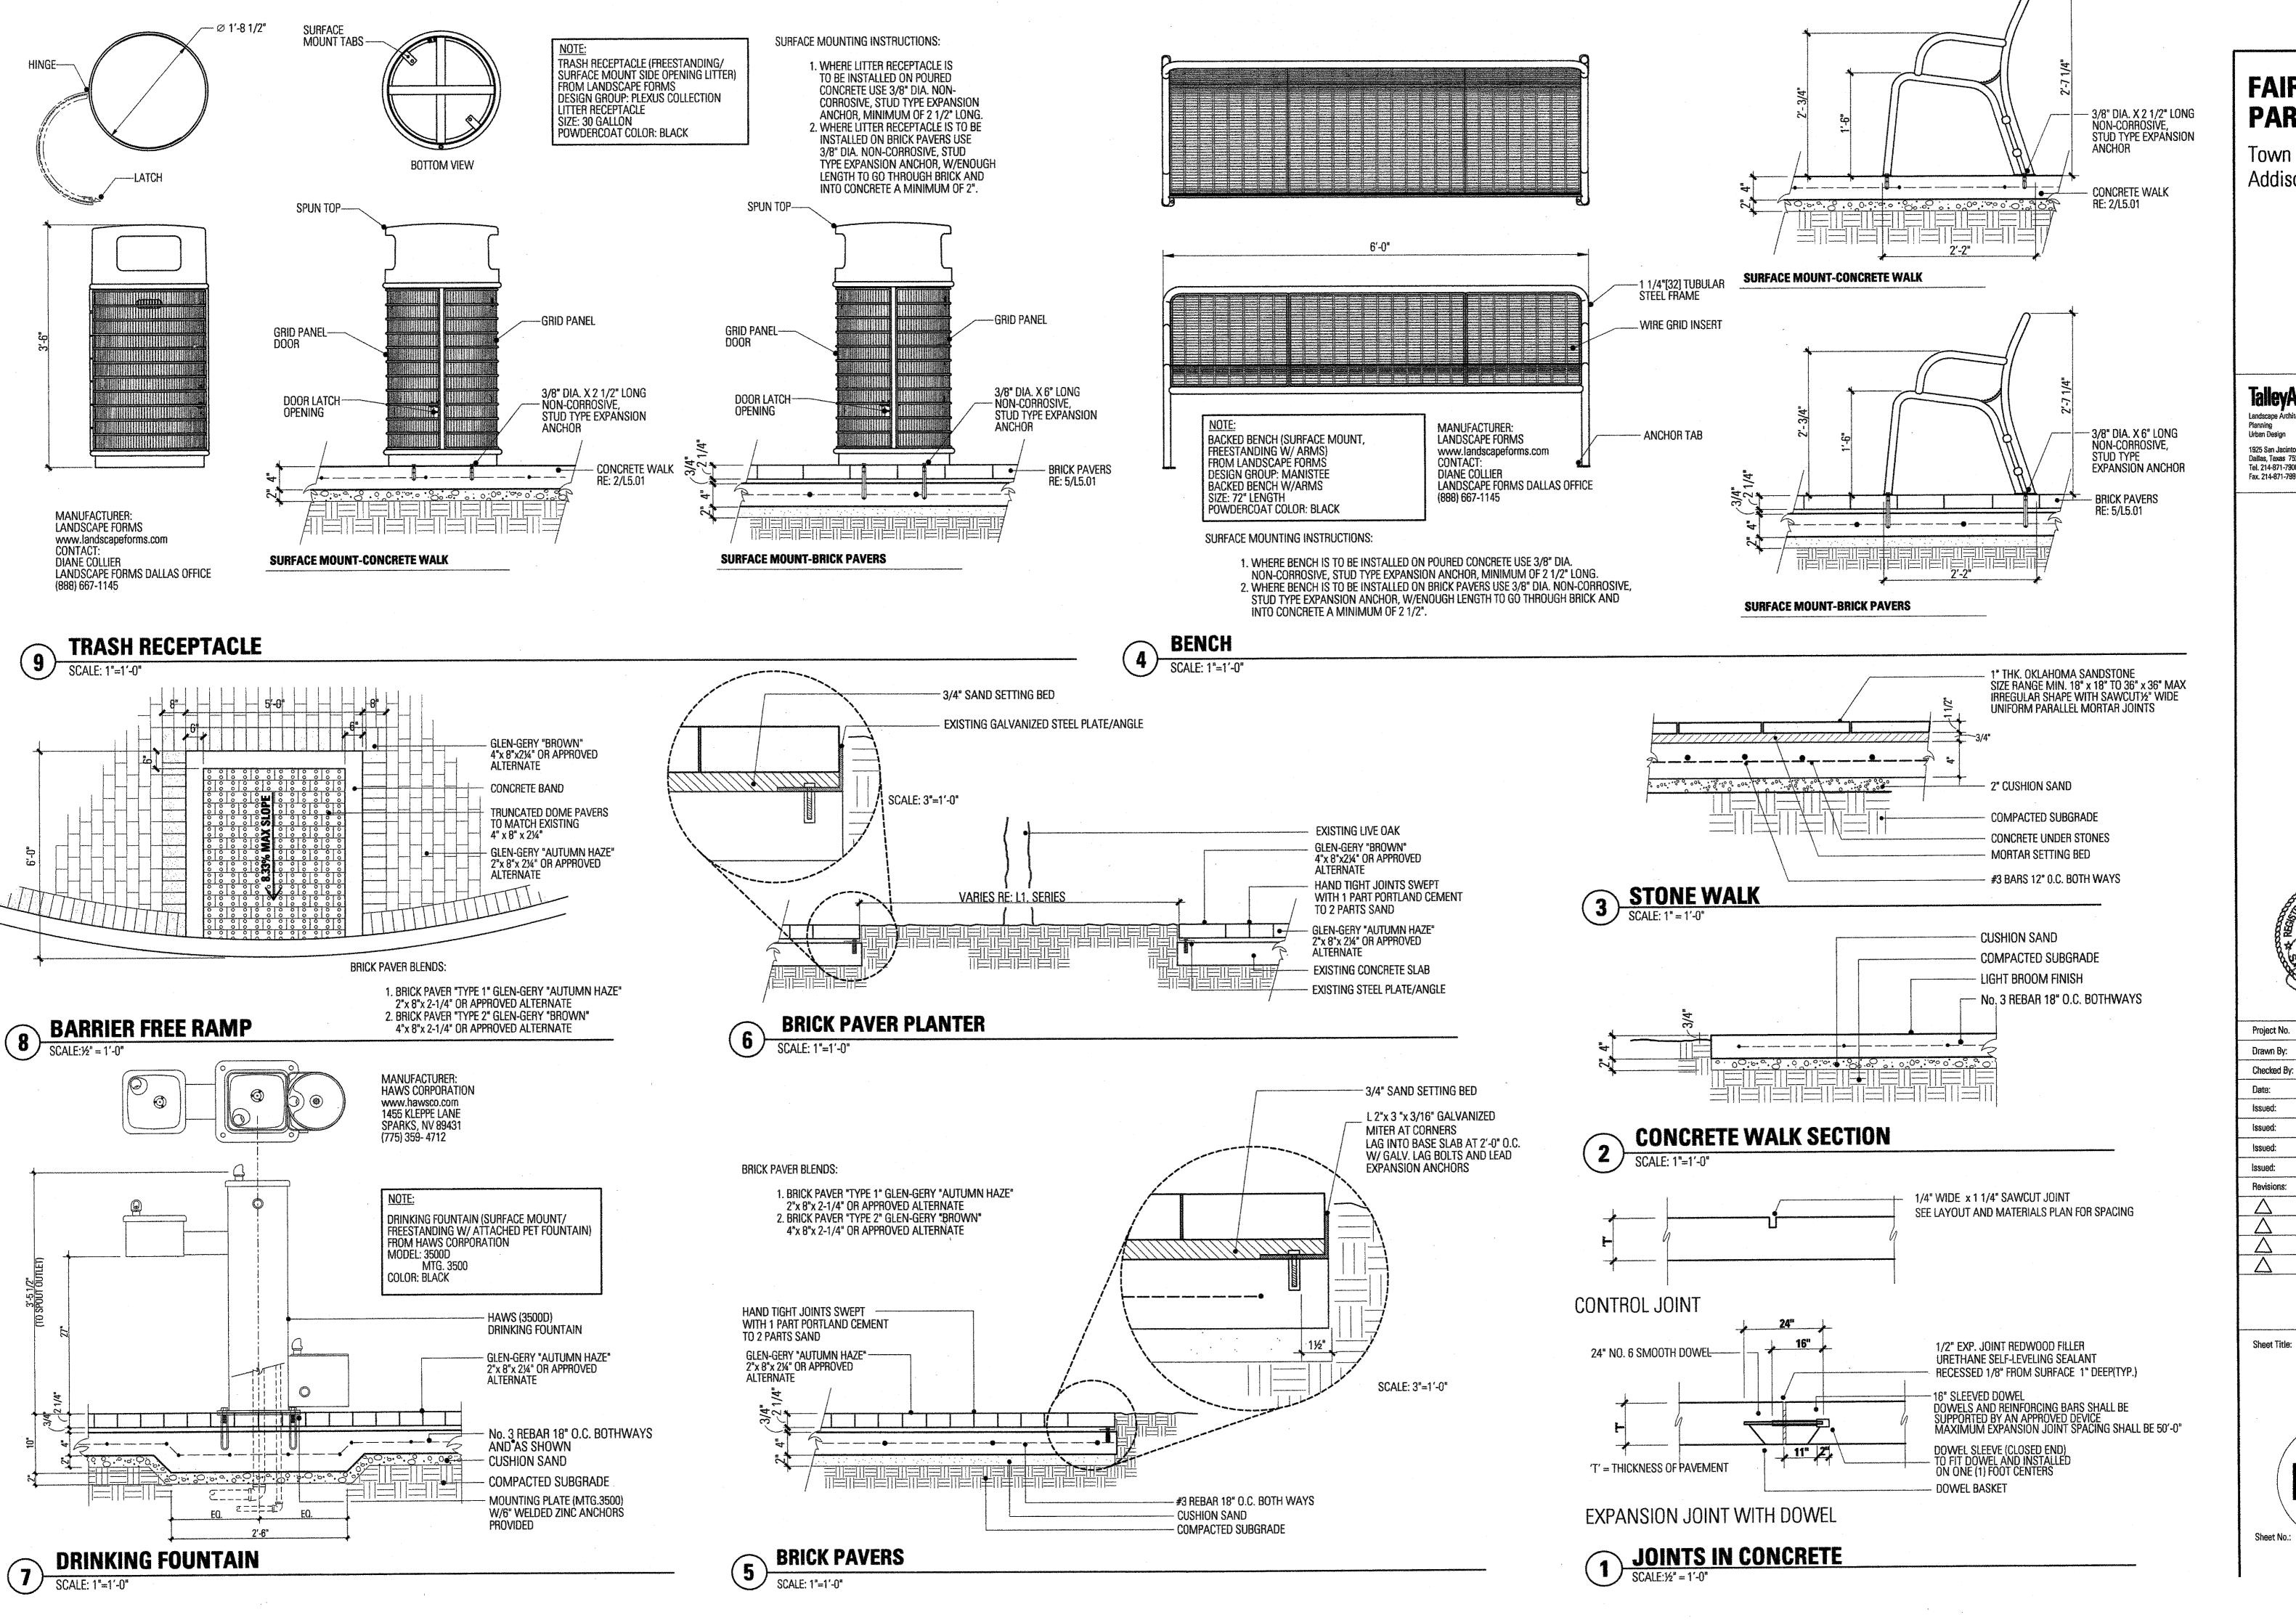

Town of Addison, Texas


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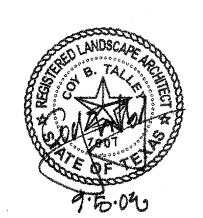


Town of Addison, Texas
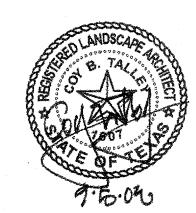
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Landscape Architecture
Planning
Urban Design

1925 San Jacinto, Suite 400
Dallas, Texas 75201
Tel. 214-871-7900
Fax. 214-871-7985

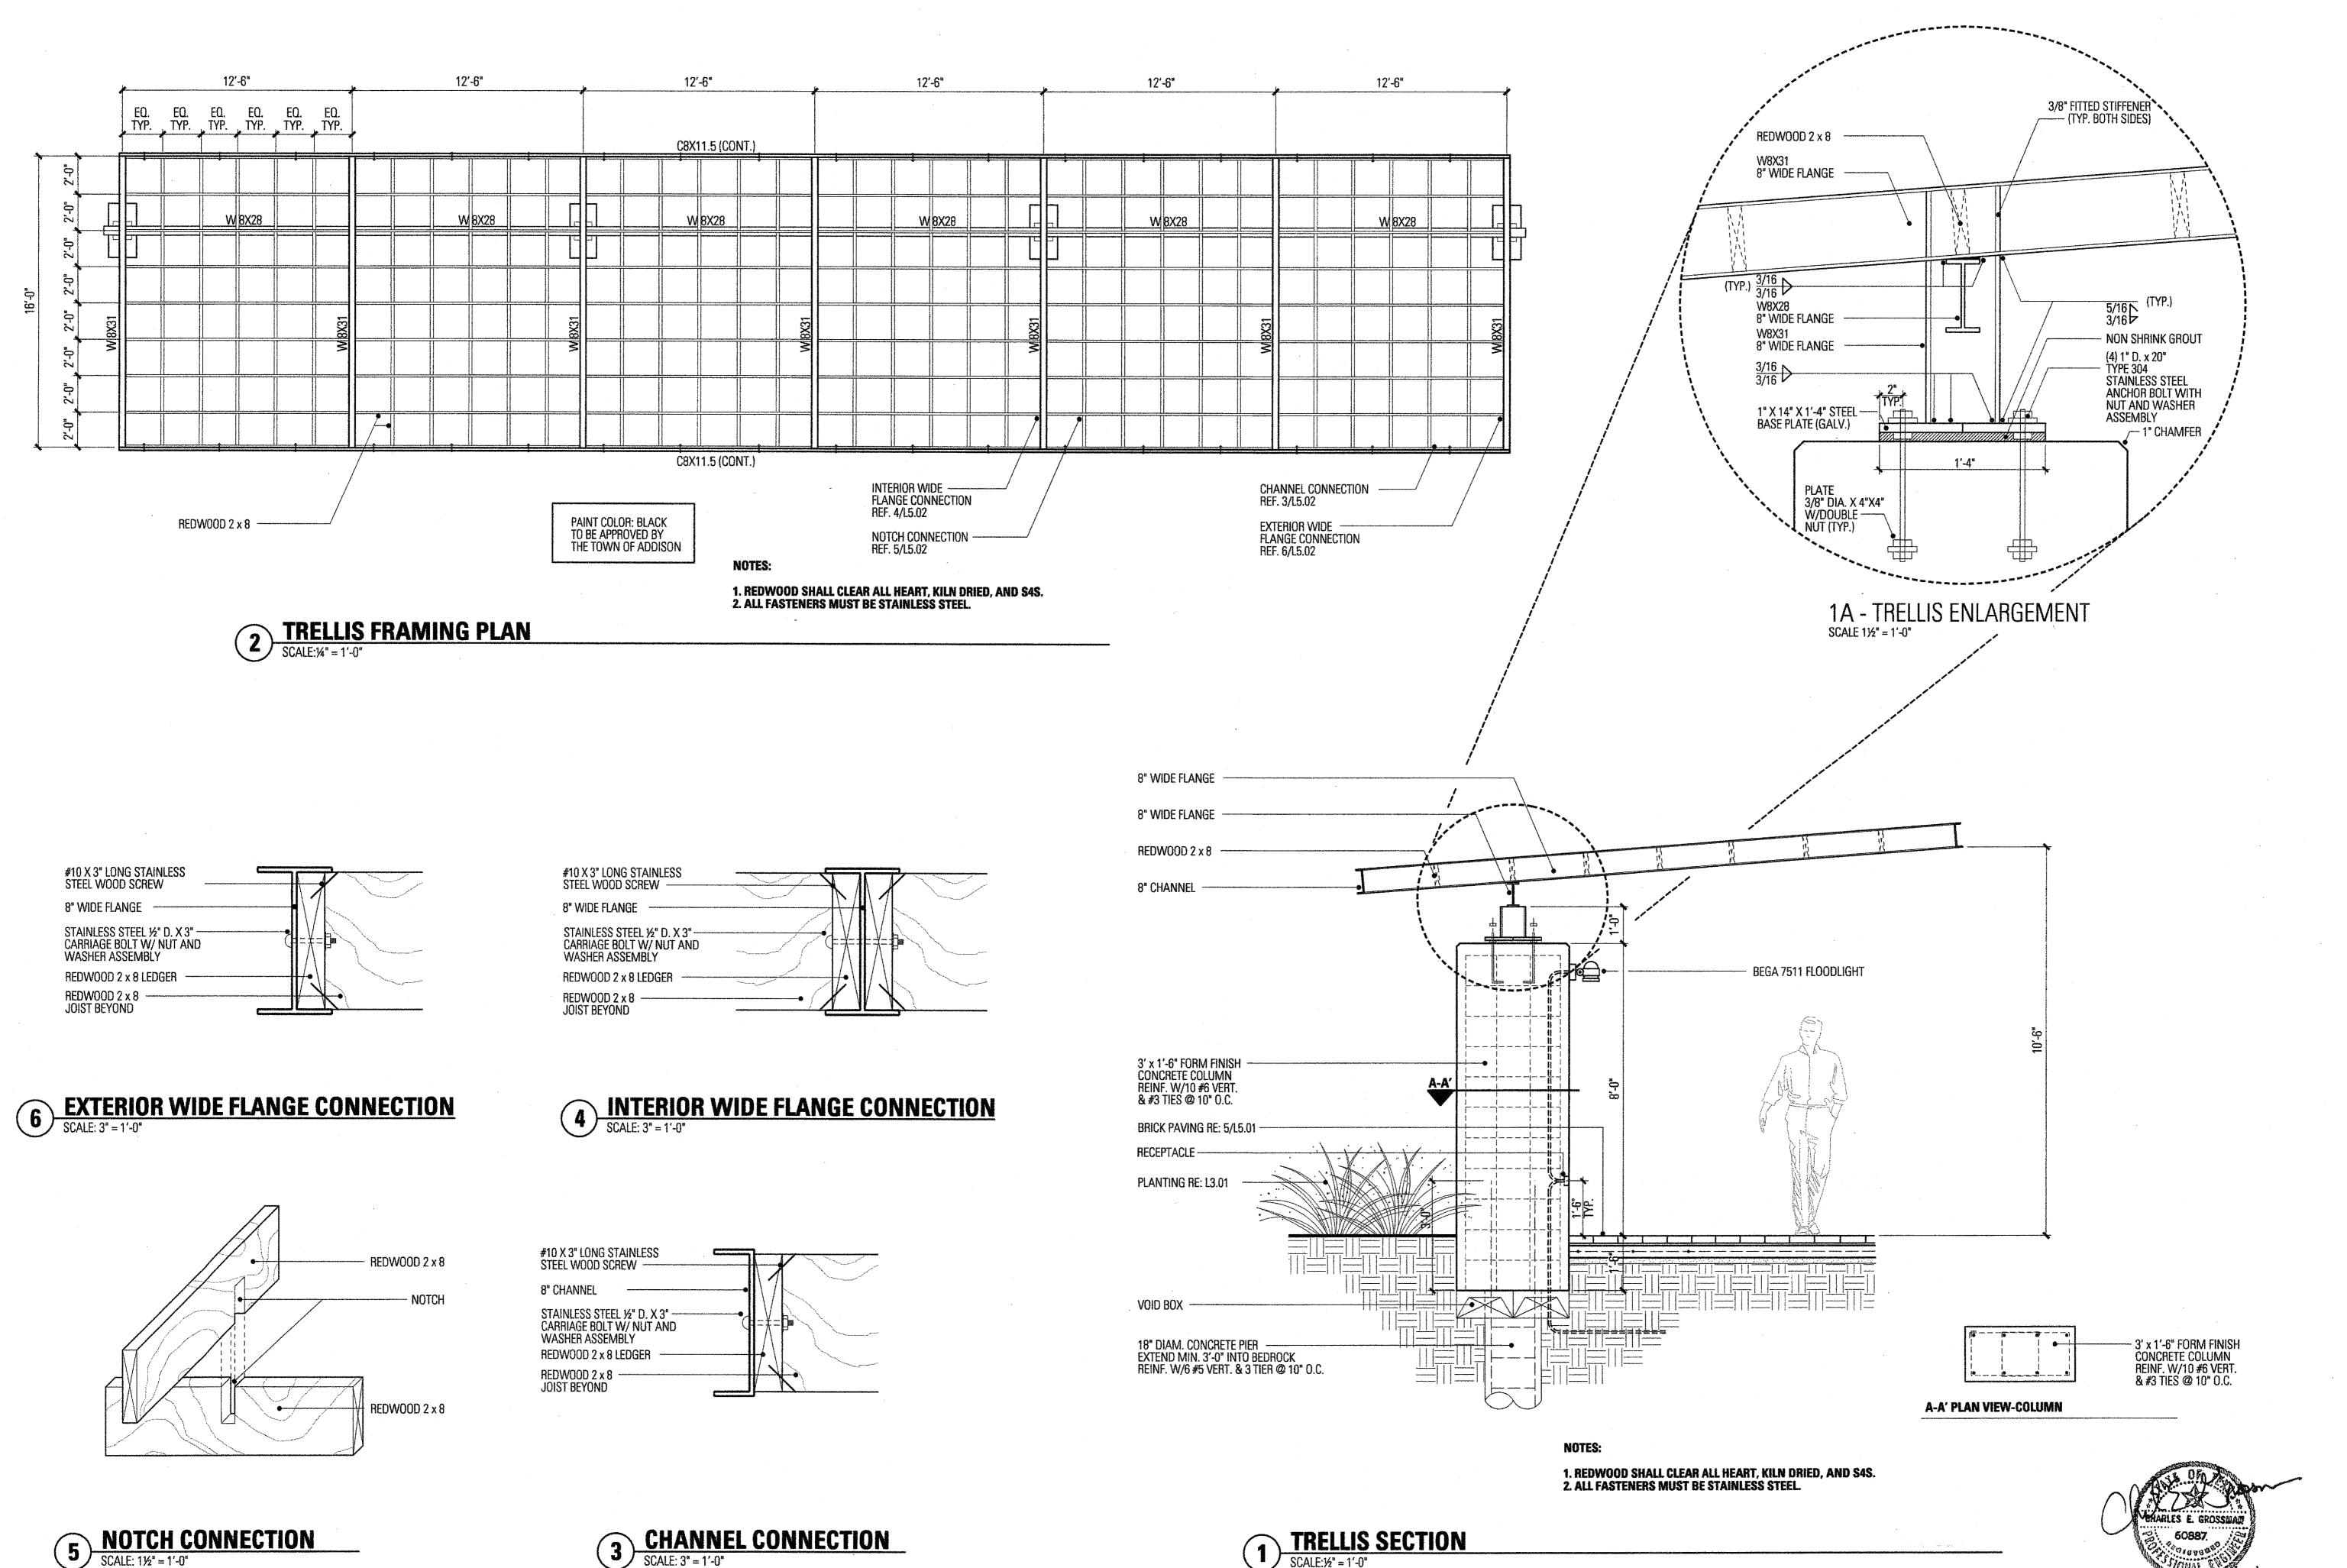

Project No. 5034

Drawn By: JW


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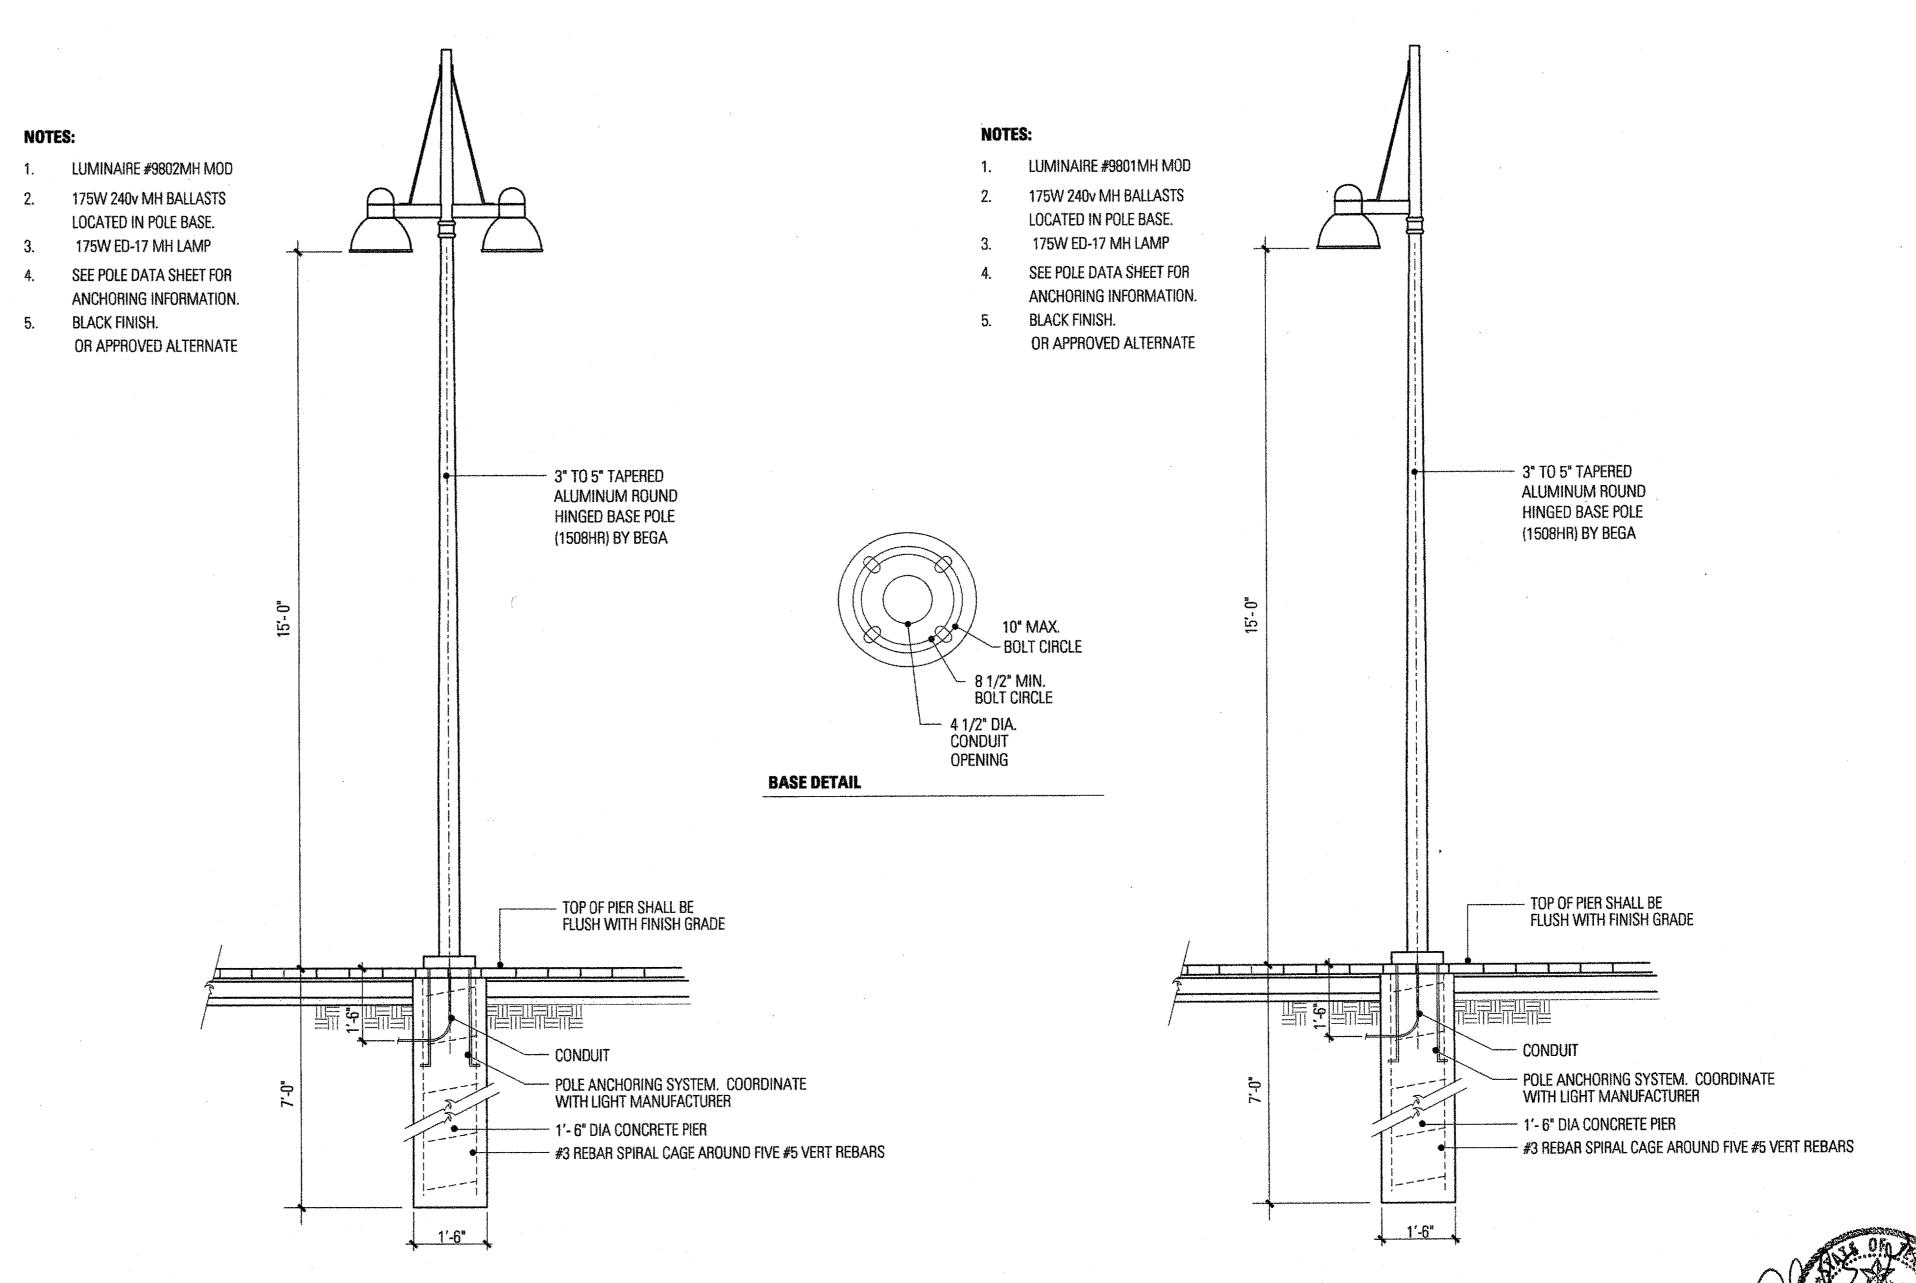
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DETAILS







Town of Addison, Texas
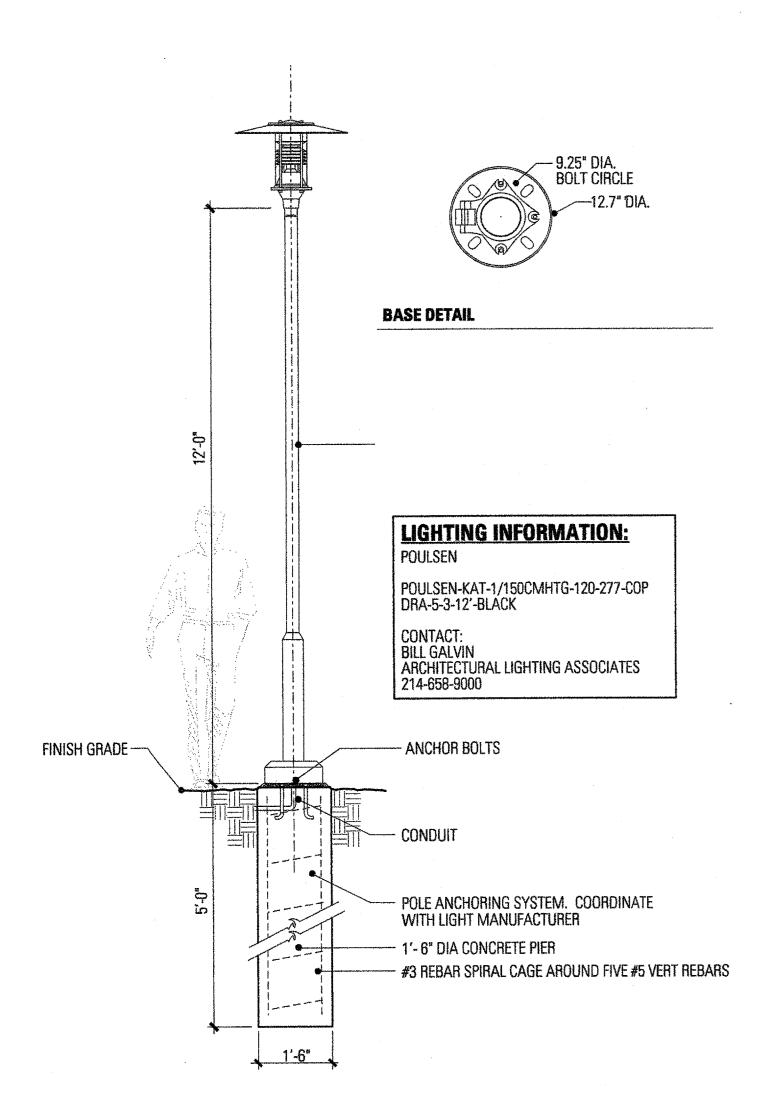
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1925 San Jacinto, Suite 400
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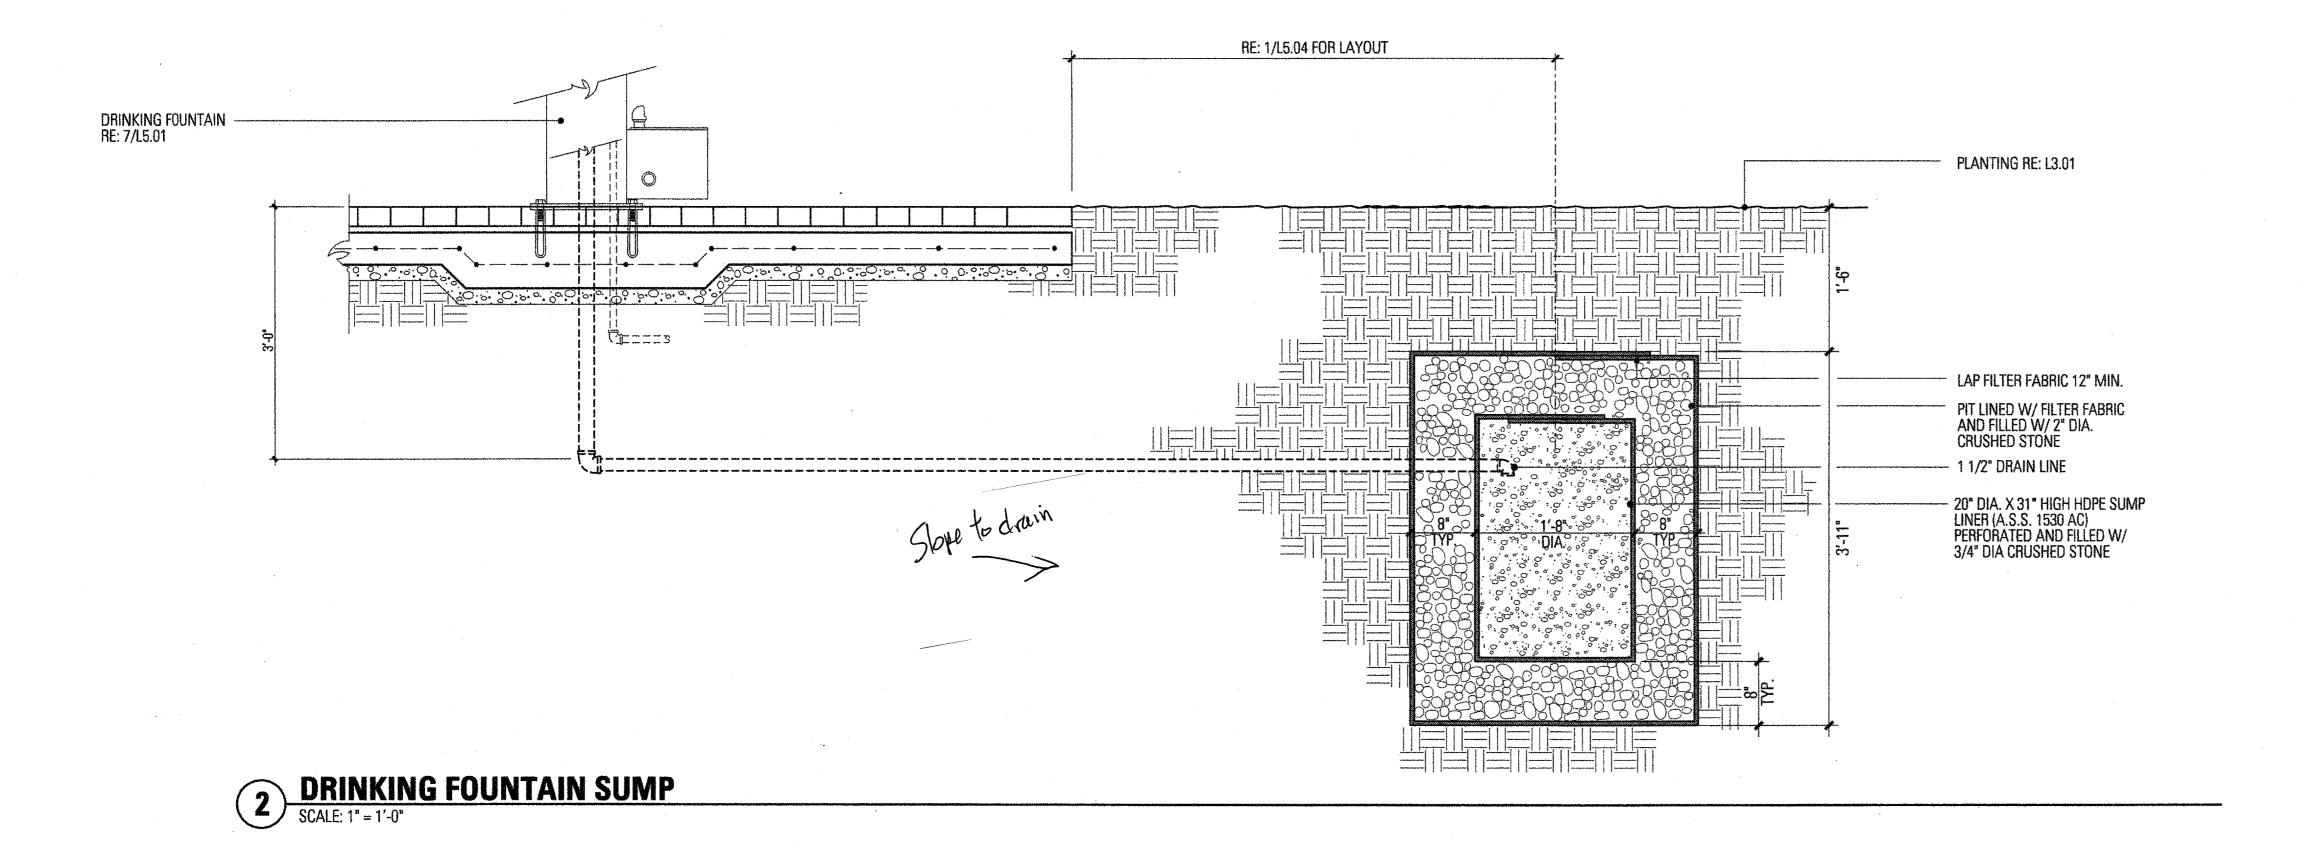
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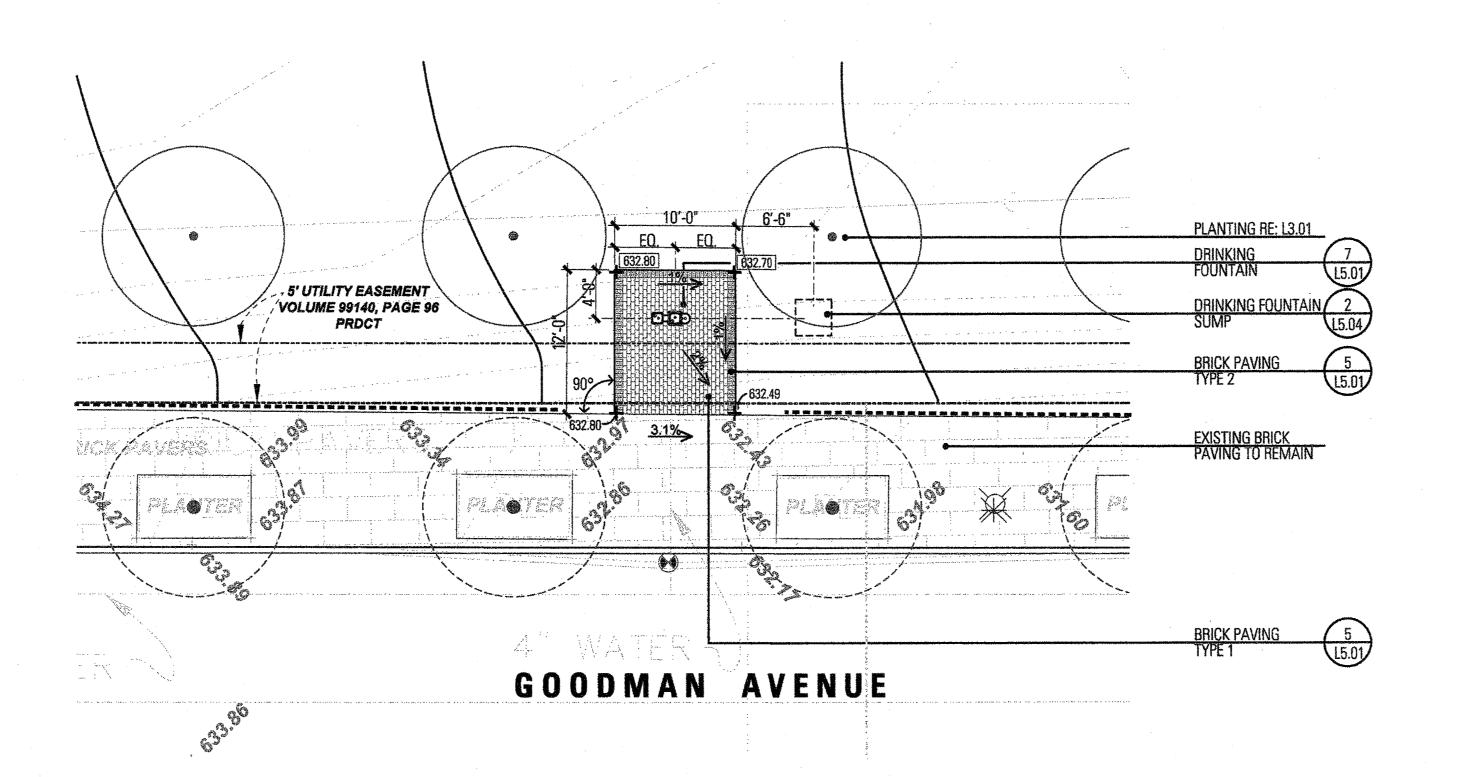
L5.03

2 STREETSCAPE LIGHT FIXTURE - TYPE 'B'
SCALE: 1/2" = 1'-0"

STREETSCAPE LIGHT FIXTURE - TYPE 'A'

SCALE: 1/2" = 1'-0"





1 DRINKING FOUNTAIN/SUMP LAYOUT
SCALE: 1/8" = 1'-0"

FAIRFIELD PARK

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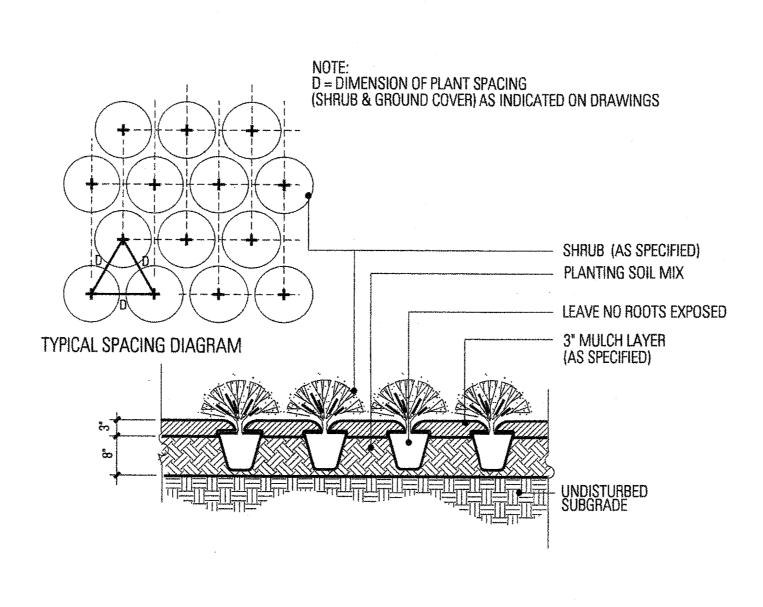
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DETAILS


D = DIMENSION OF PLANT SPACING (SHRUB & GROUND COVER) AS INDICATED ON DRAWINGS **GROUND COVER** (AS SPECIFIED) PLANTING SOIL MIX TYPICAL SPACING DIAGRAM LEAVE NO ROOTS EXPOSED 3" MULCH LAYER (AS SPECIFIED) - Undisturbed Subgrade BREAK THROUGH ANY EXISTING "HARDPAN" AND REMOVE — AS NECESSARY TO PROVIDE GOOD PERCOLATION AND POSITIVE DRAINAGE.

4 GROUNDCOVER PLANTING NTS



4 SHRUB PLANTING

- 1. TOTAL CALIPER INCHES OF A MULTIPLE TRUNK TREE IS CALCULATED AS FOLLOWS: ADD THE CALIPER INCHES OF THE LARGEST TRUNK TO HALF OF THE CALIPER INCH OF EACH OF THE SMALLER TRUNKS.
- 2. ROOTBALL WIDTH SHOULD BE DETERMINED BY THE FOLLOWING: 8" OF ROOTBALL DIA. FOR EACH 1" CALIPER OF TREE TRUNK.

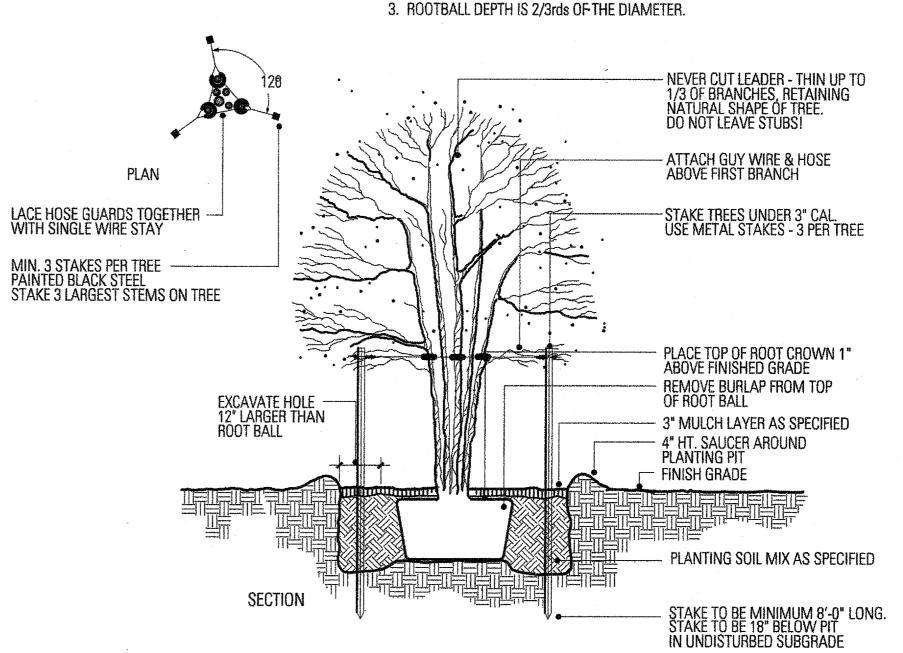


2 MULTI-STEM TREE PLANTING

1. ROOTBALL SIZE SHALL CONFORM TO THE 1995 AMERICAN ASSOCIATION OF NURSERYMEN STANDARDS.

2. ROOTBALL WIDTH SHOULD BE DETERMINED BY THE FOLLOWING: 10" OF ROOTBALL DIA. FOR EACH 1" CALIPER OF TREE TRUNK.

3. ROOTBALL DEPTH IS 2/3rds OF THE DIAMETER.

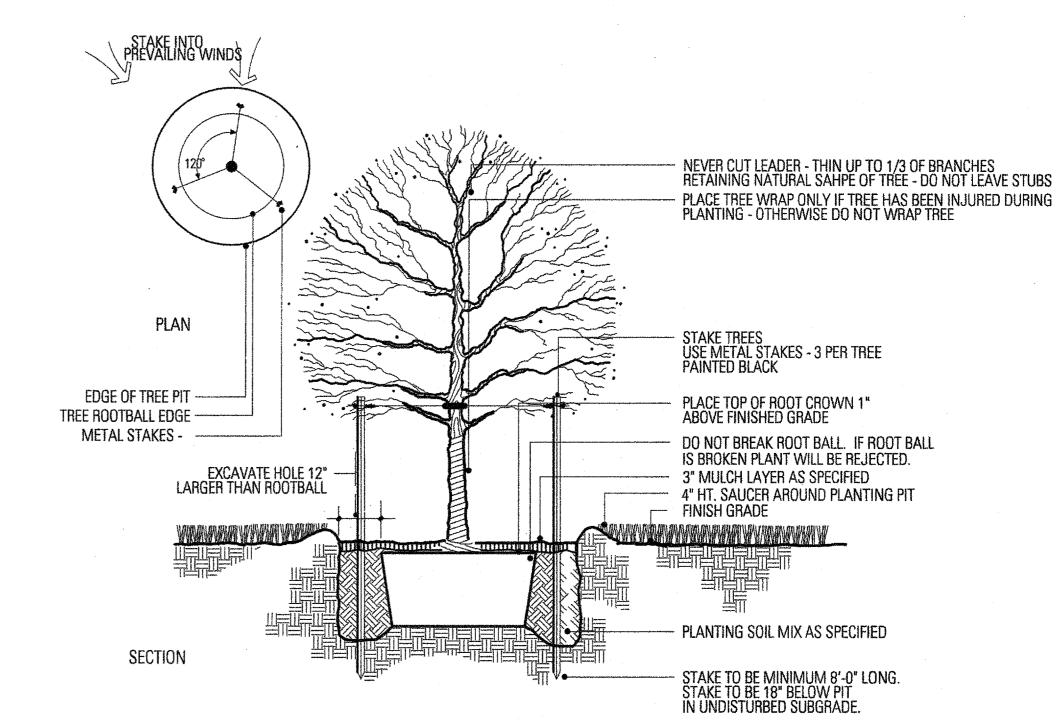





Town of Addison, Texas

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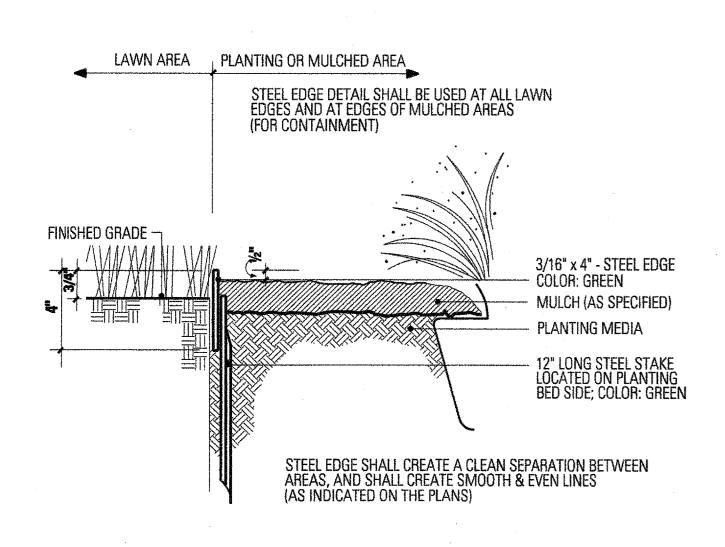
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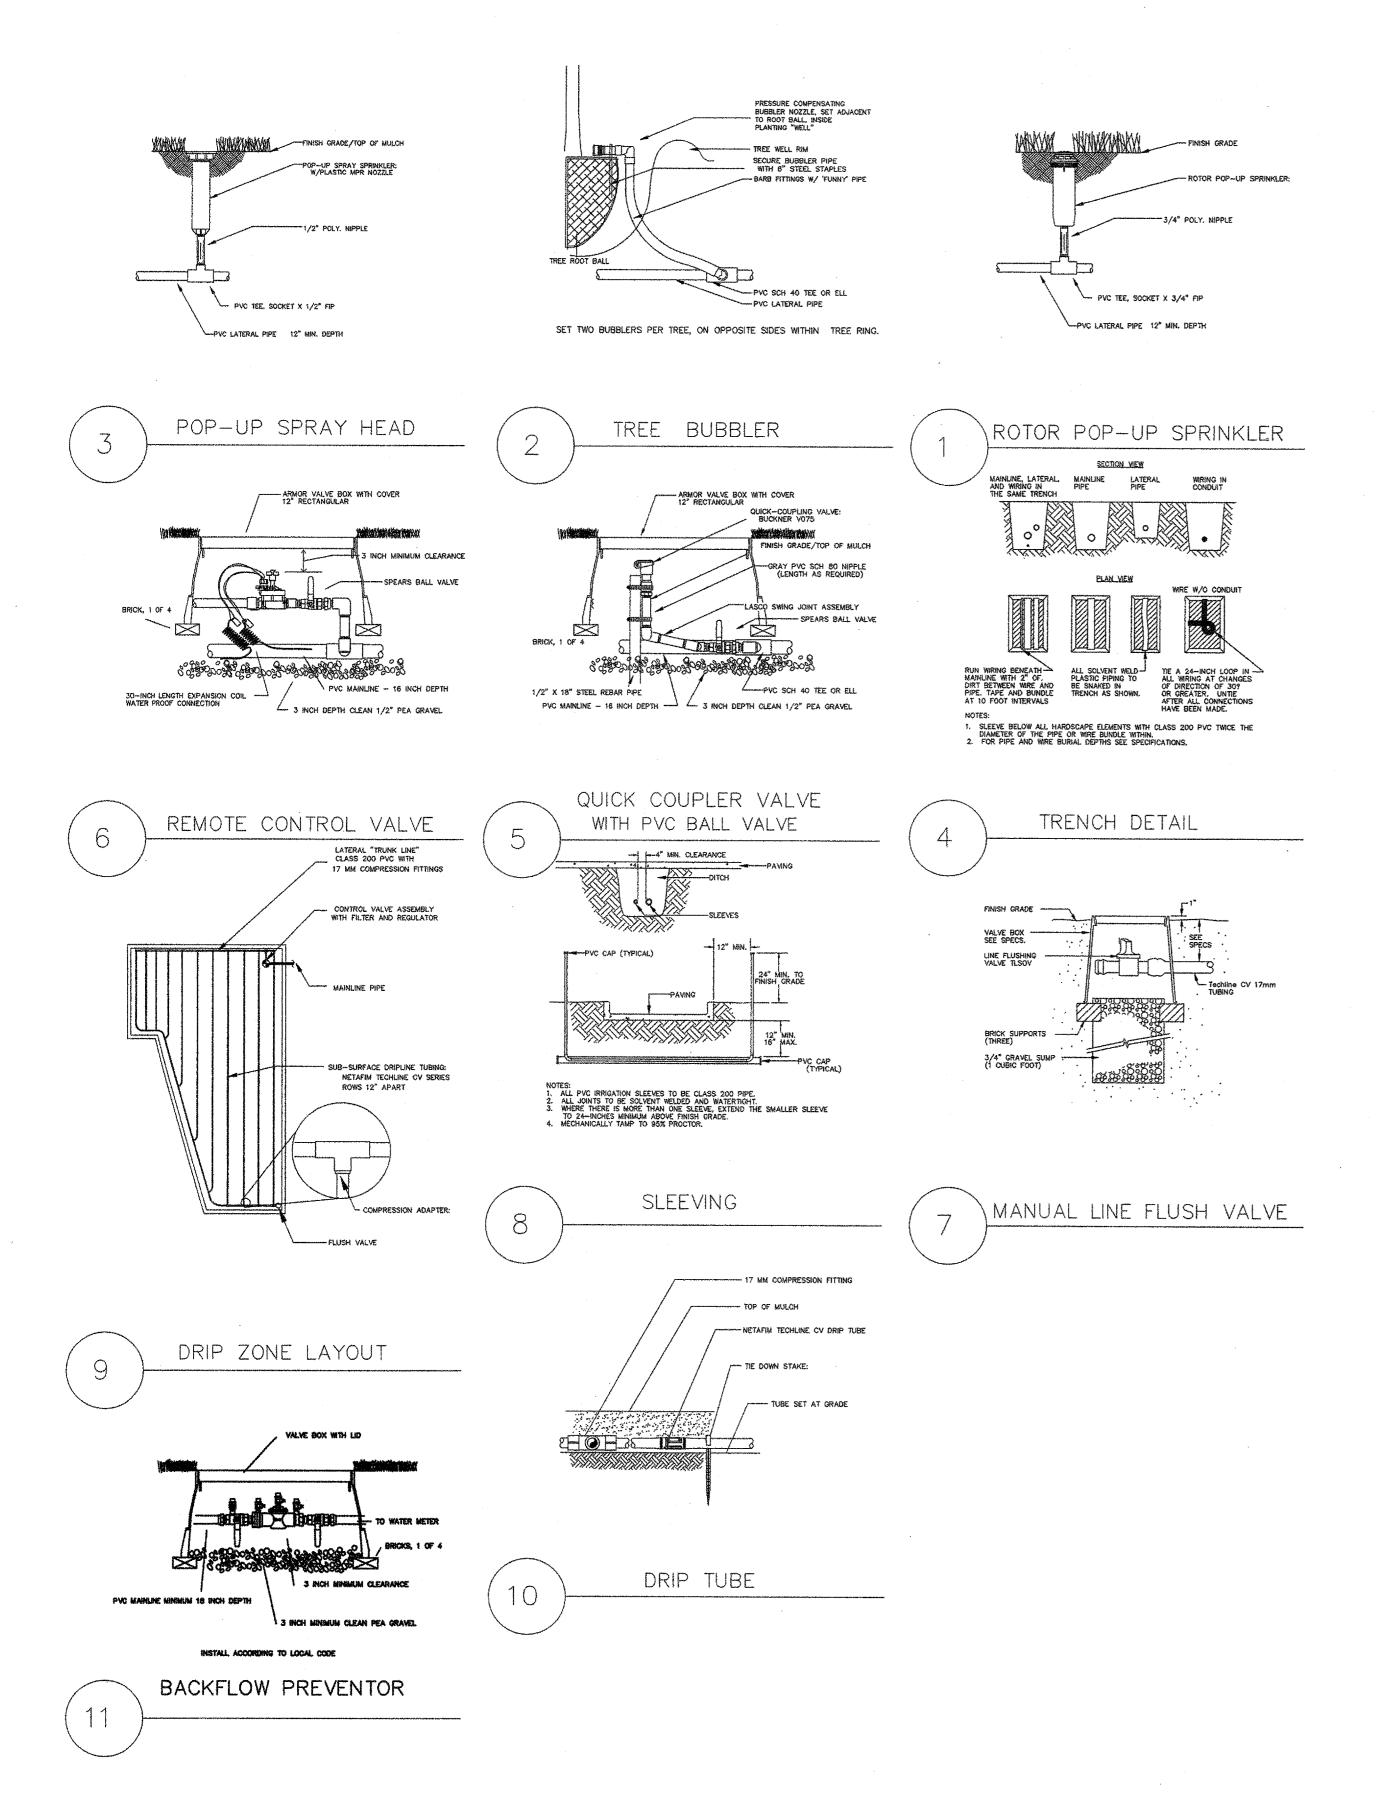
DETAILS

Sheet No.:

PLANTING NOTES:

- 1. SOIL IN THE PERENNIAL/SHRUB PLANTING BEDS SHALL BE PREPARED USING THE EARTHKIND LANDSCAPE MANAGEMENT PROGRAM. THIS SHALL INCLUDE TILLING THREE INCHES OF EXPANDED SHALE TO A DEPTH OF 6 INCHES, THEN ADDITIONALLY TILLING 3 INCHES OF FINISHED COMPOST ON TOP OF THAT. AFTER PLANTING, APPLY A 3 INCH LAYER OF SHREDDED HARDWOOD MULCH. SUBMIT SAMPLES OF ALL SOIL AMENDMENT MATERIALS, INCLUDING MULCH TO THE TOWN OF ADDISON FOR APPROVAL
- 2. ALL NEW TREES SHALL BE BACKFILLED WITH CLEAN, NATIVE BLACK CLAY TOPSOIL FREE OF DEBRIS AND ROCK 1 INCH OR LARGER IN DIAMETER. BACKFILL/TOPSOIL SHALL BE APPROVED BY THE TOWN OF ADDISON. THE CONTRACTOR SHALL PROVIDE THE SOURCE OF THE SOIL TO THE OWNER FOR REVIEW AND APPROVAL.
- 3. SOIL IN THE HYDROSEEDED WEEPING LOVE GRASS BEDS SHALL BE PREPARED USING NATIVE SOIL WITH 3 INCHES OF FINISHED COMPOST TILLED TO A DEPTH OF 6 INCHES. SUBMIT SAMPLES OF ALL SOIL AMENDMENT MATERIALS, INCLUDING MULCH TO THE TOWN OF ADDISON FOR APPROVAL PRIOR TO BEGINNING WORK.





INSTALLATION NOTES


- COORDINATE IRRIGATION INSTALLATION WITH PLANTING PLAN AND SITE CONDITIONS TO PROVIDE COMPLETE COVERAGE WITH MINIMUM OVERSPRAY. THE IRRIGATION CONTRACTOR SHALL MAKE MINOR ADJUSTMENTS TO ENSURE PROPER COVERAGE AT NO ADDITIONAL COST TO THE OWNER.
- CONFIRM STATIC WATER PRESSURE OF 60 PSI AT LEAST 7 DAYS BEFORE BEGINNING WORK. IF STATIC WATER PRESSURE IS LESS THAN STATED ABOVE, DO NOT PROCEED UNTIL DIRECTED SO BY THE LANDSCAPE ARCH.
- 3. THE IRRIGATION CONTRACTOR WILL SECURE ALL REQUIRED PERMITS AND PAY ALL ASSOCIATED FEES UNLESS OTHERWISE NOTED. ALL LOCAL CODES SHALL PREVAIL OVER ANY DISCREPANCIES HEREIN.
- 4. LATERAL PIPE SHALL BE INSTALLED AT A MINIMUM DEPTH OF 12 INCHES. MAINLINE PIPE AND WIRES SHALL BE INSTALLED AT A MINIMUM DEPTH OF 16 INCHES.
- 5. UNSLEEVED PIPES MAY BE SHOWN UNDER PAVEMENT FOR GRAPHIC CLARITY ONLY. INSTALL THESE PIPES IN ADJACENT LANDSCAPED AREAS.
- 6. ALL VALVE WIRE CONNECTIONS MUST BE SPLICED WITH A TAN COLORED KING ONE STEP CONNECTOR. ALL VALVE BOX SPLICES ARE TO BE HOUSED IN A LARGE RECTANGULAR ARMOR VALVE BOX.
- 7. 24 VOLT VALVE WIRE SHALL BE A MINIMUM OF #14 GAUGE, U.F. APPROVED FOR DIRECT BURIAL, SINGLE CONDUCTOR
- "IRRIGATION WIRE". ALL FIELD WIRE SPLICES SHALL BE ENCASED IN A DBY CONNECTOR. ALL FIELD SPLICES SHALL BE LOCATED IN A ROUND ARMOR VALVE BOX OF SUFFICIENT SIZE TO ALLOW INSPECTION.
- 8. VALVE BOXES SHALL BE INSTALLED FLUSH WITH GRADE, SUPPORTED BY BRICKS IF NEEDED, WITH 3-4 INCHES OF CLEAN PEA GRAVEL LOCATED BELOW THE VALVE. USE ARMOR 12" RECTANGULAR VALVE BOXES FOR ELECTRIC VALVES AND QUICK COUPLING VALVES UNLESS NOTED OTHERWISE.
- 9. USE LASCO SWING JOINTS FOR ALL QUICK COUPLER CONNECTIONS.
- 10. ALL SPRAY HEADS SHALL BE CONNECTED WITH A 6" X 1/2" POLYETHYLENE GREEN NIPPLE. ALL ROTOR HEADS SHALL BE CONNECTED WITH A 6" X 3/4" POLYETHYLENE GREEN NIPPLE.
- 11. PROVIDE THREE BUCKNER V075 QUICK COUPLER KEYS WITH HOSE-END SWIVELS.
- 12. CONTRACTOR IS TO CONTACT APPROPRIATE AUTHORITIES AND LOCATE ALL UTILITIES PRIOR TO CONSTRUCTION.
- 13. SUBSURFACE DRIP IRRIGATION FOR ALL SHRUBS SHALL INCLUDE NETAFIM TECHLINE, #TLCV4-1210, GRID TRUNK LINES SHALL BE RIGID CLASS 200 PVC PIPE, BURIED TO A DEPTH OF 10". DRIPPER LINES SHALL BE INSTALLED IN CENTER FED GRIDS, IN ROWS SPACED 12" APART, AT GRADE.


 MANUAL FLUSH VALVE, NETAFIM #TLSOV SHALL BE INSTALLED AT FARTHEST POINTS FROM ZONE VALVE. MAXIMUM SINGLE DRIP TUBE RUN SHALL NOT EXCEED 150 LINEAR FEET. USE NETAFIM 17 MM BARBED FITTINGS FOR DRIPPER LINE CONNECTIONS. SET VALVE PRESSURE REGULATORS TO MAX. 30 PSI. TECHLINE CV SHALL BE INSTALLED PERPENDICULAR TO SLOPE FACE. INSTALL TLCV IN-LINE CHECK VALVES FOR EVERY 4.5 FEET OF DRIP LINE ELEVATION CHANGE WITHIN THE ZONE. NETAFIM STAPLES (#TLS6) SHALL BE INSTALLED EVERY 4 LINEAR FEET OF DRIP TUBE. THE CONTRACTOR SHALL CONTACT NETAFIM REPRESENTATIVE MR. DAVID HAMMOND 888.638.2346, AND SCHEDULE PRE-CONSTRUCTION TRAINING ON CORRECT INSTALLATION PROCEEDURES FOR SUB-SURFACE DRIP EQUIPMENT.

* L.I.C. IS TO VISIT SITE PRIOR TO CONSTRUCTION TO BECOME FAMILIAR WITH THE EXISTING SITE CONDITIONS.

LEGEND

- □ RAINBIRD #1804-PRS POP UP SPRAY HEAD WITH HUNTER PCN-25
- PRESSURE COMPENSATING BUBBLER NOZZLE
- RAINBIRD #1804-PRS POP UP SPRAY HEAD WITH HUNTER PCN-50 PRESSURE COMPENSATING BUBBLER NOZZLE.
- RAINBIRD #1804-PRS POP UP SPRAY HEAD WITH RAINBIRD NOZZLES
- ✓ HUNTER I-20 4" POP UP ROTARY HEAD, PART CIRCLE, #4 NOZZLE
- O HUNTER I-20 4" POP UP ROTARY HEAD, FULL CIRCLE, #8 NOZZLE
- NETAFIM DRIP TUBE INSTALLED AS DETAILED. SEE INSTALLATION NOTE #13.
- IRRITROL 200B SERIES ELECTRIC REMOTE CONTROL VALVE, WITH SPEARS BALL VALVE
- IRRITROL 200B SERIES ELECTRIC REMOTE CONTROL VALVE, WITH SPEARS BALL VALVE, FOR DRIP ZONES. NETAFIM TECHFILTER #TF075412-100CV SERIES
- SEE INSTALLATION NOTE #13 REGARDING SUBSURFACE IRRIGATION LAYOUT IRRITROL 200B SERIES ELECTRIC REMOTE CONTROL "TREE BUBBLER" VALVE,
- IRRITROL 200B SERIES ELECTRIC REMOTE CONTROL "TREE BUBBLER" WITH SPEARS BALL VALVE
- 2" IRRITROL 200 B SERIES MASTER VALVE INSTALLED WITH BLUE WIRE FOR STATION WIRING, AND 2" DATA INDUSTRIAL FLOW METER INSTALLED WITH RAIN MASTER EV-CAB-SEN FLOW METER CABLE, INSTALLED IN 3/4" GRAY PVC CONDUIT WITH 6" OR LARGER J-BOXES PLACED EVERY 200 FEET OR WHERE 360 DEGREES OF FITTING ARE INSTALLED; ONLY SWEEP FITTINGS ARE PERMITTED. INSTALL WITHOUT SPLICES.
- ▲ BUCKNER V075 3/4" SINGLE LUG QUICK COUPLING VALVE WITH METAL TOP
- SPEARS BALL VALVE WITH POSITIVE T-HANDLE, SAME SIZE AS PIPE
- WATTS 007 M SERIES D.C.A. INSTALLED PER CITY CODE, SIZE NOTED ON PLAN
- 1 1/2" IRRIGATION WATER METER AND TAP
- CLASS 200 BELLED PVC MAINLINE PIPE
- CLASS 200 BELLED (EXCEPT 1/2 INCH #315) PVC LATERAL PIPE
- 4" CLASS 200 SLEEVE PIPES, BELLED END, UNLESS NOTED OTHERWISE
- L.I.C. SHALL SELECT MPR SERIES SPRAY NOZZLES FOR "HEAD-TO-HEAD" COVERAGE, ADJUSTED FOR MINIMUM OVERSPRAY ONTO WALLS AND WALKS. NO OVERSPRAY INTO STREETS IS PERMITTED.

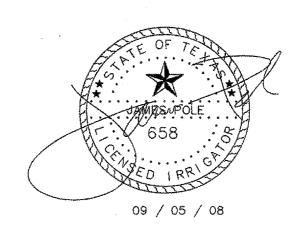

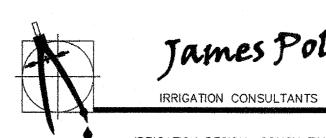

IRRIGATION DESIGN, CONSULTING, AND LANDSCAPE WATER MANAGEMENT

TEXAS L.I.C. #658

100 W. OAK ST., SUITE 101 PHONE: 940.243.2364
DENTON, TEXAS 76201 FAX: 940.382.2475

FAIRFIELD PARK

Town of Addison, Texas

TalleyAssociates

Planning Urban Design 1925 San Jacinto, Suite 400 Dallas, Texas 75201 Tel. 214-871-7900 Fax. 214-871-7985

Project No. 5034

Drawn By: JW

Checked By: CT/KB

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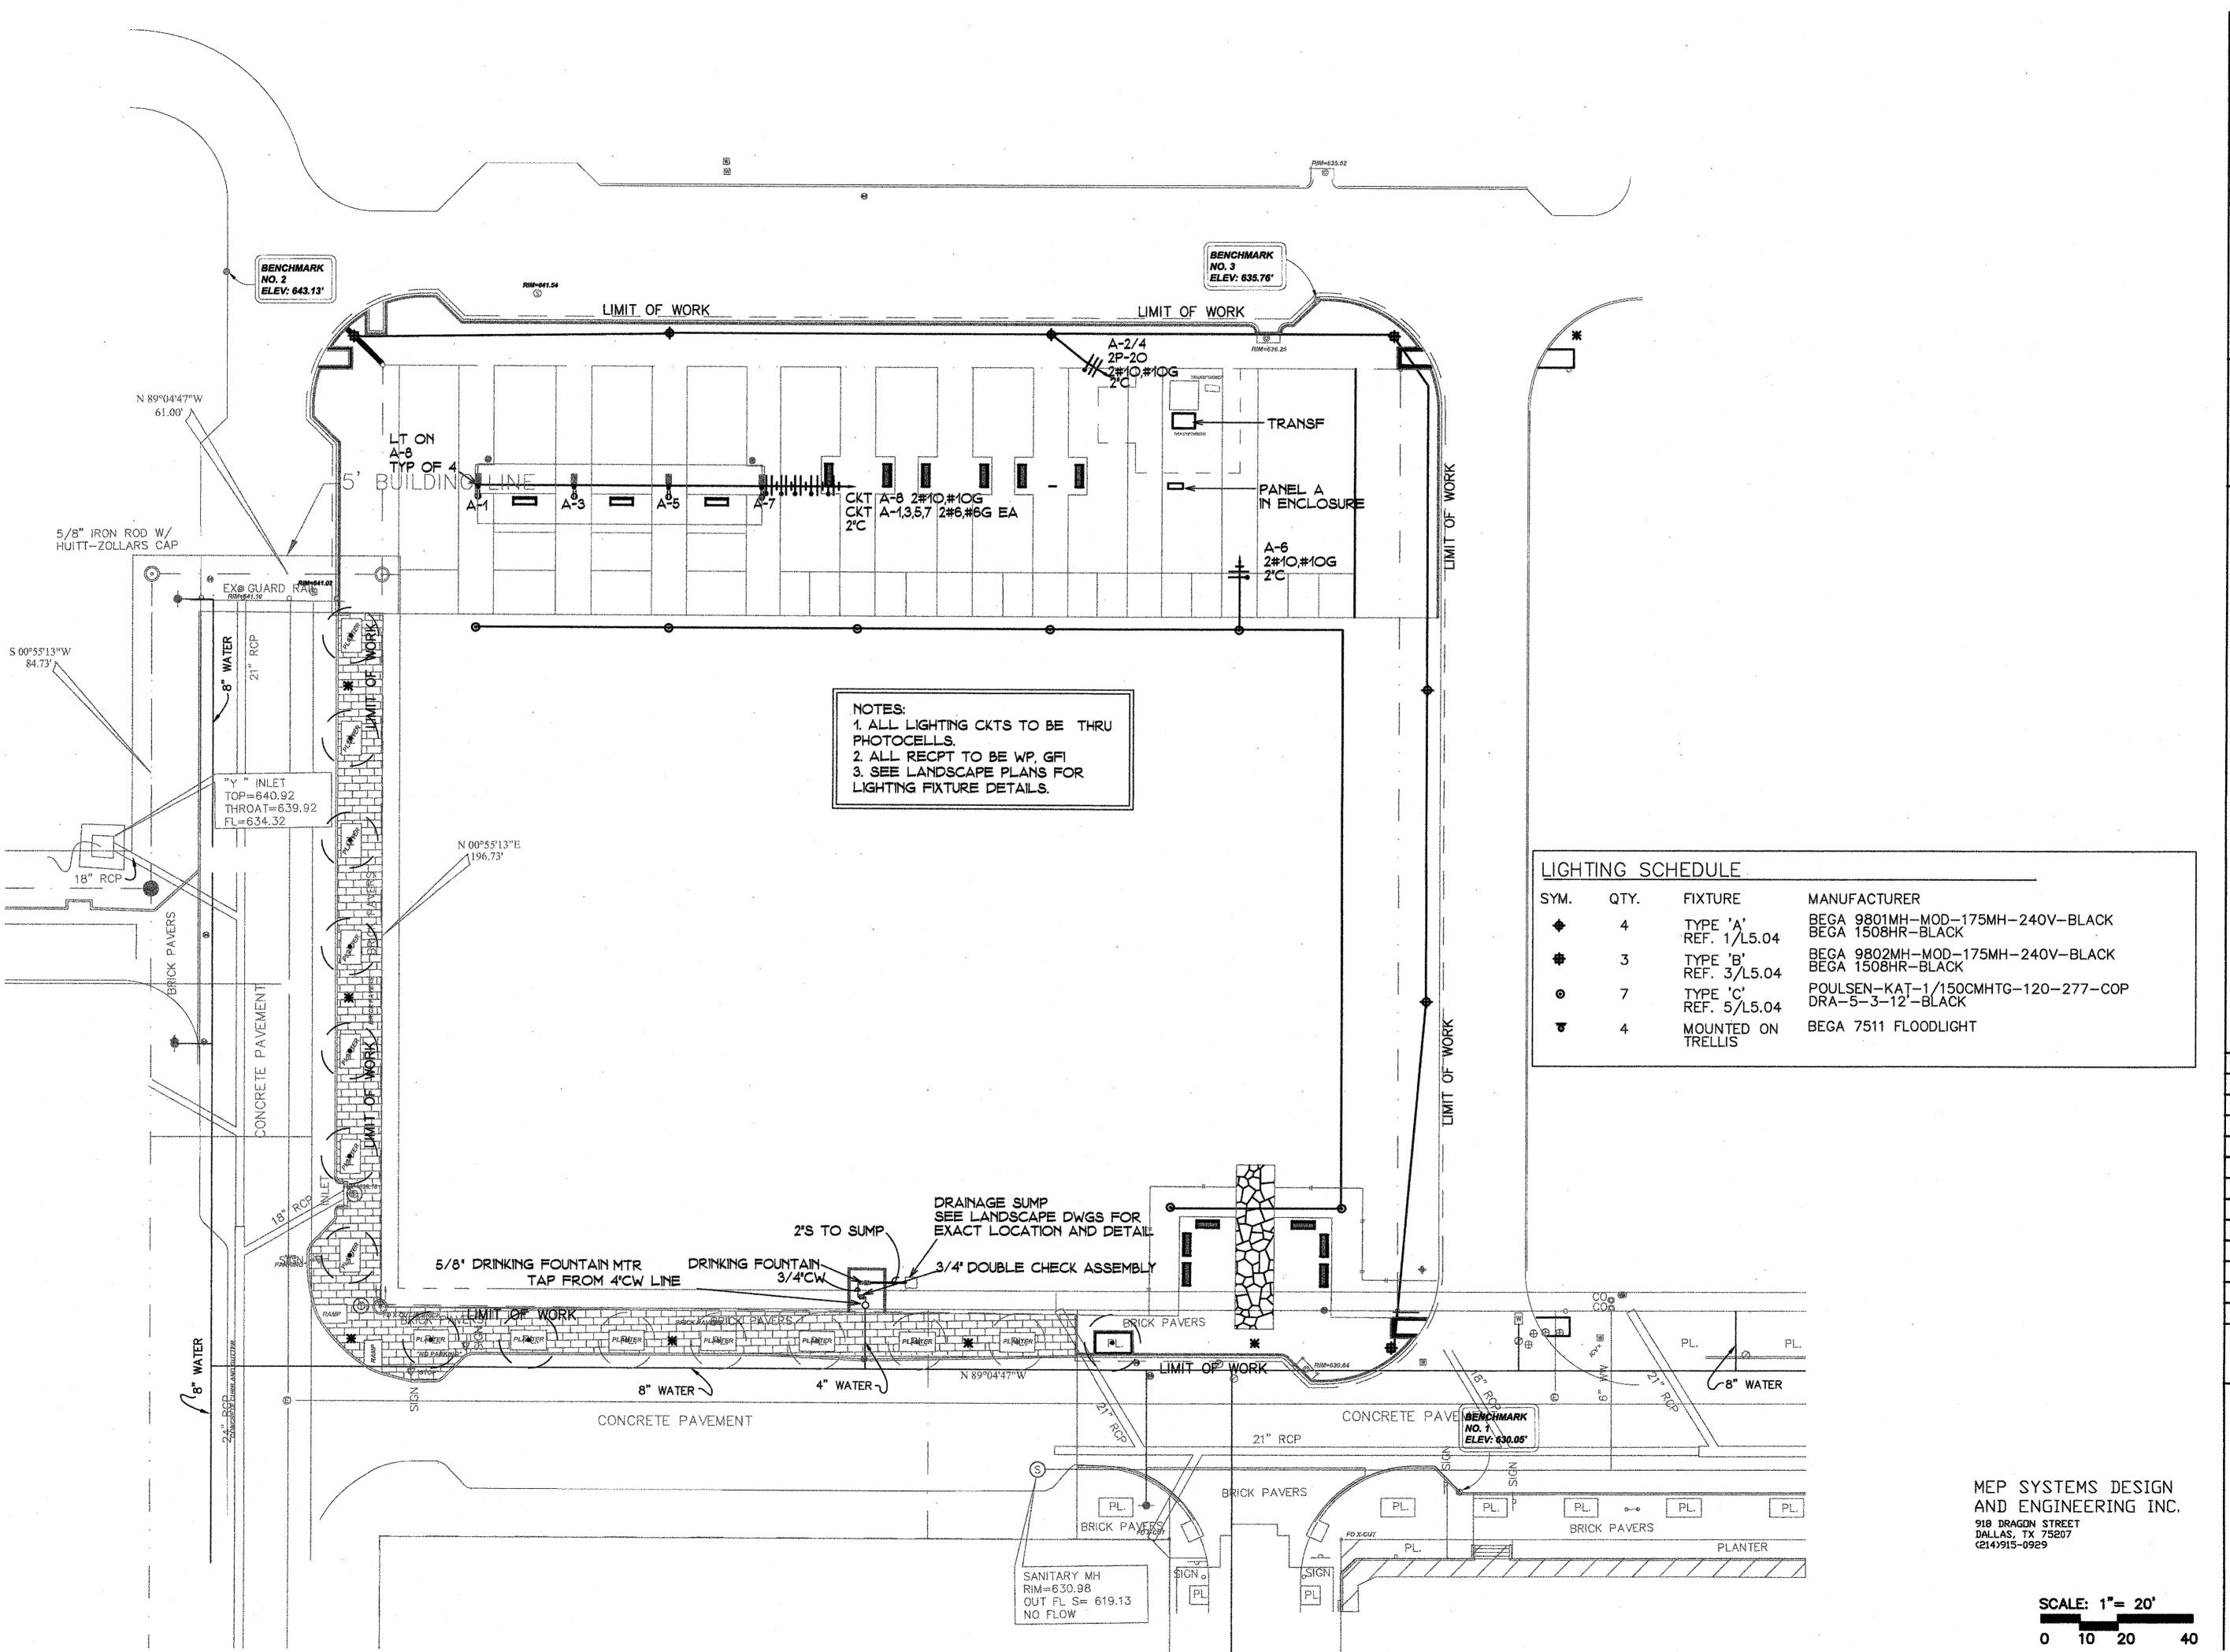
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FAIRFIELD PARK Town of Addison, Texas



Project NS034 Drawn ByJW Checked BF/KB Date: SEPTEMBER 5, 2008

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Sheet Title:

EP SITE PLAN



GENERAL NOTES

- G1. COMPLETE SYSTEMS: PROVIDE LABOR, MATERIALS, EQUIPMENT, AND TRANSPORTATION TO RECEIVE, INSTALL, ADJUST, AND PUT INTO OPERATION COMPLETE ELECTRICAL SYSTEMS IN ACCORDANCE WITH THE INTENT OF THE CONTRACT DOCUMENTS. PROVIDE PRODUCTS NOT MENTIONED BUT OBVIOUSLY NECESSARY AND INCIDENTAL TO THE COMPLETION OF THIS WORK.
- G2. SCOPE: VORK SHALL INCLUDE, BUT NOT BE LIMITED TO THE FOLLOWING:
 MECHANICAL WORK AS REQUIRED FOR COORDINATION, POWER DISTRIBUTION, AND
 INSTALLATION OF MATERIALS.
- G3. UTILITIES: COORDINATE WITH ALL UTILITY SERVICES. NOTIFY UTILITIES OF COMMENCEMENT OF WORK. MAKE ALL ARRANGEMENTS FOR TEMPORARY SERVICES. PROVIDE ALL WORK AND MATERIALS NECESSARY TO COMPLY WITH ALL UTILITY REGULATIONS AND REQUIREMENTS.
- G4. PERMITS: OBTAIN ALL NECESSARY PERMITS TO BEGIN AND CONTINUE WITH WORK, PAY ALL ASSOCIATED FEES FOR PERMITS AND OTHER MUNICIPAL AND GOVERNING
- EXPERIENCE: ALL WORK DONE SHALL BE PERFORMED BY QUALIFIED ELECTRICIANS, UNDER THE SUPERVISION AND DIRECTION OF A SUPERINTENDENT HAVING SUCCESSFUL EXPERIENCE INSTALLING AND SUPERVISING EQUIPMENT AND SYSTEMS OF SIMILAR TYPE AND SIZE AS INDICATED BY CONTRACT DOCUMENTS.
- G6. REGULATIONS: ALL WORK SHALL BE PERFORMED IN ACCORDANCE WITH CURRENT RULES, REGULATIONS, AND INDUSTRY STANDARDS OF THE NATIONAL ELECTRICAL CODE, UL, IPCEA, NEMA, NFPA, OSHA, NATIONAL ELECTRICAL SAFETY CODE, ADA, AND ANY LOCAL CODES, LAWS, OR ORDINANCES. IN THE EVENT THAT A DISCREPANCY IS FOUND IN THE CONTRACT DOCUMENTS, THE ENGINEER SHALL BE NOTIFIED IMMEDIATELY.
- G7. COSTS AND CONDITIONS: EXAMINE AND BECOME FAMILIAR WITH ALL CONTRACT DOCUMENTS IN THEIR ENTIRETY. SURVEY THE PROJECT AND BECOME FAMILIAR WITH EXISTING CONDITIONS AND SCOPE OF WORK. ALL COSTS SUBMITTED SHALL BE BASED ON A THOROUGH KNOWLEDGE OF ALL WORK AND MATERIALS REQUIRED. ANY ADDITIONAL COSTS DUE TO FAILURE TO COMPLY WITH THIS REQUIREMENT SHALL BE THE RESPONSIBILITY OF THE CONTRACTOR.
- NOTES AND THE DRAVINGS. THERE SHALL BE NO DEVIATION FROM NOTES/SPECIFICATIONS

 SPECIFICATIONS: BECOME FAMILIAR WITH ALL SPECIFICATIONS, DESIGN

 CRITERIA, AND EQUIPMENT REQUIREMENTS PRIOR TO ANY EQUIPMENT PURCHASE OR
 INSTALLATION. REFERENCE SPECIFICATIONS FOR DEVICES, MATERIALS AND
 WORKMANSHIP REQUIREMENTS. ADDITIONAL REQUIREMENTS ARE GIVEN IN THESE
 - WITHOUT THE WRITTEN APPROVAL OF THE ENGINEER.
- COORDINATION: COORDINATE WORK WITH ALL OTHER TRADES. GIVE SPECIAL CONSIDERATION TO COORDINATING INSTALLATION OF LIGHTING, POWER AND STRUCTURAL MEMBERS. COORDINATE OUTLET LOCATIONS WITH ARCHITECT. VERIFY EXACT LOCATION, COLOR AND FINISH OF OUTLETS AND DEVICES WITH ARCHITECT, OR DESIGNATED TENANT REPRESENTATIVE PRIOR TO INSTALLATION.
- PRODUCTS: ALL PRODUCTS SHALL BE NEW, SPECIFICATION GRADE. PRODUCTS OF A SIMILAR NATURE SHALL BE OF THE SAME TYPE AND MANUFACTURER. PROVIDE THE STANDARD PRODUCTS OF MANUFACTURERS REGULARLY ENGAGED IN THE PRODUCTION OF SPECIFIED PRODUCTS, UNLESS OTHERWISE REQUIRED BY DRAWINGS. ALL PRODUCTS SHALL BE CONSTRUCTED AND INSTALLED IN ACCORDANCE WITH NATIONALLY RECOGNIZED AND ACCEPTED STANDARDS AND PROCEDURES.
- G11. COMPATIBILITY: ALL NEW ELECTRICAL DISTRIBUTION EQUIPMENT SHALL MATCH AND BE COMPATIBLE, BY MANUFACTURER, TYPE, APPLICATION, AND SHORT CIRCUIT RATING.
- G12. IDENTIFICATION: ALL ELECTRICAL DISTRIBUTION EQUIPMENT, TRANSFORMERS, PANELBOARDS, AND OTHER ENCLOSED EQUIPMENT SHALL BE IDENTIFIED AS INDICATED IN THE CONTRACT DOCUMENTS. SAID IDENTIFICATION SHALL CONSIST OF PERMANENTLY ATTACHED ENGRAVED LAMINATED PLASTIC NAMEPLATES. EACH BRANCH CIRCUIT OVERCURRENT PROTECTION DEVICE SHALL BE IDENTIFIED BY CIRCUIT NUMBER AND SCHEDULED INSIDE PANEL DOOR. EACH BRANCH CIRCUIT SPLICE OR TERMINATION SHALL BE IDENTIFIED BY PANEL AND CIRCUIT DESIGNATION SHOWN ON THE JUNCTION OR OUTLET BOX, OR UPON INDIVIDUAL WIRES IN CASES WHERE MORE THAN ONE OF EACH PHASE CONDUCTOR OCCUR.
- G13. VIRING: ALL CONDUCTORS CARRYING GREATER THAN 50 VOLTS SHALL BE MINIMUM #12 AWG, SOLID, CU, SOFT DRAWN OF 98% CONDUCTIVITY, UNLESS NOTED OTHERWISE.
 - INSULATION: PROVIDE TYPE THHN, OR XHW TYPE INSULATIONS.
 COURDINATE INSULATION TYPES WITH CONDITIONS, NEC REQUIREMENTS, AND
 CONDUIT FILL REQUIREMENTS. ALL WIRING SIZES ARE BASED ON 75 C
 INSULATION, ACCORDING TO CURRENT RATING, REGARDLESS OF ACTUAL INSULATION
 USED. TYPE "AC" OR "MC" CABLE IS ACCEPTABLE ONLY WITH TYPE THHN
 INSULATION.
 - HOME RUNS: PROVIDE MINIMUM # 10 AWG VIRING ON ALL HOMERUNS GREATER THAN 100 FEET.
 - NEUTRALS: SIZE ALL NEUTRALS FULL UNLESS SPECIFICALLY REDUCED ON PLANS. PROVIDE OVERSIZED NEUTRALS FOR FEEDERS AND SEPARATE NEUTRALS FOR BRANCH CIRCUITS SERVING DIGITAL COMPUTER EQUIPMENT.
- 14. GROUNDING: ALL CIRCUITS SHALL BE RUN WITH A #12 AWG INSULATED GREEN COPPER GROUND WIRE, UNLESS OTHERWISE NOTED. USE OF CONDUIT AS A GROUND IS UNACCEPTABLE.

CONDUIT: ALL VIRING SHALL BE IN CONDUIT, MINIMUM 3/4" (E. M. T. IS

- ACCEPTABLE WITH COMPRESSION FITTINGS ONLY). FLEXIBLE METAL CONDUIT IS ACCEPTABLE ONLY WITH SEPARATE INSULATED GROUND WIRE, AND ONLY FOR WIRING INSIDE STRUCUTURAL TUBING. ENT, ALUMINUM CONDUIT, NM ('ROMEX'), NMC, AND SNM ARE NOT ACCEPTABLE. PVC SCHEDULE 40 MAY BE USED BELOW GRADE.
 - RIGID CONDUIT: CONDUIT OVER 2' IN DIAMETER; OR EXPOSED TO WEATHER; OR EXPOSED TO POTENTIAL DAMAGE; OR USED FOR SERVICE ENTRANCE SHALL BE GALVANIZED RIGID STEEL TYPE.
 - ROUTING CONDUIT ROUTING SHOWN IS SYMBOLIC AND DIAGRAMMATIC. INSTALL CONDUIT TO FIT ACTUAL FIELD CONDITIONS.
- BELOW GRADE: COVER METALLIC CONDUIT BELOW GRADE WITH ASPHALTUM OR BITUMASTIC TAPE. SEAL JOINTS AGAINST WATER.
- G16. CONDUIT FITTINGS: ALL FITTING SHALL BE COMPRESSION OR THREADED TYPE. USE OF SET SCREW FITTINGS IS NOT ACCEPTABLE.
- G17. CIRCUIT BREAKERS: ALL BRANCH CIRCUIT DVERCURRENT PROTECTION DEVICES SHALL BE 20 AMPERE INVERSE TIME TYPE CIRCUIT BREAKERS UNLESS NOTED OTHERVISE. 120/240 VOLT CIRCUIT BREAKERS SHALL BE RATED AT 10,000 AIC MINIMUM. MULTI- POLE BREAKERS SHALL BE INTEGRAL UNITS. USE OF HANDLE TIES IS NOT ACCEPTABLE.
- G19. ALTERNATES & SUBSTITUTIONS: SUBMIT FOR APPROVAL, 10 DAYS PRIOR TO PRESENTATION
- G18 PENETRATIONS: COURDINATE PIER PENETRATIONS WITH STRUCTURAL ENGINEER.

OF BID TO OWNER, ANY ALTERNATES OF ITEMS SPECIFIED ON THESE DRAWINGS. ALTERNATES SUBMITTED LATER THAN 10 DAYS PRIOR WILL NOT BE CONSIDERED. "ALTERNATE" REFERS TO A LUMINAIRE, FIXTURE, DEVICE, EQUIPMENT ITEM, OR MANUFACTURER OTHER THAN THAT SPECIFIED ON THE DRAWINGS OR IN THE SPECIFICATIONS.

- G2O. SHOP DRAWINGS & SUBMITTALS: SUBMIT MANUFACTURERS' STANDARD PRODUCT INFORMATION, PERFORMANCE SPECIFICATIONS, PHYSICAL DIMENSIONS, AND OTHER INFORMATION NECESSARY FOR ENGINEER TO INSURE COMPLIANCE WITH SPECIFICATIONS. SHOP DRAWINGS SHALL BE SUBMITTED FOR APPROVAL PRIOR TO ORDERING AND INSTALLING ANY EQUIPMENT. PROVIDE SHOP DRAWINGS FOR LIGHT FIXTURES, PANEL BUARDS, CONTACTORS, DEVICES, WIRING, CONDUIT, AND ALL OTHER ELECTRICAL EQUIPMENT.
- PROJECT RECORD DOCUMENTS: UPON COMPLETION OF WORK, PREPARE LIGHTING AND POWER PROJECT RECORD DOCUMENTS ('AS-BUILTS') ON A SUITABLY REPRODUCIBLE MEDIUM. PRESENT COMPLETED DRAWINGS TO OWNER, AND TWO SETS OF PRINTS TO INTERIOR DESIGNER OR ARCHITECT. 'AS-BUILT' DRAWINGS SHALL INCLUDE ALL BRANCH CIRCUIT WORK, ANY PANELBOARD INFORMATION AVAILABLE, FINAL SWITCHING, ETC.
- G22. WARRANTY: WARRANT ALL MATERIALS, EQUIPMENT, AND INSTALLATION FOR A PERIOD OF ONE YEAR FROM DATE OF ACCEPTANCE BY OWNER.

GENERAL LIGHTING NOTES

- L1. FIXTURE TYPES: REFERENCE LIGHTING FIXTURE SCHEDULE FOR COMPLETE DESCRIPTION OF EACH FIXTURE TYPE.
- L2. SWITCH LOCATIONS: LIGHTING TO BE CONTROLLED THROUGH PHOTOCELL AND TIMECLOCK
- L3. FIXTURE LOCATIONS: REFERENCE ARCHITECTURAL PLANS FOR EXACT LOCATIONS OF LIGHT FIXTURES. COURDINATE INSTALLATION IN FIELD WITH ARCHITECT.
- L4. INSTALLATION: WIRE FROM JUNCTION BOXES TO FIXTURES OR SWITCHES AS INDICATED. ADDITIONAL JUNCTION BOXES MAY BE REQUIRED BEYOND THOSE
 - SUPPORT ALL FIXTURES FROM STRUCTURE.

GENERAL POWER NOTES

- GENERAL: VERIFY EXACT LOCATION OF OUTLETS AND DEVICES WITH ARCHITECT PRIOR TO INSTALLATION. PROVIDE OUTLET BOXES, DEVICES, COVERPLATES, AND FLANGES AS REQUIRED.
- P2. COORDINATION: MOUNT ALL DUTLETS AT 18' A.F.F. UNLESS NOTED DTHERWISE.
 REFERENCE ARCHITECT'S DRAWINGS, PLANS & ELEVATIONS FOR ALL HEIGHTS, DIMENSIONS,
 AND CONFIGURATIONS OF DEVICES NOT INDICATED ON THESE DRAWINGS.
- P3. CONVENIENCE DUTLETS: ALL CONVENIENCE DUTLETS SHOWN SHALL BE NEMA TYPE 5-20R, SPECIFICATION GRADE WEATHERPROOF GFI RECEPTACLES. VERIFY COLOR AND TYPE WITH ARCHITECT.

ACCEPTABLE MANUFACTURERS

HUBBELL LEVITON PASS & SEYMOUR

P4. EQUIPMENT EXPOSED TO WEATHER SHALL BE WEATHERPROOF.

PANELBOARD 'A' SCHEDULE

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I(X) SUBFEED LOADS I(X) SUBFEED LOADS			**************************************		The first state from the color and the color	**************************************				
ILD LOAD SUMMARY	INDN-	ICON_KVA	ICON_AMP	IC_WPSF	DIV_FAC	DES_KVA	IDES_AMP	ID_WPSF	PANEL	'A' FILE INFORMATION
ICL) LIGHTING ICT) TASK LIGHTING ICE) EXTERIOR LTG & SIGN ICR) RECEPTACLES ICG) Grouped Motors ICM) MOTORS: O. O kVA ICM) 25% LARGEST MOTOR ICK) KITCHEN EQUIPMENT ICH) HEAT: O. O kVA ICA) A/C EQUIP: O. O kVA ICA) A/C EQUIP: O. O kVA ICC) COMPUTER EQUIPMENT ICW) WATER HEATERS ICO) OTHER ICS) SPARE: 2 kVA	LOAD 	0.0 1 0.0 1 4.1 1 6.0 1 0.0 1 0.0 1 0.0 1 0.0 1 0.0 1 0.0 1 0.0	0.0 1.0.0 1.16.9 1.25.0 1.0.0 1.0.0 1.0.0 1.0.0 1.0.0 1.0.0	0.0 0.0 1 4.1 1 6.0 1 0.0 1 0.0 1 0.0 1 0.0 1 0.0 1 0.0	1.25 1.25 1.25 1.25 1.25 1.00	0.010000000000000000000000000000000000	0.0 0.0 21.1 25.0 0.0 0.0 0.0 0.0 0.0 0.0 0.0 0.0 0.0	0.0 0.0 0.0 0.0	JOB NUM JOB N LOCAT SQUARE LIGHT W DESIGN INPUT FILE DATE: TIME: FORM	BER: 08079 AME: FAIRFIELD PARK ION: ADDISSON TX FT: 1000 /SF: 0 (PER NEC 220) BY: MP BY: MP NO: 8079PA PRINT HISTORY 26-Aug-2008 11: 46: 43 AM NUMBER: 1000PS06
I(P) SPACE: 6 kVA						***************************************				EVISION: 12-Sep-91 AL FORM: 27-Jun-87
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REMARKS:	94 640 440 <i>8</i> 88 286 286	BREAKER	SUMMARY	TO"	TAL POLES	24	IPER PHA	SE TOTALS	PAN	EL 'A' SUMMARY
1. ALL CIRCUIT BREAKERS SHALL BE RATED FOR SWITCHING DUTY. 1. 2. ALL BREAKERS SHALL I BOLT-IN.	BE	6 1	4	12		20	ABr 13. BAr 13. KILO VO Ar 5. 4 Br 4. 7 AMPERES Ar 38. 8 Br 33. 7	0 % 0 % LT-AMPERE kVA kVA A A	 VD BR # S MD LD SERVED	
MEP SYSTEMS, INC., 4136 COPYRIGHT (C) WILLIAM N	MEP SYSTEMS, INC., 4136 COMMERCE ST., SUITE 200, DALLAS, TEXAS 75226, (214) 823-2308 COPYRIGHT (C) WILLIAM M. STEVENS AND BARRY L. MANN, P.E., 1987 - 1994 - ALL RIGHTS RESERVED									

- PHOTOCELL FACING NORTH LIGHTING CONTACTOR FOR CIRCUITS 2/4.6.8 CONTROLLED THRU TIMECLOCK AND PHOTOCELL TIMECLOCK STAINLESS STEEL WEATHERPROOF ENCLOSURE MILBANKS OR EQUAL, SIZE TO ACCOMADATE ALL ELECTRICAL DEVICES. PROVIDE LOCKABLE DOORS ON FRONT. 3#3-2°C UTILITY TRANSFORMER CONCRETE BASE YERIFY REQ. W/STRUCT. ENGINEER GROUND #8 CU GRND GROUND PER NEC

ELECTRIC RISER

NTS

SCHEDULE 40 PVC BELOW GRADE MIN. 24"

GENERAL PLUMBING NOTES


- 1. IN THE EVENT A DISCREPANCY IS FOUND IN THE CONTRACT DOCUMENTS, THE ENGINEER SHALL BE NOTIFIED IMMEDIATELY.
- 2. ALL WORK SHALL BE PERFORMED BY QUALIFIED MECHANICS AND PLUMBERS UNDER THE DIRECTION OF AN EXPERIENCED SUPERVISOR HAVING EXPERIENCE IN INSTALLING EQUIPMENT AND SYSTEMS OF SIMILAR TYPE AS INDICATED BY THE CONTRACT
- 3. ALL WORK SHALL BE PERFORMED IN ACCORDANCE WITH CURRENT RULES AND REGULATIONS OF THE STATE AND LOCAL CODES AND IN ACCORDANCE WITH CURRENT INDUSTRY STANDARDS.
- PROVIDE ALL EQUIPMENT MATERIALS, LABOR SUPERVISION, AND SERVICES, NOT PROVIDED BY THE OWNER, AND NECESSARY FOR OR INCIDENTAL TO THE INSTALLATION OF A COMPLETE PLUMBING SYSTEM AS SHOWN OR INDICATED ON THE DRAWINGS AND/OR AS SPECIFIED.
- CONTRACTOR SHALL TAKE PROPER PRECAUTIONS TO PROTECT ALL EXISTING OPERATIONS AND PROPERTY ADJACENT, WITH WHICH WORK COMES IN CONTACT, OR OVER WHICH HE MAY TRANSPORT, HOIST, OR MOVE MATERIALS, EQUIPMENT, DEBRIS, ETC, AND SHALL REPAIR ANY DAMAGE CAUSED TO MATCH EXISTING BEFORE DAMAGE.
- 6. CONTRACTOR SHALL EXAMINE AND BECOME FAMILIAR WITH ALL CONTRACT DOCUMENTS IN THEIR ENTIRETY. SURVEY THE PROJECT AND BECOME FAMILIAR WITH THE EXISTING CONDITIONS AND SCOPE OF WORK. ALL COSTS SUBMITTED SHALL BE BASED ON A THOROUGH KNOWLEDGE OF ALL WORK AND MATERIALS REQUIRED. ANY ADDITIONAL COSTS DUE TO FAILURE TO COMPLY WITH THIS REQUIREMENT SHALL BE THE RESPONSIBILITY OF THE CONTRACTOR.
- 7. VERIFY THE CONDITION AND LOCATION OF UTILITIES. ANY ITEMS REQUIRING REPAIR OR RELOCATION SHALL BE REPAIRED OR RELOCATED TO PROVIDE THE OWNER A COMPLETE AND OPERATING MECHANICAL SYSTEM.
- 8. PRODUCTS OF A SIMILAR NATURE SHALL BE OF THE SAME TYPE AND MANUFACTURER. PROVIDE THE STANDARD PRODUCTS OF MANUFACTURERS REGULARLY ENGAGED IN THE PRODUCTION OF SPECIFIED PRODUCTS, UNLESS OTHERWISE REQUIRED BY DRAWINGS OR SPECIFICATIONS. ALL SUCH PRODUCTS SHALL BE LISTED, LABELED, OR CERTIFIED BY UNDERWRITERS LABORATORIES.
- 9. DRAWINGS ARE DIAGRAMMATIC AND INDICATE GENERAL ARRANGEMENT OF WORK.
- 10. CONTRACTOR SHALL COORDINATE HIS WORK WITH ALL OTHER TRADES.
- 11. CONTRACTOR SHALL VERIFY ALL MEASUREMENTS AT SITE AND BE RESPONSIBLE FOR CORRECTNESS OF SAME.
- 12. CONNECT NEW WORK TO EXISTING CONSTRUCTION IN NEAT AND APPROVED MANNER. RESTORE EXISTING WORK IN MAKING SUCH CONNECTION TO PERFECT CONDITION.
- 13. ALL WORK SHALL BE INSTALLED READILY ACCESSIBLE FOR OPERATION, MAINTENANCE
- 14. ALL WORK AND EQUIPMENT TO BE FULLY GUARANTEED FOR DNE (1) YEAR FROM THE DATE OF FINAL PAYMENT AND ACCEPTANCE.
- 15. ALL CUTTING AND PATCHING IN CONNECTION WITH THIS TRADE SHALL BE DONE BY THIS CONTRACTOR.
- 16. STORE MATERIALS IN SPACES DESIGNATED BY DWNER.
- 17. REMOVE RUBBISH FROM PREMISES AS OFTEN AS NECESSARY OR DIRECTED.
- 18. EQUIPMENT INTENDED FOR PERMANENT INSTALLATION SHALL NOT BE OPERATED FOR TEMPORARY PURPOSES.
- 19. ALL WORK AND EQUIPMENT SHALL BE CLEANED TO THE SATISFACTION OF THE DWNER BEFORE TURNING SAME OVER TO DWNER.
- 20. PROVIDE ALL NECESSARY SUPPORTS PER MSS REQUIREMENTS.
- 21. PROJECT RECORD DOCUMENTS: UPON COMPLETION OF WORK, PREPARE PLUMBING PROJECT RECORD DOCUMENTS ("AS-BUILTS") ON A SUITABLY REPRODUCIBLE MEDIUM, PRESENT COMPLETED DRAWINGS TO DWNER, AND TWO SETS OF PRINTS TO INTERIOR DESIGNER OR ARCHITECT. "AS-BUILT" DRAWINGS SHALL INCLUDE ALL PIPING AND EQUIPMENT.
- 22. SUPPORTS FOR ALL EQUIPMENT AND PIPING SHALL PROVIDE ADEQUATE SLOPE AND ANCHORAGE. CONTRACTOR SHALL USE HANGERS, RODS AND INSERTS INSTALLED, CONSTRUCTED, AND SPACED PER MSS REQUIREMENTS.
- 23. TRENCHING, EXCAVATING, BACKFILLING AND CONCRETE WORK SHALL BE PER OSHA AND LOCAL CODE REQUIREMENTS.
- 24. THIS CONTRACTOR IS RESPONSIBLE FOR COORDINATION AND NOTIFICATION OF ALL OTHER CONTRACTORS EFFECTED BY ANY EQUIPMENT MODIFICATIONS OR SUBSTITUTIONS.
- 25. SHOP DRAWINGS & SUBMITTALS: SUBMIT MANUFACTURERS' STANDARD PRODUCT INFORMATION, PERFORMANCE SPECIFICATIONS, PHYSICAL DIMENSIONS, AND OTHER INFORMATION NECESSARY FOR ENGINEER TO INSURE COMPLIANCE WITH SPECIFICATIONS. SHOP DRAWINGS SHALL BE SUBMITTED FOR APPROVAL PRIOR TO ORDERING AND INSTALLING ANY EQUIPMENT. PROVIDE SHOP DRAWINGS FOR PLUMBING FIXTURES, PIPING AND ALL OTHER ITEMS.

PLUMBING NOTES:

- 1. WASTE, DRAIN AND VENT PIPING SHALL BE SCHEDULE 40 PVC.
- 2. POTABLE WATER PIPING SHALL BE TYPE "L" HARD DRAWN COPPER ABOVE GRADE,
 TYPE 'K' BELOW GRADE WITH WROUGHT COPPER FITTINGS. MAY BE SCHEDULE 40 PVC
 BELOW GRADE IF APPROVED BY OWNER.
- PROVIDE SHUTOFF VALVES AT INLET OF EACH PLUMBING EQUIPMENT ITEM, AND AT INLET OF EACH PLUMBING FIXTURE, AND ELSEWHERE AS INDICATED.
- 4. THE DOMESTIC WATER PIPING SYSTEM SHALL BE STERILIZED PER LOCAL CODE AUTHORITY REQUIREMENTS.

MEP SYSTEMS DESIGN AND ENGINEERING INC. 918 DRAGON STREET DALLAS, TX 75207 (214)915-0929 FAIRFIELD
PARK
Town of Addison, Texas

Landscape Architecture
Planning
Urban Design
1925 San Jacinto, Suite 400
Dallas, Texas 75201
Tel. 214—871—7900
Fax. 214—871—7985

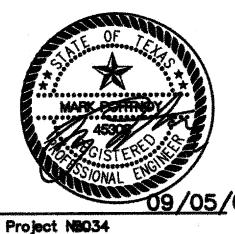

Drawn BydW

Checked BF/KB

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ELECTRICAL NOTES

